

NEW SINGLE FAMILY HOME - ATTACHED DUPLEX DND - TYPE E

7A HALF MOON STREET BOSTON, MA

DESCRIPTION OF THE WORK:

ERT804408 (BOA834537) COBUCS # 1533238804789 BWSC SITE PLAN # 18575

traffic visiblilty within a triangular area CONC. BLK. CITY OF BOSTON #7B HALF MOON STREET #7A HALF MOON STREE AREA=2,770 S.F. =0.0636 AC. -SEE DETAIL 4 2' OFFSET LINE -SEE DETAIL 3 (PUBLIC-40' WIDE)

SITE PLAN

NOTES:

THE WORK ENTAILS INSTALLATION OF A NEW DND - TYPE "E" STRUCTURE

REVISION

1 TOPO ELEVATIONS

1. NO WORK SHALL COMMENCE UNTIL A BUILDING PERMIT HAS BEEN OBTAINED

SEE CITY OF BOSTON ASSESSORS PARCEL #1301038000 FOR

BOSTON. BENCHMARK IS RIM OF SEWER MANHOLE 115,

SUBDISTRICT TYPE: THREE-FAMILY RESIDENTIAL

3. ZONE DISTRICT: ROXBURY NEIGHBORHOOD

Residential

Subdistrict

2500 sf

6.82

24.99

ZONING SUBDISTRICT: 3F-5000

SITE. SITE IS KNOWN AS #7 HALF MOON STREET IN DEED BOOK

#8848 PAGE #513. THE PARCEL WILL BE SUBDIVIDED INTO TWO PARCELS: #7"HALF MOON STREET AND #7A HALF MOON STREET.

REFERENCE BENCHMARK: TOPOGRAPHIC DATUM BASE IS CITY OF

ZONING OVERLAY DISTRICT: NEIGHBORHOOD DESIGN REVIEW

Zoning Table

7A HALF MOON STREET - 1 FAMILY (TYPE E)

Dimensional Requirements 3F-5000

Proposed

 $0.58 (1625 \text{ sf} \pm)$

29'-5" Grade @

 $675 \text{ sf} \pm$

(L)-14.68

Existing Non-conforming

Existing Non-conforming

Section 50-44, Paragraph 7

Narrow Lots. A lot narrowe

than (50) feet shall have (2) inches deducted from the

side yard for each foot below

(50) feet. Average yard

width = 31.27'. Modified side yard setback = 10' -

((50-31.27) * 0.17') = 6.82'

Section 50-44, Paragraph 1

- Rear Yards of Certain

shallower than (100) feet

for each foot below (100)

Modified side yard setback 30' - ((100-89.98) * 0.5') =

feet. Lot depth = 89.98'.

Shallow Lots. A lot

shall have (6) inches deducted from the rear yard

Side Yards of Certain

2813 sq ft

31.27

31.27

SITE PLAN NOTES:

ELEVATION=108.35

Regulations

Lot Area, sf Lot Width, ft

Lot Frontage, ft

Building height

Building height

per Dwelling Unit

Front Yard Depth, ft

Depth, ft

Depth, ft


Rear yard Max. Occ. by Accessory

Usable Open Space 650 sf

F/A/R (Max.)

- 2. THE CONTRACTOR SHALL OBTAIN AND PAY FOR ALL PERMITS AND APPROVALS REQUIRED BY THE LOCAL
- ALL WORK SHALL BE IN ACCORDANCE WITH THE MASSACHUSETTS STATE BUILDING CODE, 9th EDITION. DRAWINGS ARE NOT TO BE SCALED. ALL WORK SHALL BE LAID OUT BY DIMENSIONS. ANY DEVIATIONS SHALL BE BROUGHT TO THE ATTENTION OF THE DESIGNER IMMEDIATELY. ALL DEVIATIONS SHALL BE
- CORRECTED BY CONTRACTOR BEFORE HE BEGINS HIS PORTION OF THE WORK 5. DRAWINGS ARE THE PROPERTY OF THE DESIGNER AND SHALL NOT BE COPIED OR DUPLICATED IN ANY

- PUBLIC FROM INJURY & ADJACENT PROPERTY FROM DAMAGE
- THE DRAWINGS ARE PREPARED FOR THE PURPOSE OF PERMIT APPLICATION ONLY. 8. IT IS THE RESPONSIBILITY OF THE CONTRACTOR TO NOTIFY THE ENGINEER IN CASE OF ANY OR ALL DEVIATIONS FOR THESE DRAWINGS. THE ENGINEER SHALL BE HELD HARMLESS AS A RESULT OF ANY UNAUTHORIZED CHANGES TO THESE PLANS. ADDITIONAL FEES MAY OCCUR FOR "AS-BUILT" DOCUMENTATION DUE TO CIRCUMSTANCES BEYOND THE ENGINEERS CONTROL, OR OWNER / CONTRACTOR CHANGES TO THESE

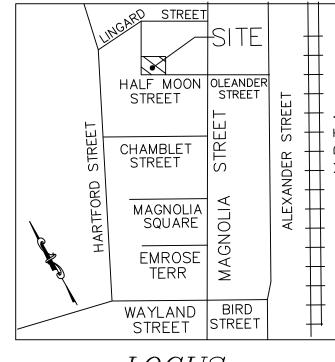

LOCUS NOT TO SCALE

CODE INFORMATION:

MA STATE BUILDING CODE, 9th EDITION 2015 IRC w/ MA AMENDMENTS

USE GROUP: R2 - SINGLE FAMILY ATTACHED

CONSTRUCTION TYPE: V-B (UNPROTECTED WOOD FRAME)

FLOOR LOADS:

DESIGN LIVE LOADS AS PER TABLE (R)301.5:

COMMON AREAS (OTHER THAN SLEEPING): 40 PSF SLEEPING AREAS: 30 PSF RESIDENTIAL ATTICS w/ FIXED STAIRS: 30 PSF RESIDENTIAL ATTICS(STORAGE): 20 PSF RESIDENTIAL ATTICS(NO STORAGE): 10 PSF DECKS: 40 PSF

SNOW LOADING:

GROUND SNOW LOAD PER TABLE (R)301.2(4): GROUND SNOW LOAD, Pg = 40 PŠF

<u>WIND LOADING:</u>

WIND LOAD PER TABLE (R)301.2(4): BASIC WIND SPEED (ULTIMATE), Vuit = 128 PSF BASIC WIND SPEED (ALLOWABLE), Vasd = 100 PSF (WIND SPEED CONVERSION PER TABLE (R)301.2.1.3)

LIST OF DRAWINGS:

- A-0.0 COVER PAGE/SITE PLAN
- A-1.0 BASEMENT & FIRST FLOOR PLANS
- A-1.1 SECOND & ATTIC FLOOR PLANS
- A-1.2 ROOF PLAN
- A-2.0 FRONT & LEFT ELEVATIONS
- A-2.1 REAR & RIGHT ELEVATIONS
- S-1.0 FOUNDATION & FIRST FLOOR FRAMING PLANS
- S-1.1 SECOND FLOOR & ATTIC FRAMING PLANS
- S-1.2 ROOF FRAMING PLAN
- E-1.0 ELECTRICAL GENERAL NOTES
- BASEMENT & FIRST FLOOR ELECTRICAL PLANS
- E-1.2 SECOND FLOOR & THIRD FLOOR ELECTRICAL PLANS
- SYMBOLS, SYSTEMS, ABBREVIATIONS & GENERAL NOTES
- T-1.1 GENERAL NOTES
- G-1.1 KITCHEN ELEVATION AND DETAILS
- G-2.0 DOOR SCHEDULE, DOOR / WINDOW DETAILS
- G-3.0 ROOM FINISH SCHEDULE & PARTITION TYPES
- G-4.0 WALL SECTIONS
- G-4.1 WALL SECTIONS
- G-5.0 TYPICAL DETAILS
- G-5.1 TYPICAL DETAILS

7A HALF MOON **STREET** BOSTON, MA

CM KIRBY ENGINEERING, PLLC ARCHITECTS ENGINEERS

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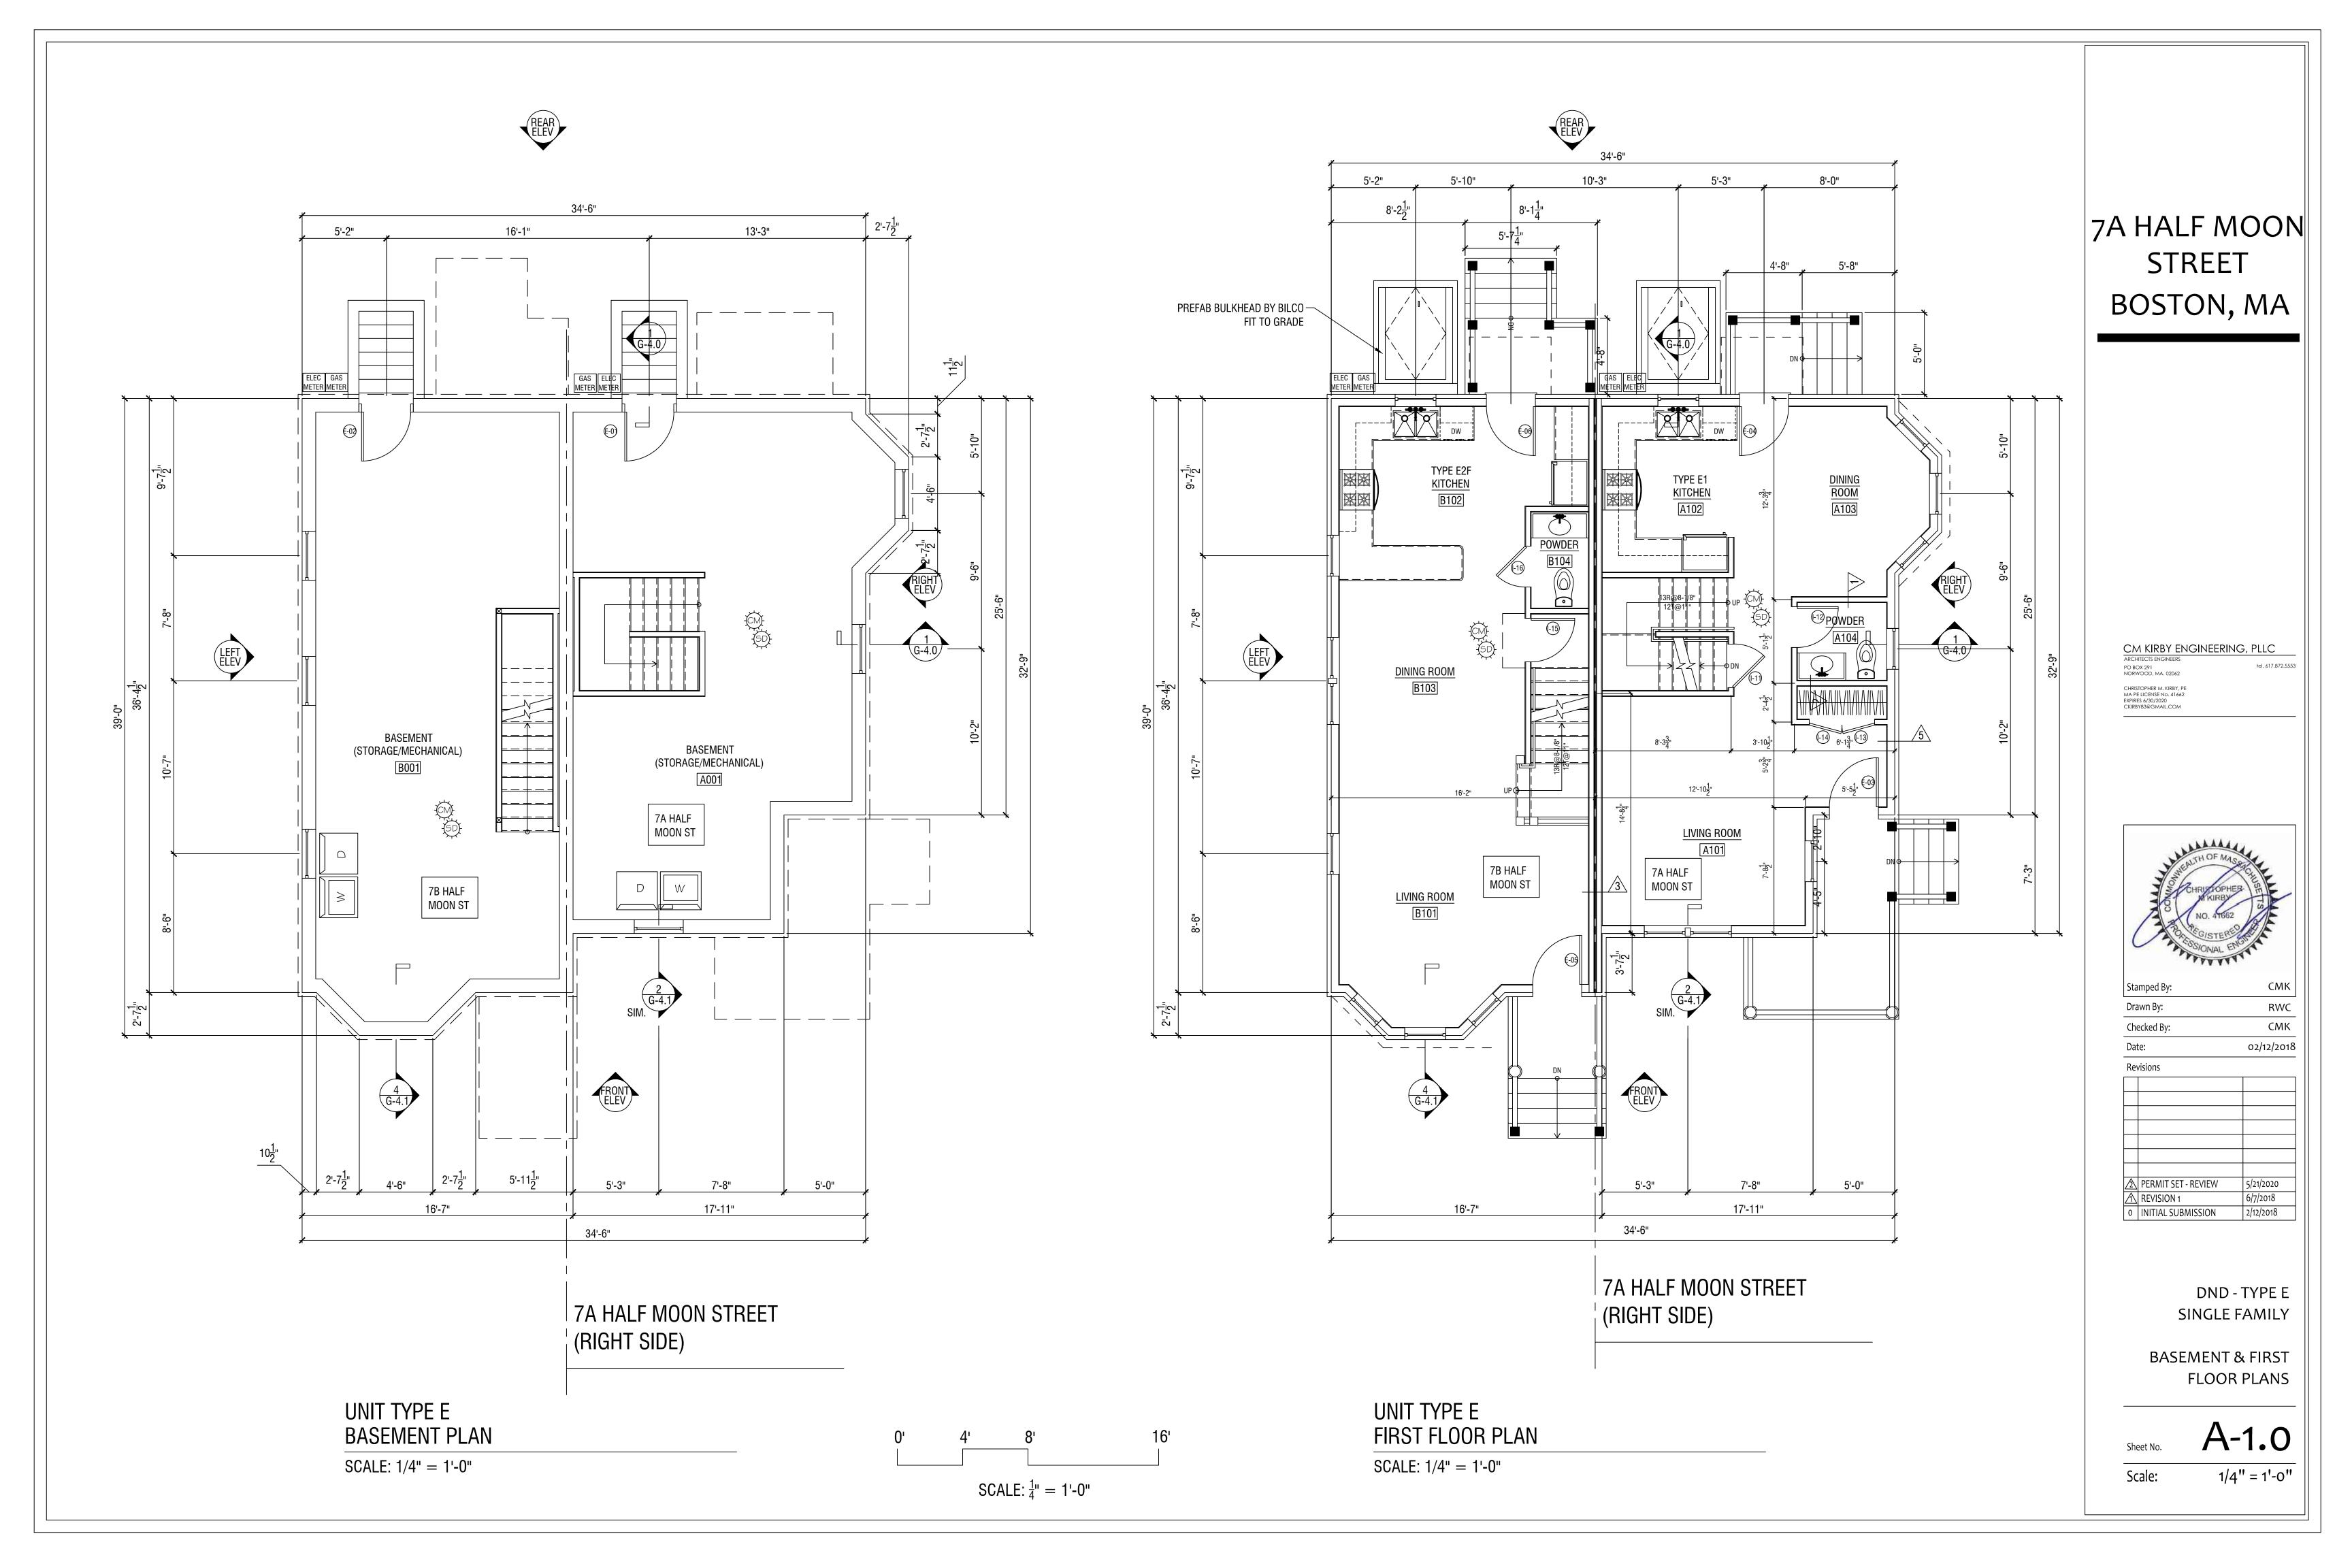



Drawn By:	RWC
Checked By:	СМК
Date:	02/12/2018
Revisions	
PERMIT SET - REVIEW	5/21/2020
↑ PERMIT SET - REVIEW	5/24/2018
0 INITIAL SUBMISSION	2/12/2018

DND - TYPE E SINGLE FAMILY

COVER PAGE

1/4" = 1'-0"




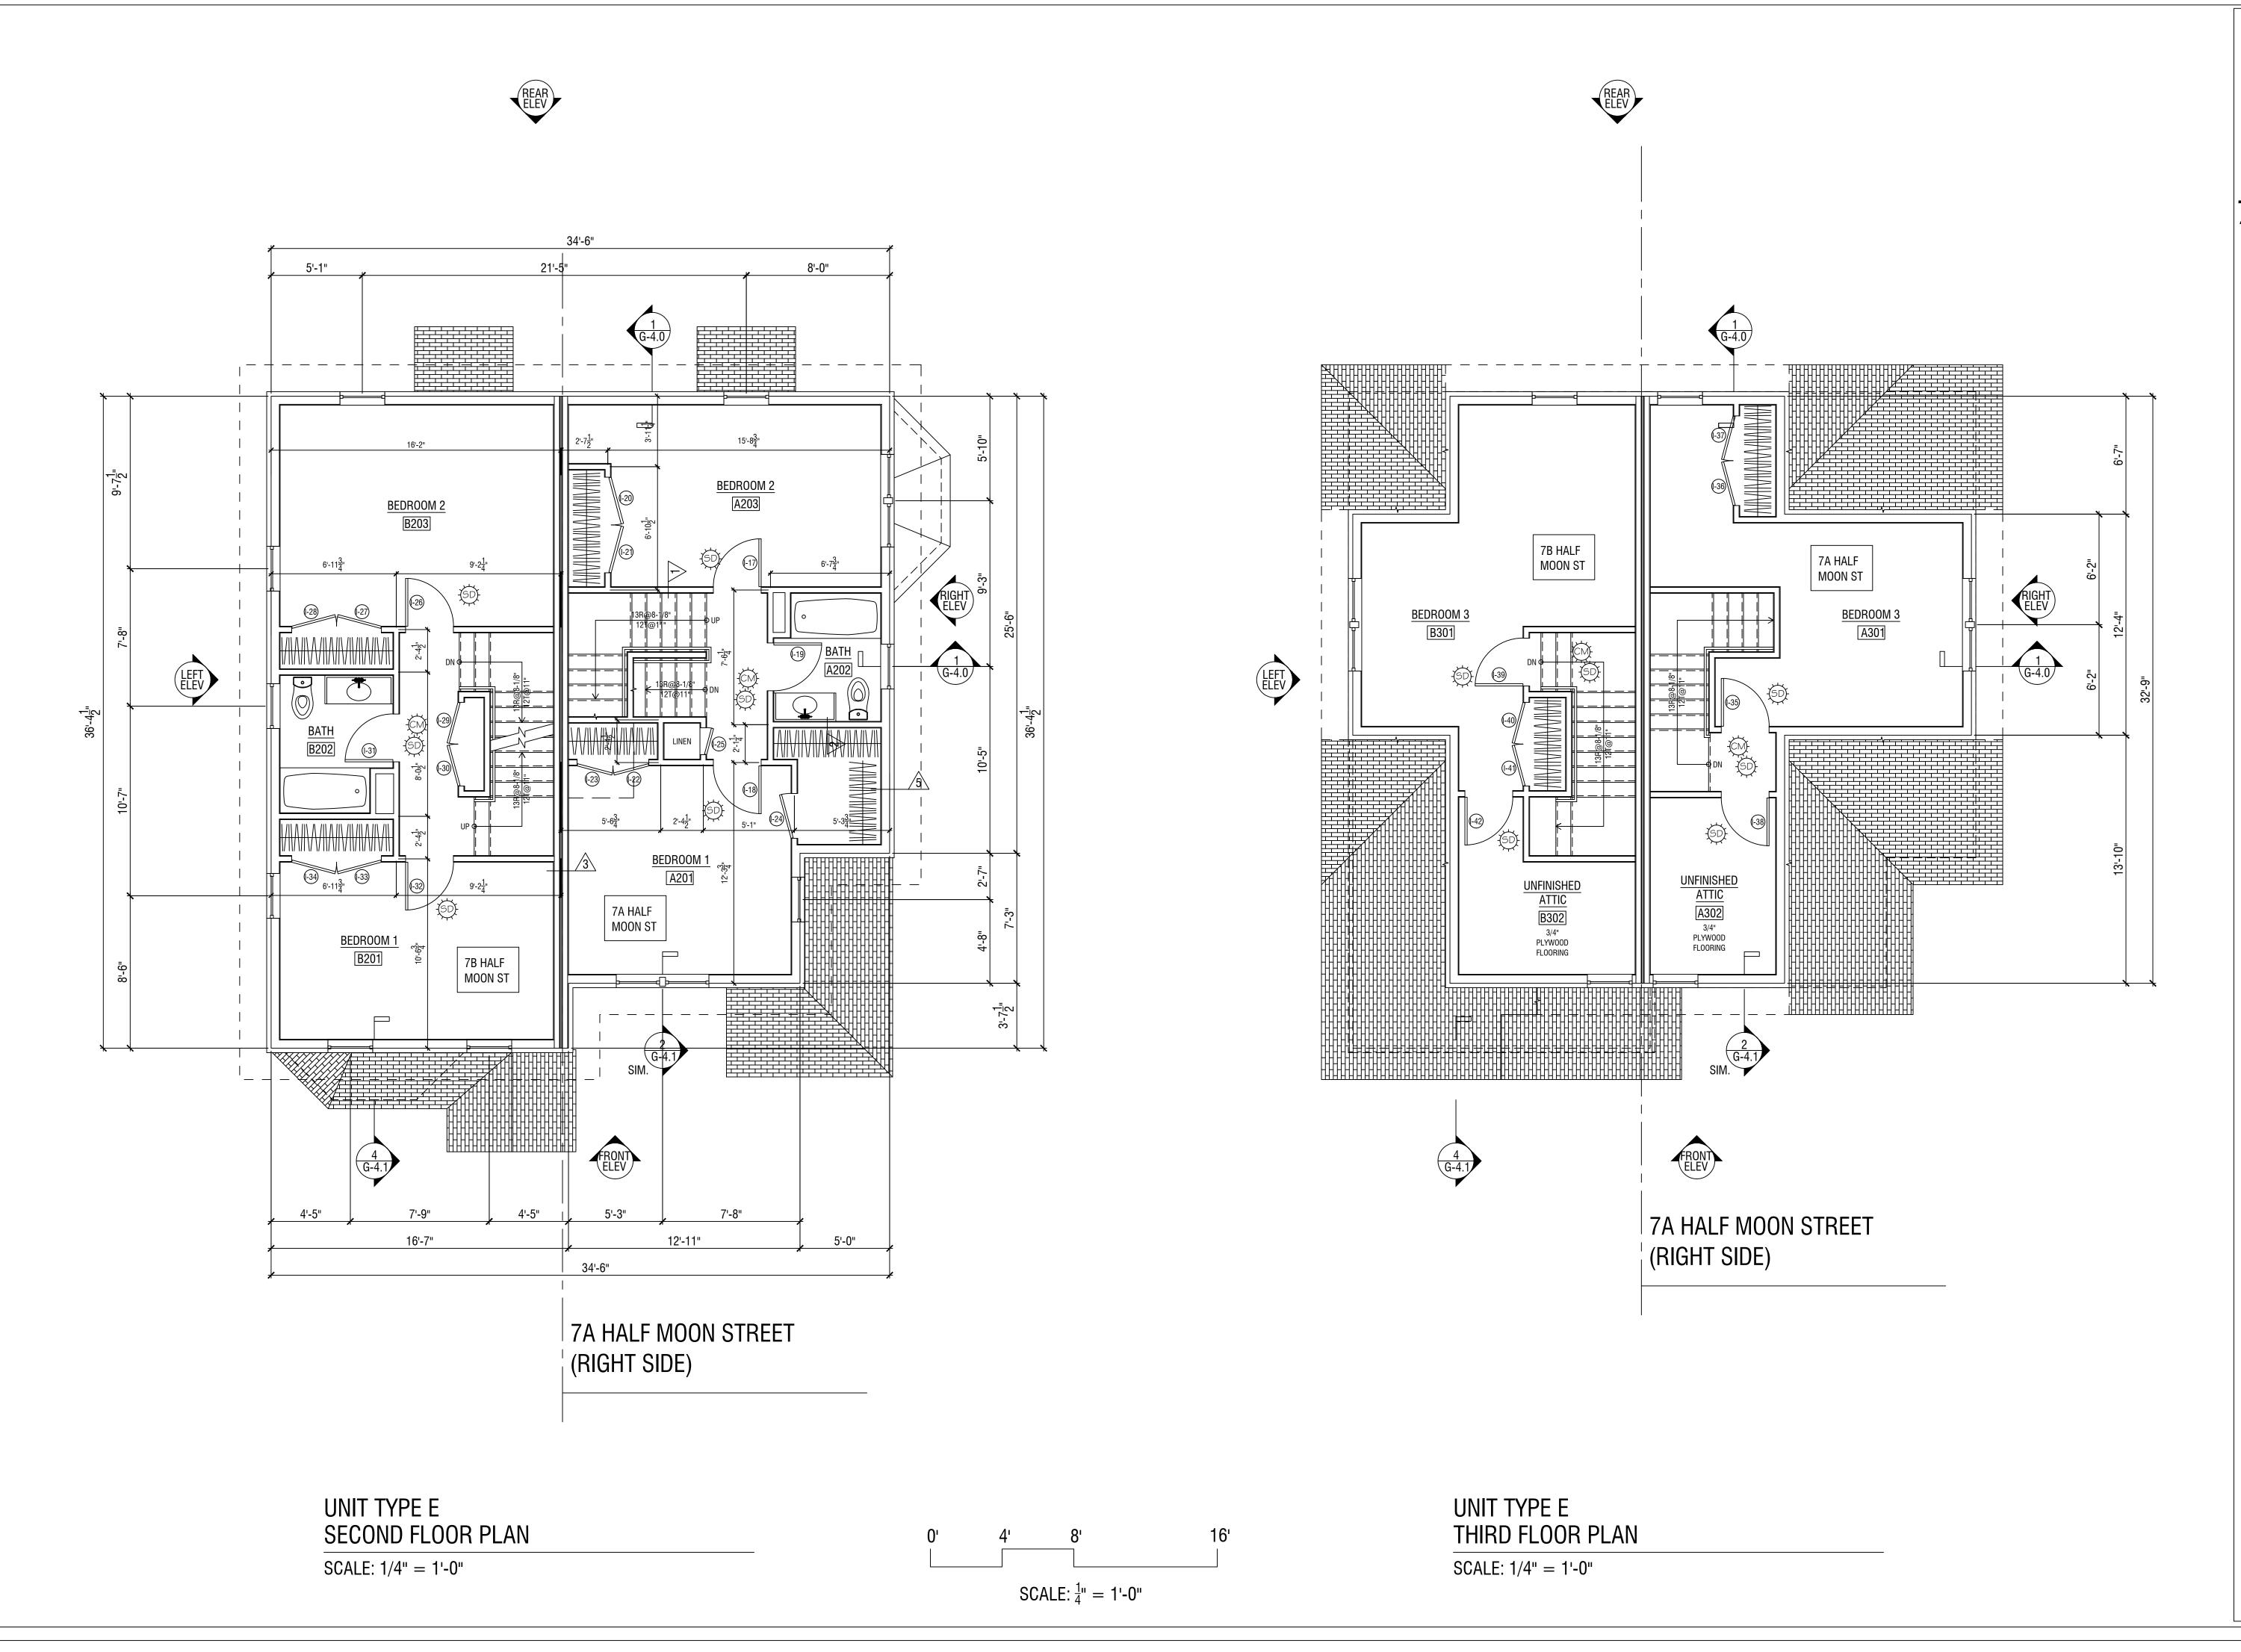

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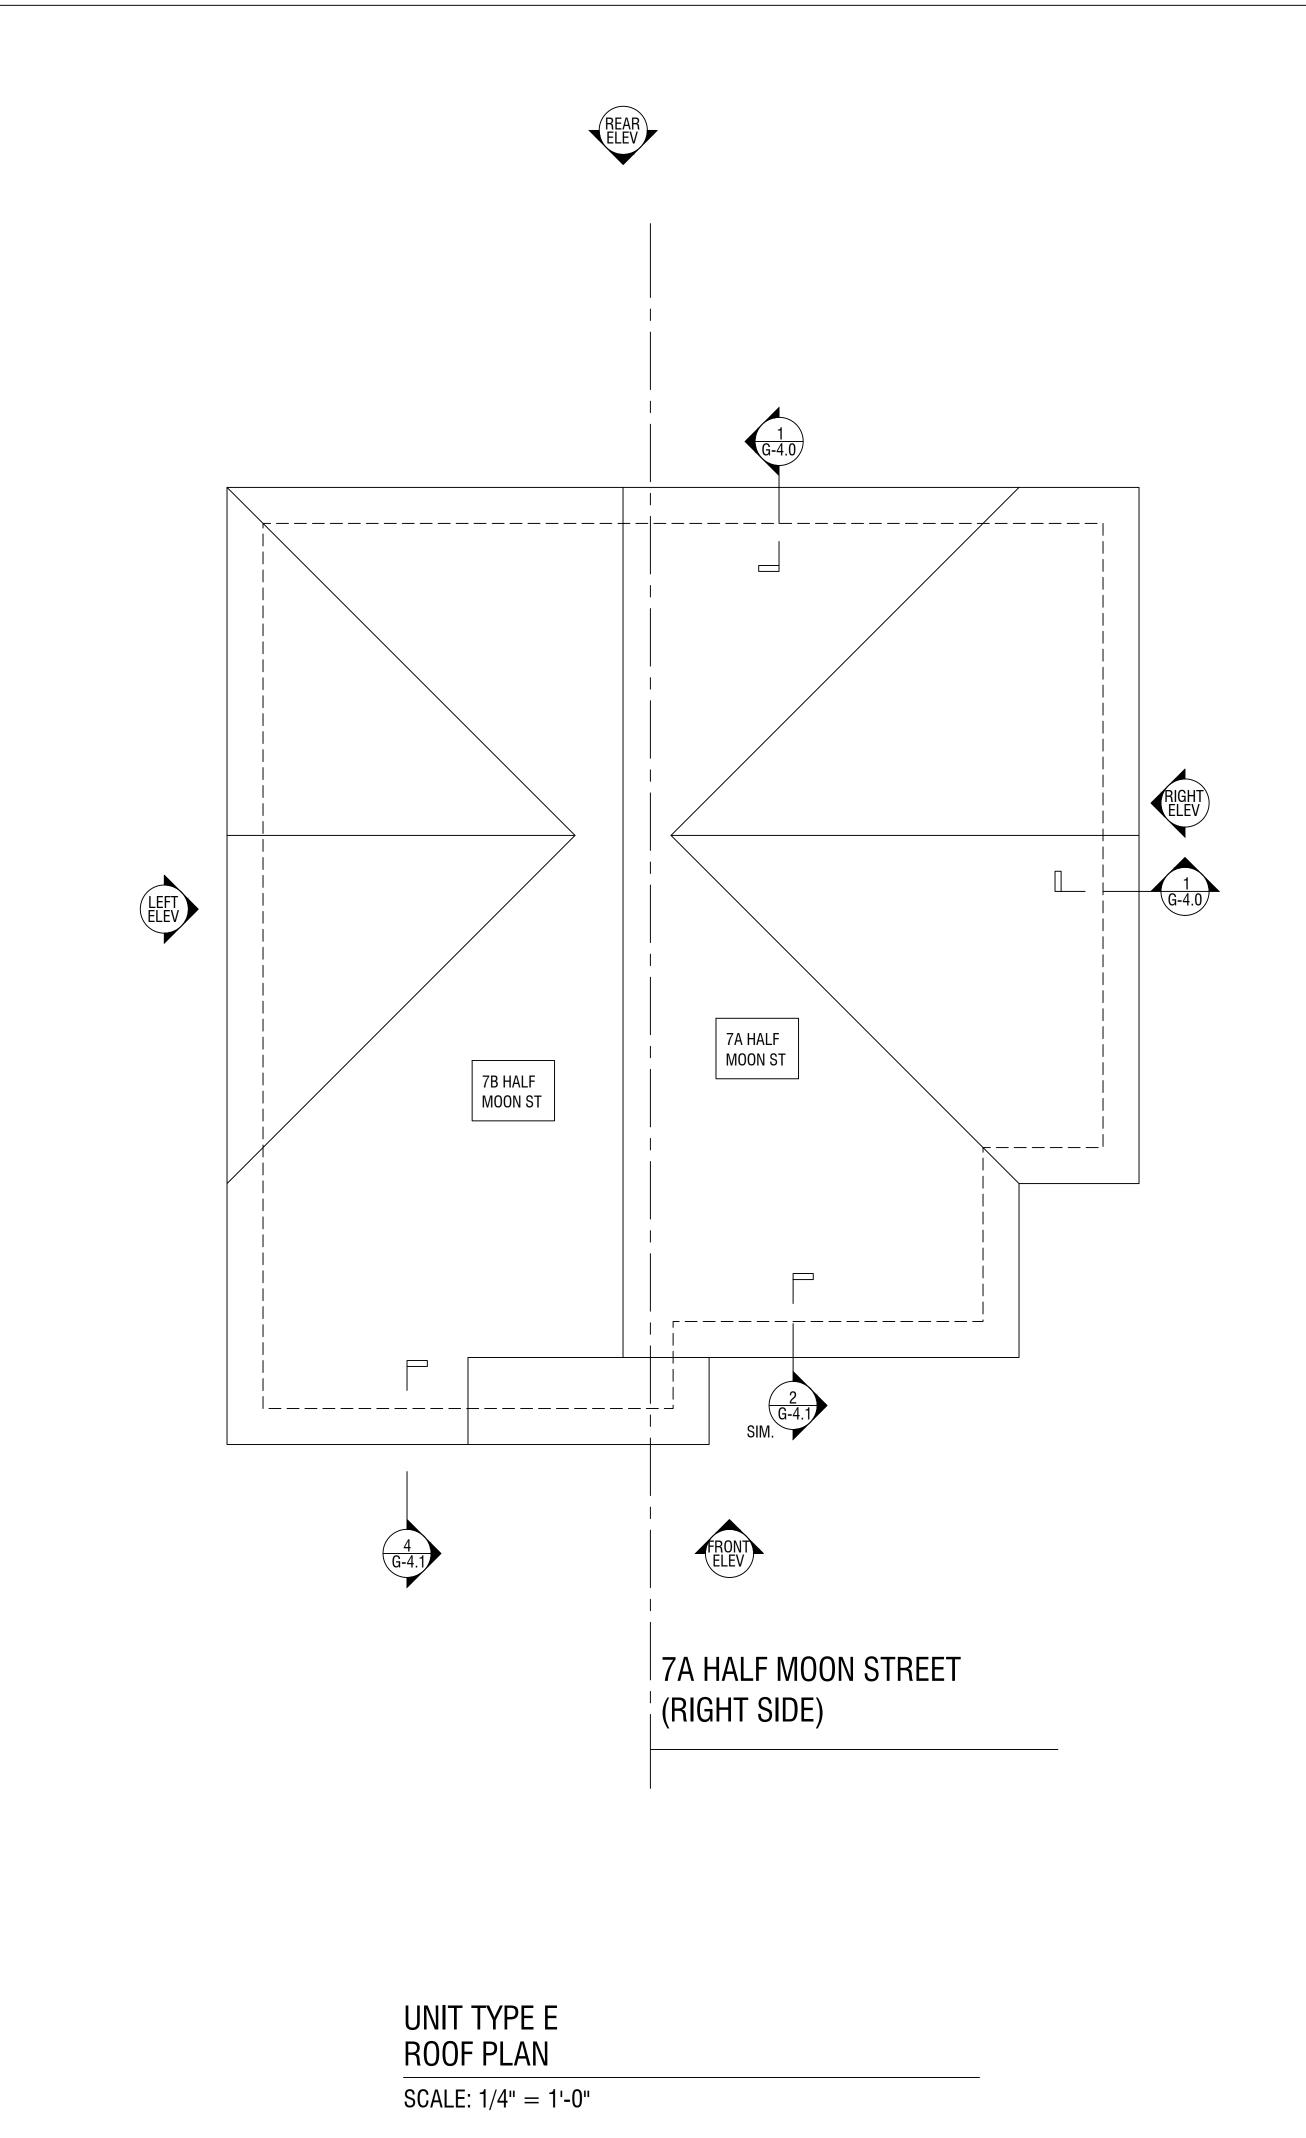


> DND - TYPE E SINGLE FAMILY

SECOND & ATTIC FLOOR PLANS

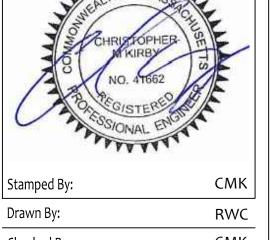Sheet No. **A-1.1**

Scale: 1/4" = 1'-0"



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Drawn By: CMK Checked By: 02/12/2018

PERMIT SET - REVIEW
REVISION 1

INITIAL SUBMISSION

DND - TYPE E SINGLE FAMILY


ROOF PLAN


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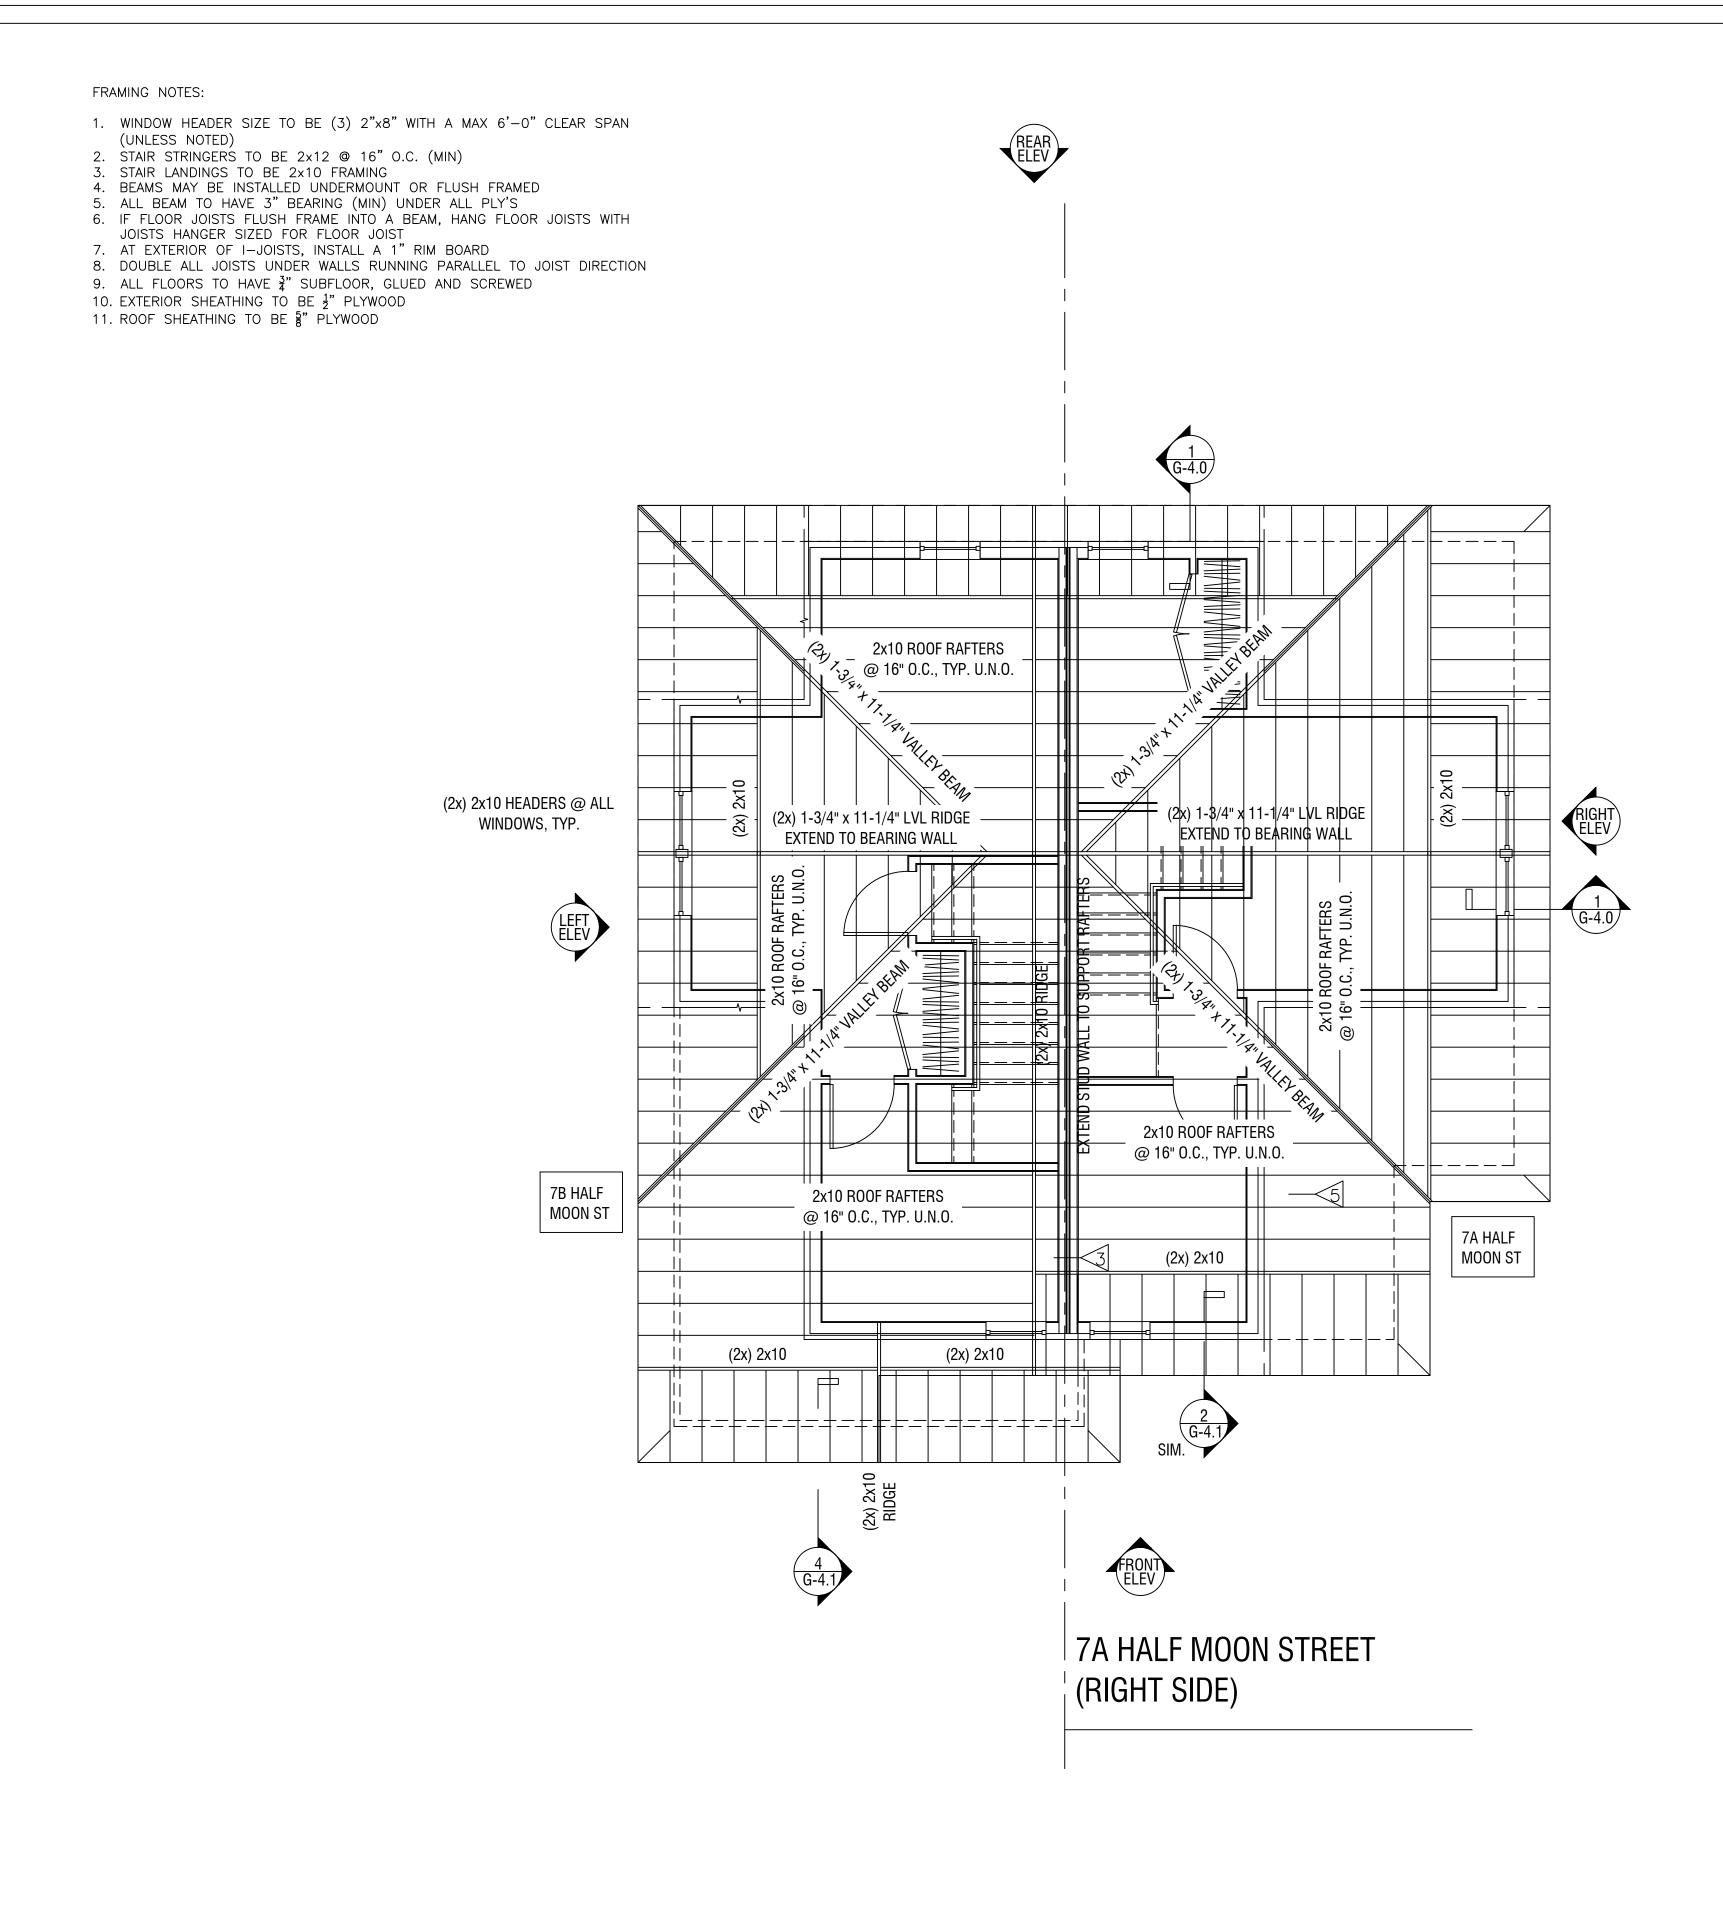
SCALE: $\frac{1}{4}$ " = 1'-0"







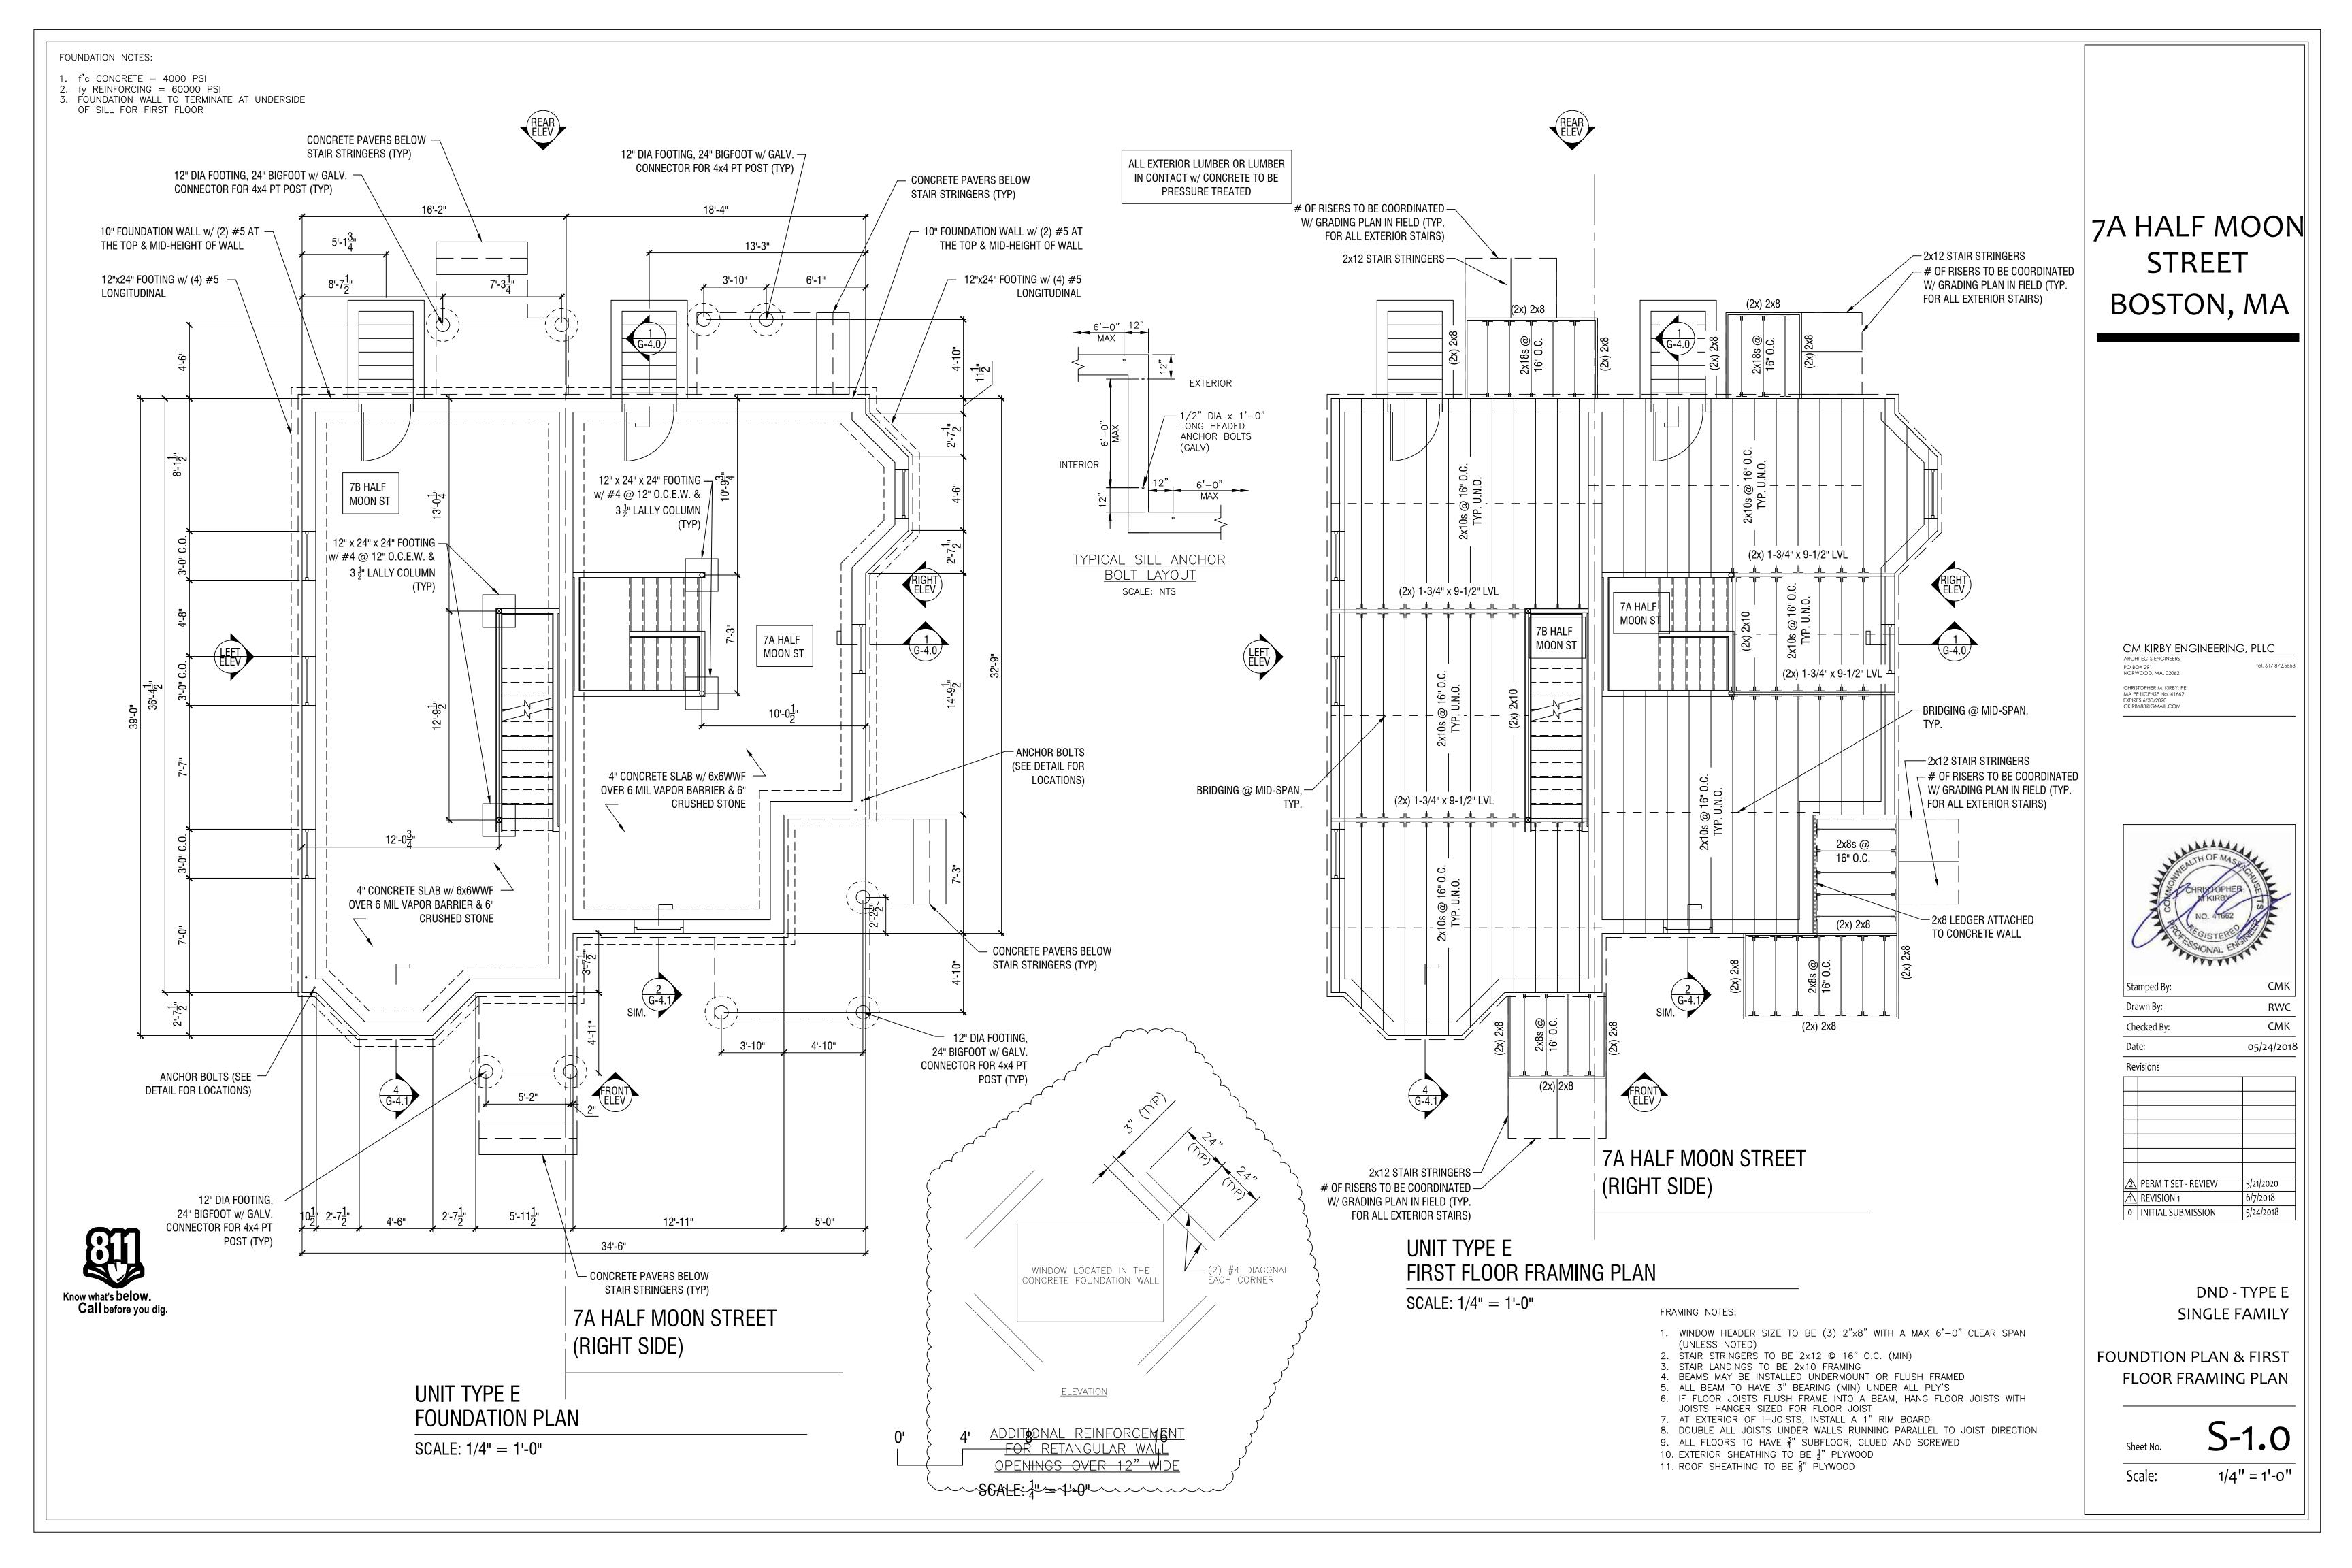

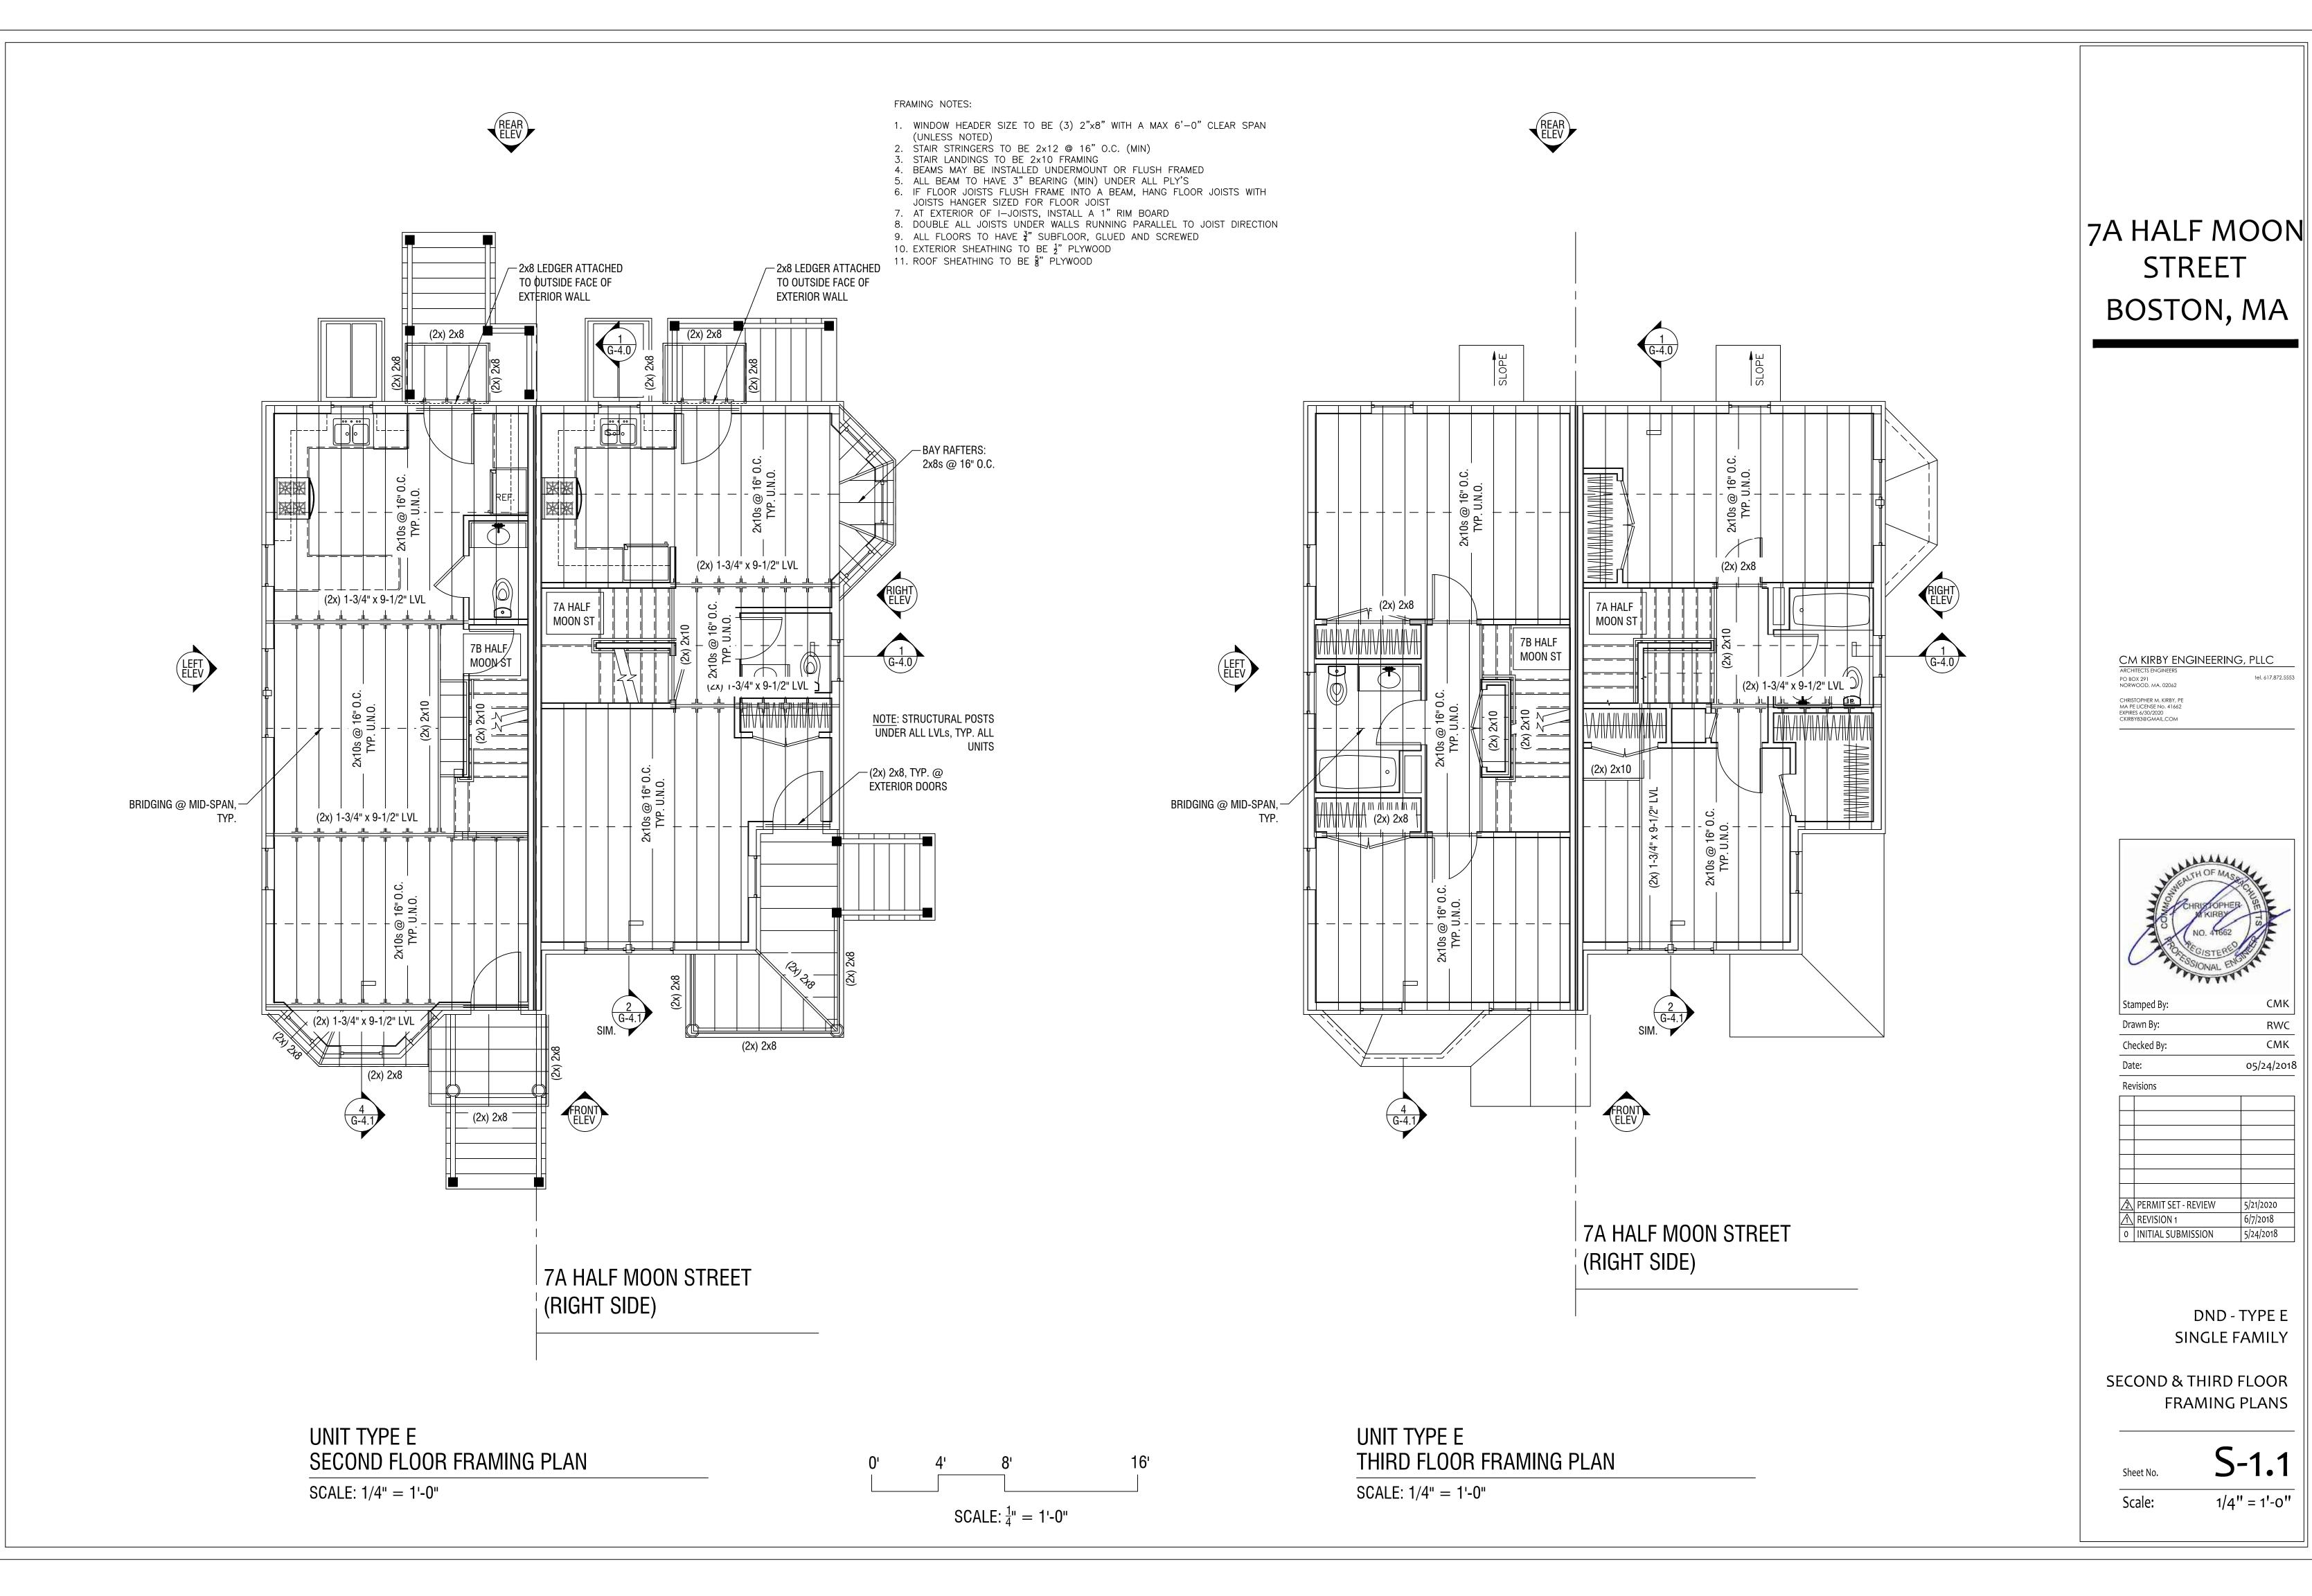

UNIT TYPE E ROOF FRAMING PLAN


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Dat	e:	05/24/201
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A	PERMIT SET - REVIEW	5/21/2020
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\square	REVISION 1	6/7/2018
0	INITIAL SUBMISSION	5/24/2018

DND - TYPE E SINGLE FAMILY

> ROOF FRAMING PLAN

Sheet No. **S-1.2**

Scale: 1/4" = 1'-0"

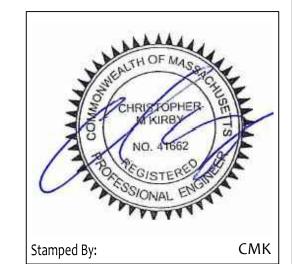SCALE: $\frac{1}{4}$ " = 1'-0"

		<u> </u>	IXTUR	E SCHEDULE	
TYPE:	MANUFACTURER:	CATALOG NUMBER:	VOLT:	LAMP:	DESCRIPTION:
U1	PROGRESS	P2851-09	120V	(2)23WCFL MINI-TWIST	KITCHEN
U2	PROGRESS	P3688-09	120V	(1)13 CFL MINI-TWIST	ENTRANCE/LIVING RM/ HALLWAY & STAIR
U3	PROGRESS	P6163-09WB	120V	(4)50W MR16	DINING ROOM
U4	PROGRESS	P3408-09	120V	(1)13 CFL MINI-TWIST	CLOSET LIGHT
U5	PROGRESS	P3688-09	120V	(1)13 CFL MINI-TWIST	BEDROOM LIGHT
U6	PROGRESS	P3223-09WB	120V	(3)60W HALOGEN G9	BATHROOM VANITY ABOVE SINK
U7	PROGRESS	P3410-09	120V	(2)13 CFL MINI-TWIST	BATHROOM CEILING LIGHT
А	PROGRESS	P6017-84	120V	(2)18W CFL	EXTERIOR CEILING MOUNTED
В	PROGRESS	P5749-84	120V	(1)18W CFL	EXTERIOR WALL MOUNTED
С	PROGRESS	P3688-09	120V	(1)13 CFL MINI-TWIST	BASEMENT LIGHT
D	PROGRESS	P2501-04	120V	-	CEILING FAN
				- (1)13 61 E WIIWI-1WIST	

	MECHANICAL SYSTEMS	
HEATING/COOLING SYSTEM:	1. FAJITSU, MITSHUBISHI, OR EQUAL MINI SPLIT HEAT PUMP SYSTEM - COMPRESSOR SIZED - 4 HEADS NO DUCTS SHALL BE INSTALLED - HSPF OF 12 OR GREATER - SEER OF 20 OR GREATER	
	OR	
	 2. DUCTED FORCED HOT AIR SYSTEM w/ AC SYSTEM - FURNACE TO BE NATURAL GAS, 95% EFFICIENT - COMPRESSOR SIZED - NO DUCTS OR SOFFITS SHALL BE EXPOSED. DUCT WORK SHALL BE INSTALLED IN FLOOR BAYS BETWEEN JOIST OR IN WALLS BETWEEN STUDS - AC COMPRESSOR SEER OF 15 OR GREATER 	
HOT WATER SYSTEM:	GAS DOMESTIC HOT WATER SYSTEM - INSTANTANEOUS GAS DHW SYSTEM EF OF .95 OR HIGHER	
ERV SYSTEM:	PROVIDE ENERGY RECOVERY SYSTEM (ERV) BY PANASONIC FV04VE1, VENMAR OR EQUIVALENT CAPABLE OF MEETING VENTILATION CODE 50-80 CFM THAT MEETS THE 2012 IECC STANDARDS FOR EFFICACY	
PASSIVE RADON SYSTEM:	PROVIDE A RADON RESISTANT CONSTRUCTION TECHNIQUES INCLUDING A PASSIVE SYSTEM WHICH FROM THE PERFORATED PIPE UNDER THE SLAB, UP THROUGH SLAB, AND HOUSE, TERMINATING ABOVE THE ROOF WITH AN ELECTRICAL OUTLET IN THE ATTIC FOR INSTALLING A FAN, MAKING IT AN ACTIVE SYSTEM, IF THERE IS A HIGH READING MEASURED. ASTM E1465 PRACTICE FOR RADON CONTROL OPTIONS	
TO BE SOLAR PV READY:	INSTALL CONDUIT FROM ROOF TO AREA IN BASEMENT IN BASEMENT ROOM FOR A SOLAR METER, AN INVERTER AND A SWITCH BOX ON EXTERIOR OF BASEMENT ROOM FOLLOWING THE LOCAL ELECTRIC COMPANY GUIDELINES, AN ACCESSIBLE SAFETY OFF SWITCH BOX	
PLUMBING:	WATER SENSE (EPA) FOR ALL INTERIOR PLUMBING DEVICES; - SHOWERHEAD - TOILET - LAVATORY FAUCET	
APPLIANCES:	USE ENERGY STAR APPLIANCES USE NATURAL GAS RANGE AND EXHAUST RANGE TO EXTERIOR	

ELECTRICAL SYMBOLS CEILING MOUNTED LIGHT FIXTURE. WALL MOUNTED LIGHT FIXTURE. 2'X2' OR 2'X4' FLUORESCENT LIGHT FIXTURE. 1'x4' FLUORESCENT WALL/CEILING MOUNTED LIGHT FIXTURE. SINGLE POLE LIGHT SWITCH THREE-WAY LIGHT SWITCHES DIMMER SWITCH MINIMUM 1000W OR AS REQUIRED PER CIRCUIT DUPLEX RECEPTACLE, 120V,18" AFF. DUPLEX RECEPTACLE WITH GROUND FAULT INTERRUPTER 8" ABOVE COUNTER TO CENTERLINE DUPLEX RECEPTACLE, 120V,18" AFF., ONE OUTLET SWITCHED 120V DOUBLE DUPLEX CONVENIENCE RECEPTACLE DUPLEX RECEPTACLE ABOVE COUNTER, 8" ABOVE COUNTER TO CENTERLINE TELEPHONE JACK COMPLETE W/JACK AND COVER, WALL MOUNTED @ 4'-0" A.F.F) SYSTEM TYPE SMOKE DETECTOR - DBEC DUCT SMOKE DETECTOR W/REMOTE TEST SWITCH - DBEC **HEAT DETECTOR - DBEC** FIRE ALARM AUDIO/VISUAL UNIT. MTD. @ 6'-8" AFF -DBEC FIRE ALARM MINI HORN - DBEC JUNCTION BOX - DBEC LIGHTING & POWER PANEL, RECESSED - DBEC FIRE ALARM CONTROL PANEL - DBEC FIRE ALARM ANNUNCIATOR - DBEC CABLE *NOTE: D.B.E.C. = DESIGN AND INSTALLED BY ELECTRICAL CONTRACTOR

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CMK

RWC CMK Checked By: 05/24/2018

Stamped By:


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⚠ PERMIT SET - REVIEW o INITIAL SUBMISSION

> DND - TYPE E SINGLE FAMILY

GENERAL NOTES -ELECTRICAL

1/4" = 1'-0"

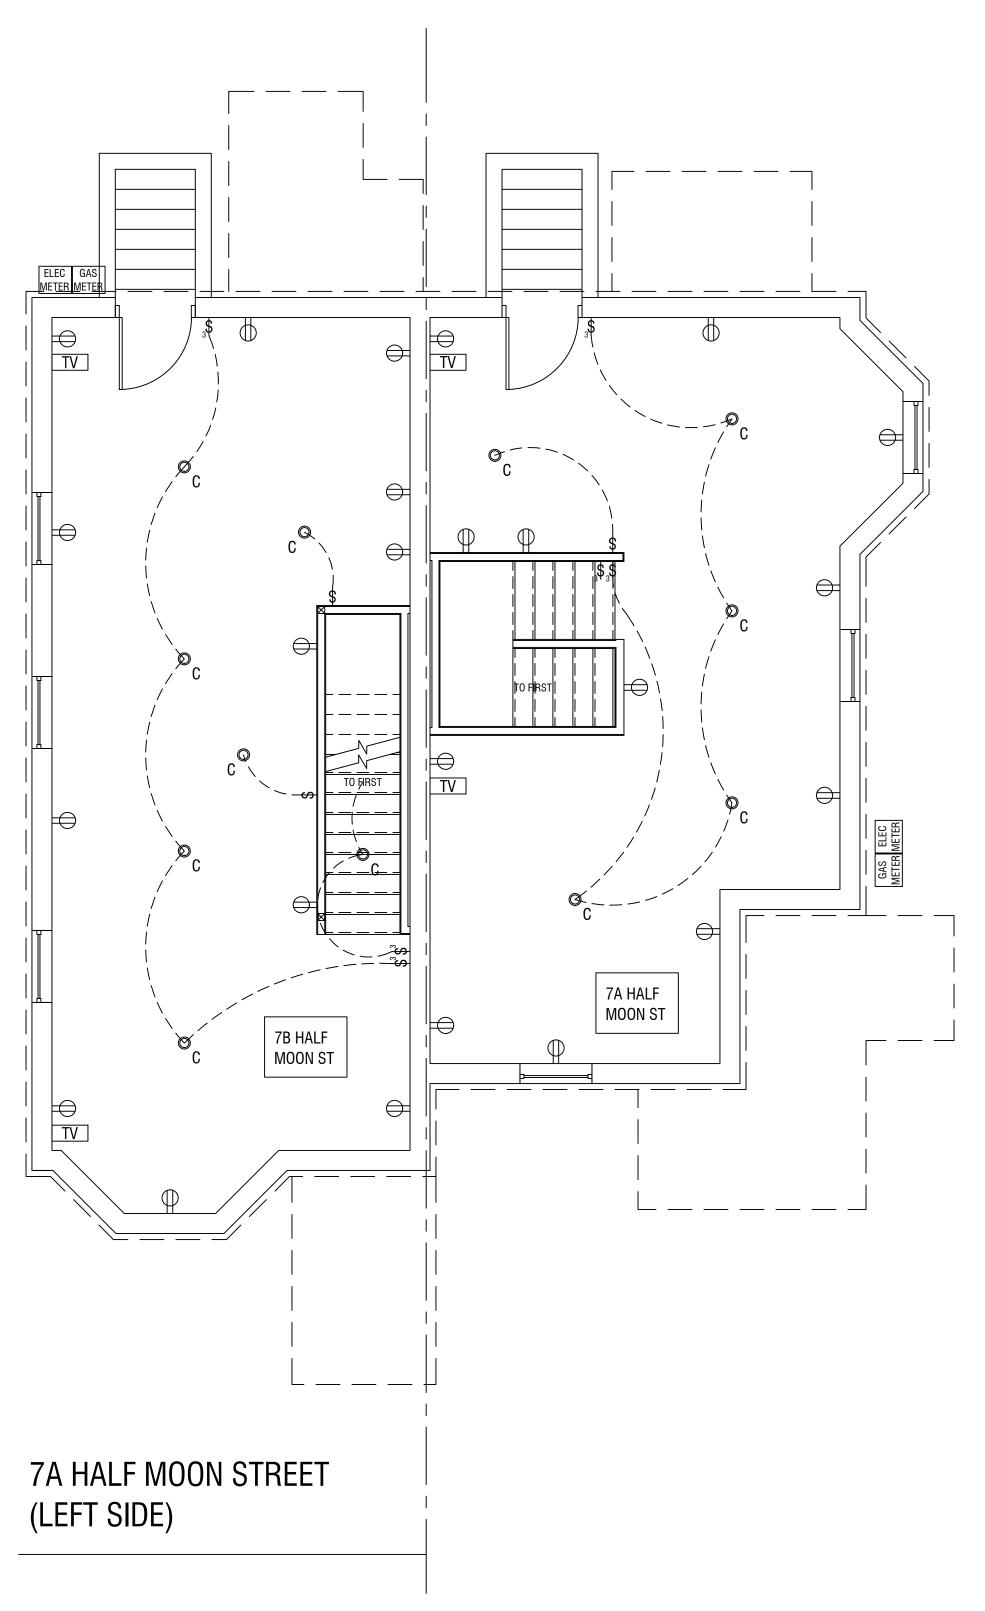


UNIT TYPE E

SCALE: 1/4" = 1'-0"

BASEMENT ELECTRICAL PLAN

0' 4' 8' 16' SCALE: $\frac{1}{4}$ " = 1'-0"

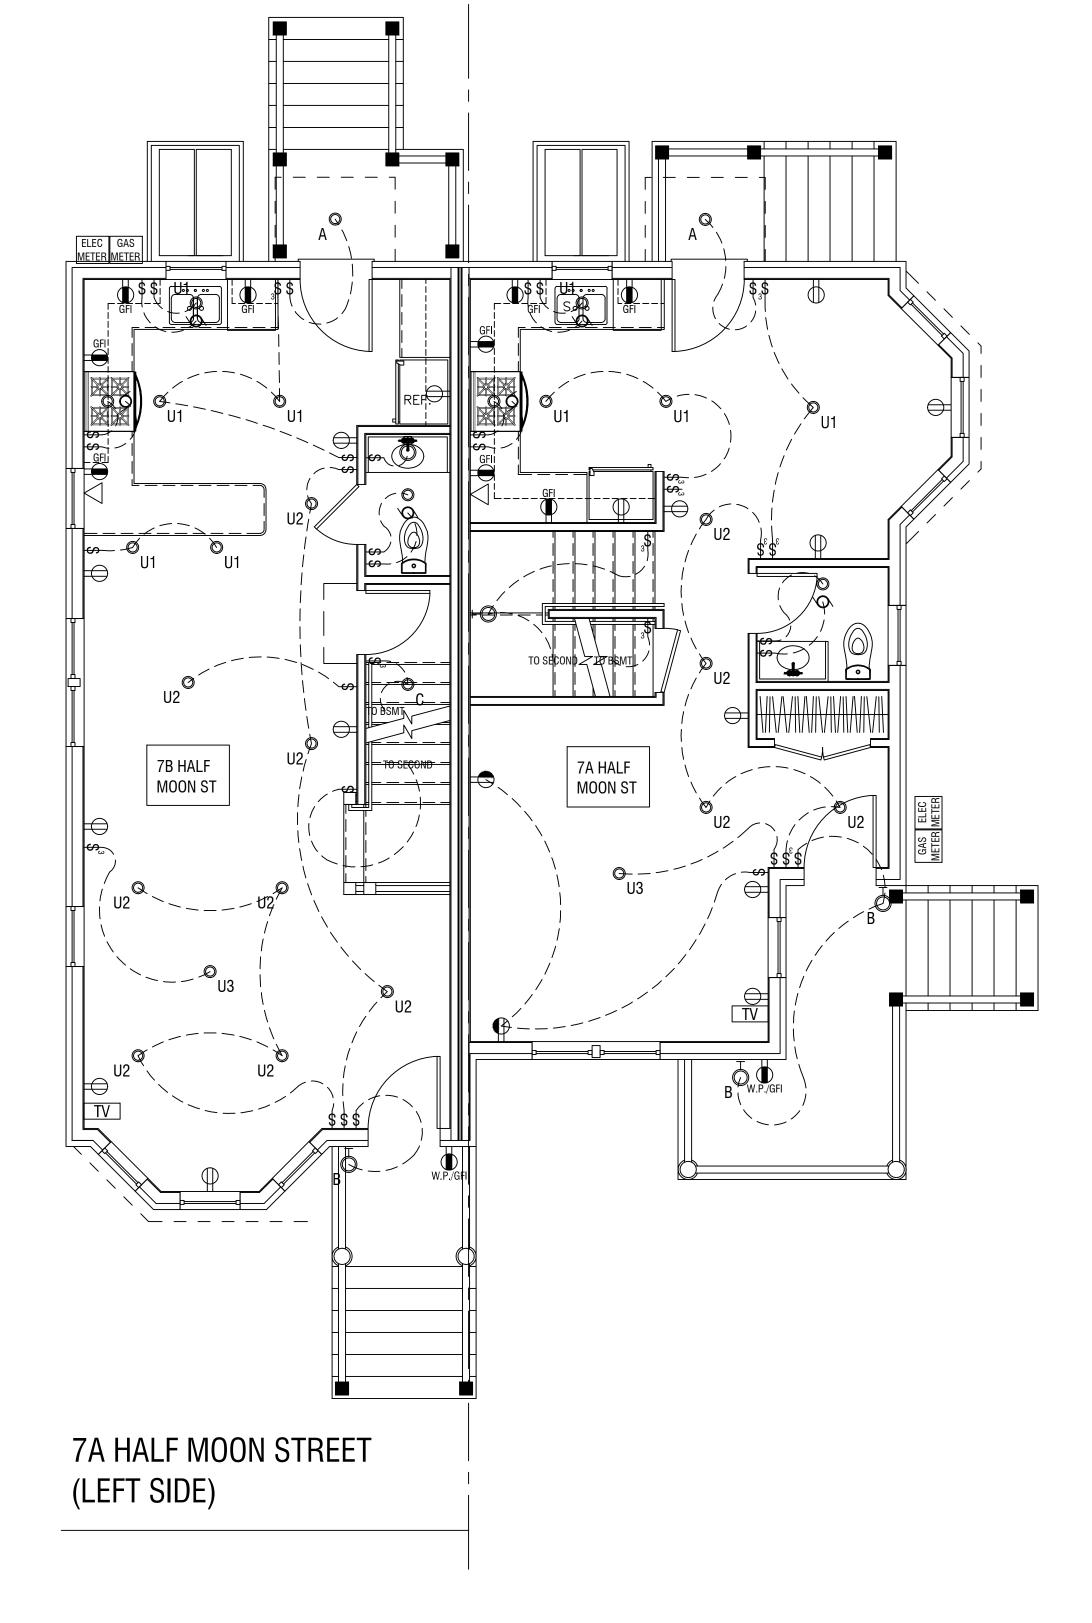

UNIT TYPE E
FIRST FLOOR ELECTRICAL PLAN


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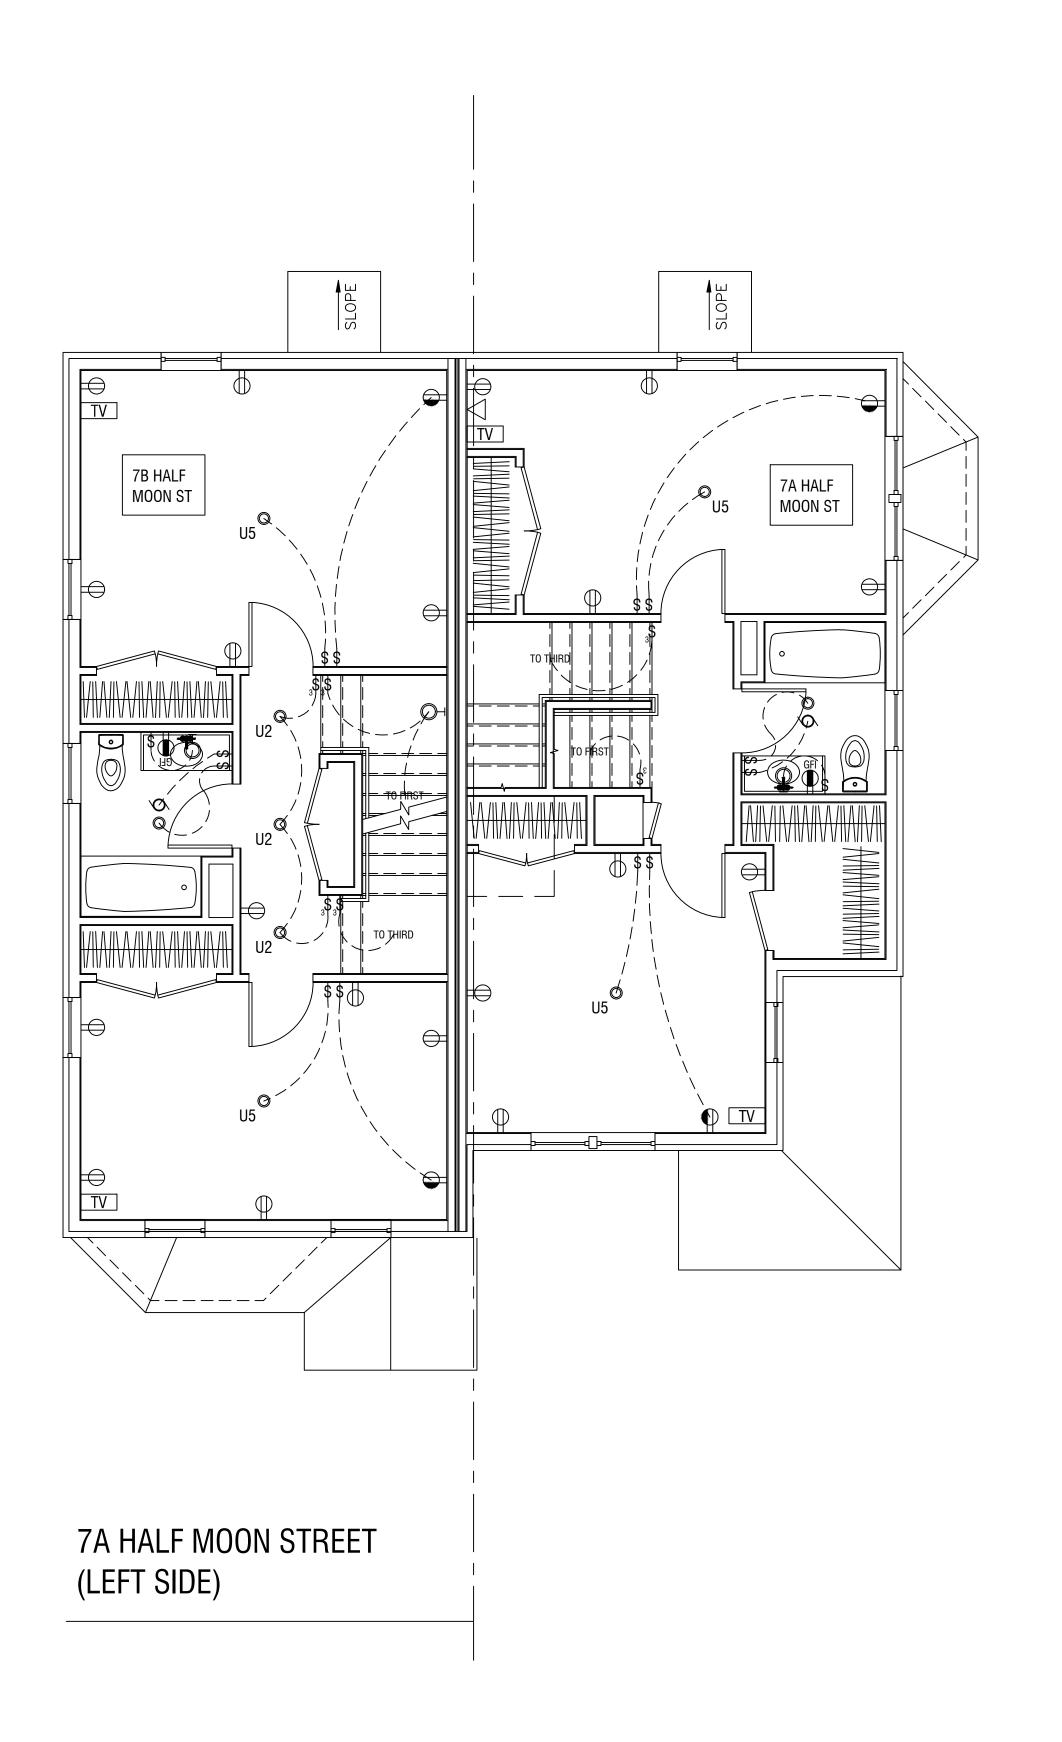



> DND - TYPE E SINGLE FAMILY

BASEMENT & FIRST FLOOR ELECTRICAL PLANS

Sheet No. E-1.1

Scale: 1/4" = 1'-0"

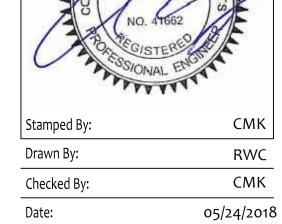

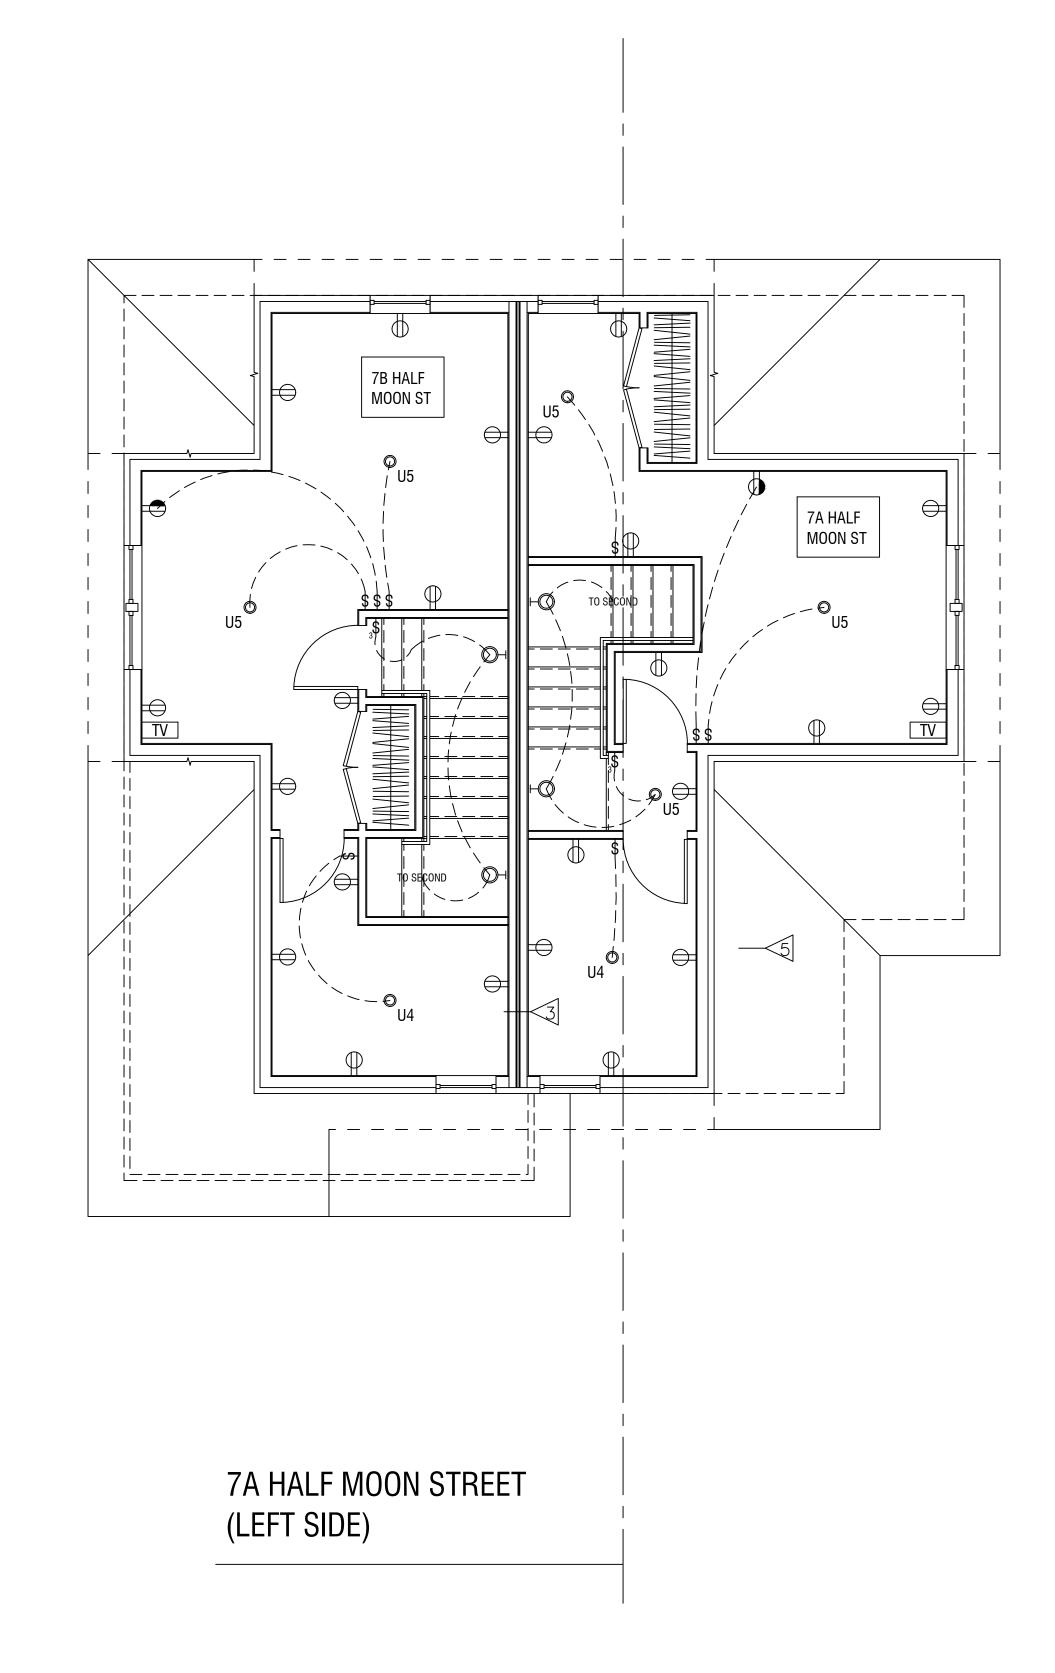

UNIT TYPE E SECOND FLOOR ELECTRICAL PLAN

SECOND FLOOR ELECTRICAL PLAN

O' 4' 8'

SCALE: 1/4" = 1'-0"

SCALE: \frac{1}{4}" = 1'-0"

UNIT TYPE E THIRD FLOOR ELECTRICAL PLAN

SCALE: 1/4" = 1'-0"

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Stamped By:

Drawn By:

CMK

Checked By:

CMK

Date:

05/24/2018

Revisions

A PERMIT SET - REVIEW

∫/21/2020

A REVISION 1

0 INITIAL SUBMISSION

CMK

D5/24/2018

DND - TYPE E SINGLE FAMILY

SECOND & THIRD FLOOR ELECTRIC PLANS


Sheet No. E-1.2

Scale: 1/4'' = 1'-0''

GENERAL NOTES

COUST.	ACOUSTICAL	E. EA.	EAST	I.D.	INSIDE DIAMETER	R. RAD.	RISER
۹.D.	AREA DRAIN	E.B.	EACH EXPANSION BOLT	INCL. INSUL.	INCLUDED, INCLUDING INSULATION	RBR.	RADIUS RUBBER
NDJ.	ADJUSTABLE	E.J.	EXPANSION JOINT	INT.	INTERIOR	R.D.	ROOF DRAIN
\.F.F.	ABOVE FINISH FLOOR	EL.	ELEVATION	IIVI.	INTERIOR	RECD.	RECESSED
AGGR.	AGGREGATE	ELEC.	ELECTRICAL	JAN.	JANITOR	REF.	REFERENCE
ALUM	ALUMINUM	ELEV.	ELEVATOR	JT.	JOINT	REFR.	REFRIGERATOR
APPROX.	APPROXIMATE	EMER.	EMERGENCY			REINF.	REINFORCED
ARCH.	ARCHITECTURAL	ENCL.	ENCLOSURE	KIT.	KITCHEN	REQ.	REQUIRED
		E.P.	ELECTRICAL PANELBOARD			RESIL.	RESILIENT
ASPH.	ASPHALT	EQ.	EQUAL	LAB.	LABORATORY	RM.	ROOM
ATTD.	ATTACHED	EQPT.	EQUIPMENT	LAM.	LAMINATE	R.O.	ROUGH OPENING
		E.W.C.	ELECTRIC WATER COOLER	LAV.	LAVATORY		
D.D.	20422	EXST.	EXISTING	L.C.C.	LEAD-COATED COPPER	S.	SOUTH, SINK
BD. BF.	BOARD BI-FOLD	EXPO.	EXPOSED	LCKR.	LOCKER	S.C.	SOLID CORE
BITUM.	BITUMINOUS	EXP.	EXPANSION	LT.	LIGHT	SCHED.	SCHEDULE
BLDG.	BUILDING	EXT.	EXTERIOR	LTL.	LINTEL	SCR.	SCREEN
BLK.	BLOCK	ΓΛ	FIDE ALADM	LVR.	LOUVER	SECT.	SECTION
BLKG.	BLOCKING	F.A. F.B.	FIRE ALARM FLAT BAR, FACE BRICK	L.W.C.	LIGHT WEIGHT CONCRETE	SEP. SH.	SEPARATE SHELF
BM.	BEAM	F.D.	FLOOR DRAIN	MACH.	MACHINE	SHT.	SHEET
BOT.	воттом	FDN.	FOUNDATION	MATL.	MATERIAL	SHTG.	SHEATHING
BSMT.	BASEMENT	F.E.	FIRE EXTINGUISHER	MAX.	MAXIMUM	SHWR.	SHOWER
		F.E.C.	FIRE EXTINGUISHER CABINET	M.B.	MACHINE BOLT	SIM.	SIMILAR
CAB.	CABINET	F.H.C.	FIRE HOSE CABINET	MBR.	MEMBER, MEMBRANE	SPEC.	SPECIFICATION
C.B.	CATCH BASIN	FIN.	FINISH, FINISHED	M.C.	MEDICINE CABINET	SQ.	SQUARE
		FL.	FLOOR	MECH.	MECHANICAL	S.S.	STAINLESS STEEL
CEM.	CEMENT	FLASH.	FLASHING	MEMB.	MEMBRANE	STA.	STATION
CER.	CERAMIC	FLUOR.	FLUORESCENT	MFR.	MANUFACTURER	STD.	STANDARD
C.I.	CAST IRON	F.O.C.	FACE OF CONCRETE	MH.	MANHOLE	ST.	STEEL
C.I.P.	CAST IN PLACE	F.O.F.	FACE OF FINISH	MIN.	MINIMUM	STOR.	STORAGE
C.I.P.C.	CAST IN PLACE CONCRETE	F.O.S.	FACE OF STUDS	MIR.	MIRROR	STRL.	STRUCTURAL
C.G.	CORNER GUARD	FPRF.	FIREPROOF	MISC.	MISCELLANEOUS	SUSP.	SUSPENDED
C.J.	CONTROL JOINT	F.R.	FIRE RATED	MLDG.	MOULDING	SV RNG	SELF-VENTING RANGE HOOD
CLG.	CEILING	F.S.	FULL SIZE	MLWK.	MILLWORK	SYM.	SYMMETRICAL
CLKG.	CAULKING	FT.	FOOT OR FEET	MOD.	MODULAR	SYS.	SYSTEM
CLO.	CLOSET	FTG.	FOOTING	M.O.	MASONRY OPENING		
CLR.	CLEAR	FURR.	FURRING	MTD.	MOUNTED		
C.O.	CONCRETE OPENING	FUT.	FUTURE	MTL. MUL.	METAL MULLION	T. or TRD.	TREAD
COL.	COLUMN	0.4	CALICE	WUL.	WIGELIGIN	T.B.	TOWEL BAR
CONC.	CONCRETE	GA.	GAUGE			T.C.	TOP OF CURB
CONN. CONSTR.	CONNECTION CONSTRUCTION	GALV. G.B.	GALVANIZED GRAB BAR	N.	NORTH	TEL. T. & G.	TELEPHONE TONGUE and GROOVE
CONSTA.	CONTINUOUS	G.B. GL.	GLASS	N.I.C.	NOT IN CONTRACT	THK.	THICK
CORR.	CORRIDOR	GL. GND.	GROUND	NO. or #	NUMBER.	THLD.	THRESHOLD
CTSK.	COUNTERSUNK	GR.	GRADE	NOM.	NOMINAL	TP.	TEMPERED
CNTR.	COUNTER	GWB.	GYPSUM WALL BOARD	N.T.S.	NOT TO SCALE		TEIVIII EITED
C.T.	CERAMIC TILE	GYP.	GYPSUM	O.A.	OVERALL	T.V.	TELEVISION
CTR.	CENTER			OBS.	OBSCURE	T.W.	TOP OF WALL
		H.B.	HOSE BIBB	O.C.	ON CENTER	TYP.	TYPICAL
DBL.	DOUBLE	H.C.	HOLLOW CORE, HANDICAPPED	0.D.	OUTSIDE DIAMETER		
DEM.	DEMOLITION	HDWD.	HARDWOOD	OFF.	OFFICE		
DEPT.	DEPARTMENT	HDWE.	HARDWARE	OPNG.	OPENING	U.L.	UNDERWRITER'S LABORATOR
D.F.	DRINKING FOUNTAIN	H.M.	HOLLOW METAL	OPP.	OPPOSITE	UNF.	UNFINISHED
DET.	DETAIL	HORIZ.	HORIZONTAL			U.O.N.	UNLESS OTHERWISE NOTED
DIA.	DIAMETER	HR.	HOUR	P.C.C.	PRECAST CONCRETE		
DIM.	DIMENSION	HGT.	HEIGHT	PERF.	PERFORATED	V.B.	VAPOR BARRIER, VINYL BASE
DISP.	DISPENSER	HTR.	HEATER	PERIM.	PERIMETER	VCT	VINYL COMPOSITION TILE
DN.	DOWN	HVAC	HEATING, VENTILATING,	PKG.	PARKING	VEN.	VENEER
D.O.	DOOR OPENING		& AIR CONDITIONING	PRCST.	PRECAST	VERT.	VERTICAL
DR.	DOOR	H.W.	HOT WATER	PL.	PLATE	VEST.	VESTIBULE
DWR.	DRAWER			P.LAM.	PLASTIC LAMINATE	V.I.F.	VERIFY IN FIELD
DS.	DOWNSPOUT			PLAS.	PLASTER	VIN.	VINYL
D.S.P.	DRY STANDPIPE			PLYWD.	PLYW00D		
DW	DISHWASHER			PNL.	PANEL	W.	WEST
DWG.	DRAWING			POL.	POLISHED	W/	WITH
				PR.	PAIR	W.C.	WATER CLOSET
				PT.	POINT	WD.	WOOD
				PTD.	PAINTED	W.H.	WALL HUNG
				PTN.	PARTITION	WIN.	WINDOW
						W/O	WITHOUT
				0.7		WP.	WATERPROOF
				Q.T.	QUARRY TILE	W.R.	WATER RESISTENT
				QTR.	QUARTER	WSCT.	WAINSCOT
						WT.	WEIGHT

LEGEND:

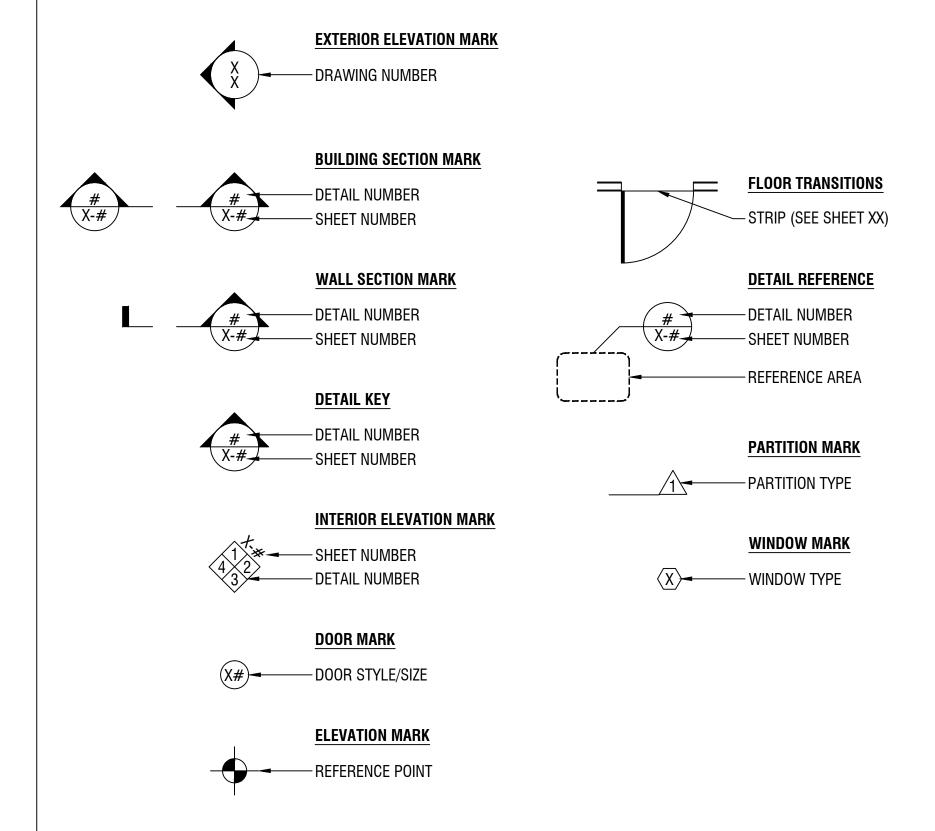

MECHANICAL SYSTEMS:

- 4 HEADS.

.95 OR HIGHER

READING MEASURED.

- SHOWERHEAD

- LAVATORY FAUCET

USE ENERGY STAR APPLIANCES

- TOILET

- COMPRESSOR SIZED

- HSPF OF 12 OR GREATER

- SEER OF 20 OR GREATER

- COMPRESSOR SIZED

HEATING/COOLING SYSTEM:

HOT WATER SYSTEM:

PASSIVE RADON SYSTEM:

TO BE SOLAR PV READY:

PLUMBING:

APPLIANCES:

ERV SYSTEM:

- NO DUCTS SHALL BE INSTALLED

2. DUCTED FORCED HOT AIR SYSTEM w/ AC SYSTEM

PROVIDE ENERGY RECOVERY SYSTEM (ERV) BY

PANASONIC FV04VE1. VENMAR OR EQUIVALENT

ASTM E1465 PRACTICE FOR RADON CONTROL OPTIONS

INSTALL CONDUIT FROM ROOF TO AREA IN BASEMENT

GUIDELINES, AN ACCESSIBLE SAFETY OFF SWITCH BOX

WATER SENSE (EPA) FOR ALL INTERIOR PLUMBING DEVICES;

USE NATURAL GAS RANGE AND EXHAUST RANGE TO EXTERIOR

2012 IECC STANDARDS FOR EFFICACY

- FURNACE TO BE NATURAL GAS, 95% EFFICIENT

- AC COMPRESSOR SEER OF 15 OR GREATER

- NO DUCTS OR SOFFITS SHALL BE EXPOSED. DUCT WORK SHALL BE

GAS DOMESTIC HOT WATER SYSTEM - INSTANTANEOUS GAS DHW SYSTEM EF OF

PROVIDE A RADON RESISTANT CONSTRUCTION TECHNIQUES INCLUDING A PASSIVE

ATTIC FOR INSTALLING A FAN, MAKING IT AN ACTIVE SYSTEM, IF THERE IS A HIGH

IN BASEMENT ROOM FOR A SOLAR METER, AN INVERTER AND A SWITCH BOX

ON EXTERIOR OF BASEMENT ROOM FOLLOWING THE LOCAL ELECTRIC COMPANY

SYSTEM WHICH FROM THE PERFORATED PIPE UNDER THE SLAB, UP THROUGH SLAB, AND HOUSE, TERMINATING ABOVE THE ROOF WITH AN ELECTRICAL OUTLET IN THE

CAPABLE OF MEETING VENTILATION CODE 50-80 CFM THAT MEETS THE

INSTALLED IN FLOOR BAYS BETWEEN JOIST OR IN WALLS BETWEEN STUDS

1. FAJITSU. MITSHUBISHI. OR EQUAL MINI SPLIT HEAT PUMP SYSTEM

GENERAL NOTES:


- 1. ALL MATERIALS, WORKMANSHIP AND DETAILS SHALL CONFORM WITH COMMONWEALTH OF MASSACHUSETTS BUILDING CODE-9TH EDITION.
- 2. THE CONTRACTOR SHALL FAMILIARIZE THEMSELVES WITH THE CONTRACT DOCUMENTS AND DISCREPANCIES SHALL BE BROUGHT TO THE ATTENTION OF THE ARCHITECT PRIOR TO PROCEEDING WITH THE AFFECTED WORK. THE PROJECT MANUAL SETS OUT THE HIERARCHY OF THE DRAWINGS AND SPECIFICATIONS. ANY VARIATION OR SUBSTITUTION OF MATERIALS OR DETAILS FROM THOSE SHOWN ON THE DRAWINGS MAY BE MADE ONLY WITH THE PRIOR APPROVAL OF THE ARCHITECT
- 3. THE CONTRACTOR SHALL VERIFY ALL SITE CONDITIONS. CHECK ALL DIMENSIONS PRIOR TO CONSTRUCTION AND NOTIFY THE ARCHITECT OF ANY CONDITIONS REQUIRING MODIFICATIONS TO THE DRAWINGS.
- 4. ABBREVIATIONS USED ON THE DRAWINGS ARE SELF-EVIDENT OR AS ACCEPTED IN THE INDUSTRY AND SUCH AS THE INTERPRETATION OF THE ARCHITECT. THE CONTRACTORS REQUEST FOR INTERPRETATION SHALL BE ADDRESSED TO THE ARCHITECT.
- 5. ALL DOCUMENTS INCLUDING THE PROJECT MANUAL(IF ANY) AND REFERENCED STANDARDS ARE INTENDED TO BE COMPLEMENTARY. IT IS INTENDED THAT ALL TRADES SHALL FAMILIARIZE THEMSELVES WITH THE ENTIRE SET OF DOCUMENTS AS IT IS RELATED TO THEIR TRADE.
- 6. INTERIOR DIMENSIONS ARE TAKEN FROM THE EXTERIOR FACE OF STUD OR MASONRY TO CENTERLINE OF INTERIOR PARTITIONS UNLESS OTHER WISE NOTED. CLEAR DIMENSIONS "CLR." FROM FACE OF FINISH TO FACE OF FINISH. MINIMUM CLEAR "MIN CLR." IS A MINIMUM DIMENSION THAT MUST BE
- 7. THERE SHALL BE NO EXPOSED ELECTRICAL DISTRIBUTION IN ALL HABITABLE AREAS U.O.N.
- 8. THE CONTRACTOR SHALL BE RESPONSIBLE FOR PROVIDING ALL BLOCKING, FRAMING AND FIRE STOPPING AS REQUIRED BY THE DOCUMENTS AND THE BUILDING CODE.
- 10. ALL RISERS FOR DUCTS AND PIPES, SHALL BE BOXED IN WITH GYPSUM WALLBOARD TO PROVIDE TWO HOUR FIRE RATING. WHERE POSSIBLE, LOCATE RISER IN A CORNER OR WHERE SHOWN IN A CLOSET OR LINEN CLOSET. LOCATE AT END OF CLOSET TO PROVIDE MAXIMUM CLEAR SPACE, NOTIFY ARCHITECT OF ALL CONFLICTS.
- 11. CONSTRUCTION TO COMPLY WITH REQUIREMENTS OF ENERGY STAR. COMPLY WITH THE REQUIREMENTS CONTAINED IN THE FOLLOWING DOCUMENTS: ENERGY STAR HOMES TECHNICAL STANDARDS VERSION 3 FIELD GUIDE TO RESIDENTIAL NEW CONSTRUCTION, AUGUST 2000
- 12.1. BASIC AIR SEALING: MAXIMUM ALLOWABLE AIR LEAKAGE IS 2 SQUARE INCHES LEAKAGE PER 100 SQUARE FEET OF BUILDING SHELL AREA.
- 12.2. ALL RECESSED LIGHTS MUST BE AIRTIGHT. ANY RECESSED LIGHTS THAT PENETRATE THE SHELL OF THE BUILDING MUST BE INSULATION CONTACT (IC) RATED AND AIRTIGHT.
- 12.3. WINDOWS FRAMES AND DOOR JAMBS MUST BE SEALED TO THEIR ROUGH OPENINGS USING LOW EXPANSION FOAM, BACKER ROD, OR CAULK. DO NOT USE FIBERGLASS FOR THIS PURPOSE. IT IS NOT AN EFFECTIVE AIR BARRIER.
- 12.4. ALL PENETRATIONS THROUGH THE INSULATED ENVELOPE MUST BE CAREFULLY SEALED. TYPICAL PENETRATIONS INCLUDE CHIMNEY, DUCT AND PLUMBING CHASES AND PENETRATIONS OF PIPES AND WIRES THROUGH THE TOP PLATES OF TOP STORY WALLS. IT IS PARTICULARLY IMPORTANT TO SEAL ANY POSSIBLE AIR PATHS TO THE ATTIC AS THESE BY-PASSES ARE NOT ONLY SOURCE OF ENERGY LOSS BUT ALSO PROVIDE PATHS FOR MOISTURE TO MIGRATE INTO THE ATTIC.
- 12.5. BATTS MUST BE INSTALLED AT FULL LOFT WITHOUT GAPS OR EMPTY POCKETS.
- 12.6. BATTS MUST BE CUT TO ACCOMMODATE ALL OBSTRUCTIONS (I.E. PLUMBING AND ELECTRICAL). PROPER INSTALLATION IS CRITICAL TO ENSURE ITS RATED PERFORMANCE.
- 12.7. THE INSULATION MUST BE COMPLETELY FILL THE STUD CAVITIES.
- 12.8. ATTIC AND CRAWL SPACE ACCESS HATCHES MUST BE COVERED WITH A MINIMUM OF R-60 INSULATION, PERMANENTLY ATTACHED TO THE HATCH.
- 12.9. A VAPOR RETARDER IS REQUIRED ON THE WINTER WARM SIDE OF THE INSULATION.
- 12.10. TO EFFECTIVELY REDUCE AIR LEAKAGE, BUILDING AREAS SUCH AS KNEEWALL-FLOOR TRANSITIONS, DROPPED SOFFITS, AND CANTILEVERS MUST BE IDENTIFIED AND SEALED CAREFULLY WITH CONTINUOUS AIR BARRIER. WHERE JOIST SPANS OR STUD BAYS RUN BETWEEN A HEATED AREA AND UNHEATED AREA, ALL BAYS MUST BE BLOCKED AND SEALED AT THE TRANSITION.
- 12.11. ATTIC AND CRAWL SPACE ACCESS DOORS OR HATCHES MUST BE WEATHER-STRIPPED.

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Stamped by:	CIVIN
Drawn By:	RWC
Checked By:	СМК
Date:	6/8/2018
Revisions	
PERMIT SET - REVIEW	6/22/2020
PERMIT SET - REVIEW	5/21/2020
o INITIAL SUBMISSION	6/8/2018

DND PROJECT

SYMBOLS, SYSTEMS, ABBREVIATIONS AND GENERAL NOTES

AS SHOWN Scale:

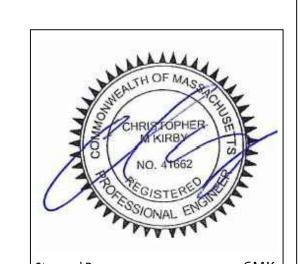GENERAL CONSTRUCTION NOTES

- 1. ALL DIMENSIONS ARE CALCULATED FROM OUTSIDE FACE OF EXTERIOR WALLS TO THE CENTERLINE OF INTERIOR STUD WALLS UNLESS OTHERWISE NOTED. STUD WALLS NOT DIMENSIONED ARE TYPICALLY 2x6 (5 1/2") FOR BOTH INTERIOR AND EXTERIOR WALLS.
- 2. THE PROJECT IS A NEW STRUCTURE. EXACT DIMENSIONS, ELEVATIONS, TIE-IN POINTS, ROOF SLOPES, BEARING POINT LOCATIONS ARE REPRESENTED AS ACCURATE AS KNOWN AT THE TIME OF THE DRAWING SET CREATION. FIELD VERIFICATION OF ALL ELEMENTS IS REQUIRED BY THE CONTRACTOR AND IF INCONSISTENCIES OCCUR, NOTIFY THE ENGINEER FOR DIRECTION. THE ENGINEER IS NOT RESPONSIBLE FOR CHANGES TO THE PLANS WITHOUT DIRECTION.
- WINDOWS APPEARING ON THE FLOOR PLANS AND EXTERIOR ELEVATIONS ARE TO BE CONFIRMED BY THE OWNER.
- 4. THE WINDOW FINAL SILL HEIGHT AT THE FIRST FLOOR IS 24" ABOVE FINISH FLOOR UNLESS NOTED OTHERWISE.
- 5. GENERAL CONTRACTOR TO REVIEW ALL BUILT IN REQUIREMENTS WITH THE OWNER INCLUDING SHELVING, CLOSETS, PANTRY, ETC., IF APPLICABLE.
- 6. ALL REQUIREMENTS FOR SECURITY SYSTEMS, CENTRAL VACUUM, AND ANY AUDIO, COMPUTER OR CABLE TELEVISION SYSTEMS TO BE COORDINATED WITH OWNER.
- 7. ALL PERMITS AND VARIANCES, IF NECESSARY, ARE THE RESPONSIBILITY OF THE OWNER AND GENERAL CONTRACTOR PRIOR TO START OF
- 8. ALL FINISH COLORS TO BE THE RESPONSIBILITY OF THE OWNER.

GENERAL FLOOR PLAN NOTES

- 1. DO NOT SCALE DRAWINGS. FOLLOW DRAWING DIMENSIONS ONLY. DIMENSION IS NOT CALLED OUT, VERIFY DIMENSIONS WITH ENGINEER.
- 2. ALL DIMENSIONS ARE CALCULATED FROM OUTSIDE FACE OF EXTERIOR WALLS TO THE CENTERLINE OF INTERIOR STUD WALLS (UNO). STUD WALLS NOT DIMENSIONED ARE TYPICALLY 2x6 FOR EXTERIOR WALLS AND 2x4 FOR INTERIOR WALLS (UNO).
- 3. ALL INTERIOR WALLS ARE TO BE COVERED WITH 1/2" GYPSUM BOARD, METAL CORNER REINFORCING, TAPE SEAMS AND PLASTER SKIMCOAT.
- 4. ALL WALLS IN THE GARAGE TO HAVE A LAYRER OF 5/8", TYPE "X" FIRE RATED GYPSUM BOARD (UNO).
- 5. ALL BATH AND TOILET AREA WALLS AND CEILINGS ADJACENT TO WET AREAS TO HAVE WATER RESISTANT GYPSUM BOARD.
- 6. BEDROOM WINDOWS TO HAVE A MINIMUM NET CLEAR OPENING OF 3.38 SQFT., A MINIMUM NET CLEAR OPENING OF 20" WIDE x 24" HIGH IN EITHER DIRECTION, AND HAVE A MAXIMUM FINISHED SILL HEIGHT OF 44" FROM FINISHED FLOOR.
- 7. ALL GLASS LOCATED WITHIN 18" OF FLOOR OR 24" OF A DOOR SWING MUST BE TEMPERED GLASS.
- 8. BATHROOMS AND UTILITY ROOMS TO BE VENTED TO THE OUTSIDE WITH A MINIMUM OF 50 CFM FAN. RANGE HOODS TO BE VENTED TO THE OUTSIDE.
- 9. SUBCONTRACTOR TO FIELD VERIFY ALL CABINET DIMENSIONS BEFORE FABRICATION.

GENERAL FLEVATION NOTES

- 1. ICE & WATER SHIELD TO BE INSTALLED CORRECTLY AT ALL CONNECTIONS BETWEEN ROOFS, WALLS, CHIMNEYS, PROJECTIONS, AND PENETRATIONS AND UNDER FIRST 36" OF PERIMETER OF ROOF.
- 2. ICE & WATER SHIELD TO BE PLACE OVER ENTIRE ROOF SURFACE WHEN ROOF SLOPE IS BELOW A 4/12 PITCH.
- 3. ADEQUATE ATTIC VENTILATION AND ROOF VENTS ARE TO BE PROVIDED AS SHOWN ON PLANS.
- 4. ALL PLUMBING AND MECHANICAL VENTS TO BE LOCATED CLOSE TOGETHER WITHIN THE ATTIC SPACE WHEN POSSIBLE TO MINIMIZE THE NUMBER OF ROOF PENETRATIONS. ALL PLUMBING AND MECHANICAL VENTS WHICH APPEAR ABOVE THE ROOF TO BE LOCATED AWAY FROM ANY PROMINENT VIEW. NO VENT TO BE ALLOWED ON THE FRONT ROOF. ALL METAL AND PVC VENTS AND PENETRATIONS TO BE PRIMED AND PAINTED TO CLOSELY MATCH ROOF COLOR.
- 5. GUTTERS AND DOWN SPOUTS ARE NOT LOCATED ON ELEVATION DRAWINGS. LOCATIONS OF DOWN SPOUTS ARE TO BE DETERMINED ON-SITE DUE TO TOPOGRAPHICAL CONDITIONS TO ALLOW POSITIVE DRAINAGE AWAY FROM THE HOUSE. DOWN SPOUTS NOT TO BE LOCATED IN PROMINENT LOCATIONS, GUTTERS AND DOWN SPOUTS ARE TO CLOSELY MATCH TRIM COLOR OF THE HOUSE.
- 6. ALL FLASHING TO BE OF THE SAME MATERIAL. DISSIMILAR METALS NOT ALLOWED.
- 7. OWNER RESPONSIBLE FOR SELECTING ROOF COLOR.

GENERAL STAIRWAY NOTES

- 1. STAIRWAYS SHALL NOT BE LESS THAN 36" IN CLEAR WIDTH AT ALL POINTS ABOVE THE PERMITTED HANDRAIL HEIGHT AND THE PERMITTED HEADROOM HEIGHT. THE MINIMUM WIDTH AT OR BELOW THE HANDRAIL HEIGHT SHALL NOT BE LESS THAN 32" WHERE A HANDRAIL IS INSTALLED ON ONE SIDE AND 28" WHERE HANDRAILS ARE PROVIDED ON BOTH SIDES.
- 2. THE MINIMUM HEADROOM IN ALL PARTS OF THE STAIRWAY SHALL NOT BE LESS THAN 6'-8" MEASURED VERTICALLY FROM THE SLOPED PLANE ADJOINING THE TREAD NOSING OR THE NOSING FROM THE FLOOR SURFACE OF THE LANDING OR PLATFORM.
- 3. THE MAXIMUM RISER HEIGHT SHALL BE 8 1/4" AND THE MINIMUM TREAD DEPTH SHALL BE 9". TREAD NOSING SHALL NOT EXTEND MORE THAN 1 1/2" BEYOND THE FACE OF THE RISER BELOW.
- 4. OPEN SIDES OF STAIRS WITH A TOTAL RISE OF MORE THAN 30" ABOVE THE FLOOR/GRADE SHALL HAVE GUARDRAILS, WHICH SHALL ALSO SERVE AS HANDRAILS, NOT LESS THAN 36" IN HEIGHT.
- 5. REQUIRED GUARDRAILS ON OPEN SIDES OF STAIRWAYS, BALCONIES, PORCHES, DECKS AND RAISED FLOOR AREAS, SHALL HAVE BALUSTERS WHICH PREVENT THE PASSAGE OF AN OBJECT 4" OR MORE IN DIAMETER.

GENERAL FOUNDATION NOTES

- 1. ALL CONCRETE WORK SHALL CONFORM WITH THE LATEST
- REQUIREMENTS OF THE AMERICAN CONCRETE INSTITUTE (ACI).
- 2. THE MINIMUM COMPRESSIVE STRENGTH OF CONCRETE AT THE END OF 28 DAYS SHALL BE 4000 PSI.
- 3. ALL SLABS TO BE PLACED ON A 6 MIL VAPOR BARRIER OVER 6" OF COMPACTED GRAVEL.
- 4. PROVIDE A 1/2" EXPANSION JOINT MATERIAL BETWEEN ALL CONCRETE SLABS ON ABUTTING CONCRETE OR MASONRY WALLS OCCURRING IN EXTERIOR OR UNHEATED AREAS.
- 5. PROVIDE DEEP SCORE CONTROL JOINTS AT MID POINTS OF ALL SLABS. BOTH DIRECTIONS.
- 6. PROVIDE 1 COAT OF MASTIC ON EXTERIOR SURFACE OF FOUNDATION WALL BELOW GRADE.

7. FOUNDATION WALLS TO EXTEND A MINIMUM OF 36" ABOVE FINISH

8. PROVIDE 1" DIA ANCHOR BOLTS AS SHOWN ON THE FOUNDATION PLAN.

LOCATION LIVE (PSF) DEAD (PSF) DEFLECTION

GENERAL FRAMING NOTES:

200/111011		<u> </u>	DEFECTION
COMMON AREAS	40	15	L / 360
SLEEPING AREAS	30	15	L / 360
ATTIC (STORAGE)	20	15	L / 240
ATTIC (NO STORAGE)) 10	15	L / 240
ROOF (SNOW LOAD)	40	15	L / 240
DECK	40	15	L / 360
BALCONY	60	15	L / 360

- 1. ALL FRAMING MATERIAL TO BE MINIMUM #2 OR BETTER KD LUMBER,
- 2. ALL WOOD FRAMING IN CONTACT WITH CONCRETE OR MASONRY TO BE PRESSURE TREATED (PT),
- 3. PROVIDE DOUBLE FLOOR JOISTS UNDER ALL WALLS WHICH RUN PARALLEL TO THE DIRECTION OF THE JOIST SPAN,
- 4. PROVIDE 1"x3" CROSS BRIDGING OR 2"x6" BLOCKING AT THE MIDSPAN OF ALL FLOOR JOISTS,
- 5. FLOOR CONSTRUCTION: 3/4" TONGUE AND GROOVE SUBFLOOR GLUED AND NAILED TO FLOOR FRAMING. FINISH FLOORING TO BE FITHER 3/4" HARDWOOD.
- 6. ALL STUD FRAMED WALLS TO BE FRAMED AT 16" ON CENTER, MAXIMUM.
- 7. ALL ANGLED WALLS ARE TO BE FRAMED AT 45 DEGREES (UNO),
- 8. HEADER SIZE OVER WINDOWS TO BE (3)2"x8" (UNO).
- 9. ALL HEADERS TO BE FREE FROM SPLITS AND CHECKS,
- 10. PROVIDE FULL SOLID BEARING OR STUD BEARING UNDER ALL BEAM BEARING POINTS,
- 11. ALL BEAM AND JOIST INTERSECTIONS TO BE FLUSH FRAMED WITH GALVANIZED JOIST HANGERS AND INSTALLED PER MANUFACTURERS RECOMMENDATIONS.

12. ALL BEAMS TO HAVE TRIPLE STUD BEARING UNDER EACH END,

- 13. UNLESS OTHERWISE NOTED, PROVIDE A 2x PLATE BOLTED TO THE TOP
- FLANGE OF ALL STEEL BEAMS WITH 3/8" DIAMETER GALVANIZED BOLTS STAGGERED AT 24" ON CENTER,
- 14. UNLESS OTHERWISE NOTED, PROVIDE DOUBLE HEADER JOIST AND TRIMMERS AT ALL FLOOR OPENINGS,
- 15. STAIR CONSTRUCTION TO CONSIST OF $3-2"\times12"$ STRINGERS, MINIMUM,
- 16. TEMPORARY GUARDRAILS MUST BE INSTALLED AT ALL FLOOR OPENINGS, 17. ALL WALLS OVER 10'-0" HIGH TO BE 2"x6"s AT 16" ON CENTER AND RECEIVE 1 ROW OF 2"x6" BLOCKING AT MID-HEIGHT,
- 18. 2"x6" EXTERIOR WALLS TO BE SHEATHED WITH 1/2" EXTERIOR GRADE PLYWOOD. SHEATHING TO SPAN OVER ALL PLATES AND HEADERS. INSTALL SHEATHING WITH AN 1/8" GAP BETWEEN PANELS AND BLOCK ALL SEAMS - BOTH VERTICAL AND HORIZONTAL,
- 19. FLOOR FRAMING LAYOUT IS CONSTRUCTED AS TO PROVIDE BEST POSSIBLE ACCESS TO THE HVAC DUCTS AND UNOBSTRUCTED RUNS FOR THE DUCT WORK,
- 20. PROVIDE BLOCKING AT ALL CABINET LOCATIONS,
- 21. PROVIDE 2"x4" RAFTER TIES AT ALL PLATES WHERE JOIST RUN IS PERPENDICULAR TO RAFTERS,
- 22. HIP VALLEY RAFTERS AND RIDGE BOARDS TO BE ONE SIZE LARGER THAN TYPICAL RAFTERS UNLESS OTHERWISE NOTED ON PLANS,
- 23. PROVIDE 1"x6" COLLAR TIES AT UPPER 1/3 OF VERTICAL DISTANCE BETWEEN RIDGE BOARD AND CEILING JOIST AT 48" ON-CENTER.
- 24. PROVIDE INSULATION BAFFLES AT EAVE VENTS BETWEEN RAFTERS. 25. REQUIRED GUARDRAILS ON BALCONIES, PORCHES, DECKS, AND RAISED
- FLOOR AREAS. SHALL HAVE A MINIMUM HEIGHT OF 36" MEASURED. VERTICALLY FROM THE FINISHED FLOOR.
- 26. ALL HARDWARE AND FLASHING IN CONTACT WITH ACQ TREATED LUMBER MUST BE HOT DIPPED GALVANIZED OR STAINLESS STEEL,
- 27. IF ON-SITE CONDITIONS DIFFER FROM THOSE SHOWN ON THE PLANS. CONTRACTOR TO NOTIFY ENGINEER IMMEDIATELY FOR DIRECTION.

GENERAL ELECTRICAL NOTES

- 1. ELECTRICAL CONTRACTOR TO BE RESPONSIBLE FOR ADHERING TO ALL CODES AND SAFETY REQUIREMENTS.
- 2. GENERAL AND ELECTRICAL CONTRACTOR TO REVIEW THE PLAN(S) AND WALK THROUGH THE JOB TO VERIFY THAT THE DESIGN INTENT IS MAINTAINED.
- 3. ELECTRICAL SERVICE TO BE PROVIDED AS REQUIRED FOR ALL APPLIANCES AND EQUIPMENT SUCH AS REFRIGERATOR. DISH WASHER. DISPOSAL, HVAC EQUIPMENT, ALARM PANEL, LAWN SPRINKLER SYSTEM, ETC. OUTLET TO BE PROVIDED ABOVE THE RANGE FOR MICROWAVE OR HOOD VENT IF FINAL KITCHEN LAYOUT REQUIRES.
- 4. ALL OUTLETS PLACED NEAR ANY WATER CONDITION TO BE G.F.C.I.
- SWITCHES AND OUTLETS TO BE COORDINATED WITH OWNER.
- PROVIDE EXTERIOR WATERPROOF OUTLETS AS REQUIRED BY CODE. 7. ALL PHONE OUTLETS, COMPUTER OUTLETS, CABLE TV OUTLETS, AND
- ELECTRONIC DEVICE OUTLETS TO BE VERIFIED BY OWNER.
- 8. DIMMERS TO BE SIZED FOR THE APPROPRIATE LOAD OF THE FIXTURES AND LAMPS SELECTED.
- VERIFY TRIM SIZE FOR ALL DOORS AND WINDOWS PRIOR TO LOCATING SWITCHES. ALL LOCATIONS SHOULD BE CLOSE TO TRIM AND ALIGNED WITH ONE ANOTHER. IF THERE ARE MULTIPLE.
- 10. BLOCK AND PREWIRE SEPARATE SWITCHES TO EACH LIGHT AND CEILING.
- 11. IF EXTERIOR SECURITY LIGHTING IS DESIRED BY OWNER THE TYPE. LOCATION, AND REQUIRED SWITCHING MUST ALL BE VERIFIED BY
- 12. IF AN ALARM IS DESIRED ALL OF THE REQUIREMENTS MUST BE COORDINATED WITH THE OWNER.
- 13. PANEL BOX TO BE SIZED TO ACCOMMODATE ALL CALCULATED LOADS AND PROVIDE FOR A MINIMUM OF EIGHT (8) SPARES.
- 14. RECESSED FIXTURES LOCATED IN FIRE RATED WALLS (i.e. GARAGE CEILINGS OR FIRE SEPARATION ASSEMBLIES) SHALL BE RATED FIXTURES, FIRE RATED TO THE LEVEL OF FIRE SEPARATION OF THE WALL/CEILING IN WHICH THE FIXTURE IS INSTALLED.
- 15. PROVIDE ENERGY EFFICIENT LIGHTING AS REQUIRED PER THE 2015 IECC.

GENERAL PLUMBING/HVAC NOTES

- 1. PLUMBING SUBCONTRACTOR IS RESPONSIBLE FOR ADHERING TO ALL APPLICABLE CODES AND SAFETY REQUIREMENTS.
- 2. PROVIDE GAS SERVICE TO ALL WATER HEATERS, APPLIANCES, AND HVAC EQUIPMENT, AS REQUIRED.
- 3. IF WALL PLATES OR JOISTS ARE CUT DURING INSTALLATION OF PLUMBING FIXTURES OR EQUIPMENT, PROVIDE BRACING TO TIE FRAMING BACK TOGETHER.
- 4. ALL GAS WATER HEATERS TO BE VENTED AT TOPOUT.
- 5. ALL PLUMBING AND MECHANICAL VENT STACKS TO BE LOCATED CLOSE TOGETHER IN THE ATTIC. VENT STACKS TO BE LOCATED TO THE REAR OF THE HOUSE AWAY FROM PROMINENT VIEW. ALL VENT STACKS TO BE PRIMED AND PAINTED TO CLOSELY MATCH ROOF COLOR.
- 6. HVAC CONTRACTOR TO PROPERLY SIZE HEATING AND COOLING SYSTEM FOR THE STRUCTURE.
- 7. IF A NEW KITHCEN EXHAUST FAN OVER 400 CFM IS INSTALLED, AN OUTSIDE MAKE-UP AIR SYSTEM IS REQUIRED.

ENERGY EFFICIENCY


- 1. ENERGY EFFICIENCY TO BE THE "PRESCRIPTIVE METHOD" IN ACCORDANCE WITH CHAPTER 4 (RESIDENTIAL ENERGY EFFICIENCY) OF THE THE 2015 INTERNATIONAL ENERGY CONSERVATION CODE (2015) IECC). SEE THIS CHAPTER FOR COMPLETE REQUIREMENTS.
- 2. THE BUILDINGS (NEW PORTION) THERMAL ENVELOPE SHALL MEET THE REQUIREMENTS OF TABLE R402.1.2. A SHORT VERSION OF TABLE R402.1.2 IS LISTED BELOW AND THE FULL VERSION SHALL BE REVIEWED FOR COMPLETE REQUIREMENTS.
- 3. THE 2015 IECC HAS STRICT REQUIREMENTS FOR ENERGY EFFICIENCY AND CHANGES TO THE CODE INCLUDE; HIGHER WALL R-VALUES, PERMANENT CERTIFICATE OF BUILDING COMPONENTS POSTED, AIR LEAKAGE TEST, BASEMENT INSULATION TO A DEPTH OF 10 FEET BELOW GRADE OR THE BASEMENT FLOOR (WHICHEVER IS LESS), RIM JOIST/WALL SEALING, RECESSED LIGHTING SHALL BE SEALED FIXTURES, JUNCTION BOXES ON EXTERIOR WALLS SHALL BE INSULATED, ATTIC ACCESS SHALL BE SEALED, ETC.
- 4. THE CITY OF BOSTON HAS ADOPTED THE "STRETCH ENERGY CODE". ADDITIONAL ENERGY EFFICIENCY REQUIREMENTS MAY APPLY.

		TABLE R402	.1.2 – PAR	TIAL LIST ((2015 IECC)	
•	CLIMATE ZONE	FENESTRATION U-FACTOR	SKYLIGHT U-FACTOR		WOOD FRAME WALL R-VALUE	FLOOR R-VALUE
	5	0.30	0.55	49	20	30

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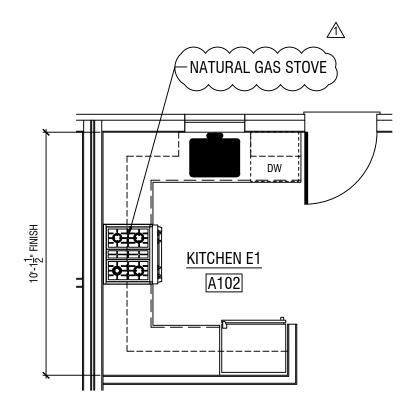
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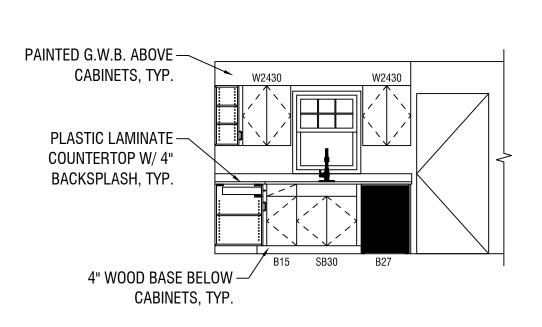
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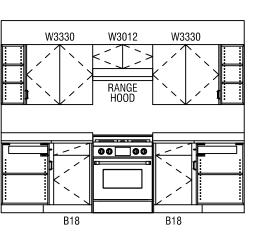
GENERAL NOTES

T-1.1

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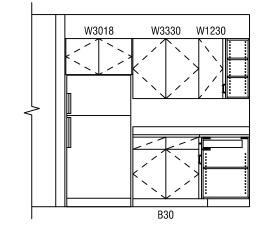


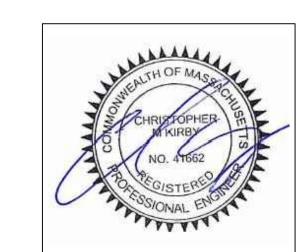



2 ELEVATION

1/4" = 1'-0"



3 ELEVATION 1/4" = 1'-0"

TYPE E1 KITCHEN PLAN

1/4" = 1'-0"

1 ELEVATION
1/4" = 1'-0"

CM KIRBY ENGINEERING, PLLC
ARCHITECTS ENGINEERS

7A HALF MOON

STREET

BOSTON, MA

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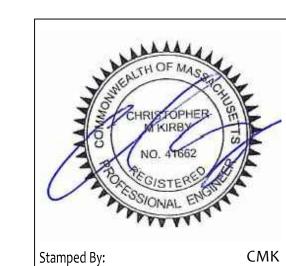
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KITCHEN - GENERAL NOTES:

- 1. THESE KITCHEN PLANS & ELEVATIONS ARE PROVIDED FOR REFERENCE ONLY
- 2. MODEST REVISIONS TO THE LAYOUT & MATERIALS ARE ACCEPTABLE
- 3. D.N.D. HIGHLY ENCOURAGES THE APPLICATION OF UNIVERSAL DESIGN PRINCIPLES
- 4. COORDINATE PLANS & ELEVATIONS WITH FINAL DRAWINGS

KITCHEN CABINETS - GENERAL NOTES:

- 1. PLASTIC TRIM EDGE ON ALL EXPOSED PLASTIC LAMINATE WALL COVER EDGES.
- 2. IF USED, STAINLESS STEEL BACKSPLASH
 SHALL BE USED BEHIND THE STOVE AND EXTEND
 FROM THE BOTTOM OF THE CABINETS TO THE
 TOP OF THE COUNTERTOP BACKSPLASH
- 3. INSTALL DUPLEX OUTLET AT 6" ABOVE THE TOP OF THE COUNTERTOP TYP. SEE ELECTRICAL DWGS.
- 4. ALL EXPOSED END PANELS SHALL BE FINISHED INSTALL WOOD BASE & BASE UNIT END PANELS INCLUDING BEHIND APPLIANCES
- 5. INSTALL WOOD BASE ON WALLS BEHIND ALL APPLIANCES.
- 6. VERIFY ALL DIMENSIONS AT SITE PRIOR TO SUBMISSION OF SHOP DRAWINGS.
- 7. INSTALL FILLER STRIPS TO MAKE UP VARIATIONS IN DIMENSIONS 3" MAXIMUM.
- 8. PROVIDE DOUBLE BOWL SINKS IN ALL UNITS.
- 9. FIELD MEASURE ROUGH FRAMING FOR, AND PROVIDE SHOP DRAWING FOR REVIEW
- 10. PROVIDE FILLER PANELS FOR SPACES UP TO 3". IF OVER 3" PROVIDE NEXT CABINET SIZES.



Drawn By:

Checked By:

CMK

Date:

6/8/2018

Revisions

PERMIT SET - REVIEW

5/21/2020


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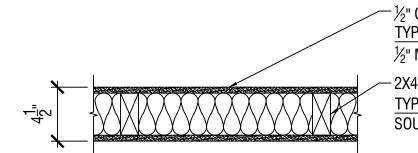
DND PROJECT

KITCHEN ELEVATIONS
AND DETAILS

Sheet No. G-1

Scale: AS SHOWN



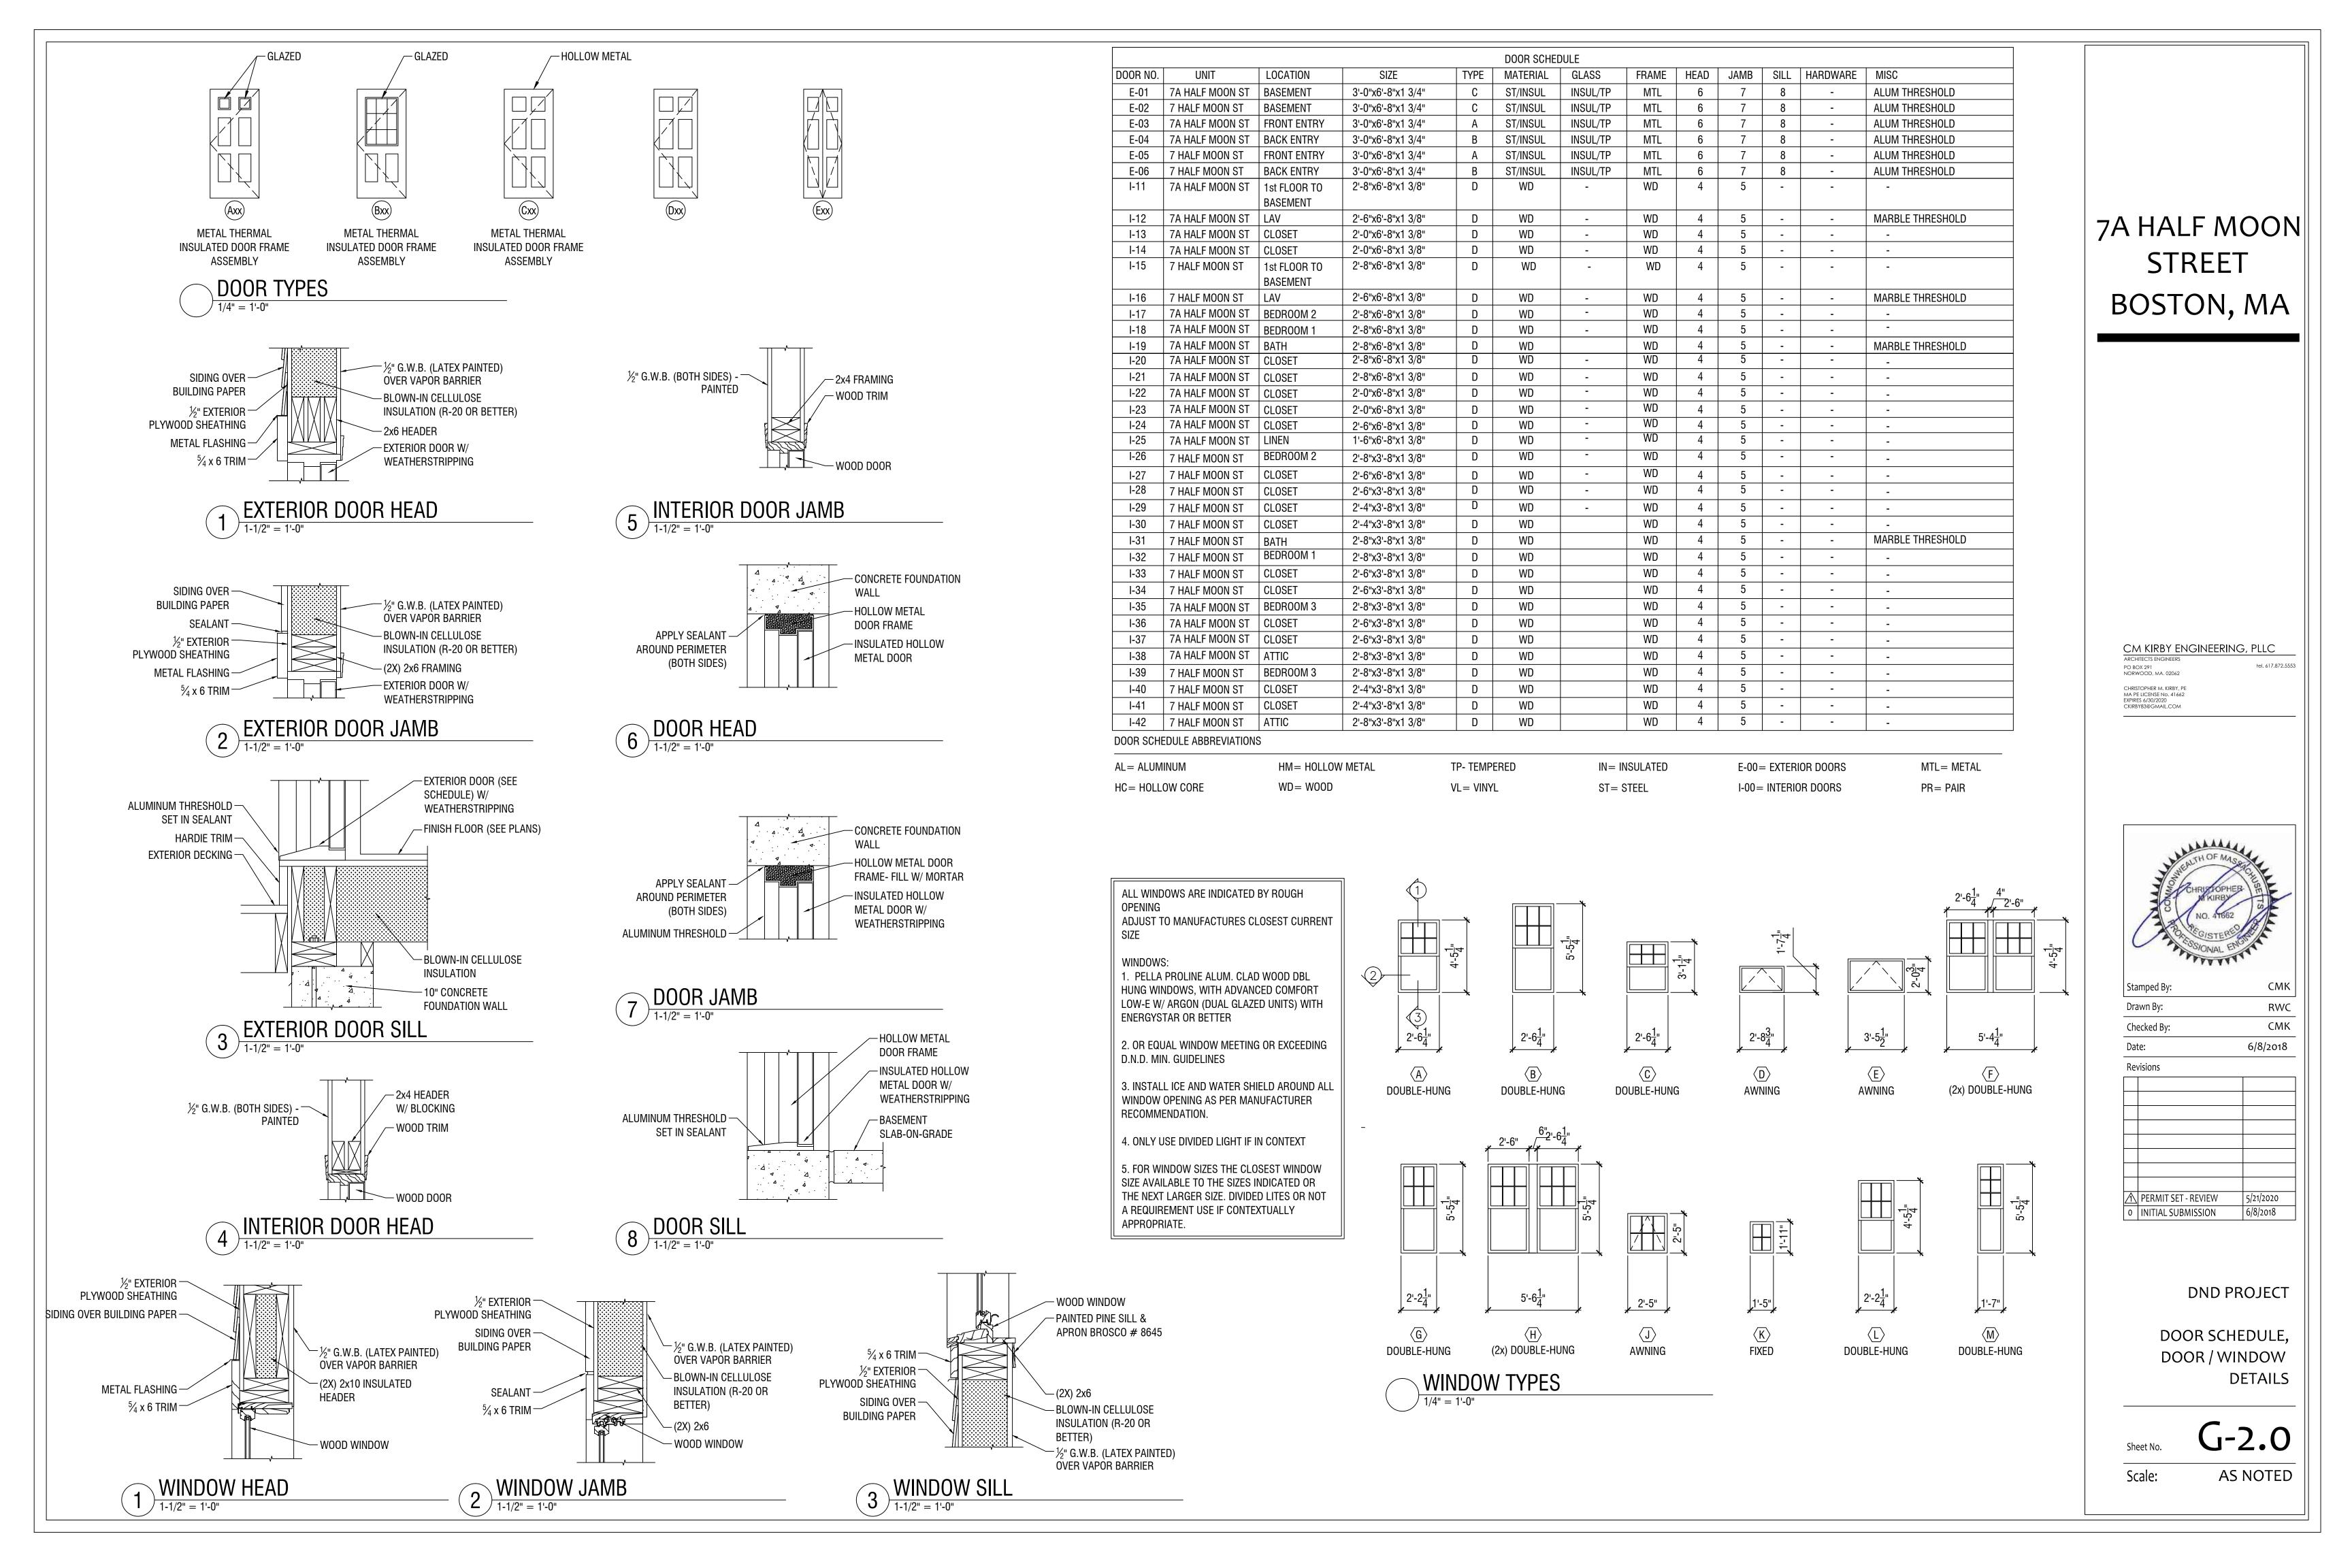

1\ TYP. INTERIOR PARTITION

1-1/2" = 1'-0"


 $-\frac{1}{2}$ " G.W.B (BOTH SIDES) - PAINTED TYPICAL @ BATHS/KITCHENS: ½" M.R.G.W.B.


−2X4 WOOD STUDS @ 16" O.C. TYPICAL @ BATHS: SOUND ATTENUATION BLANKETS



½" G.W.B (BOTH SIDES) - PAINTED TYPICAL @ BATHS/KITCHENS: ½" M.R.G.W.B. -2x6 WOOD STUDS @ 16" O.C. TYPICAL @ BATHS: SOUND ATTENUATION BLANKETS NOTE: ACOUSTICAL SEALANT - 3-1/2" SOUND ATTENUATION BLANKETS @ BASE & HEAD OF PARTITION

2 TYP. PLUMBING PARTITION 1-1/2" = 1'-0"

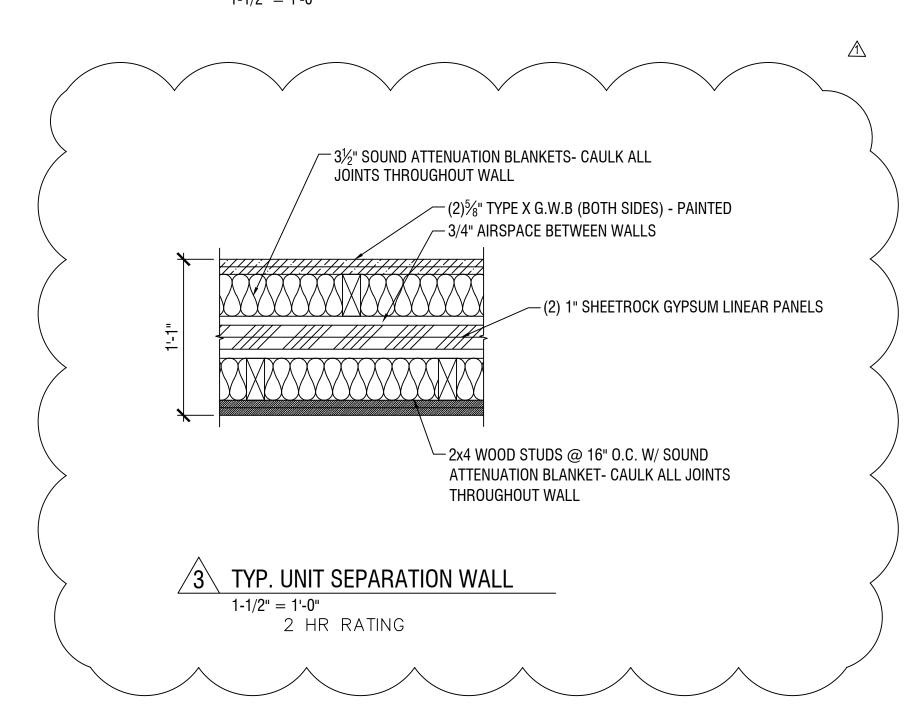

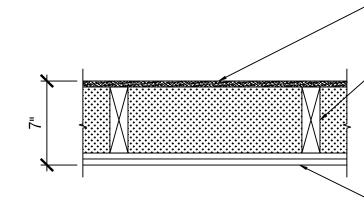

-½" G.W.B - PAINTED TYPICAL @ BATHS/KITCHENS: ½" M.R.G.W.B.

-2x6 WOOD STUDS @ 16" O.C. W/ **BLOWN-IN CELLULOSE INSULATION** (VAPOR BARRIER ON WARM SIDE OF INSULATION)

1/2" PLYWOOD SHEATHING; TYVEK BUILDING WRAP FLASHING; ICE & WATER SHIELD @ WINDOWS; CEMENTITIOUS CLAPBOARD SIDING (4" EXPOSURE); HARDI TRIM AS INDICATED

5	TYP. EXTERIOR WALL
	1-1/2" = 1'-0" R32

		R00M	FINISH SCH	EDULE				
ROOM NO.	ROOM NAME	WALLS/WAINSCOT	BASE	FL00R	CEILING	CLNG HGT	MISC	REMARKS
A 0.0.1	DACEMENT	CWD		CONC	DC	OL OIL		
A001	BASEMENT	GWB	-	CONC	DS	8'-0"	-	-
A101	LIVING ROOM	GWB	WD	WD	GWB	8'-0"	-	-
A102	KITCHEN	GWB	WD	WD	GWB	8'-0"	-	-
A103	DINING ROOM	GWB	WD	WD	GWB	8'-0"	-	-
A104	1/2 BATH	MR BD	СТ	СТ	GWB	7'-6"	-	-
A201	BEDROOM 1	GWB	WD	WD	GWB	8'-0"	-	-
A202	ВАТН	MR BD	СТ	CT	GWB	7'-6"	-	-
A203	BEDROOM 2	GWB	WD	WD	GWB	8'-0"	-	-
A301	BEDROOM 3	GWB	WD	WD	GWB	8'-0"	-	_
A302	STORAGE	GWB	WD	WD	GWB	8'-0"		-

ROOM FINISH SCHEDULE ABBREVIATIONS

CRPT= CARPET DS= DUST SHIELD CONC = CONCRETE

CMU= CONCRETE MASONRY UNIT

EXP= EXPOSED

GWB= GYPSUM WALL BOARD

PNT= PAINTED VB= VINYL BASE VNL= SHEET VINYL

MR BD= MOISTURE RESISTANT GYPSUM WALL BOARD

WD = WOOD

GENERAL NOTES:

- 1. TYP. FIRST FLOOR/ BASEMENT CEILING ASSEMBLY PROVIDE BATT, SPRAY FOAM OR NETTED LOOSE INSULATION R-30 W/ STRAPPING FIRE RATED G.W.B. AT BOILER AREA (TYP.)
- 2. CLOSET FINISHES AND LAUNDRY CLOSET TO MATCH ROOM CLOSET OPENS INTO.
- 3. PROVIDE OAK CAP AT STAIR HANDRAIL.
- 4. STAIR TREAD AND LANDING FINISHES BASEMENT TREADS PROVIDE UNPAINTED HARD PINE FIRST FLOOR LANDING - PROVIDE WOOD FLOORING
- 5. ALL WASHING MACHINES IN LIVING AREA TO HAVE CONNECTED METAL PAN TO DRAIN.
- 6. PROVIDE MIN. ONE HAND HANDRAIL AT ALL STAIRS. TWO WHEN SHOWED IN THE DRAWINGS.
- 7. STAIR HANDRAILS WITH OPEN BALUSTER B-720 BEECH NATURAL FINISH HANDRAIL 1-1/4" SQUARE PAINTED BALUSTER AND 3-1/4" SQUARE PAINTED NEWELL: BY BROSCO OR ARCHITECT APPROVED EQUAL.
- 8. INTERIOR STAIR RAIL BRACKET: C- 3002 BROSCO BRASS FINISH OR ARCHITECT APPROVED EQUAL.
- 9. WALL HANG RAILINGS BROSCO 1-1/2" x 1-11/16" NO. 75 ROUND AT BASEMENT STAIRS ONLY. NO. 66 TAPERED PROFILE PINE WITH INTERIOR STAIR HANDRAIL BRACKETS AT STAIRS WITHIN UNITS MITERED RETURNS.

7A HALF MOON STREET BOSTON, MA

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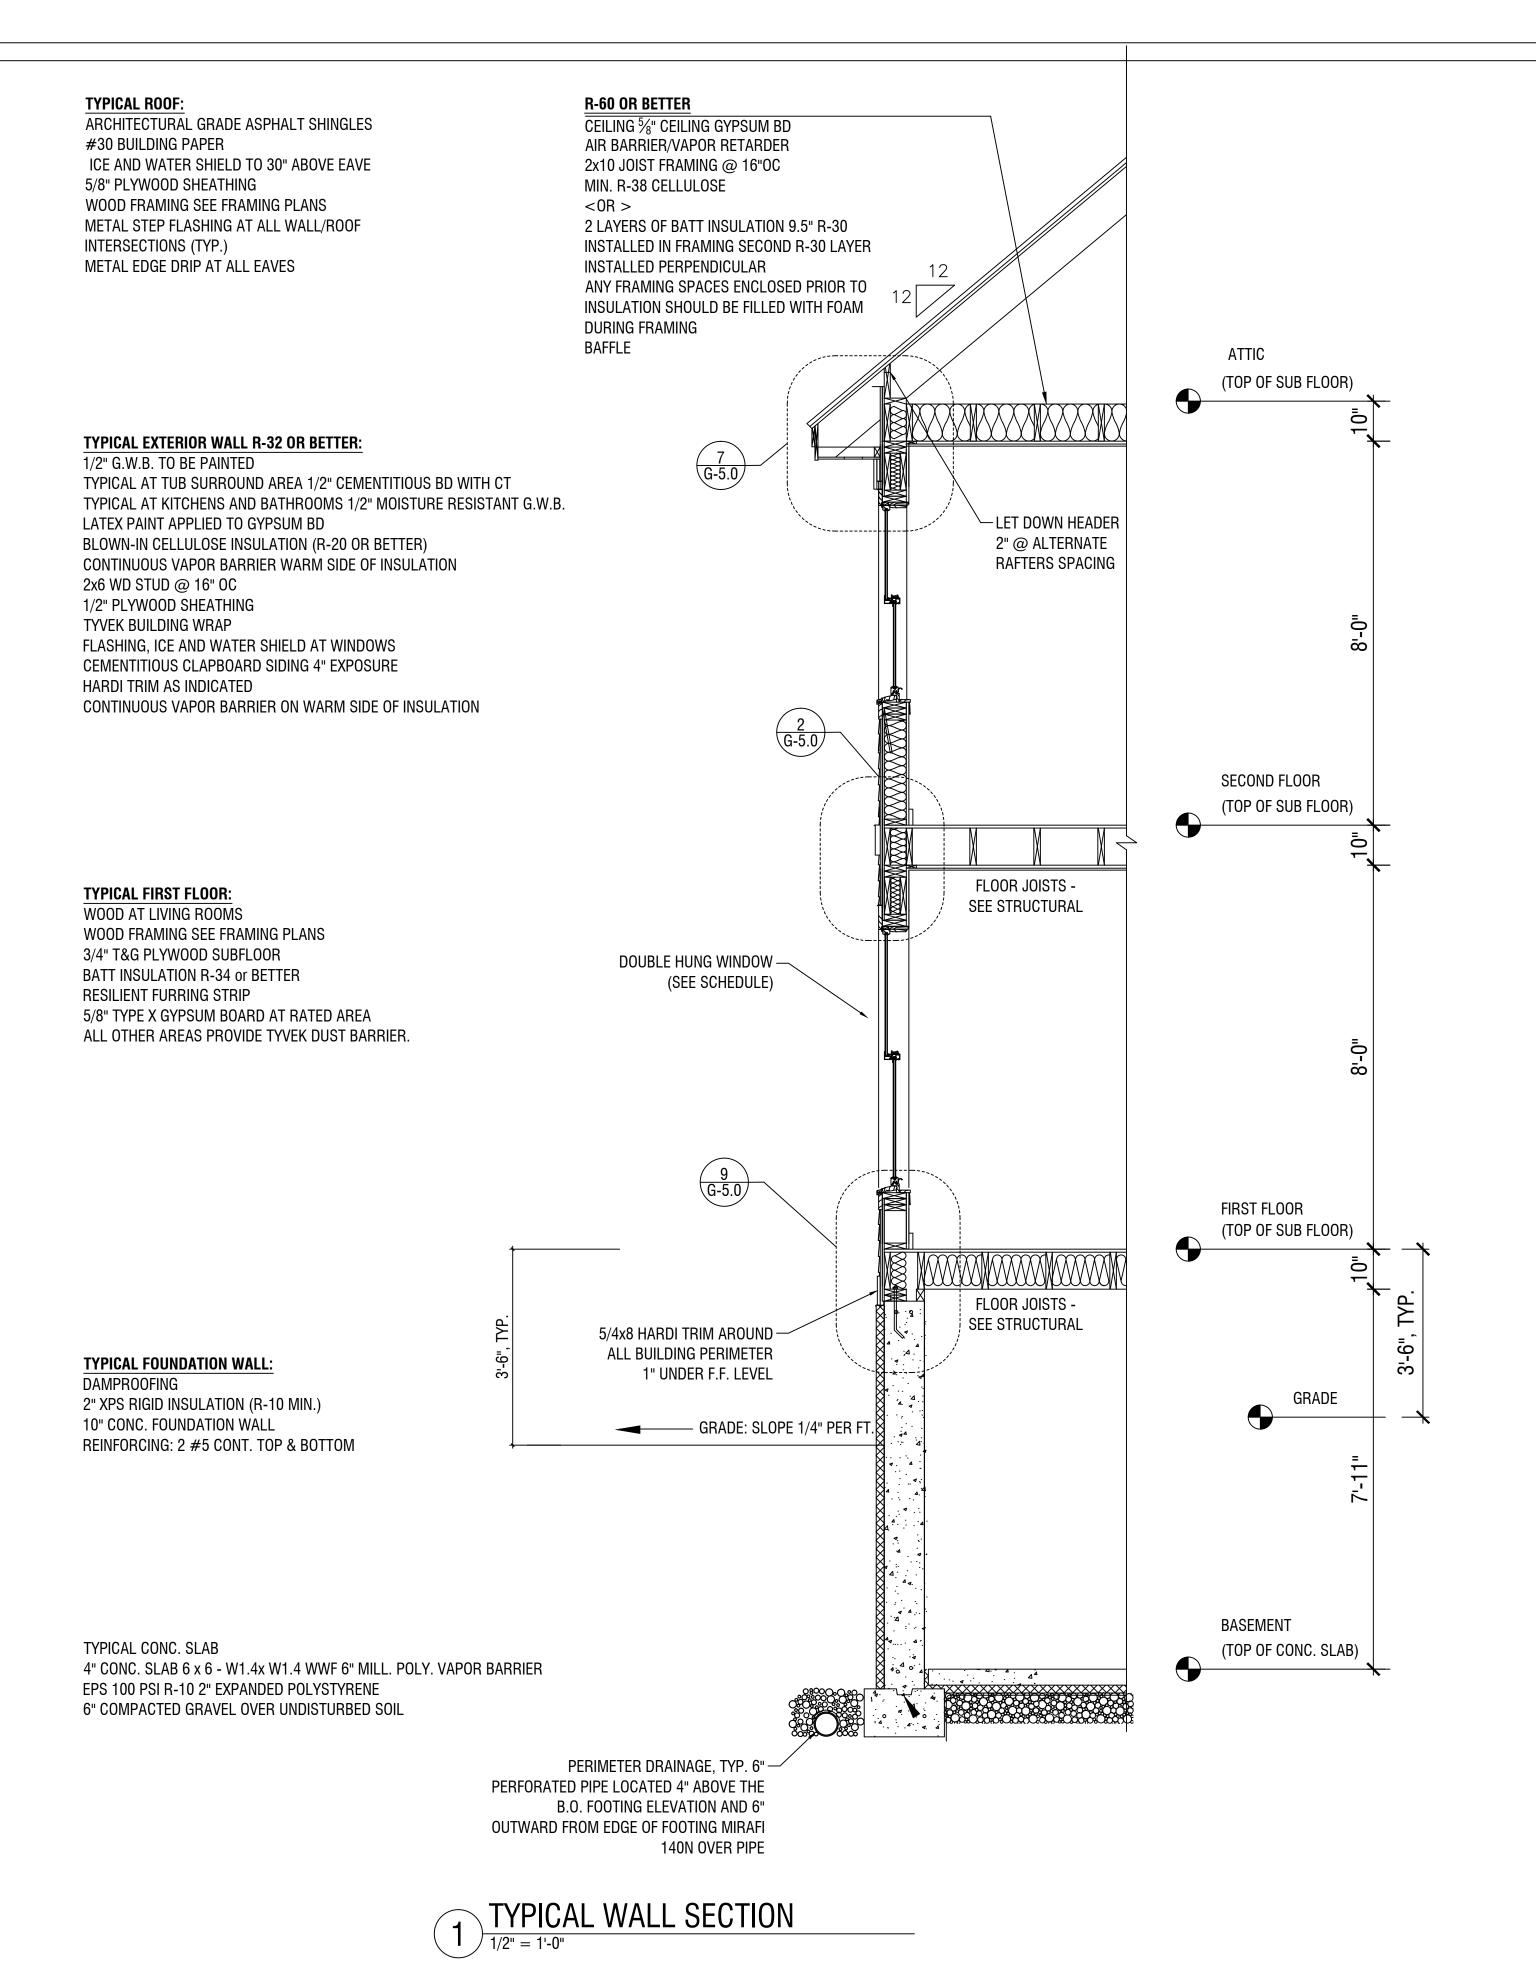


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Ch	ecked By:	CMK
Da	te:	6/8/2018
Re	visions	
	PERMIT SET - REVIEW	5/21/2020
0	INITIAL SUBMISSION	6/8/2018

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ROOM FINISH SCHEDULE AND PARTITION TYPES

AS SHOWN Scale:



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Checked By:	CN
Date:	6/8/20
Revisions	
	<u> </u>
PERMIT SET - REVIEW	5/21/2020
o INITIAL SUBMISSION	6/8/2018


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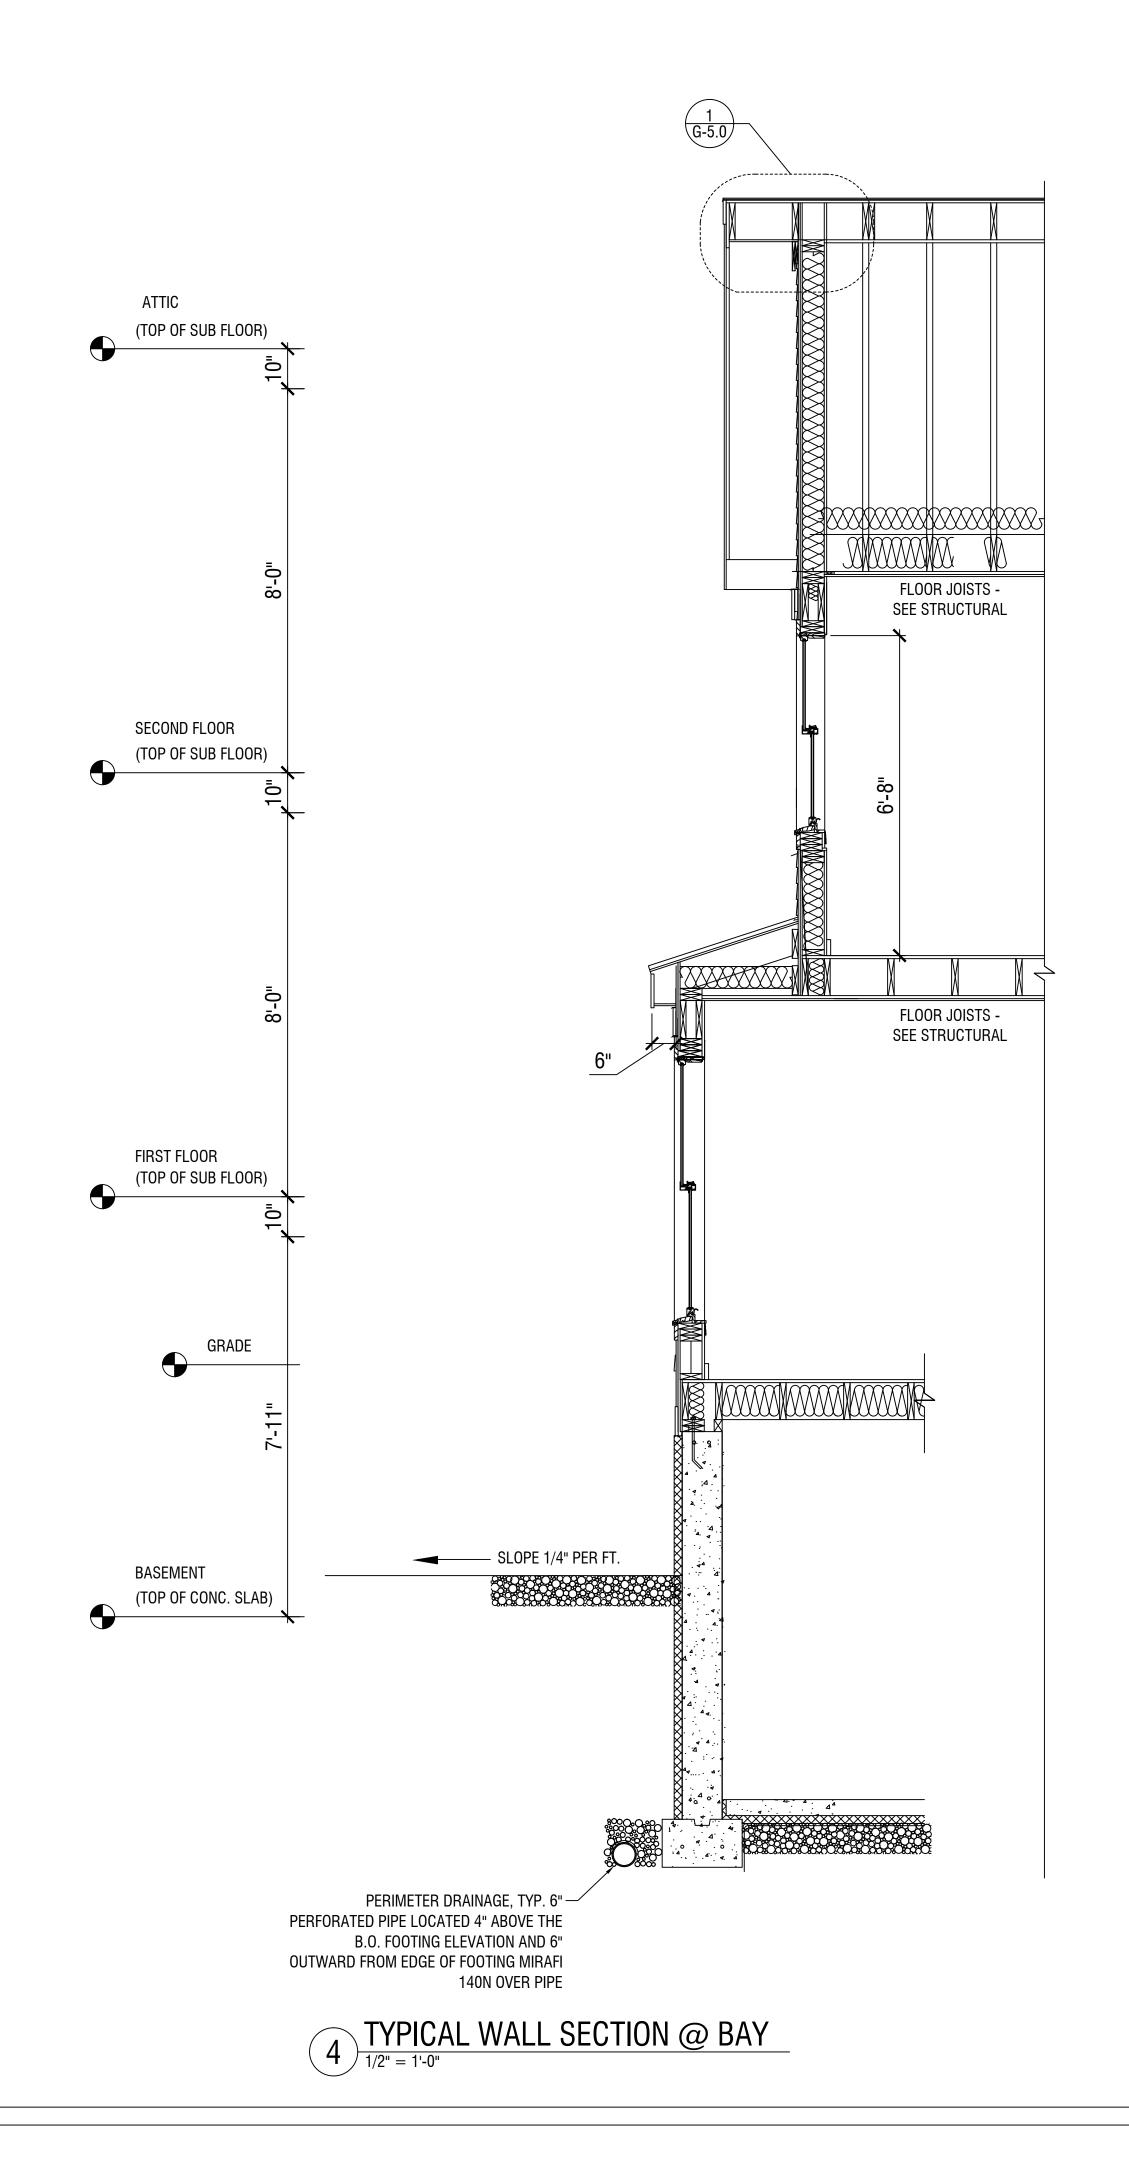
WALL SECTIONS

Sheet No.

Scale: A

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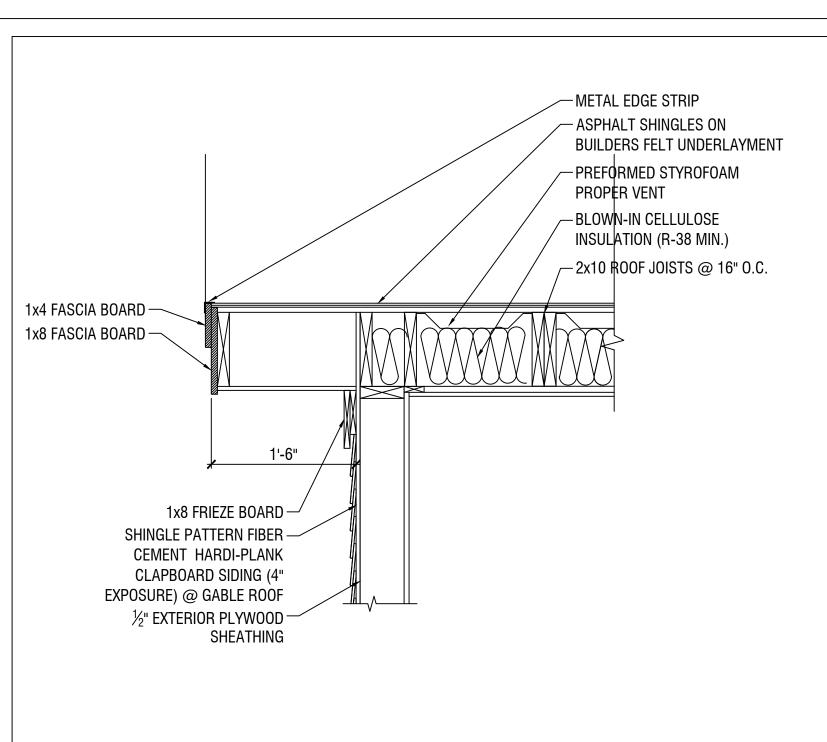
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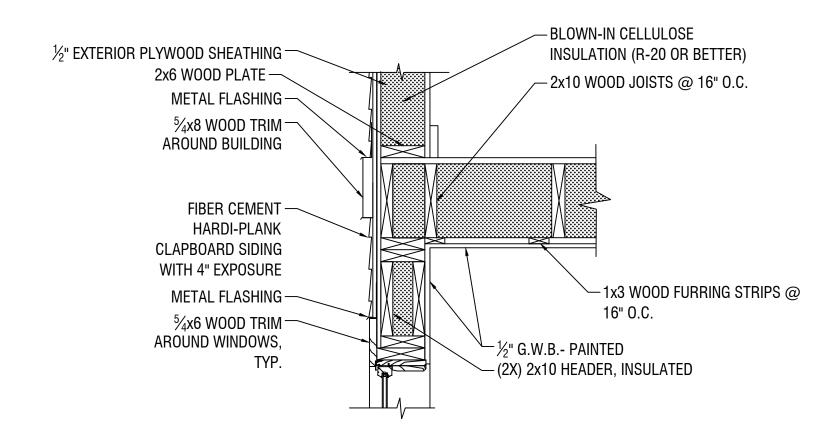
WALL SECTIONS

Scale:

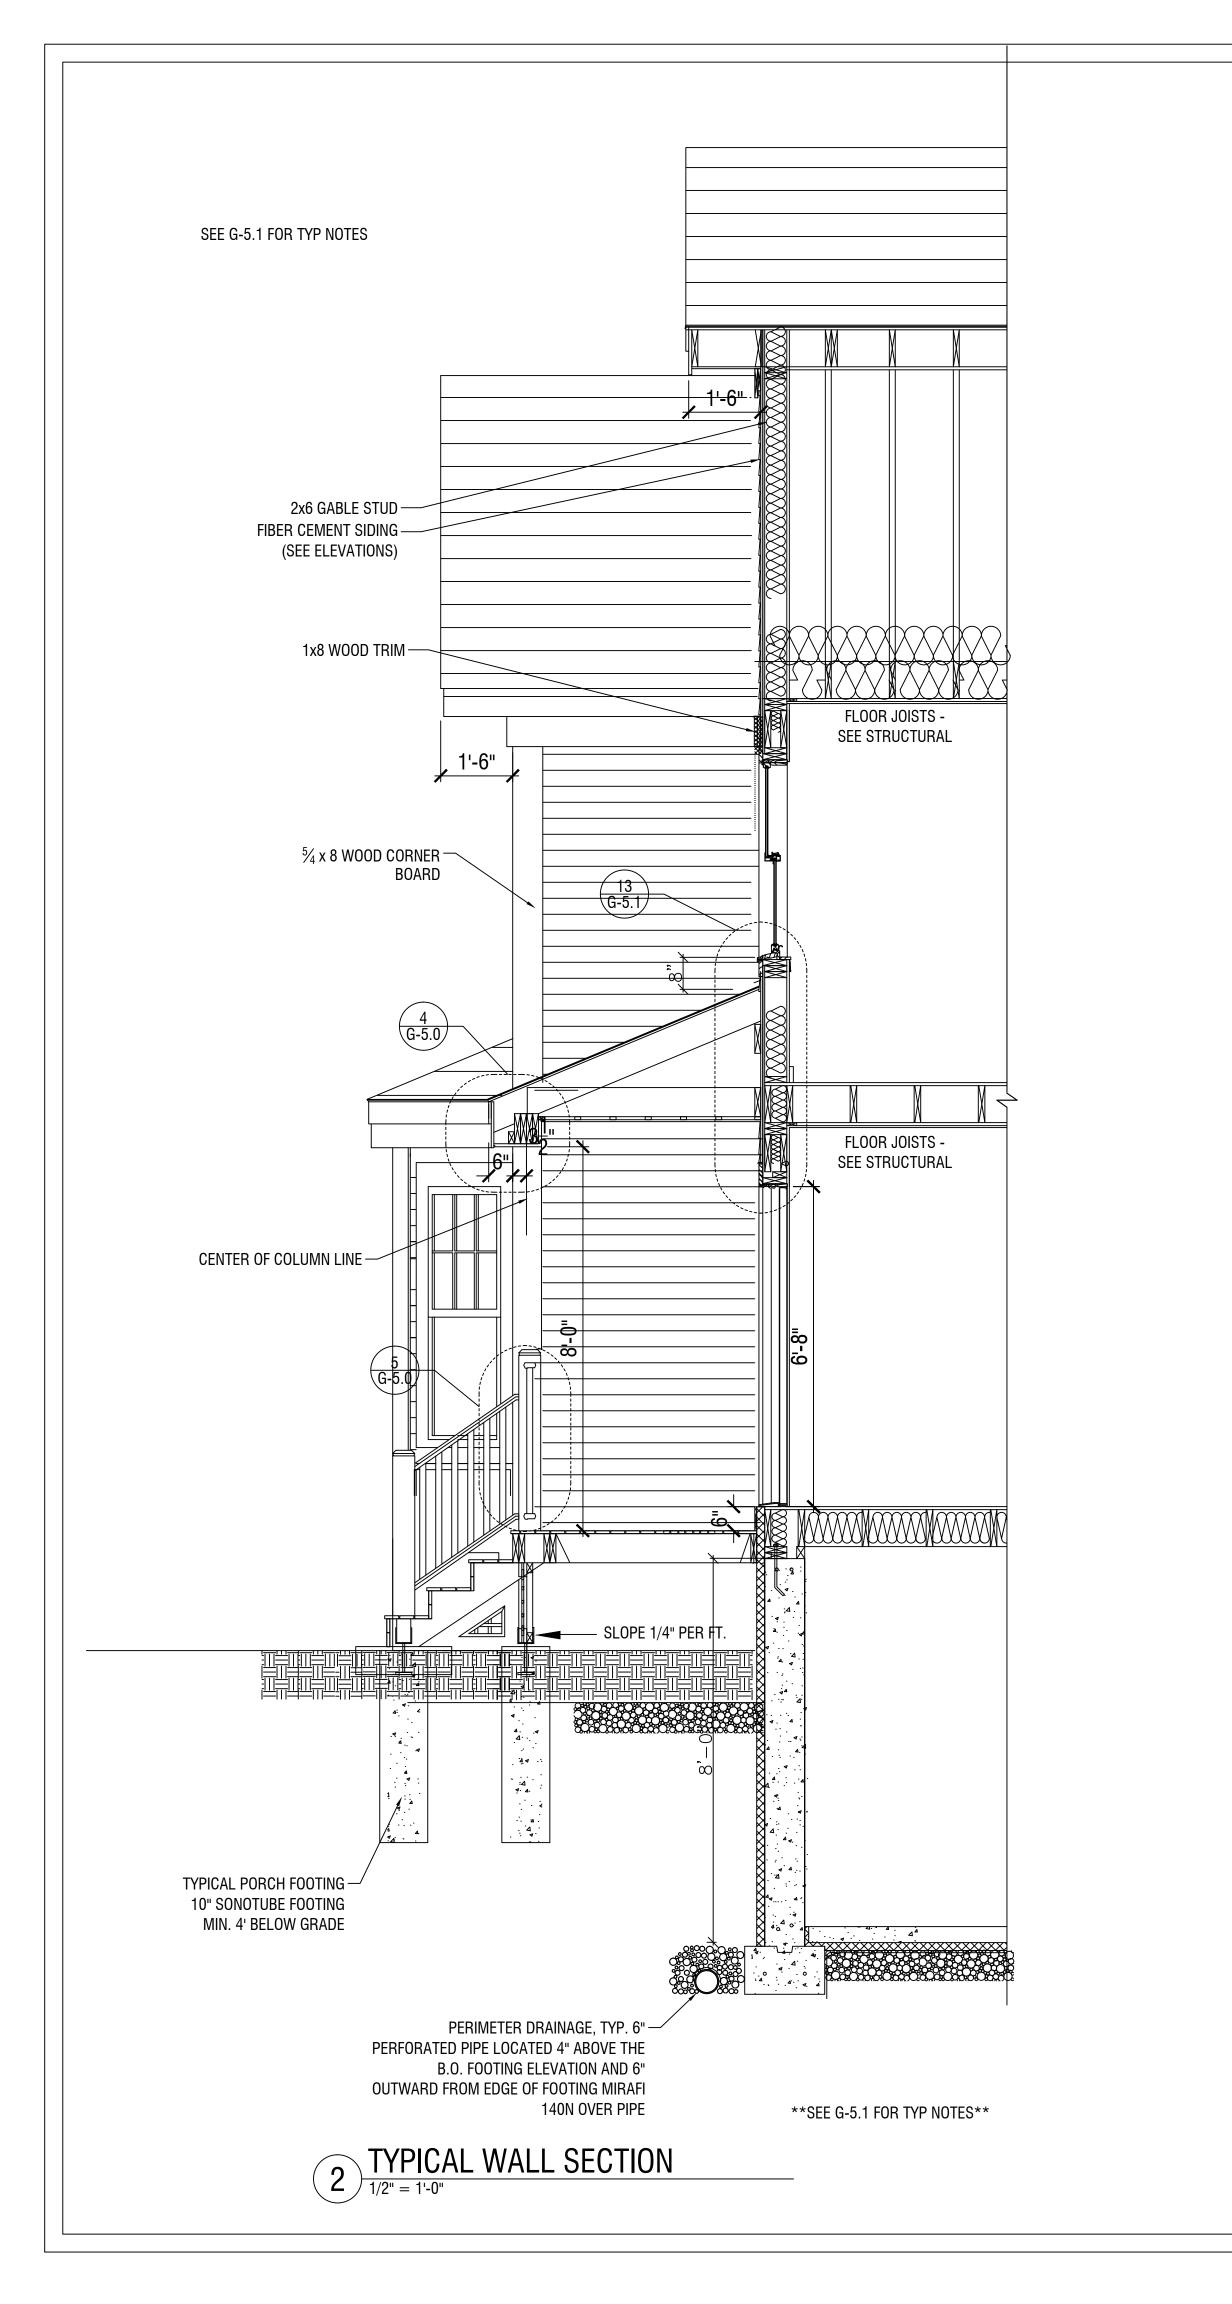
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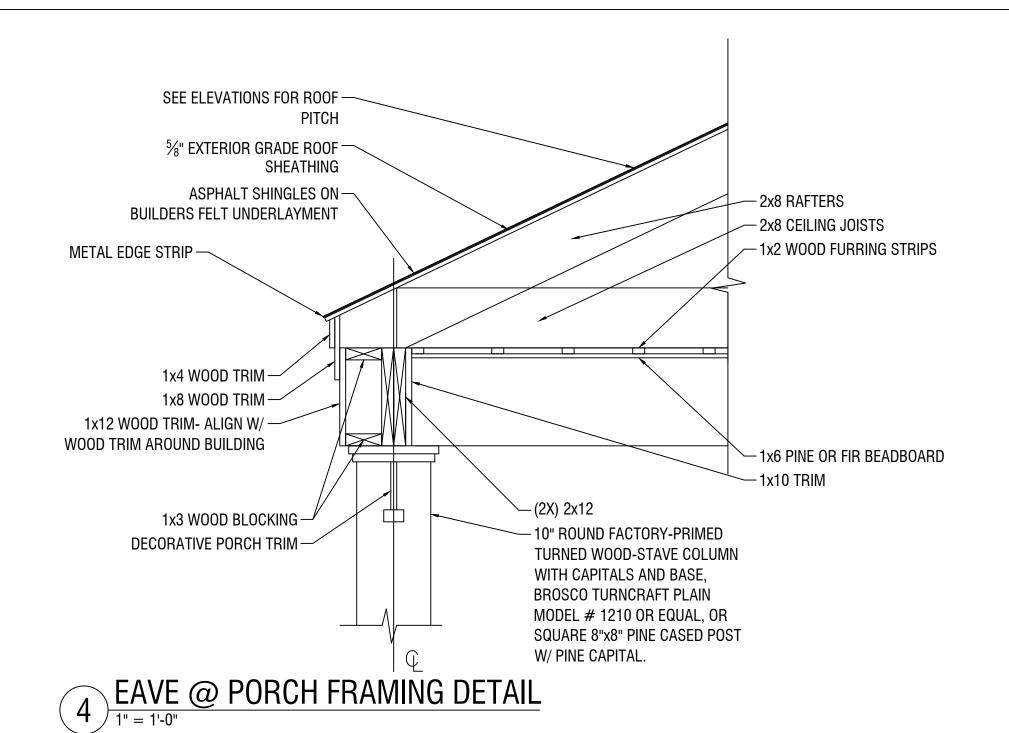



RAKE DETAIL @ GABLE ROOF





TYP. WALL DETAIL 1" = 1'-0"




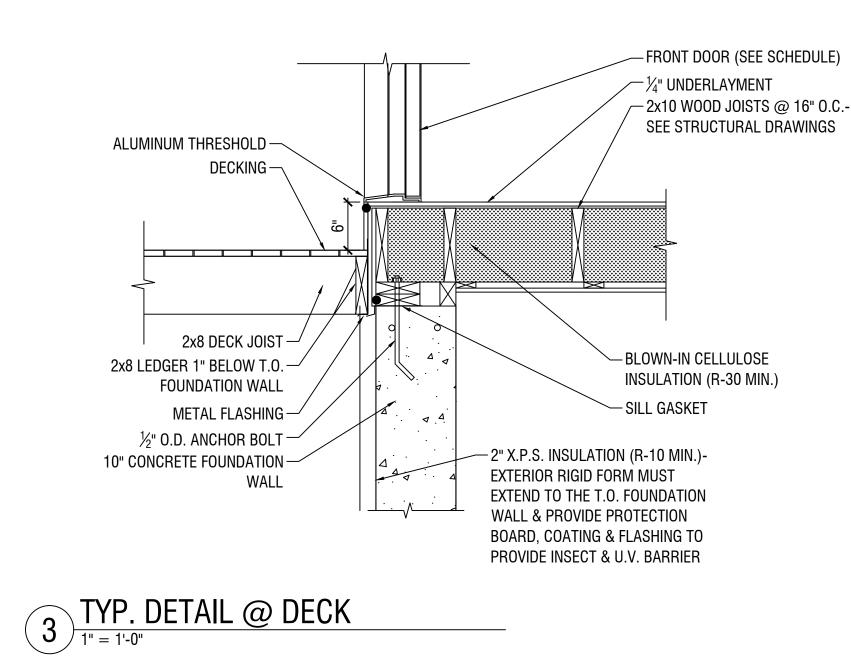

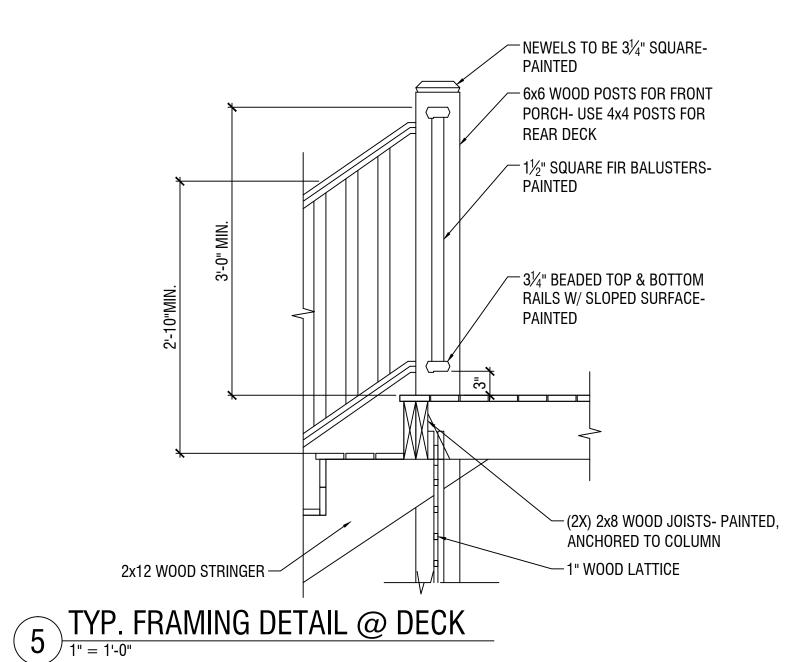

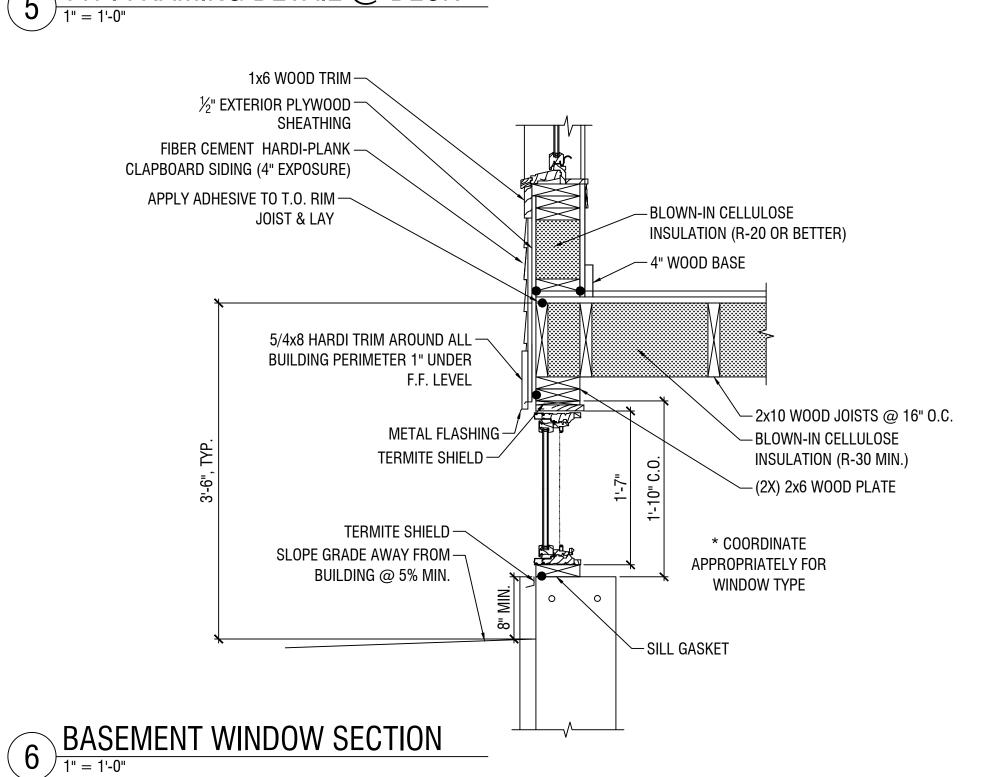

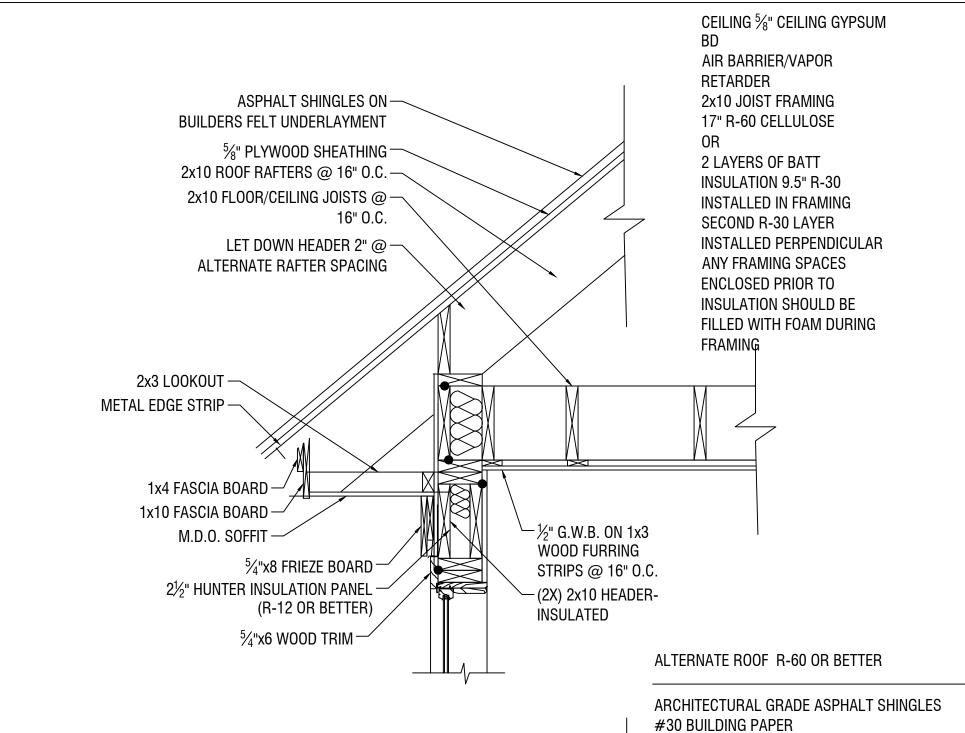


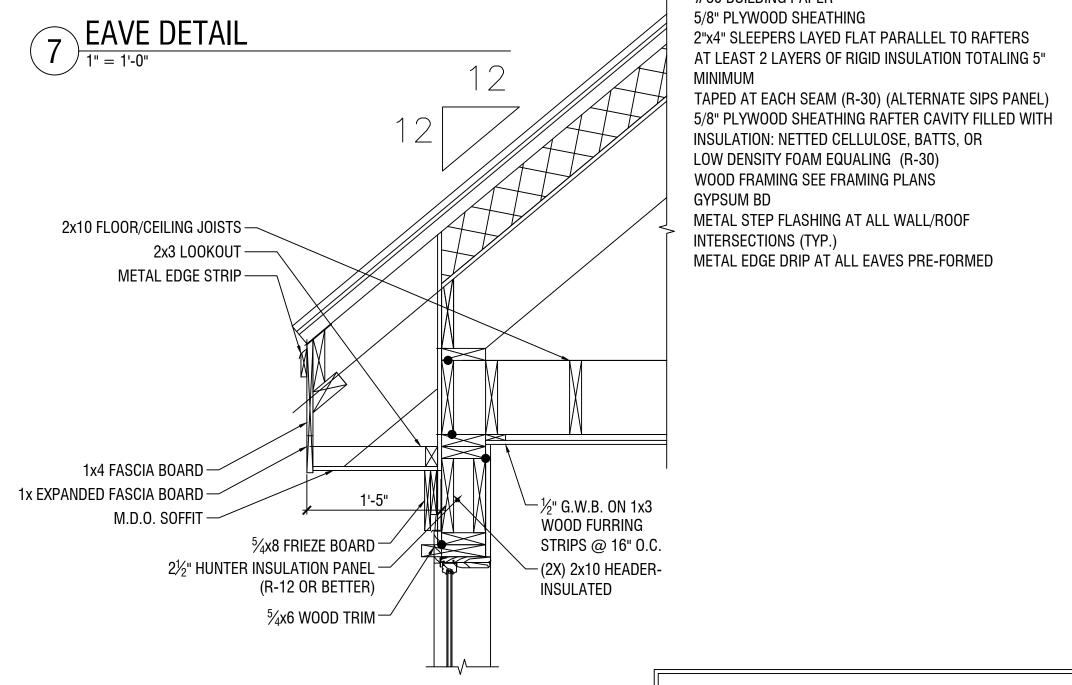

REQUIRED. THIS IS TYPICAL OF ALL DETAILS.

NOTE:
INCLUDE ADHESIVE SEAM TAPE
ON ALL SHEATHING INSTALLATION

DOT REPRESENTS POINTS WHERE CAUKING IS

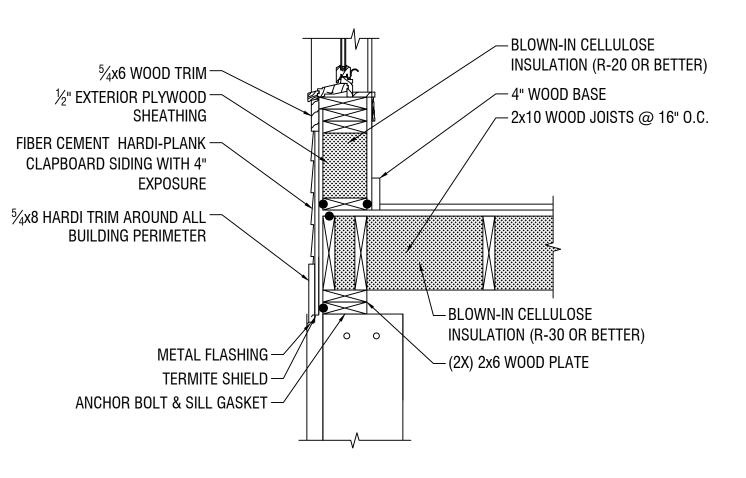

9 TYP. DETAIL @ FOUNDATION WALL

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EXPIRES 6/30/2020

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LAAAA.		
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Checked By:		СМК
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TYPICAL DETAILS

Sheet No. G-5.C

Scale: AS SHOWN

