

NOTE

- 1. SEE CITY OF BOSTON ASSESSORS PARCEL #1300252000, #1300253000, #1300254000 AND #130026300 FOR SITE. SITE IS KNOWN AS #21-23 MAGNOLIA STREET AND #8 WOODFORD STREET IN DEED BOOK #8341, PAGE #227-230 AND BOOK #8986, PAGE #377 SUFFOLK REGISTRY OF DEEDS. THE PARCEL WILL BE SUBDIVIDED INTO THREE PARCELS: #23 MAGNOLIA STREET, #21 MAGNOLIA STREET AND #8 WOODFORD STREET.
- 2. TOPOGRAPHIC DATUM BASE IS CITY OF BOSTON. BENCHMARK IS DRAIN MANHOLE 268 RIM LOCATED ON MAGNOLIA STREET, ELEVATION=56.25
- 3. ZONE DISTRICT: ROXBURY NEIGHBORHOOD
 ZONING SUBDISTRICT: 3F-4000
 SUBDISTRICT TYPE: THREE-FAMILY RESIDENTIAL
 ZONING OVERLAY DISTRICT: NEIGHBORHOOD DESIGN REVIEW


<u>LEGEND</u>

O IR	IRON ROD
DH	DRILL HOLE
\square WHH	WATER HAND HOLE
□ EHH	ELECTRICAL HAND HOLE
**	HYDRANT
□ CB	CATCH BASIN
☆ LP	LIGHT POLE
© CSMH	COMBINED SEWER MANHOLE
S SMH	SEWER MANHOLE
O DMH	DRAIN MANHOLE
© EMH	ELECTRICAL MANHOLE
© CMH	CABLE TELEVISION MANHOLE
• WG	WATER GATE
● GG	GAS GATE
——S ——	SEWER PIPELINE
——W——	WATER PIPELINE
——D——	DRAIN PIPELINE
—— G——	GAS PIPELINE
—— CS ——	COMBINED SEWER PIPELINE
	WATER SERVICE PIPELINE
—— GS ——	GAS SERVICE PIPELINE
-x-x-	CHAIN LINK FENCE(CLF)
<i>─</i> −52− <i>─</i>	ELEVATION CONTOUR
X 52.12	SPOT ELEVATION
N/F	NOW OR FORMERLY
W.F.D.	WOOD FRAME DWELLING
GC	GRANITE CURB
CONC. BLK.	CONCRETE BLOCK
CEM. CONC.	CEMENT CONCRETE
BIT. CONC.	BITUMINOUS CONCRETE PAVEMENT
FND	FOUND
D 01	DIT 010T ID 011

CM KIRBY ENGINEERING, PLLC

PO BOX 291
NORWOOD, MA 02062
TEL: (617) 872-5553
EMAIL: CKIRBY83@GMAIL.COM
PE LICENSE NO. 41662 EXP. 6/30/2020
JANUARY 19, 2018

PCI

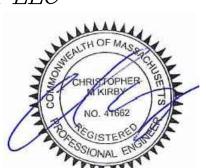

SUBDIVISION PLAN OF LAND

PIT CAST IRON

BOSTON, MASSACHUSETTS

8 WOODFORD STREET

21 MAGNOLIA STREET


23 MAGNOLIA STREET


ORIGINAL SURVEY BY:

MERRIMACK ENGINEERING SERVICES
66 PARK STREET
ANDOVER, MASSACHUSETTS 01810
TEL: (978) 475-3555 FAX: (978) 475-1448
EMAIL: MERRENG@AOL.COM

DATED: JULY 13, 2016

SCALE: 1"=10'
(24x36 PAPER)
0' 5' 10' 20

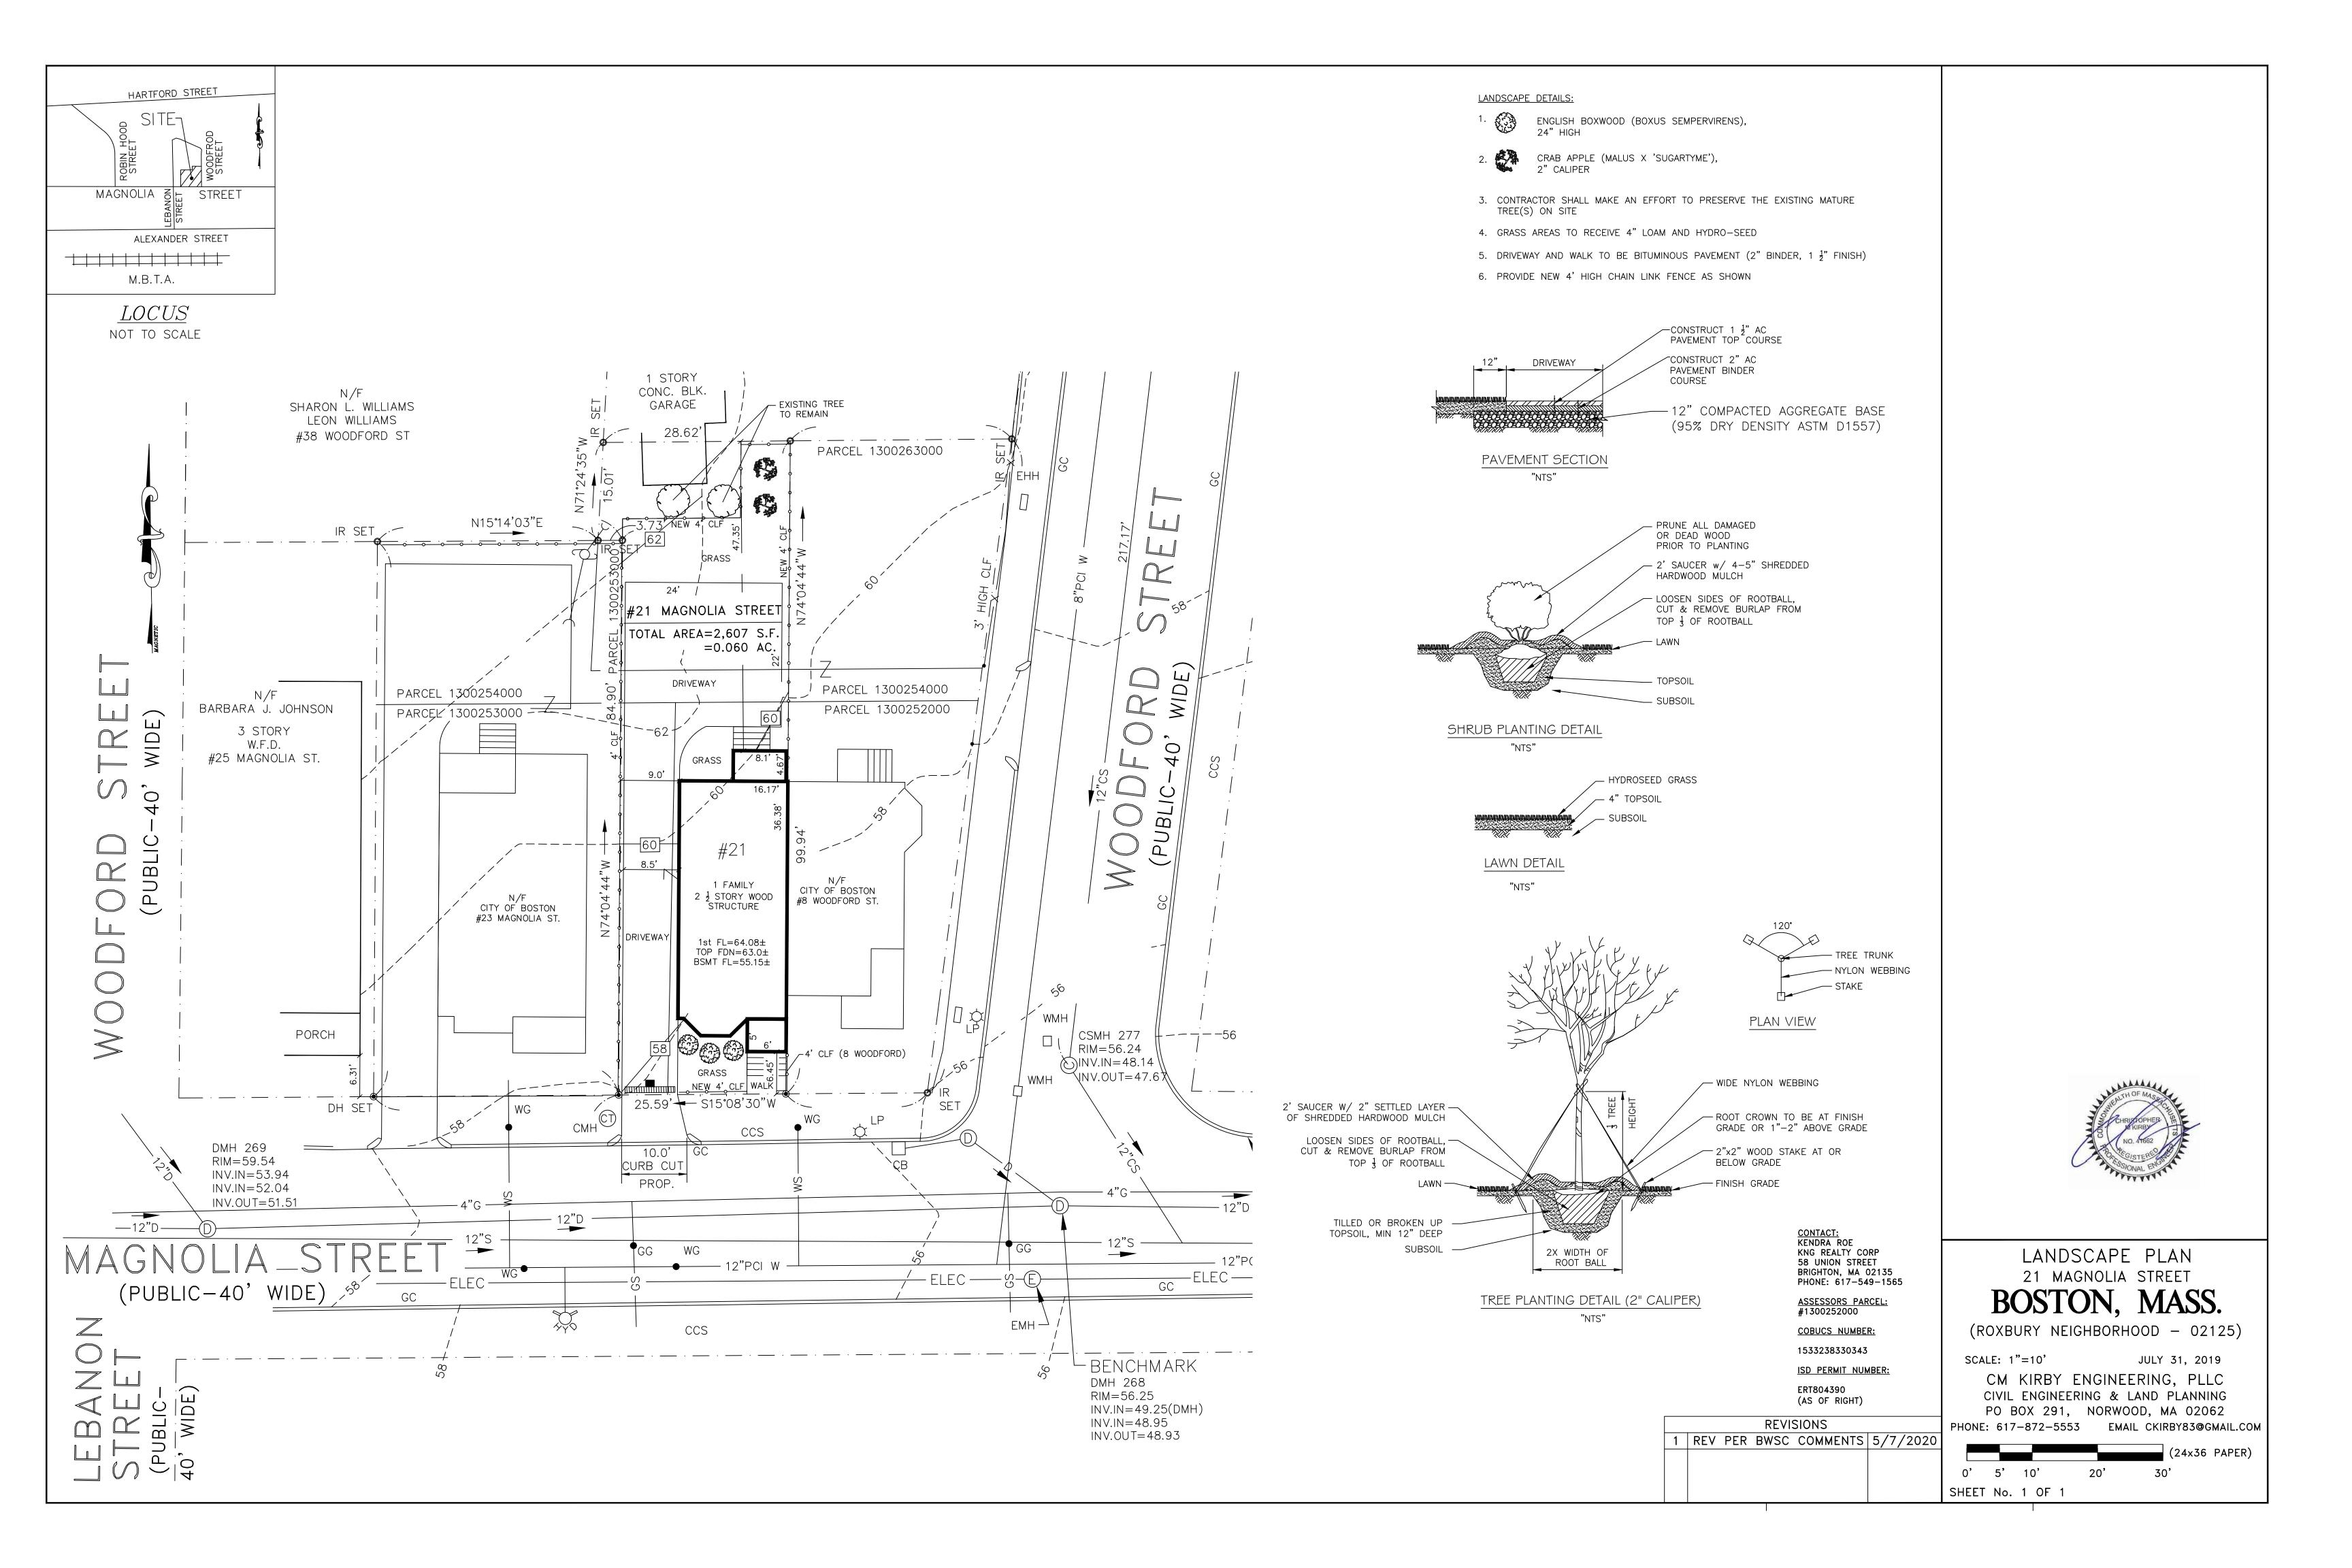

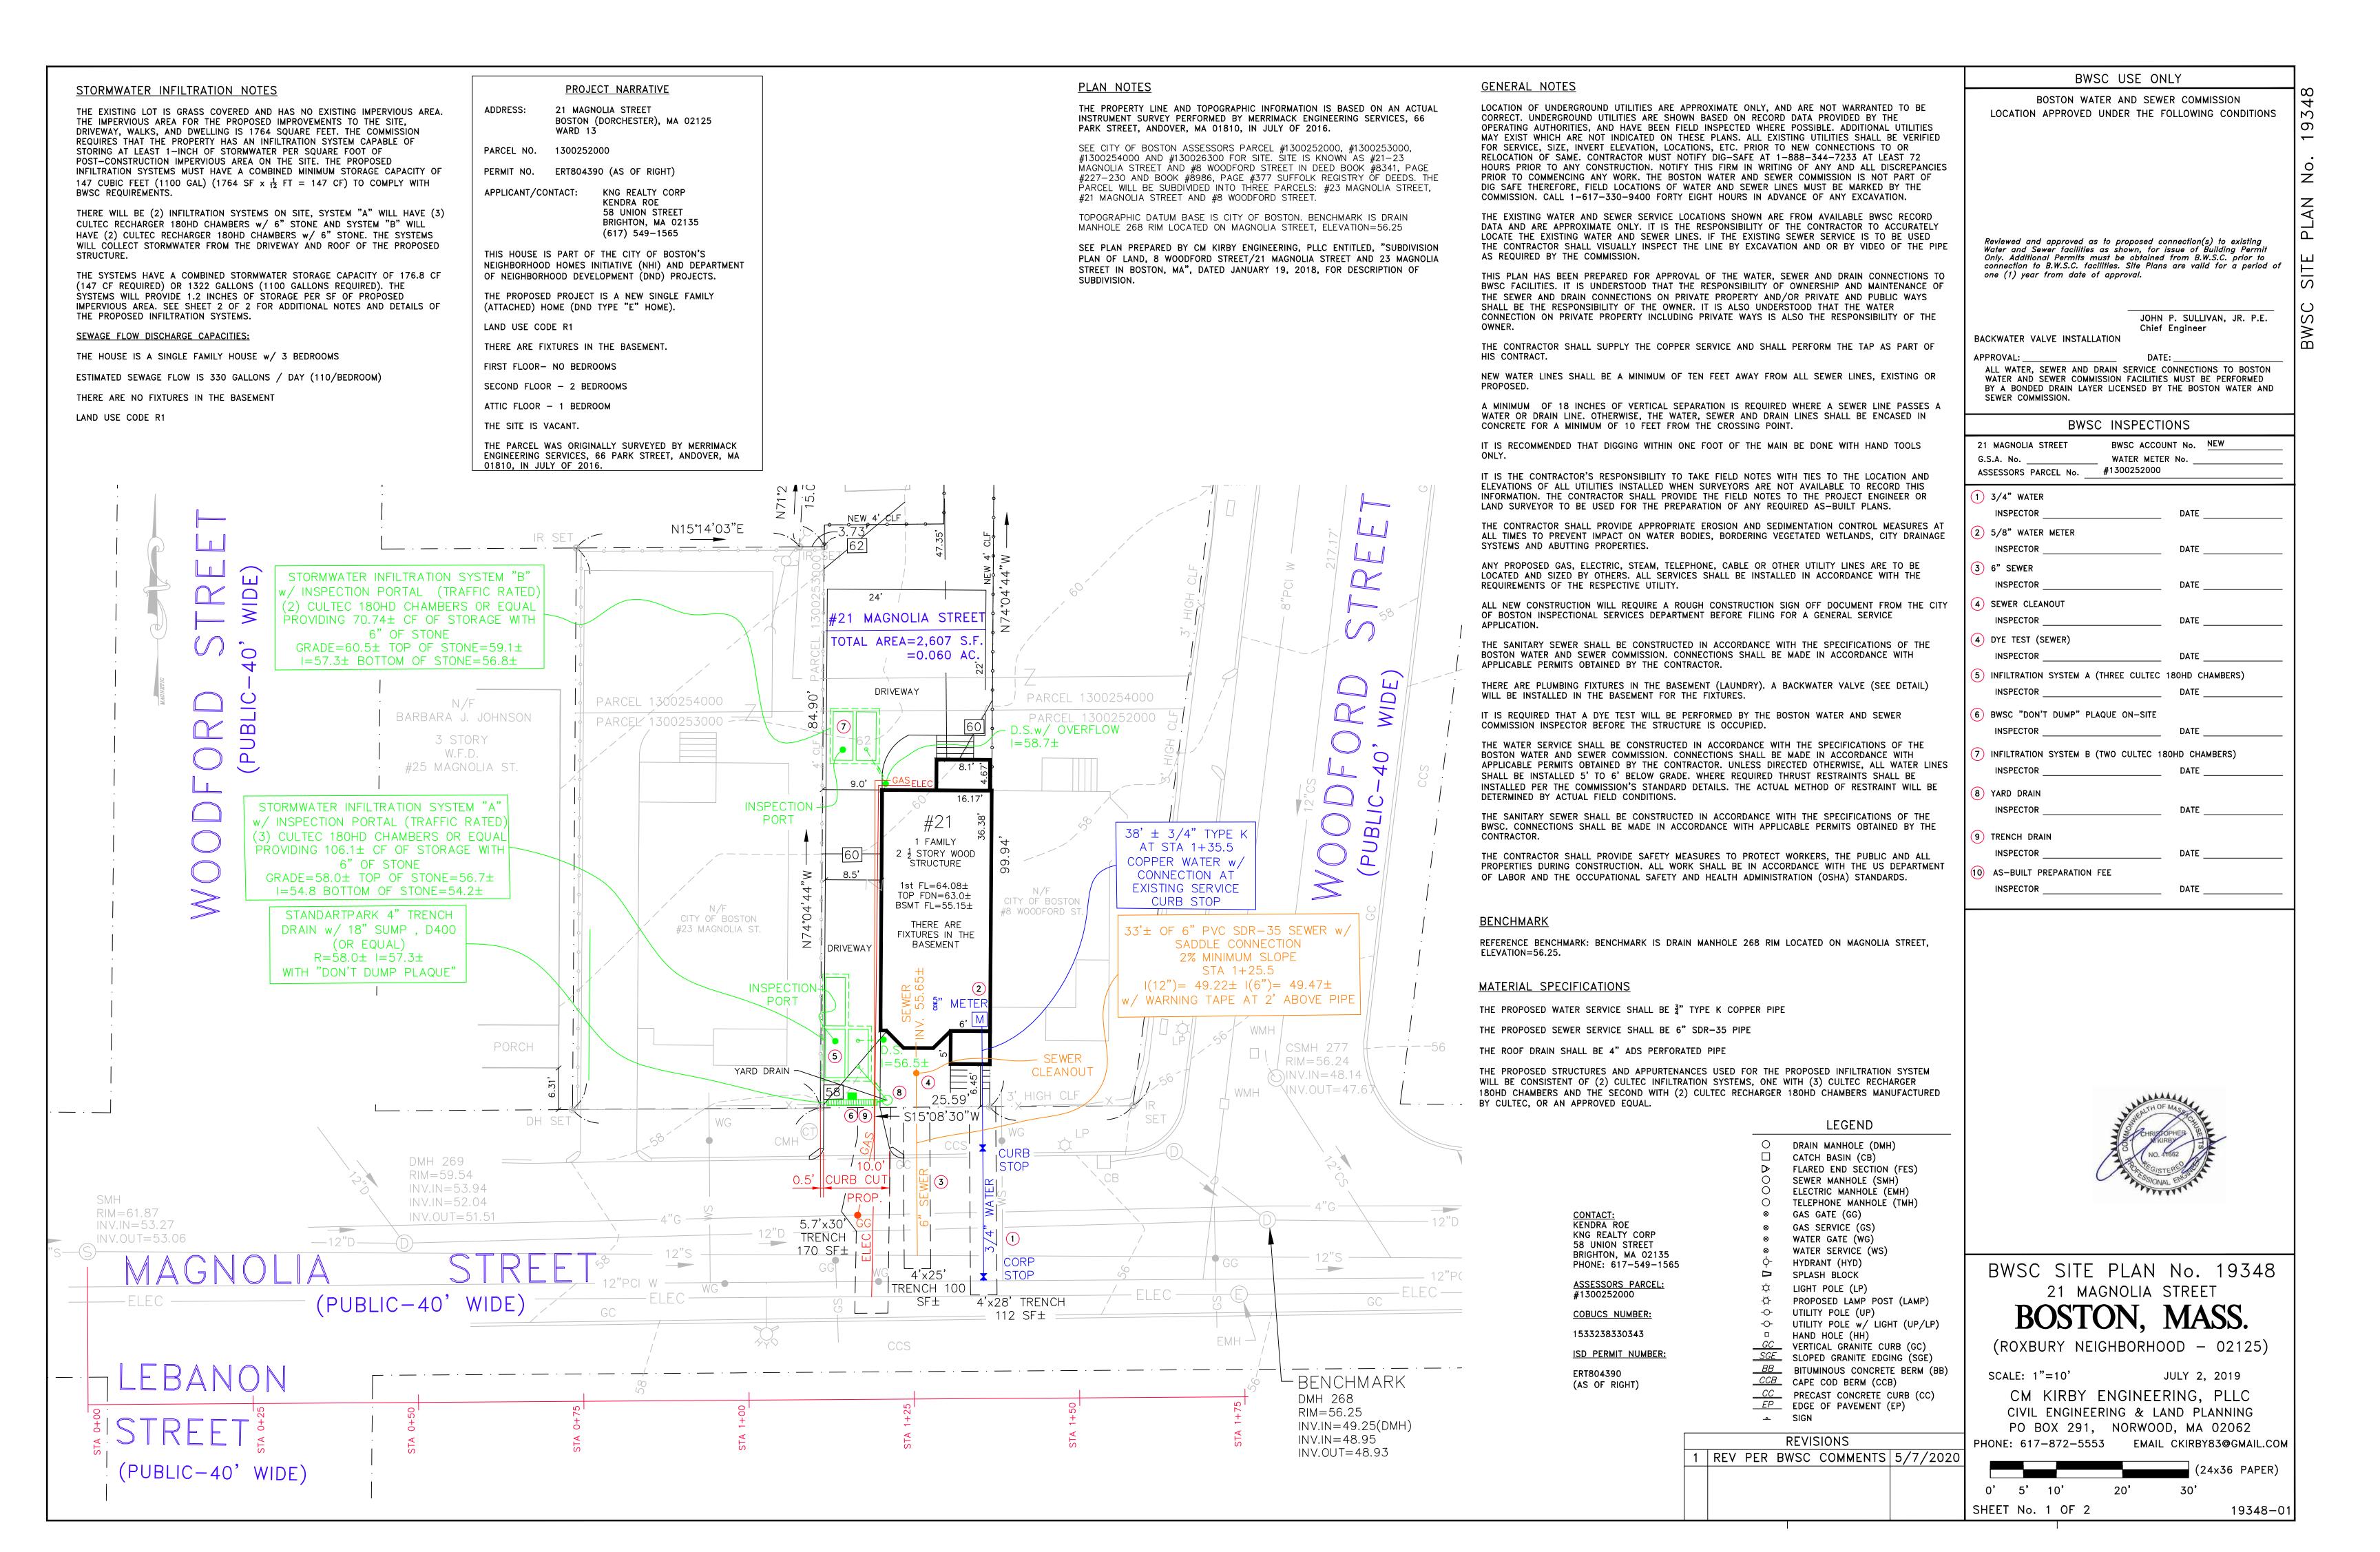

9

o Z

SIT

S

19348-02

SHEET No. 2 OF 2

NOT TO SCALE

N15°14'03"E

 $\overline{}$

PARCEL 1300254000

PARCEL 1300253000 ---

INSPECTION

PORT

5.7'x30"

TRENCH

YARD DRAIN

PORT

CITY OF BOSTON

#23 MAGNOLIA ST

EDGESTONE 1 1/2" BIT. CONC. WEARING SURFACE PROPOSED CONCRETE SIDEWALK PROPOSED GRANITE D-STON S' RADIUS STONI TYPE VA4 1 PIECE SURFACE > 1/2" BIT. CONC. BINDER COURSE -8" COMPACTED GRAVEL BASE CONCRETE DRIVEWAY SECTION A-A

STORMWATER INFILTRATION NOTES PLAN NOTES

THE PROPERTY LINE AND TOPOGRAPHIC INFORMATION IS BASED ON AN ACTUAL INSTRUMENT SURVEY PERFORMED BY MERRIMACK ENGINEERING SERVICES, 66 PARK STREET, ANDOVER, MA 01810, IN JULY OF 2016.

SEE CITY OF BOSTON ASSESSORS PARCEL #1300252000, #1300253000, #1300254000 AND #130026300 FOR SITE. SITE IS KNOWN AS #21-23 MAGNOLIA STREET AND #8 WOODFORD STREET IN DEED BOOK #8341, PAGE #227-230 AND BOOK #8986, PAGE #377 SUFFOLK REGISTRY OF DEEDS. THE PARCEL WILL BE SUBDIVIDED INTO THREE PARCELS: #23 MAGNOLIA STREET, #21 MAGNOLIA STREET AND #8 WOODFORD STREET.

TOPOGRAPHIC DATUM BASE IS CITY OF BOSTON. BENCHMARK IS DRAIN MANHOLE 268 RIM LOCATED ON MAGNOLIA STREET, ELEVATION=56.25

SEE PLAN PREPARED BY CM KIRBY ENGINEERING, PLLC ENTITLED, "SUBDIVISION PLAN OF LAND, 8 WOODFORD STREET/21 MAGNOLIA STREET AND 23 MAGNOLIA STREET IN BOSTON, MA", DATED JANUARY 19, 2018, FOR DESCRIPTION OF SUBDIVISION.

NEW 4' ∕CLF

24'

£21 MAGNOLIA STREET

=0.060 AC

#21

1 FAMILY

2 3 STORY WOOD

STRUCTURE

1st FL=64.08±

TOP FDN= $63.0\pm$

BSMT FL=55.15±

THERE ARE

FIXTURES IN THE

BASEMENT

4′×25′

TRENCH 100

SF±

FOTAL AREA=2,607 S.F

DRIVEWAY

THE EXISTING LOT IS GRASS COVERED AND HAS NO EXISTING IMPERVIOUS AREA. THE IMPERVIOUS AREA FOR THE PROPOSED IMPROVEMENTS TO THE SITE, DRIVEWAY, WALKS, AND DWELLING IS 1764 SQUARE FEET. THE COMMISSION REQUIRES THAT THE PROPERTY HAS AN INFILTRATION SYSTEM CAPABLE OF STORING AT LEAST 1-INCH OF STORMWATER PER SQUARE FOOT OF POST-CONSTRUCTION IMPERVIOUS AREA ON THE SITE. THE PROPOSED INFILTRATION SYSTEMS MUST HAVE A COMBINED MINIMUM STORAGE CAPACITY OF 147 CUBIC FEET (1100 GAL) (1764 SF x $\frac{1}{12}$ FT = 147 CF) TO COMPLY WITH BWSC REQUIREMENTS.

THERE WILL BE (2) INFILTRATION SYSTEMS ON SITE, SYSTEM "A" WILL HAVE (3) CULTEC RECHARGER 180HD CHAMBERS w/ 6" STONE AND SYSTEM "B" WILL HAVE (2) CULTEC RECHARGER 180HD CHAMBERS w/ 6" STONE. THE SYSTEMS WILL COLLECT STORMWATER FROM THE DRIVEWAY AND ROOF OF THE PROPOSED STRUCTURE.

THE SYSTEMS HAVE A COMBINED STORMWATER STORAGE CAPACITY OF 176.8 CF (147 CF REQUIRED) OR 1322 GALLONS (1100 GALLONS REQUIRED). THE SYSTEMS WILL PROVIDE 1.2 INCHES OF STORAGE PER SF OF PROPOSED IMPERVIOUS AREA. SEE SHEET 2 OF 2 FOR ADDITIONAL NOTES AND DETAILS OF THE PROPOSED INFILTRATION SYSTEMS.

SEWAGE FLOW DISCHARGE CAPACITIES:

THE HOUSE IS A SINGLE FAMILY HOUSE w/ 3 BEDROOMS

ESTIMATED SEWAGE FLOW IS 330 GALLONS / DAY (110/BEDROOM)

THERE ARE NO FIXTURES IN THE BASEMENT

LAND USE CODE R1

 $38' \pm 3/4"$ TYPE K

AT STA 1+35.5

COPPER WATER w/

CONNECTION AT

EXISTING SERVICE

CURB STOP

33'± OF 6" PVC SDR-35 SEWER w/

SADDLE CONNECTION

2% MINIMUM SLOPE

STA 1+25.5

 $I(12") = 49.22 \pm I(6") = 49.47 \pm$

w/ WARNING TAPE AT 2' ABOVE PIPE

EMH -

CSMH 277

RIM = 56.24

31NV.IN = 48.14

√N V.OUT=47.6 🌣

-BENCHMARK

INV.IN = 49.25(DMH)

DMH 268

RIM = 56.25

INV.IN = 48.95INV.OUT = 48.93

PARCEL 1300254000

D.S.w/ OVERFLOW

 $1 = 58.7 \pm$

CITY OF BOSTON

CLEANOU1

4'x28' TRENCH

8 WOODFORD S

GENERAL NOTES

LOCATION OF UNDERGROUND UTILITIES ARE APPROXIMATE ONLY, AND ARE NOT WARRANTED TO BE CORRECT, UNDERGROUND UTILITIES ARE SHOWN BASED ON RECORD DATA PROVIDED BY THE OPERATING AUTHORITIES, AND HAVE BEEN FIELD INSPECTED WHERE POSSIBLE. ADDITIONAL UTILITIES MAY EXIST WHICH ARE NOT INDICATED ON THESE PLANS. ALL EXISTING UTILITIES SHALL BE VERIFIED FOR SERVICE, SIZE, INVERT ELEVATION, LOCATIONS, ETC. PRIOR TO NEW CONNECTIONS TO OR RELOCATION OF SAME. CONTRACTOR MUST NOTIFY DIG-SAFE AT 1-888-344-7233 AT LEAST 72 HOURS PRIOR TO ANY CONSTRUCTION. NOTIFY THIS FIRM IN WRITING OF ANY AND ALL DISCREPANCIES PRIOR TO COMMENCING ANY WORK. THE BOSTON WATER AND SEWER COMMISSION IS NOT PART OF DIG SAFE THEREFORE. FIELD LOCATIONS OF WATER AND SEWER LINES MUST BE MARKED BY THE COMMISSION. CALL 1-617-330-9400 FORTY EIGHT HOURS IN ADVANCE OF ANY EXCAVATION.

THE EXISTING WATER AND SEWER SERVICE LOCATIONS SHOWN ARE FROM AVAILABLE BWSC RECORD DATA AND ARE APPROXIMATE ONLY. IT IS THE RESPONSIBILITY OF THE CONTRACTOR TO ACCURATELY LOCATE THE EXISTING WATER AND SEWER LINES. IF THE EXISTING SEWER SERVICE IS TO BE USED THE CONTRACTOR SHALL VISUALLY INSPECT THE LINE BY EXCAVATION AND OR BY VIDEO OF THE PIPE AS REQUIRED BY THE COMMISSION.

THIS PLAN HAS BEEN PREPARED FOR APPROVAL OF THE WATER, SEWER AND DRAIN CONNECTIONS TO BWSC FACILITIES. IT IS UNDERSTOOD THAT THE RESPONSIBILITY OF OWNERSHIP AND MAINTENANCE OF THE SEWER AND DRAIN CONNECTIONS ON PRIVATE PROPERTY AND/OR PRIVATE AND PUBLIC WAYS SHALL BE THE RESPONSIBILITY OF THE OWNER. IT IS ALSO UNDERSTOOD THAT THE WATER CONNECTION ON PRIVATE PROPERTY INCLUDING PRIVATE WAYS IS ALSO THE RESPONSIBILITY OF THE OWNER.

THE CONTRACTOR SHALL SUPPLY THE COPPER SERVICE AND SHALL PERFORM THE TAP AS PART OF HIS CONTRACT.

NEW WATER LINES SHALL BE A MINIMUM OF TEN FEET AWAY FROM ALL SEWER LINES, EXISTING OR

A MINIMUM OF 18 INCHES OF VERTICAL SEPARATION IS REQUIRED WHERE A SEWER LINE PASSES A WATER OR DRAIN LINE. OTHERWISE, THE WATER, SEWER AND DRAIN LINES SHALL BE ENCASED IN CONCRETE FOR A MINIMUM OF 10 FEET FROM THE CROSSING POINT.

IT IS RECOMMENDED THAT DIGGING WITHIN ONE FOOT OF THE MAIN BE DONE WITH HAND TOOLS

IT IS THE CONTRACTOR'S RESPONSIBILITY TO TAKE FIELD NOTES WITH TIES TO THE LOCATION AND ELEVATIONS OF ALL UTILITIES INSTALLED WHEN SURVEYORS ARE NOT AVAILABLE TO RECORD THIS INFORMATION. THE CONTRACTOR SHALL PROVIDE THE FIELD NOTES TO THE PROJECT ENGINEER OR LAND SURVEYOR TO BE USED FOR THE PREPARATION OF ANY REQUIRED AS-BUILT PLANS.

THE CONTRACTOR SHALL PROVIDE APPROPRIATE EROSION AND SEDIMENTATION CONTROL MEASURES AT ALL TIMES TO PREVENT IMPACT ON WATER BODIES, BORDERING VEGETATED WETLANDS, CITY DRAINAGE SYSTEMS AND ABUTTING PROPERTIES.

ANY PROPOSED GAS, ELECTRIC, STEAM, TELEPHONE, CABLE OR OTHER UTILITY LINES ARE TO BE LOCATED AND SIZED BY OTHERS. ALL SERVICES SHALL BE INSTALLED IN ACCORDANCE WITH THE REQUIREMENTS OF THE RESPECTIVE UTILITY.

ALL NEW CONSTRUCTION WILL REQUIRE A ROUGH CONSTRUCTION SIGN OFF DOCUMENT FROM THE CITY OF BOSTON INSPECTIONAL SERVICES DEPARTMENT BEFORE FILING FOR A GENERAL SERVICE

THE SANITARY SEWER SHALL BE CONSTRUCTED IN ACCORDANCE WITH THE SPECIFICATIONS OF THE BOSTON WATER AND SEWER COMMISSION. CONNECTIONS SHALL BE MADE IN ACCORDANCE WITH APPLICABLE PERMITS OBTAINED BY THE CONTRACTOR.

THERE ARE PLUMBING FIXTURES IN THE BASEMENT (LAUNDRY). A BACKWATER VALVE (SEE DETAIL) WILL BE INSTALLED IN THE BASEMENT FOR THE FIXTURES.

IT IS REQUIRED THAT A DYE TEST WILL BE PERFORMED BY THE BOSTON WATER AND SEWER COMMISSION INSPECTOR BEFORE THE STRUCTURE IS OCCUPIED.

THE WATER SERVICE SHALL BE CONSTRUCTED IN ACCORDANCE WITH THE SPECIFICATIONS OF THE BOSTON WATER AND SEWER COMMISSION. CONNECTIONS SHALL BE MADE IN ACCORDANCE WITH APPLICABLE PERMITS OBTAINED BY THE CONTRACTOR. UNLESS DIRECTED OTHERWISE, ALL WATER LINES SHALL BE INSTALLED 5' TO 6' BELOW GRADE. WHERE REQUIRED THRUST RESTRAINTS SHALL BE INSTALLED PER THE COMMISSION'S STANDARD DETAILS. THE ACTUAL METHOD OF RESTRAINT WILL BE

THE SANITARY SEWER SHALL BE CONSTRUCTED IN ACCORDANCE WITH THE SPECIFICATIONS OF THE BWSC. CONNECTIONS SHALL BE MADE IN ACCORDANCE WITH APPLICABLE PERMITS OBTAINED BY THE CONTRACTOR.

THE CONTRACTOR SHALL PROVIDE SAFETY MEASURES TO PROTECT WORKERS, THE PUBLIC AND ALL PROPERTIES DURING CONSTRUCTION. ALL WORK SHALL BE IN ACCORDANCE WITH THE US DEPARTMENT OF LABOR AND THE OCCUPATIONAL SAFETY AND HEALTH ADMINISTRATION (OSHA) STANDARDS.

BENCHMARK

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REFERENCE BENCHMARK: TOPOGRAPHIC DATUM BASE IS CITY OF BOSTON. BENCHMARK IS DMH 268 RIM LOCATED ON MAGNOLIA STREET, ELEVATION=56.25.

MATERIAL SPECIFICATIONS

DETERMINED BY ACTUAL FIELD CONDITIONS.

THE PROPOSED WATER SERVICE SHALL BE 3" TYPE K COPPER PIPE

THE PROPOSED SEWER SERVICE SHALL BE 6" SDR-35 PIPE

THE ROOF DRAIN SHALL BE 4" ADS PERFORATED PIPE

KENDRA ROE

ERT804390

(AS OF RIGHT)

KNG REALTY CORP 58 UNION STREET

BRIGHTON, MA 02135

PHONE: 617-549-1565

THE PROPOSED STRUCTURES AND APPURTENANCES USED FOR THE PROPOSED INFILTRATION SYSTEM WILL BE CONSISTENT OF (2) CULTEC INFILTRATION SYSTEMS, ONE WITH (3) CULTEC RECHARGER 180HD CHAMBERS AND THE SECOND WITH (2) CULTEC RECHARGER 180HD CHAMBERS MANUFACTURED BY CULTEC, OR AN APPROVED EQUAL.

> LEGEND DRAIN MANHOLE (DMH) CATCH BASIN (CB)

FLARED END SECTION (FES)

SEWER MANHOLE (SMH) ELECTRIC MANHOLE (EMH) GAS GATE (GG)

ASSESSORS PARCEL: #1300252000 **COBUCS NUMBER:**

1533238330343 **ISD PERMIT NUMBER:**

TELEPHONE MANHOLE (TMH) GAS SERVICE (GS) WATER GATE (WG) WATER SERVICE (WS) HYDRANT (HYD) SPLASH BLOCK LIGHT POLE (LP) PROPOSED LAMP POST (LAMP) UTILITY POLE (UP) UTILITY POLE w/ LIGHT (UP/LP) HAND HOLE (HH) <u>GC</u> VERTICAL GRANITE CURB (GC) <u>SGE</u> SLOPED GRANITE EDGING (SGE) <u>BB</u> BITUMINOUS CONCRETE BERM (BB) <u>CCB</u> CAPE COD BERM (CCB) <u>CC</u> PRECAST CONCRETE CURB (CC) __EP___ EDGE OF PAVEMENT (EP)

REVISIONS REV PER BWSC COMMENTS 5/7/2020

PWD USE ONLY

CITY OF BOSTON PUBLIC WORKS DEPARTMENT APPROVAL OF SITE UTILITY/GRADING PLAN

APPROVING THE RELATIONSHIP GRADEWISE OF THE PROPOSED BUILDING TO THE ABUTTING PUBLIC WAY(S) AND DOES NOT CONSIDER

THE APPROVAL OF NEW/MODIFIED CURB CUTS. APPARENT BUILDING PROJECTIONS OVER THE PUBLIC WAY? ☐YES ☒NO

ANY BUILDING PROJECTIONS OVER THE PUBLIC WAY, NOTED OR OTHERWISE, REQUIRE ADDITIONAL PERMITTING.

TODD M. LIMING, P.E., DATE

THE PERMITEE AGREE TO SAVE AND HOLD HARMLESS THE

CITY OF BOSTON FROM ALL LIABILITY ARISING FROM THE CONSTRUCTION ASSOCIATED WITH THIS PERMIT.

CONDITIONS OF THE CURB CUT PERMIT

THIS PERMIT IS NON-TRANSFERABLE.

PRINCIPAL CIVIL ENGINEER

THIS PERMIT IS CONDITIONAL AND ONLY BECOMES VALID UPON THE ISSUANCE OF A USE OF PREMISE PERMIT BY THE CITY OF BOSTON INSPECTIONAL SERVICES ("ISD") FOR THE SAME PLAN SUBMITTED WITH THIS PERMIT. THIS PERMIT IS NOT VALID IF THE PLANS ASSOCIATED WITH THE USE OF PREMISES PERMIT HAS BEEN ALTERED IN ANY WAY FROM THE PLAN SUBMITTED WITH THIS PERMIT.

UNLESS OTHERWISE NOTED, THIS PERMIT AUTOMATICALLY EXPIRES 18 MONTHS FROM THE DATE OF THE ISSUANCE UNLESS EXTENDED IN WRITING BY THE CHIEF ENGINEER OF THE PUBLIC WORKS DEPARTMENT. AN EXTENSION MAY BE GRANTED AFTER A REQUEST IS MADE IN WRITING AND THE APPROPRIATE FEES ARE PAID PRIOR TO THE EXPIRATION DATE OF THE PERMIT.

THE PROPOSED SIDEWALK SHALL CONFORM TO THE RULES AND REGULATIONS OF THE MASSACHUSETTS ARCHITECTURAL ACCESS BOARD (CMR521).

ALL WORK DONE UNDER THIS PERMIT SHALL COMPLY WITH WRITTEN REQUIREMENTS OF DIRECTIONS WHICH MAY BE ISSUED BY THE COMMISSIONER OF PUBLIC WORKS RELATING TO THE PARTICULAR PROJECT. IF ANY OF THE CONDITIONS OF THIS PERMIT ARE VIOLATED, THIS PERMIT MAY BE REVOKED BY THE COMMISSIONER OF PUBLIC WORKS.

THE WORK, MATERIALS, PLANS AND SPECIFICATIONS SHALL BE AVAILABLE AT ALL TIMES FOR INSPECTION BY DULY AUTHORIZED OFFICIALS OF THE CITY OF BOSTON.

PRIOR TO THE ISSUANCE OF ANY PERMIT FOR THE CONSTRUCTION OF A DRIVEWAY, A PERMIT FROM THE CITY OF BOSTON PARKS & RECREATION IS REQUIRED FOR THE REMOVAL, AND/OR PLANTING OF ANY TREES ON OR ALONG A PUBLIC WAY. THE OPENING FOR THE DRIVEWAY MUST BE AT LEAST FIVE FEET AWAY FROM ANY TREE, POLE, STREET LIGHT, OR OTHER EXISTING APPURTENANCES. CONTACT (617) 635-4500 TO BE DIRECTED TO THE PARKS DEPARTMENT.

THE RELOCATION AND/OR ADJUSTMENT OF ANY PUBLIC OR PRIVATE UTILITY SHALL BE THE RESPONSIBILITY OF THE PERMITEE PRIOR TO ANY CONSTRUCTION AUTHORIZED BY THIS

COORDINATE THE RELOCATION OF ANY TRAFFIC CONTROL SIGNS, PARKING METERS OR SIGNALIZATION DEVICE WITH THE TRANSPORTATION DEPARTMENT. CONTACT (617) 635-4500 FOR THE TRANSPORTATION DEPARTMENT.

CONSTRUCTION MATERIALS AND EQUIPMENT MUST NOT BE STORED OR PARKED ON THE PUBLIC RIGHT OF WAY, UNLESS OTHERWISE NOTED AS A CONDITION OF THIS PERMIT.

PRIOR TO THE RELEASE OF THIS PERMIT, COMPLETE REPAIR (RESTORATION OF RIGHT OF WAY) SHALL BE MADE OF ANY AND ALL DAMAGES DONE TO THE EXISTING IMPROVEMENTS IN THE PUBLIC RIGHT OF WAY CAUSED BY CONSTRUCTION OPERATIONS ON THIS SITE. ALL DISTURBED AREAS SHALL BE FINE GRADED AND SODDED. PROPER PRECAUTIONS MUST BE TAKEN TO KEEP EXISTING ROADWAYS FREE OF MUD, DEBRIS, AND OTHER OBSTRUCTIONS.

THE PROPOSED WORK SHALL BE PERFORMED IN ACCORDANCE WITH THE CONDITIONS OF THIS PERMIT, SUBJECT TO THE PROVISIONS OF THE MASSACHUSETTS GENERAL LAWS. THE ORDNANCES OF THE CITY OF BOSTON, AND ALL APPLICABLE REGULATIONS, STANDARDS, SPECIFICATIONS, AND INSPECTION AND CONTROL OF THE COMMISSIONERS OF THE DEPARTMENT OF PUBLIC WORKS, INSPECTIONAL SERVICES DEPARTMENT, AND TRANSPORTATION DEPARTMENT.



SITE PLAN FOR A NEW CURB CUT 21 MAGNOLIA STREET

(ROXBURY NEIGHBORHOOD - 02125)

SCALE: 1"=10'

JULY 2, 2019 CM KIRBY ENGINEERING, PLLC

CIVIL ENGINEERING & LAND PLANNING PO BOX 291, NORWOOD, MA 02062 PHONE: 617-872-5553 EMAIL CKIRBY83@GMAIL.COM

(24×36 PAPER) 5'

BWSC 19348

SMH

RIM = 61.87

INV.IN = 53.27

INV.OUT=53.06

PAVEMENT TO BE SAW CUT OR BY OTHER

SEALED TO PREVENT UNRAVELING.

NOT TO SCALE

SEE ROADWAY

TYPICAL SECTION

APPROVED METHOD. JOINT TO BE PROPERLY

LIMIT OF TRENCH PAVING

SEE TRENCH DETAIL

-NEW OR RESET

ETTING BED FOR

GRANITE EDGESTONE

EDGESTONE

WIDTH OF EXCAVATION

PERMANENT TRENCH REPAIR

----1.5% (2% MAX)

PUBLIC WORKS DEPARTMENT ENGINEERING DIVISION - DETAIL NO. S1

CONCRETE SIDEWALK AND DRIVEWAYS

NOT TO SCALE

∖6" CEMENT CONC.

SIDEWALK

GRAVEL BASE

 \Box

`6" COMPACTED

MEET EXISTING GRADE

- GRAVEL SUBBASE

-GRAVEL BACKFILL

(BWSC DETAIL)

CLASS 1 BIT. CONC. PAVEMENT

- CLASS 1 BIT.CONC. PVMT. BINDER

COURSE, TYPE I-1 PLACED IN TWO

STORMWATER INFILTRATION SYSTEM "B"

w/ INSPECTION PORTAL (TRAFFIC RATED

(2) CULTEC 180HD CHAMBERS OR EQUAL

PROVIDING 70.74± CF OF STORAGE WITH

6" OF STONE

GRADE=60.5± TOP OF STONE=59.1±

 $I=57.3\pm$ BOTTOM OF STONE=56.8±

STORMWATER INFILTRATION SYSTEM "A"

w/INSPECTION PORTAL (TRAFFIC RATED

(3) CULTEC 180HD CHAMBERS OR EQUAL

6" OF STONE

GRADE=58.0± TOP OF STONE=56.7±

I=54.8 BOTTOM OF STONE= $54.2\pm$

STANDARTPARK 4" TRENCH

DRAIN w/ 18" SUMP , D400

(OR EQUAL)

 $R=58.0 \pm I=57.3 \pm$

WITH "DON'T DUMP PLAQUE"

PROVIDING 106.1± CF OF STORAGE WITH

N/F

BARBARA J. JOHNSON

3 STORY

W.F.D.

PORCH

WEARING COURSE, TYPE I-1

LIFTS OF EQUAL THICKNESS

SHEET No. 1 OF

(PUBLIC-40' WIDE)

DMH 269

RIM = 59.54

INV.IN = 53.94

INV.IN = 52.04

INV.OUT=51.51

—12"D-

NEW SINGLE FAMILY HOME - ATTACHED DUPLEX DND - TYPE E

21 MAGNOLIA STREET BOSTON, MA

DESCRIPTION OF THE WORK:

ERT804390 (AS OF RIGHT)
COBUCS # 1533238330343
BWSC SITE PLAN # 19348


#10 WOODFORD ST S-1 P. S. SHARON L. WILLIAMS #38 WOODFORD ST PARCEL 1300252000 N/F BARBARA J. JOHNSON 3 STORY W.F.D. #25 MAGNOLIA ST. CITY OF BOSTON #23 MAGNOLIA ST. PORCH BENCHMARK DMH 268 RM=56.25 INV.IN=49.25(DMH) INV.IN=48.95 INV.OUT=48.93

SITE PLAN

NOTES:

- 1. NO WORK SHALL COMMENCE UNTIL A BUILDING PERMIT HAS BEEN OBTAINED
- . THE CONTRACTOR SHALL OBTAIN AND PAY FOR ALL PERMITS AND APPROVALS REQUIRED BY THE LOCAL ZONING AND BUILDING DEPARTMENTS AND ANY OTHER GOVERNMENTAL AGENCIES HAVING JURISDICTION OVER THE WORK
- 3. ALL WORK SHALL BE IN ACCORDANCE WITH THE MASSACHUSETTS STATE BUILDING CODE, 9th EDITION 4. DRAWINGS ARE NOT TO BE SCALED. ALL WORK SHALL BE LAID OUT BY DIMENSIONS. ANY DEVIATIONS
- 4. DRAWINGS ARE NOT TO BE SCALED. ALL WORK SHALL BE LAID OUT BY DIMENSIONS. ANY DEVIATION SHALL BE BROUGHT TO THE ATTENTION OF THE DESIGNER IMMEDIATELY. ALL DEVIATIONS SHALL BE CORRECTED BY CONTRACTOR BEFORE HE BEGINS HIS PORTION OF THE WORK.
- 5. DRAWINGS ARE THE PROPERTY OF THE DESIGNER AND SHALL NOT BE COPIED OR DUPLICATED IN ANY MANNER.
- 6. CONSTRUCTION SHALL BE PERFORMED IN SUCH A MANNER AS TO PROTECT WORKMEN AND GENERA
- PUBLIC FROM INJURY & ADJACENT PROPERTY FROM DAMAGE.
- 7. THE DRAWINGS ARE PREPARED FOR THE PURPOSE OF PERMIT APPLICATION ONLY.

 8. IT IS THE RESPONSIBILITY OF THE CONTRACTOR TO NOTIFY THE ENGINEER IN CASE OF ANY OR ALL DEVIATIONS FOR THESE DRAWINGS. THE ENGINEER SHALL BE HELD HARMLESS AS A RESULT OF ANY UNAUTHORIZED CHANGES TO THESE PLANS. ADDITIONAL FEES MAY OCCUR FOR "AS—BUILT" DOCUMENTATION DUE TO CIRCUMSTANCES BEYOND THE ENGINEERS CONTROL, OR OWNER / CONTRACTOR CHANGES TO THESE

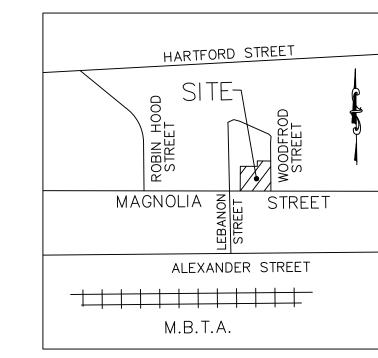

LOCUS
NOT TO SCALE

THE WORK ENTAILS INSTALLATION OF A NEW DND - TYPE "E" STRUCTURE

NOTE

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- 3. ZONE DISTRICT: ROXBURY NEIGHBORHOOD

 ZONING SUBDISTRICT: 3F-4000

 SUBDISTRICT TYPE: THREE-FAMILY RESIDENTIAL

 ZONING OVERLAY DISTRICT: NEIGHBORHOOD DESIGN REVIEW

	21 MAGNOLIA STR Zo	ing Table REET - 1 FAMILY (Toning Tables Requirements 3F-400	,
Dimensional Regulations	Requirements for Residential Subdistrict 3F-4000	Proposed	Comment
Lot Area, sf	2000 sf	2607 sq ft	
Lot Width, ft	45	25.59	Existing Non-conforming
Lot Frontage, ft	45	25.59	Existing Non-conforming
F/A/R (Max.)	0.8	0.62 (1625 sf ±)	
Building height (stories)	3	2.5	
Building height (feet)	35'-0"	29'-5" Grade @ Sidewalk	
Usable Open Space per Dwelling Unit	650 sf	675 sf ±	
Front Yard Depth, ft	6.31	6.45	Section 50-44, Paragraph 2 - Conformity with Existing Building Alignment.
Side Yard Depth, ft	5.65	(L)-9.0 (R)-0.0	Section 50-44, Paragraph 7 - Side Yards of Certain Narrow Lots. A lot narrower than (50) feet shall have (2) inches deducted from the side yard for each foot below (50) feet. Average yard width = 25.59'. Modified side yard setback = 10' - ((50-25.59) * 0.17') = 5.65' Article 50, Table F, Footnote F: Semi-attached dwellings,
			Town House Buildings, and Row House Buildings are required to have side yards only on sides that are not attached to another Dwelling.
Rear Yard Depth, ft	30	47.35	
Rear yard Max. Occ. by Accessory Buildings	.25	N/A	

CODE INFORMATION:

BUILDING CODE: MA STATE BUILDING CODE, 9th EDITION 2015 IRC w/MA AMENDMENTS

USE GROUP: R2 - SINGLE FAMILY ATTACHED

CONSTRUCTION TYPE: V-B (UNPROTECTED WOOD FRAME)

FLOOR LOADS:

DESIGN LIVE LOADS AS PER TABLE (R)301.5:

COMMON AREAS (OTHER THAN SLEEPING): 40 PSF SLEEPING AREAS: 30 PSF RESIDENTIAL ATTICS w/ FIXED STAIRS: 30 PSF RESIDENTIAL ATTICS(STORAGE): 20 PSF RESIDENTIAL ATTICS(NO STORAGE): 10 PSF DECKS: 40 PSF

SNOW LOADING:

GROUND SNOW LOAD PER TABLE (R)301.2(4): GROUND SNOW LOAD, Pg = 40 PSF

WIND LOADING:

WIND LOAD PER TABLE (R)301.2(4):

BASIC WIND SPEED (ULTIMATE), Vult =128 PSF

BASIC WIND SPEED (ALLOWABLE), Vasd = 100 PSF

(WIND SPEED CONVERSION PER TABLE (R)301.2.1.3)

LIST OF DRAWINGS:

- A-0.0 COVER PAGE/SITE PLAN
- A-1.0 BASEMENT & FIRST FLOOR PLANS
- A-1.1 SECOND & ATTIC FLOOR PLANS
- A-1.2 ROOF PLAN
- A-2.0 FRONT & LEFT ELEVATIONS
- A-2.1 REAR & RIGHT ELEVATIONS
- S-1.0 FOUNDATION & FIRST FLOOR FRAMING PLANS
- S-1.1 SECOND FLOOR & ATTIC FRAMING PLANS
- S-1.2 ROOF FRAMING PLAN
- E-1.0 ELECTRICAL GENERAL NOTES
- E-1.1 BASEMENT & FIRST FLOOR ELECTRICAL PLANS
- E-1.2 SECOND FLOOR & THIRD FLOOR ELECTRICAL PLANS
- T-1.0 SYMBOLS, SYSTEMS, ABBREVIATIONS & GENERAL NOTES
- T-1.1 GENERAL NOTES
- G-1.1 KITCHEN ELEVATION AND DETAILS
- G-2.0 DOOR SCHEDULE, DOOR / WINDOW DETAILS
- G-3.0 ROOM FINISH SCHEDULE & PARTITION TYPES
- G-4.0 WALL SECTIONS
- G-4.1 WALL SECTIONS
- G-5.0 TYPICAL DETAILS
- G-5.1 TYPICAL DETAILS

21 MAGNOLIA STREET BOSTON, MA

CONTACT:
KENDRA ROE
KNG REALTY CORP
58 UNION STREET
BRIGHTON, MA 02135
PHONE: 617-549-1565

ASSESSORS PARCEL:
#1300252000

COBUCS NUMBER:

1533238330343

ISD PERMIT NUMBER:

ERT804390 (AS OF RIGHT)


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CHRISTOPHER M. KIRBY, PE MA PE LICENSE No. 41662

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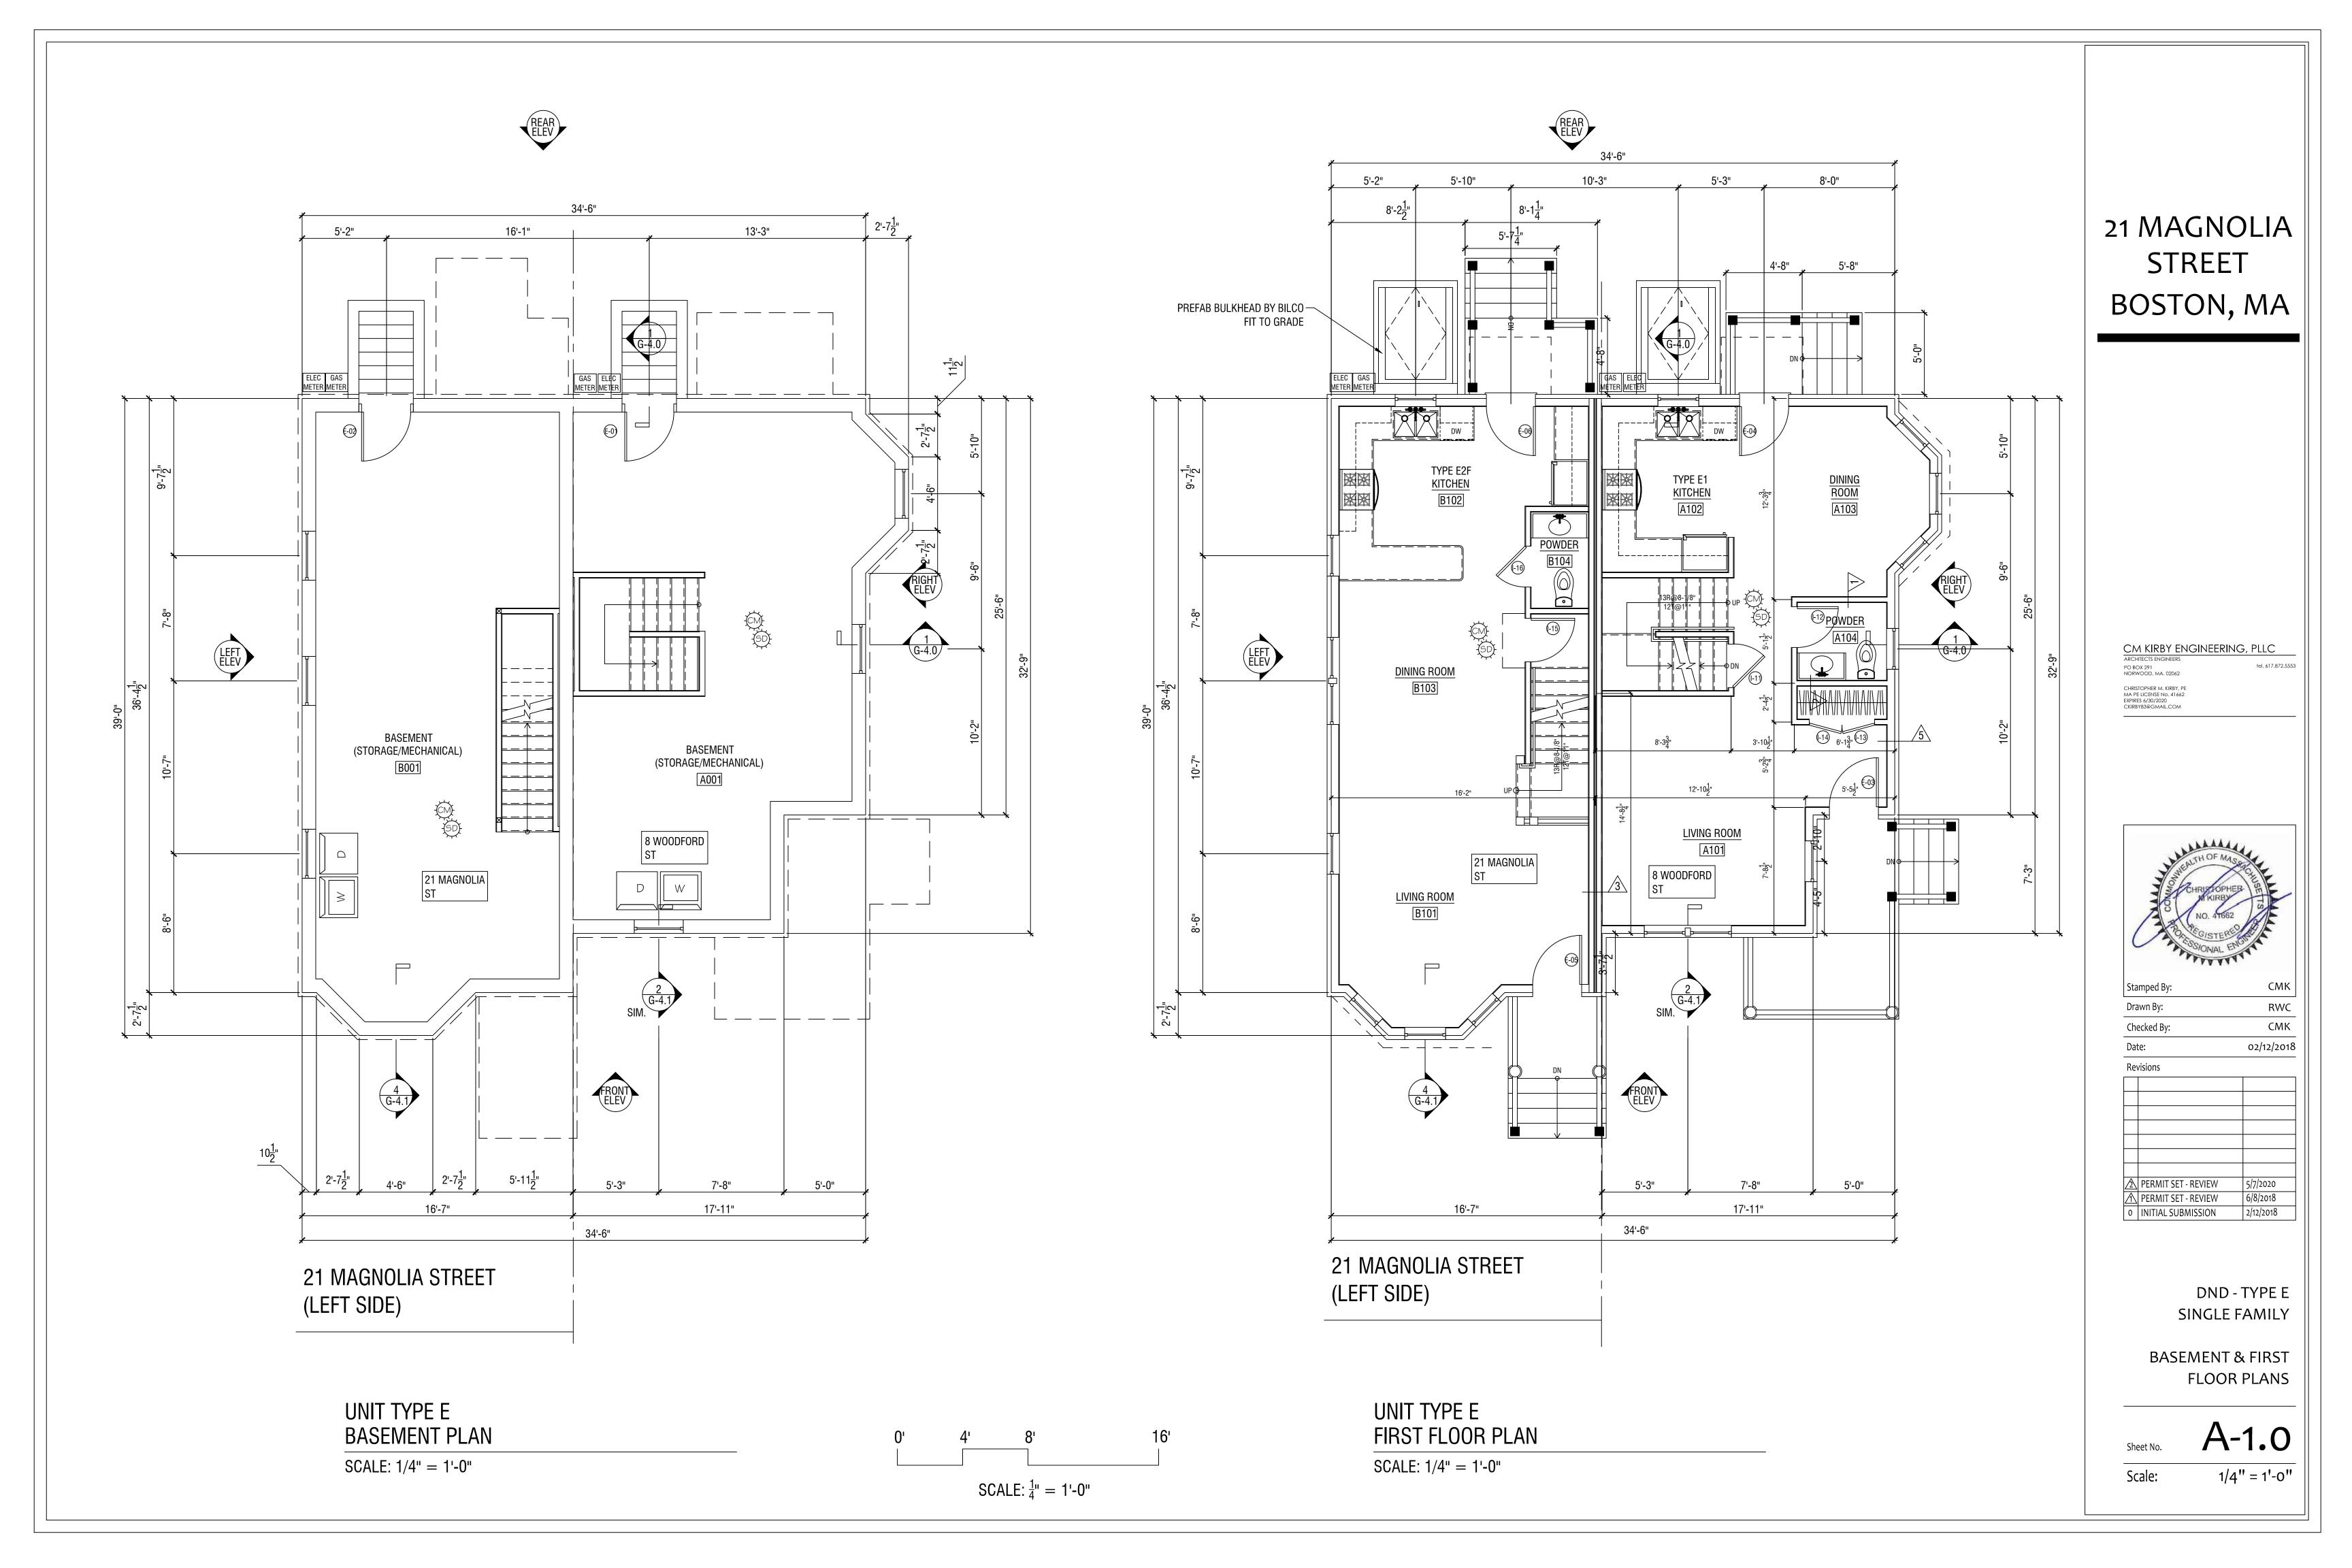
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Drawn By:	RW
Checked By:	CMI
Date:	02/12/20
Revisions	
PERMIT SET - REVIEW	5/7/2020
PERMIT SET - REVIEW	6/8/2018
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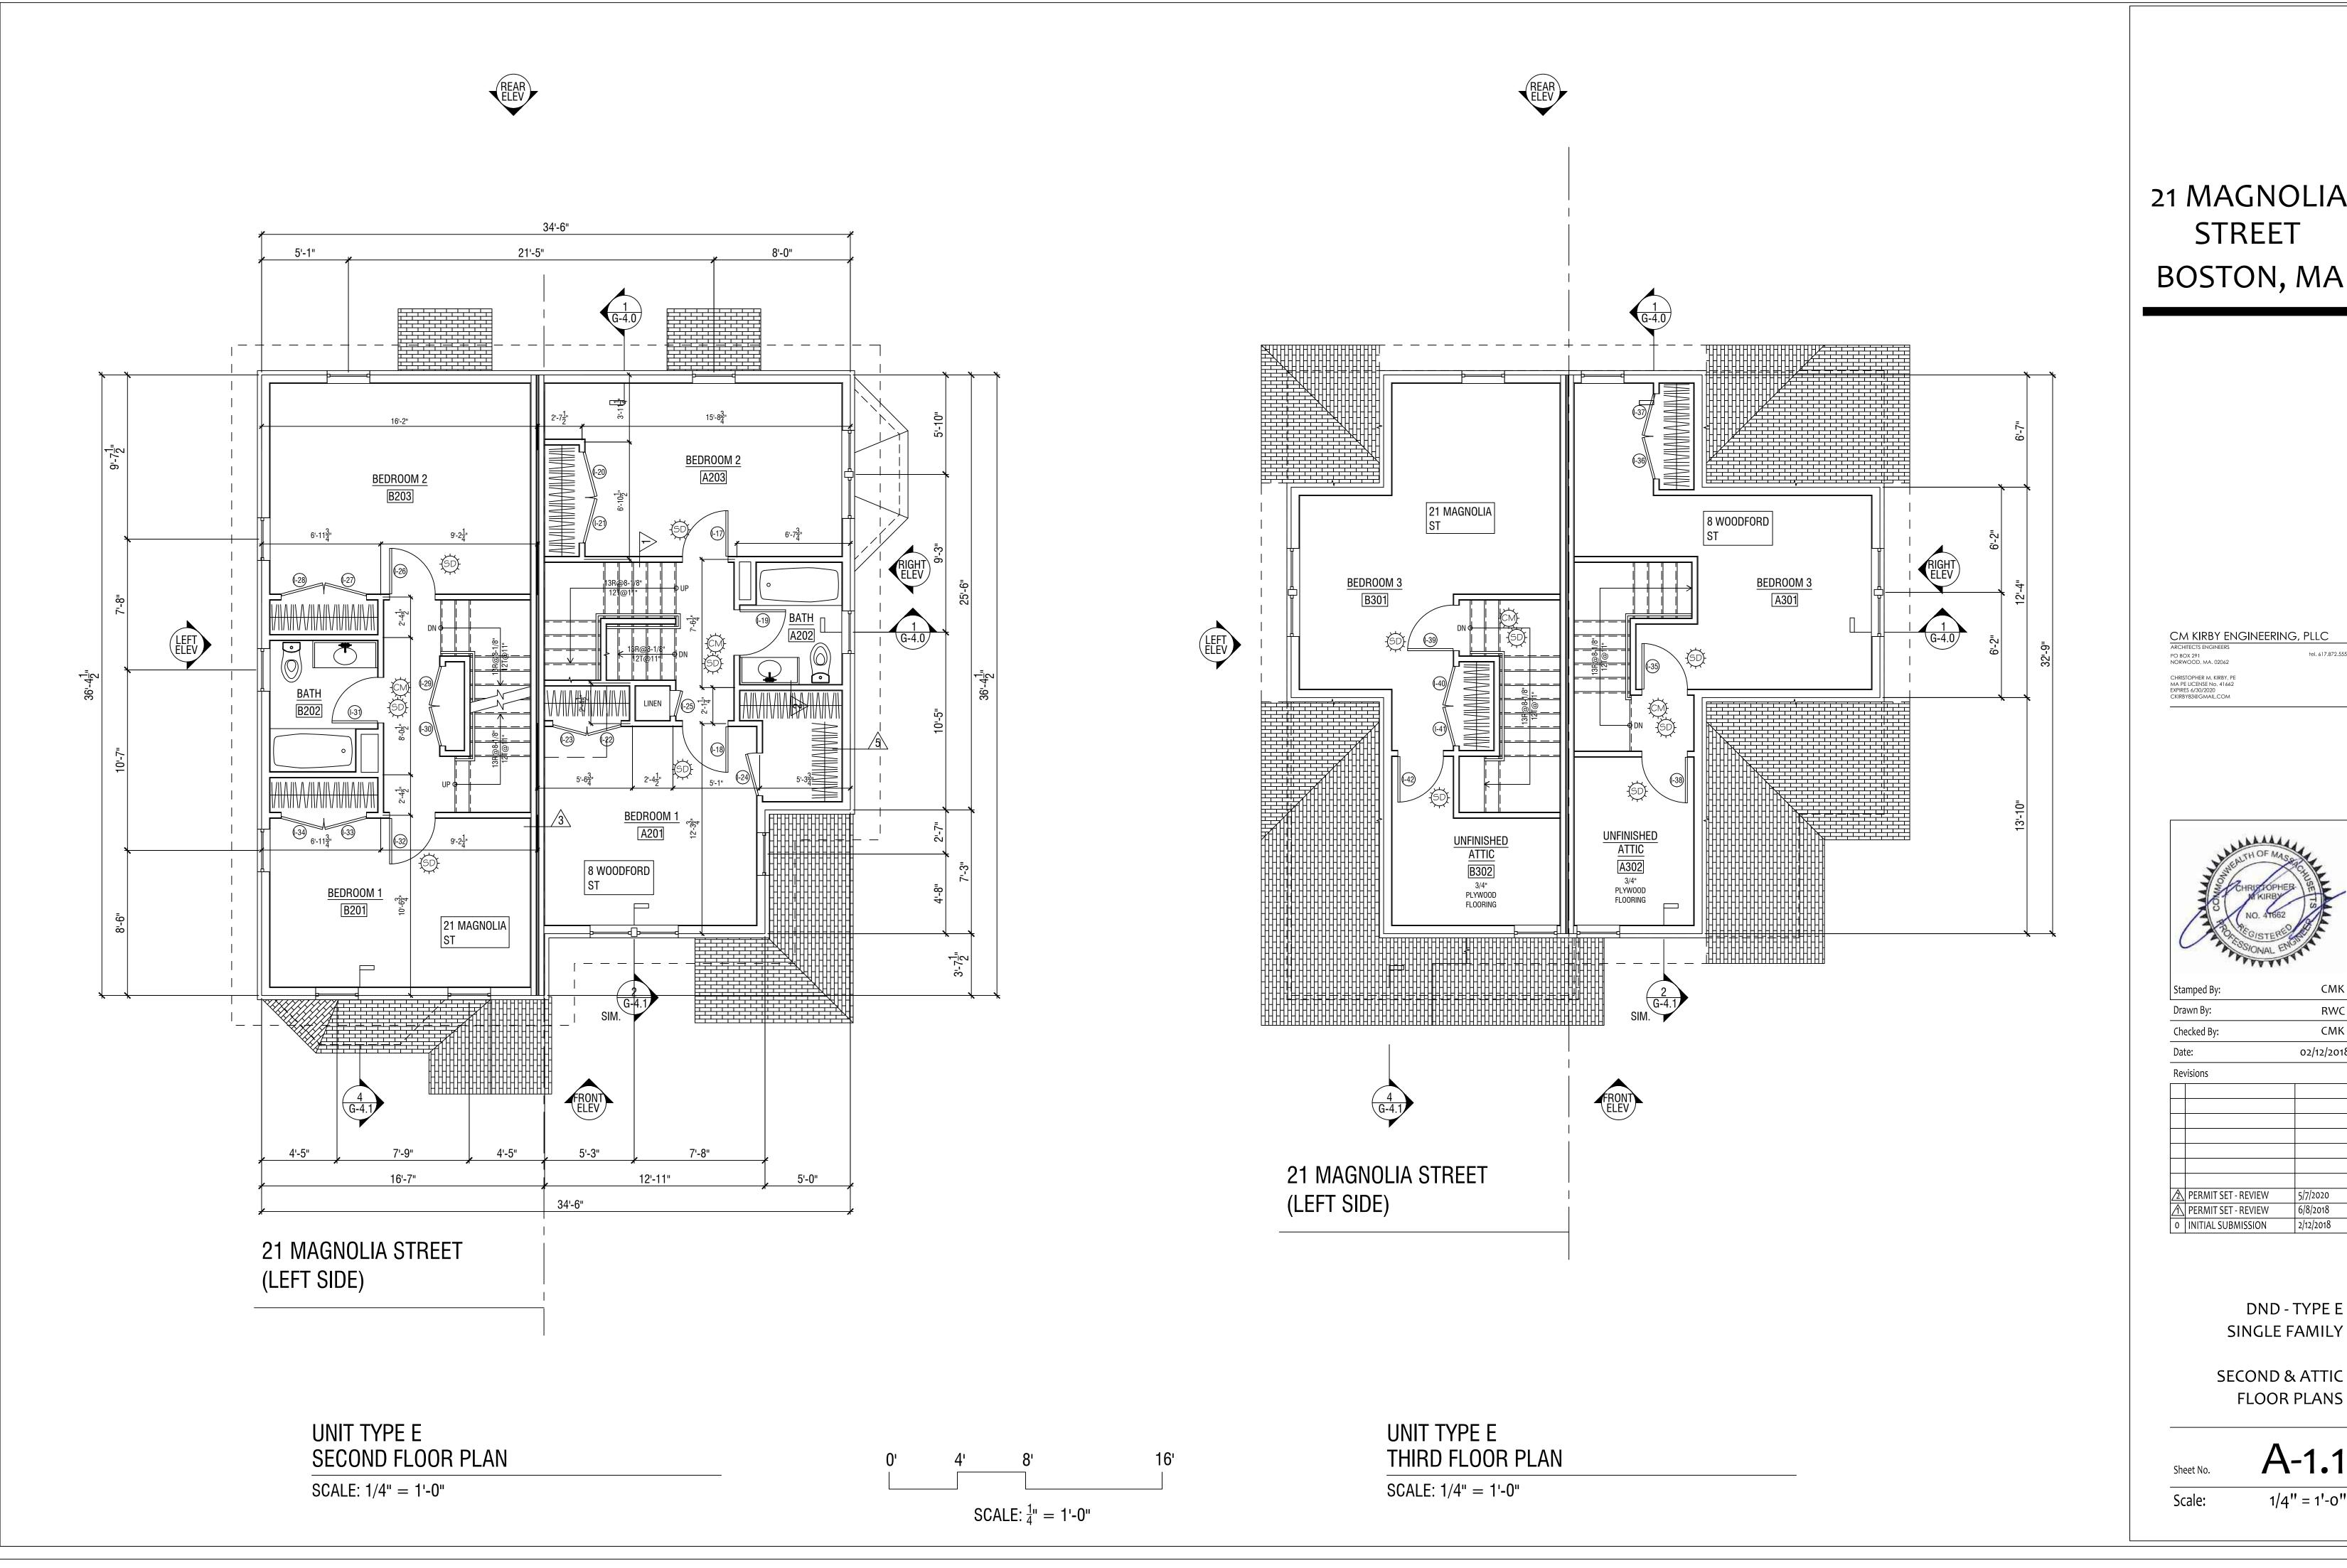
DND - TYPE E SINGLE FAMILY

COVER PAGE

eet No. **A-O.O**

Scale: 1/4" = 1'-0"

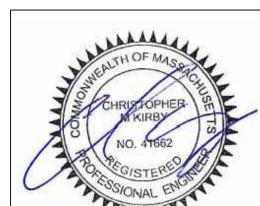



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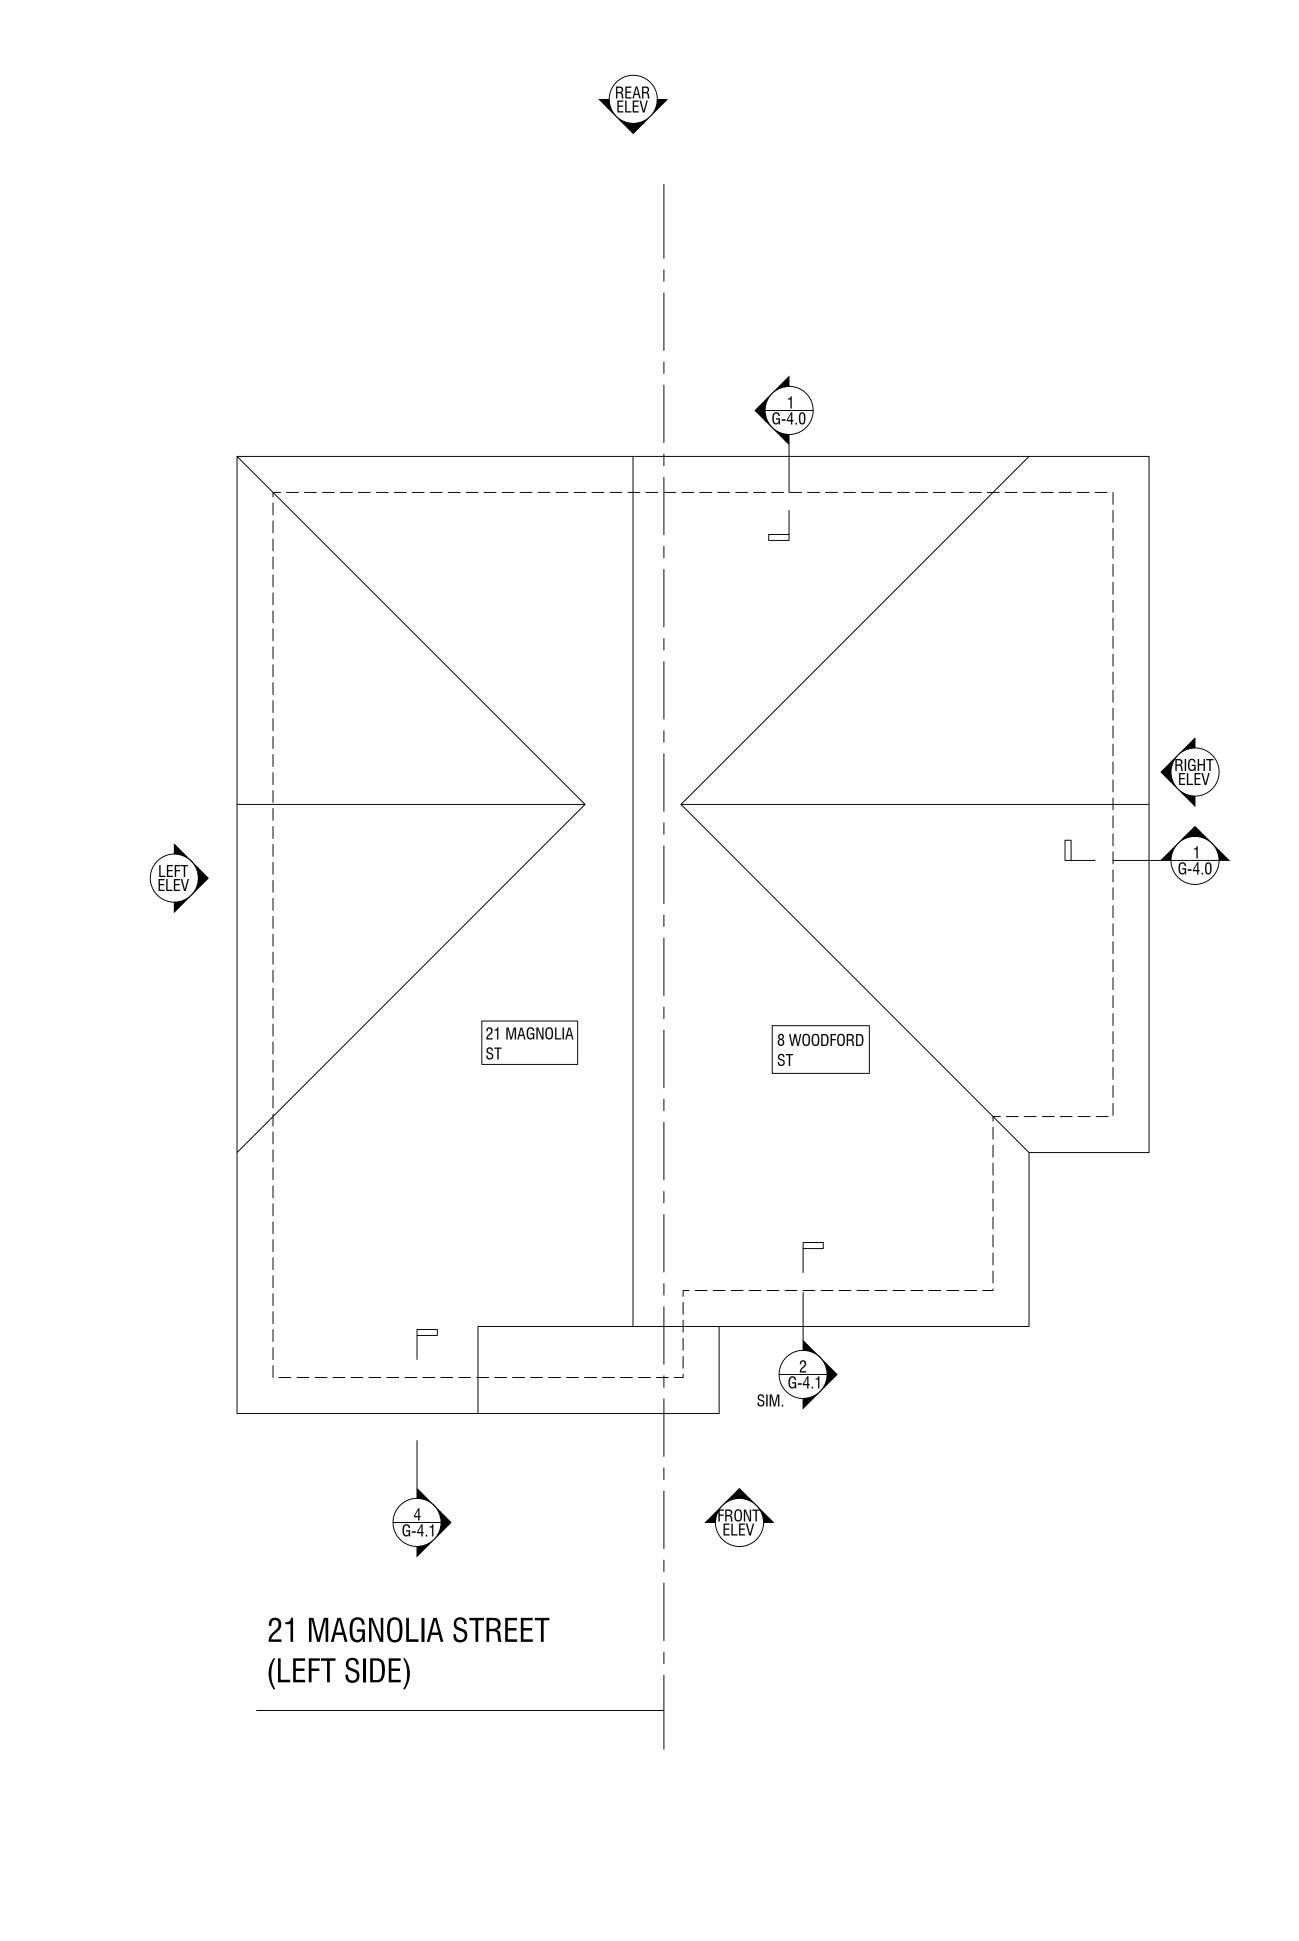
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CMK RWC CMK 02/12/2018 6/8/2018

SINGLE FAMILY

FLOOR PLANS

A-1.1 1/4" = 1'-0"



21 MAGNOLIA STREET BOSTON, MA

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2	PERMIT SET - REVIEW	5/7/2020
\triangle	PERMIT SET - REVIEW	6/8/2018
0	INITIAL SUBMISSION	2/12/2018


DND - TYPE E SINGLE FAMILY

ROOF PLAN


Scale: 1/4" = 1'-0"


UNIT TYPE E **ROOF PLAN** SCALE: 1/4" = 1'-0"

SCALE: $\frac{1}{4}$ " = 1'-0"

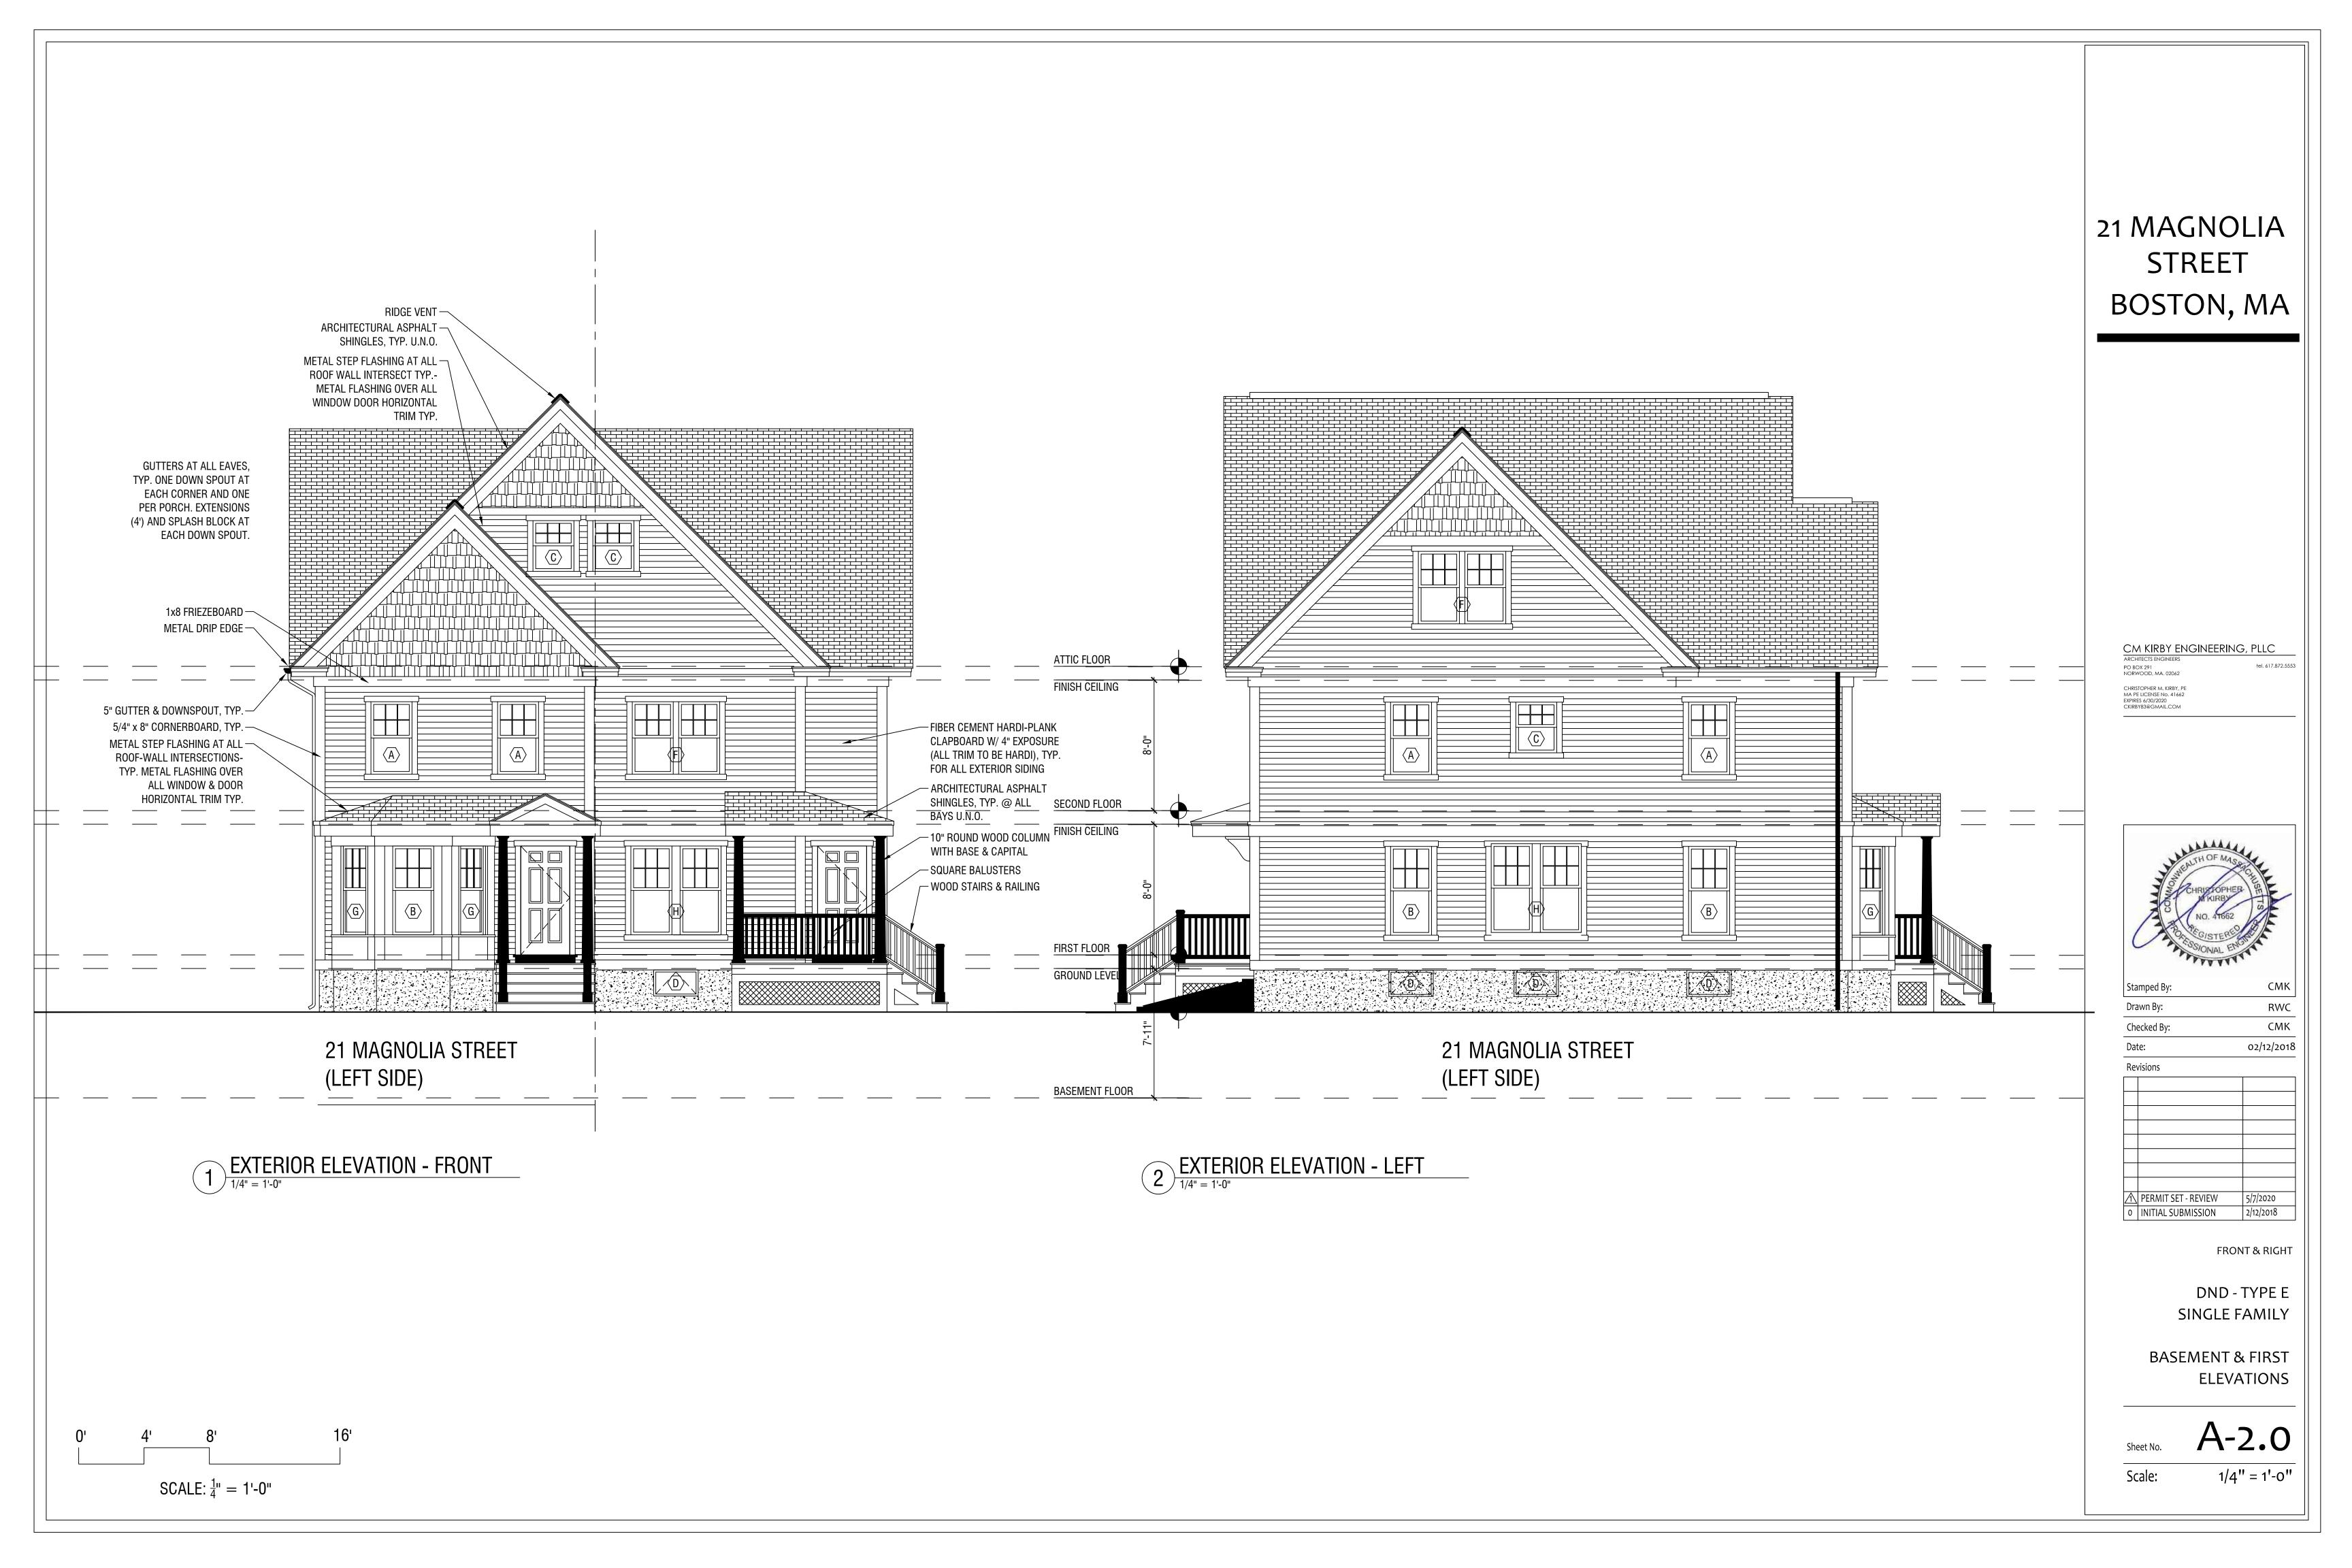



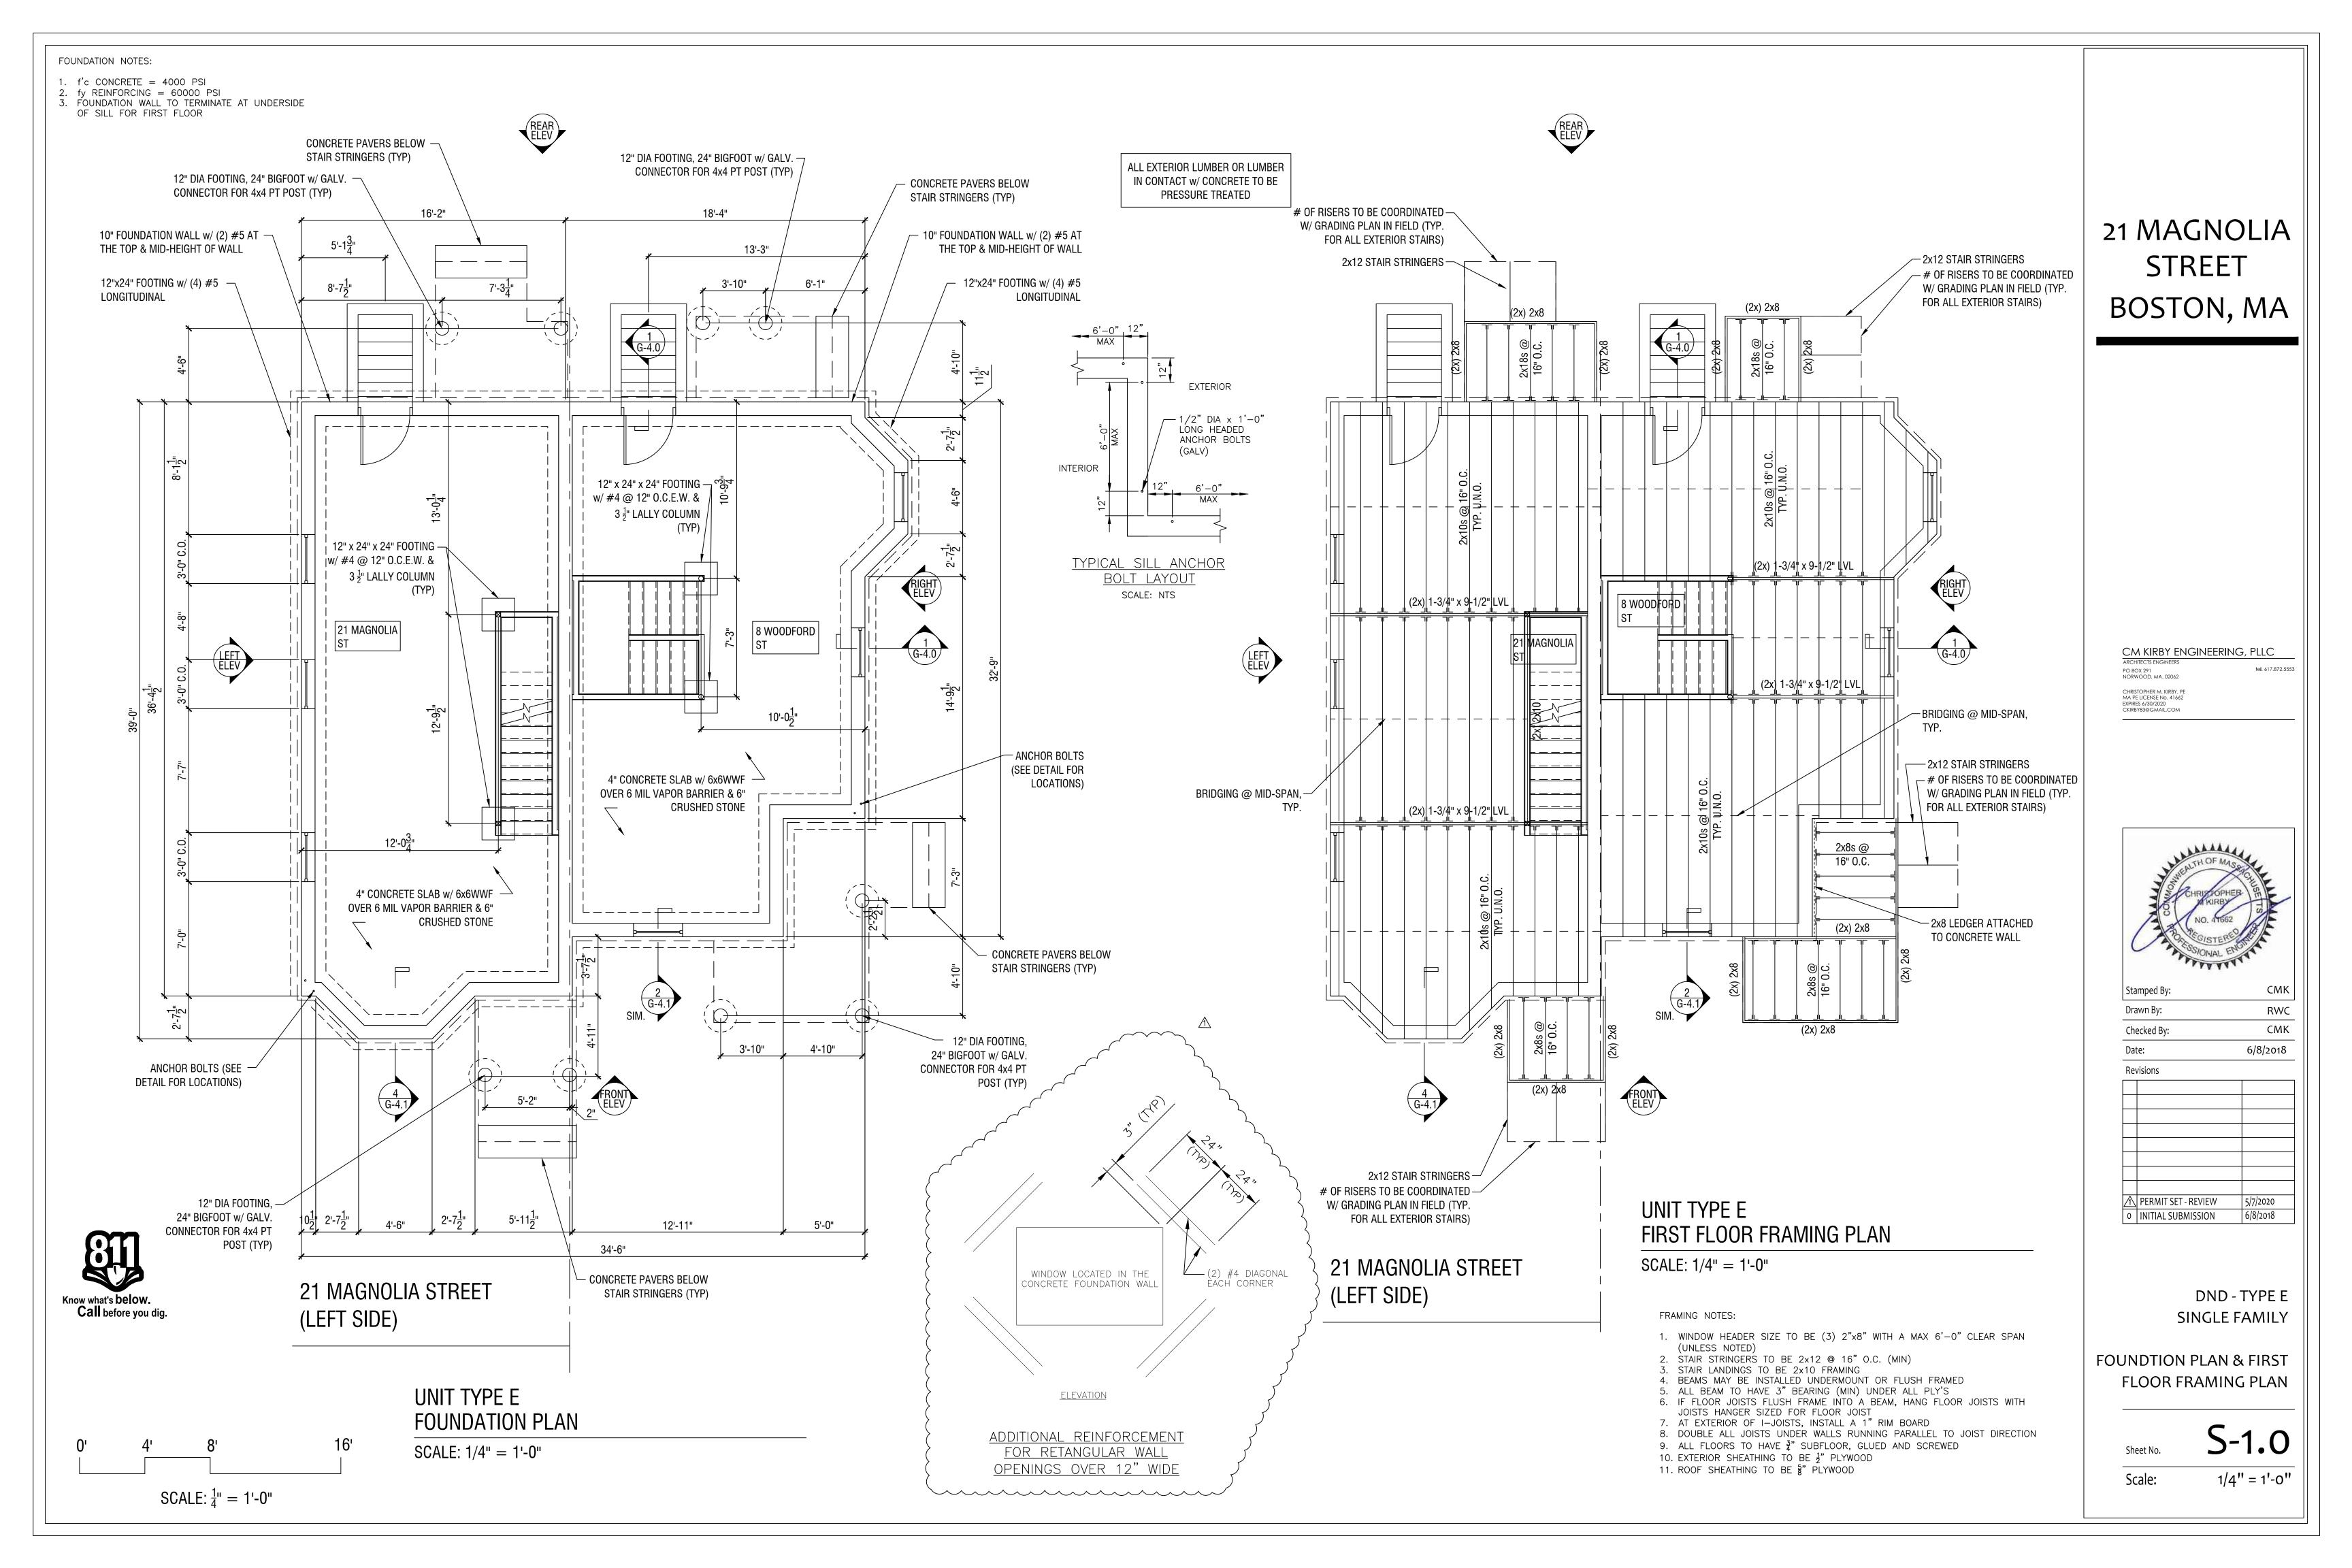


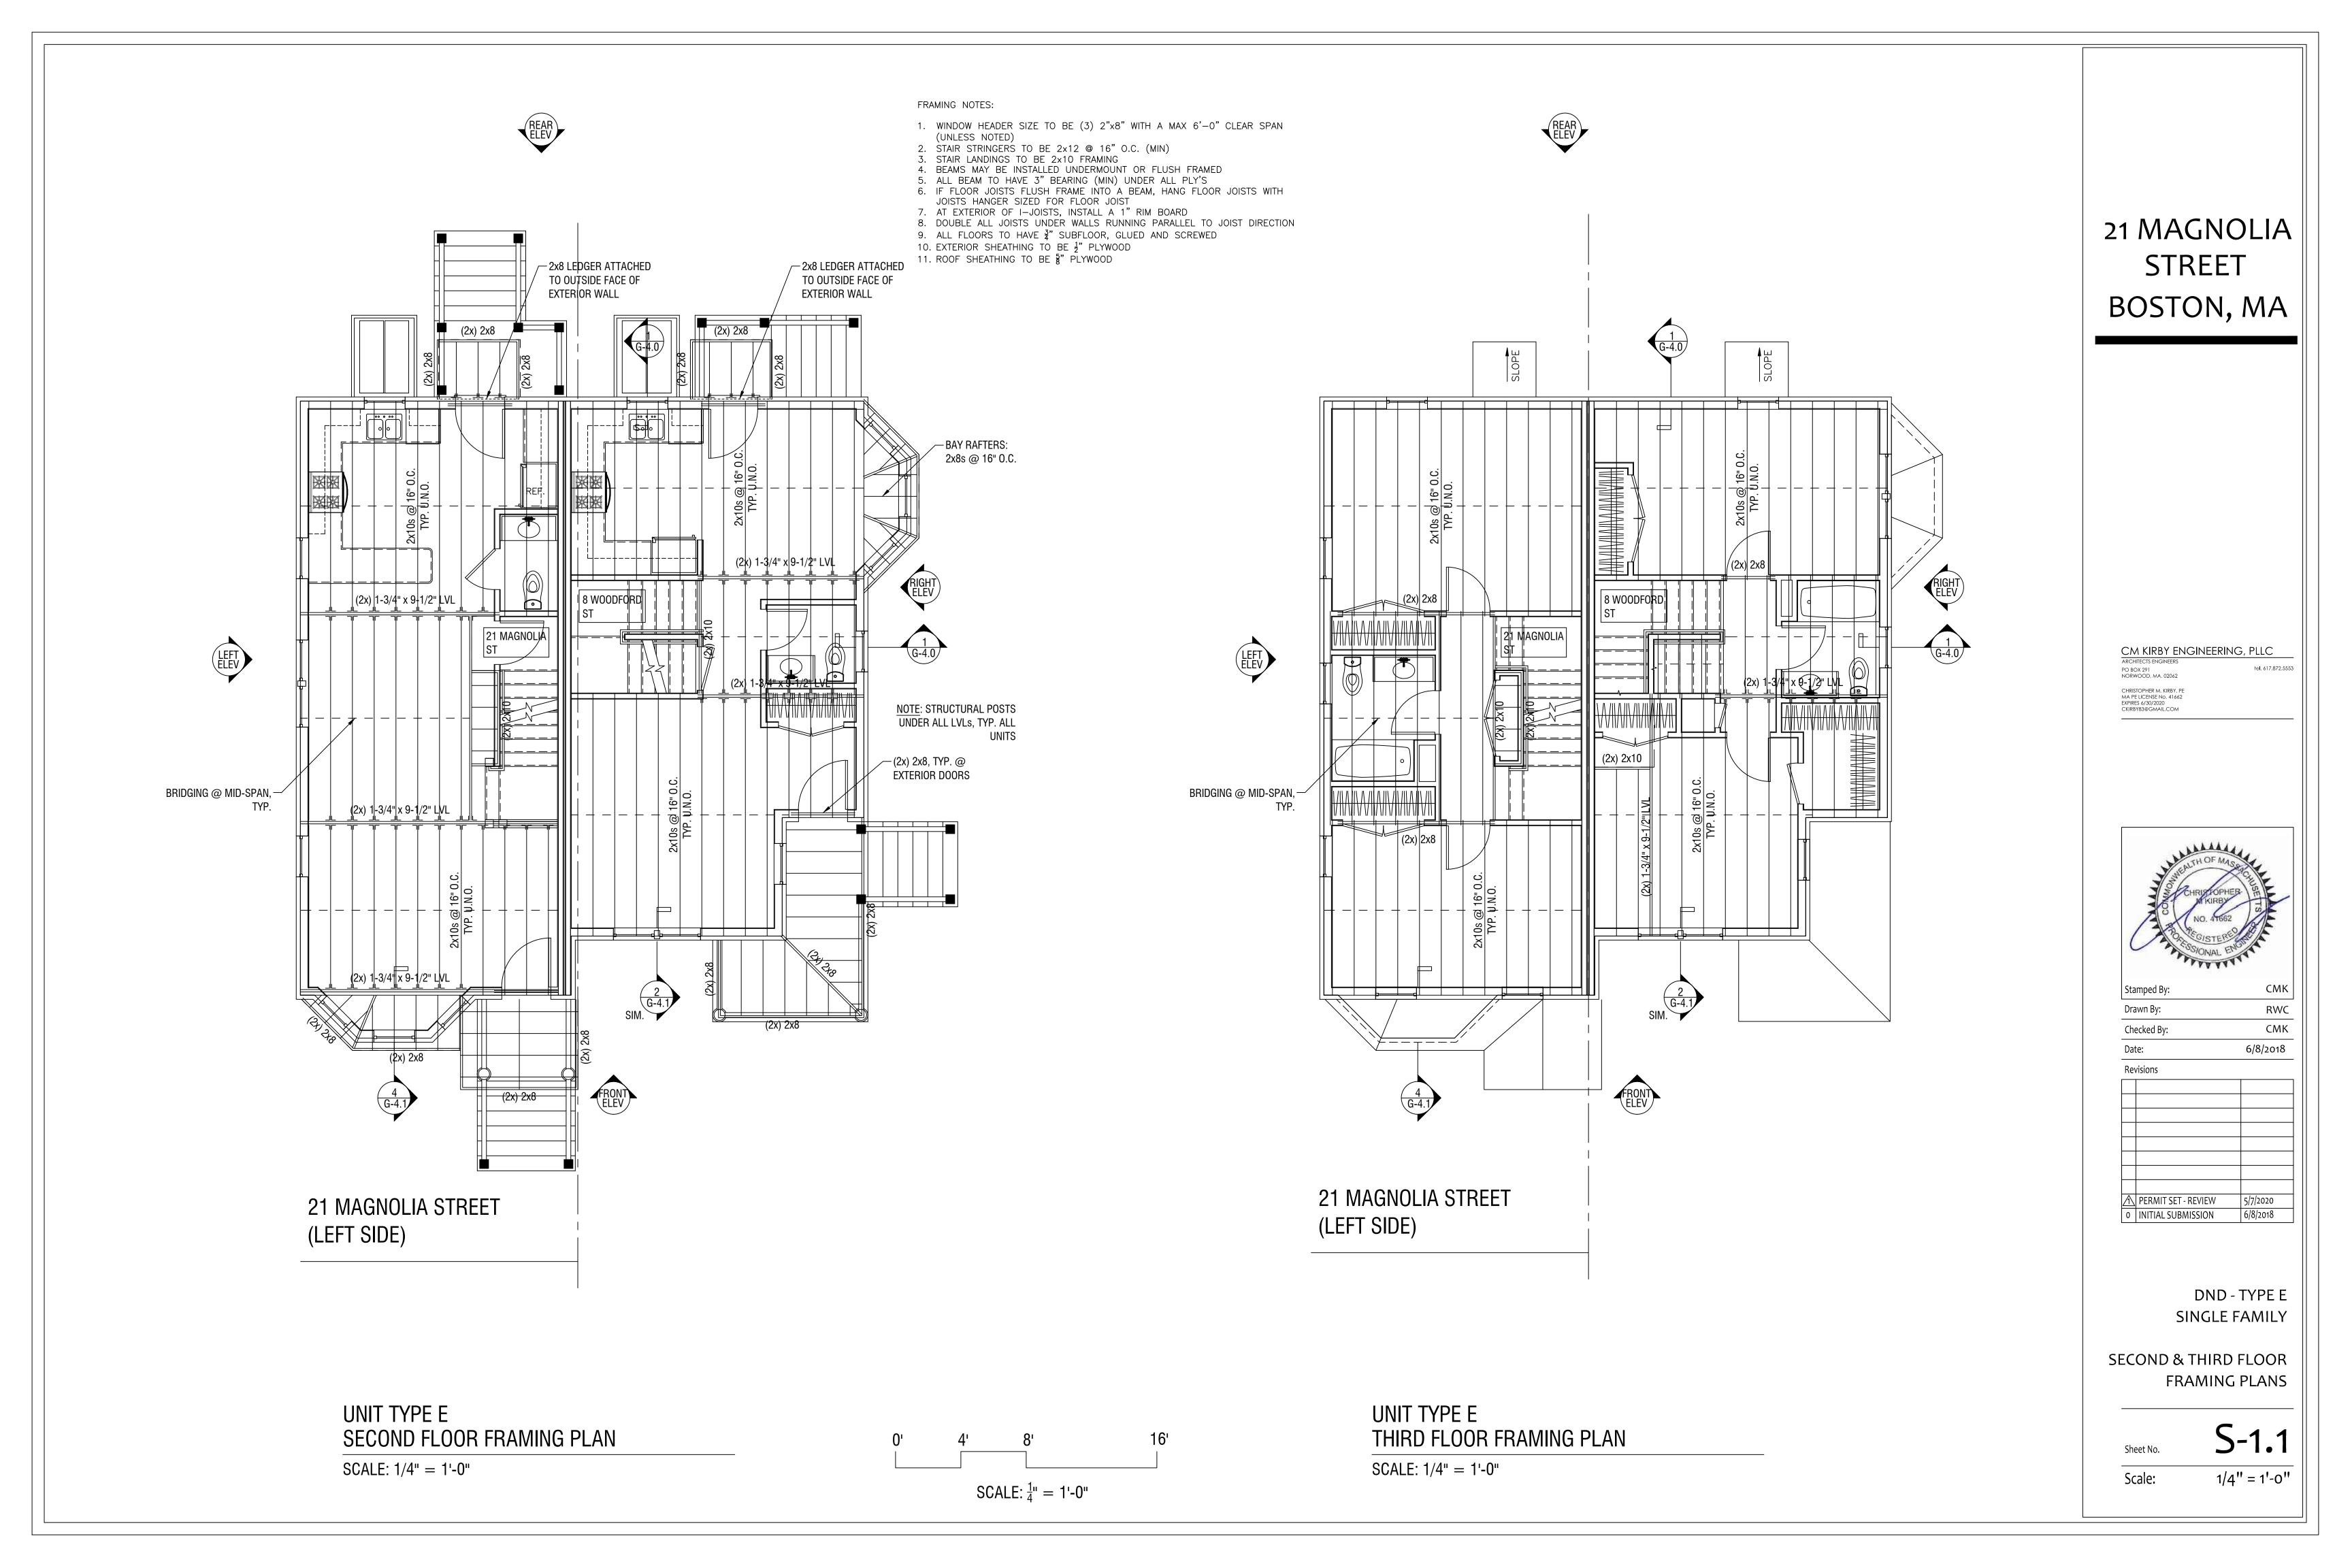

FRAMING NOTES:

- 1. WINDOW HEADER SIZE TO BE (3) 2"x8" WITH A MAX 6'-0" CLEAR SPAN
- (UNLESS NOTED)
- 2. STAIR STRINGERS TO BE 2x12 @ 16" O.C. (MIN)
 3. STAIR LANDINGS TO BE 2x10 FRAMING
- 4. BEAMS MAY BE INSTALLED UNDERMOUNT OR FLUSH FRAMED 5. ALL BEAM TO HAVE 3" BEARING (MIN) UNDER ALL PLY'S
- 6. IF FLOOR JOISTS FLUSH FRAME INTO A BEAM, HANG FLOOR JOISTS WITH JOISTS HANGER SIZED FOR FLOOR JOIST
- 7. AT EXTERIOR OF I-JOISTS, INSTALL A 1" RIM BOARD 8. DOUBLE ALL JOISTS UNDER WALLS RUNNING PARALLEL TO JOIST DIRECTION
- 9. ALL FLOORS TO HAVE \(\frac{3}{4} \) SUBFLOOR, GLUED AND SCREWED
- 10. EXTERIOR SHEATHING TO BE $\frac{1}{2}$ " PLYWOOD 11. ROOF SHEATHING TO BE 8" PLYWOOD



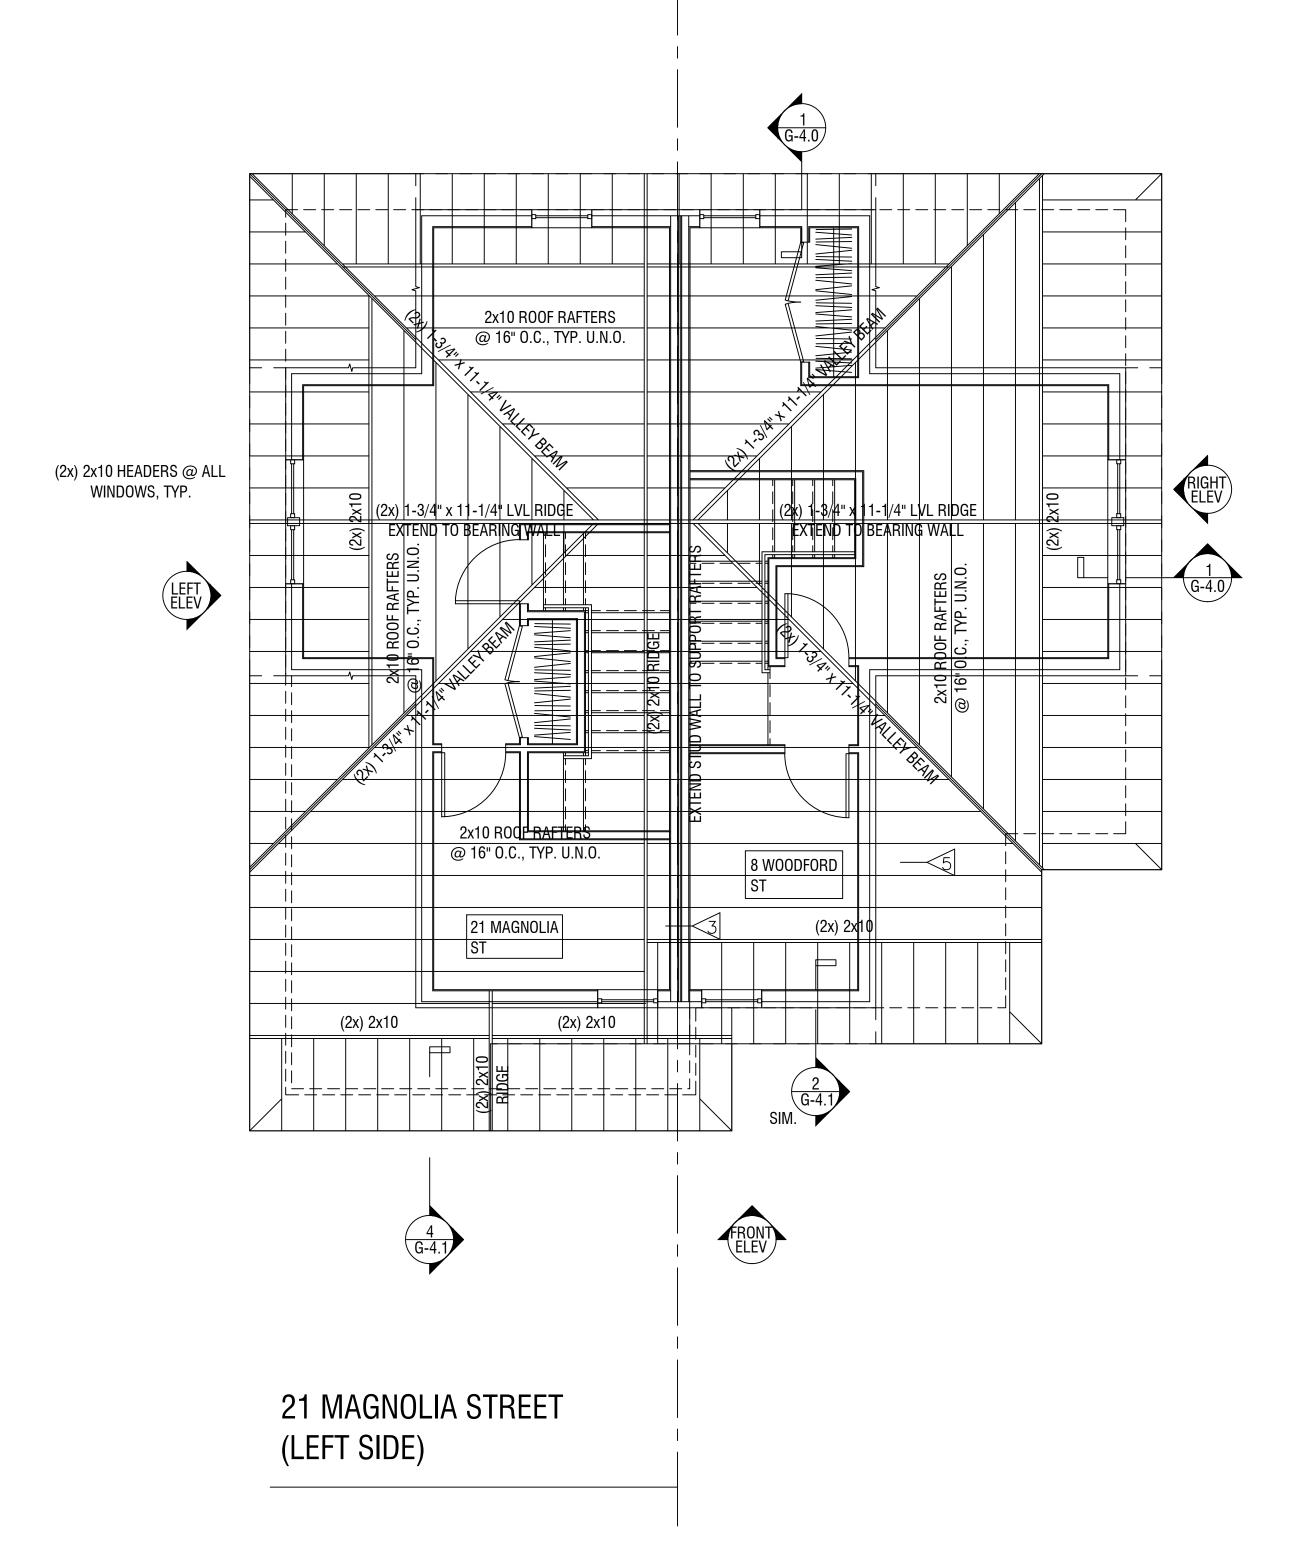

UNIT TYPE E ROOF FRAMING PLAN

SCALE: 1/4" = 1'-0"

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Dr	awn By:	RWC
Ch	ecked By:	СМК
Da	te:	6/8/2018
Re	visions	
	PERMIT SET - REVIEW	5/7/2020
0	INITIAL SUBMISSION	6/8/2018

DND - TYPE E SINGLE FAMILY

ROOF FRAMING PLAN

S-1.2

Scale: 1/4" = 1'-0"

SCALE: $\frac{1}{4}$ " = 1'-0"

	FIXTURE SCHEDULE						
TYPE:	MANUFACTURER:	CATALOG NUMBER:	VOLT:	LAMP:	DESCRIPTION:		
U1	PROGRESS	P2851-09	120V	(2)23WCFL MINI-TWIST	KITCHEN		
U2	PROGRESS	P3688-09	120V	(1)13 CFL MINI-TWIST	ENTRANCE/LIVING RM/ HALLWAY & STAIR		
U3	PROGRESS	P6163-09WB	120V	(4)50W MR16	DINING ROOM		
U4	PROGRESS	P3408-09	120V	(1)13 CFL MINI-TWIST	CLOSET LIGHT		
U5	PROGRESS	P3688-09	120V	(1)13 CFL MINI-TWIST	BEDROOM LIGHT		
U6	PROGRESS	P3223-09WB	120V	(3)60W HALOGEN G9	BATHROOM VANITY ABOVE SINK		
U7	PROGRESS	P3410-09	120V	(2)13 CFL MINI-TWIST	BATHROOM CEILING LIGHT		
Α	PROGRESS	P6017-84	120V	(2)18W CFL	EXTERIOR CEILING MOUNTED		
В	PROGRESS	P5749-84	120V	(1)18W CFL	EXTERIOR WALL MOUNTED		
С	PROGRESS	P3688-09	120V	(1)13 CFL MINI-TWIST	BASEMENT LIGHT		
D	PROGRESS	P2501-04	120V	-	CEILING FAN		


	MECHANICAL SYSTEMS
HEATING/COOLING SYSTEM:	1. FAJITSU, MITSHUBISHI, OR EQUAL MINI SPLIT HEAT PUMP SYSTEM - COMPRESSOR SIZED - 4 HEADS NO DUCTS SHALL BE INSTALLED - HSPF OF 12 OR GREATER - SEER OF 20 OR GREATER
	OR 2. DUCTED FORCED HOT AIR SYSTEM w/ AC SYSTEM
	- FURNACE TO BE NATURAL GAS, 95% EFFICIENT - COMPRESSOR SIZED - NO DUCTS OR SOFFITS SHALL BE EXPOSED. DUCT WORK SHALL BE INSTALLED IN FLOOR BAYS BETWEEN JOIST OR IN WALLS BETWEEN STUDS - AC COMPRESSOR SEER OF 15 OR GREATER
HOT WATER SYSTEM:	GAS DOMESTIC HOT WATER SYSTEM - INSTANTANEOUS GAS DHW SYSTEM EF OF .95 OR HIGHER
ERV SYSTEM:	PROVIDE ENERGY RECOVERY SYSTEM (ERV) BY PANASONIC FV04VE1, VENMAR OR EQUIVALENT CAPABLE OF MEETING VENTILATION CODE 50-80 CFM THAT MEETS THE 2012 IECC STANDARDS FOR EFFICACY
PASSIVE RADON SYSTEM:	PROVIDE A RADON RESISTANT CONSTRUCTION TECHNIQUES INCLUDING A PASSIVE SYSTEM WHICH FROM THE PERFORATED PIPE UNDER THE SLAB, UP THROUGH SLAB, AND HOUSE, TERMINATING ABOVE THE ROOF WITH AN ELECTRICAL OUTLET IN THE ATTIC FOR INSTALLING A FAN, MAKING IT AN ACTIVE SYSTEM, IF THERE IS A HIGH READING MEASURED. ASTM E1465 PRACTICE FOR RADON CONTROL OPTIONS
TO BE SOLAR PV READY:	INSTALL CONDUIT FROM ROOF TO AREA IN BASEMENT IN BASEMENT ROOM FOR A SOLAR METER, AN INVERTER AND A SWITCH BOX ON EXTERIOR OF BASEMENT ROOM FOLLOWING THE LOCAL ELECTRIC COMPANY GUIDELINES, AN ACCESSIBLE SAFETY OFF SWITCH BOX
PLUMBING:	WATER SENSE (EPA) FOR ALL INTERIOR PLUMBING DEVICES; - SHOWERHEAD - TOILET - LAVATORY FAUCET
APPLIANCES:	USE ENERGY STAR APPLIANCES USE NATURAL GAS RANGE AND EXHAUST RANGE TO EXTERIOR

ELECTRICAL SYMBOLS CEILING MOUNTED LIGHT FIXTURE. WALL MOUNTED LIGHT FIXTURE. 2'X2' OR 2'X4' FLUORESCENT LIGHT FIXTURE. 1'x4' FLUORESCENT WALL/CEILING MOUNTED LIGHT FIXTURE. SINGLE POLE LIGHT SWITCH THREE-WAY LIGHT SWITCHES DIMMER SWITCH MINIMUM 1000W OR AS REQUIRED PER CIRCUIT DUPLEX RECEPTACLE, 120V,18" AFF. DUPLEX RECEPTACLE WITH GROUND FAULT INTERRUPTER 8" ABOVE COUNTER TO CENTERLINE DUPLEX RECEPTACLE, 120V,18" AFF., ONE OUTLET SWITCHED 120V DOUBLE DUPLEX CONVENIENCE RECEPTACLE DUPLEX RECEPTACLE ABOVE COUNTER, 8" ABOVE COUNTER TO CENTERLINE TELEPHONE JACK COMPLETE W/JACK AND COVER, WALL MOUNTED @ 4'-0" A.F.F) SYSTEM TYPE SMOKE DETECTOR - DBEC DUCT SMOKE DETECTOR W/REMOTE TEST SWITCH - DBEC **HEAT DETECTOR - DBEC** FIRE ALARM AUDIO/VISUAL UNIT. MTD. @ 6'-8" AFF -DBEC FIRE ALARM MINI HORN - DBEC JUNCTION BOX - DBEC LIGHTING & POWER PANEL, RECESSED - DBEC FIRE ALARM CONTROL PANEL - DBEC FIRE ALARM ANNUNCIATOR - DBEC CABLE *NOTE: D.B.E.C. = DESIGN AND INSTALLED BY ELECTRICAL CONTRACTOR

21 MAGNOLIA STREET BOSTON, MA

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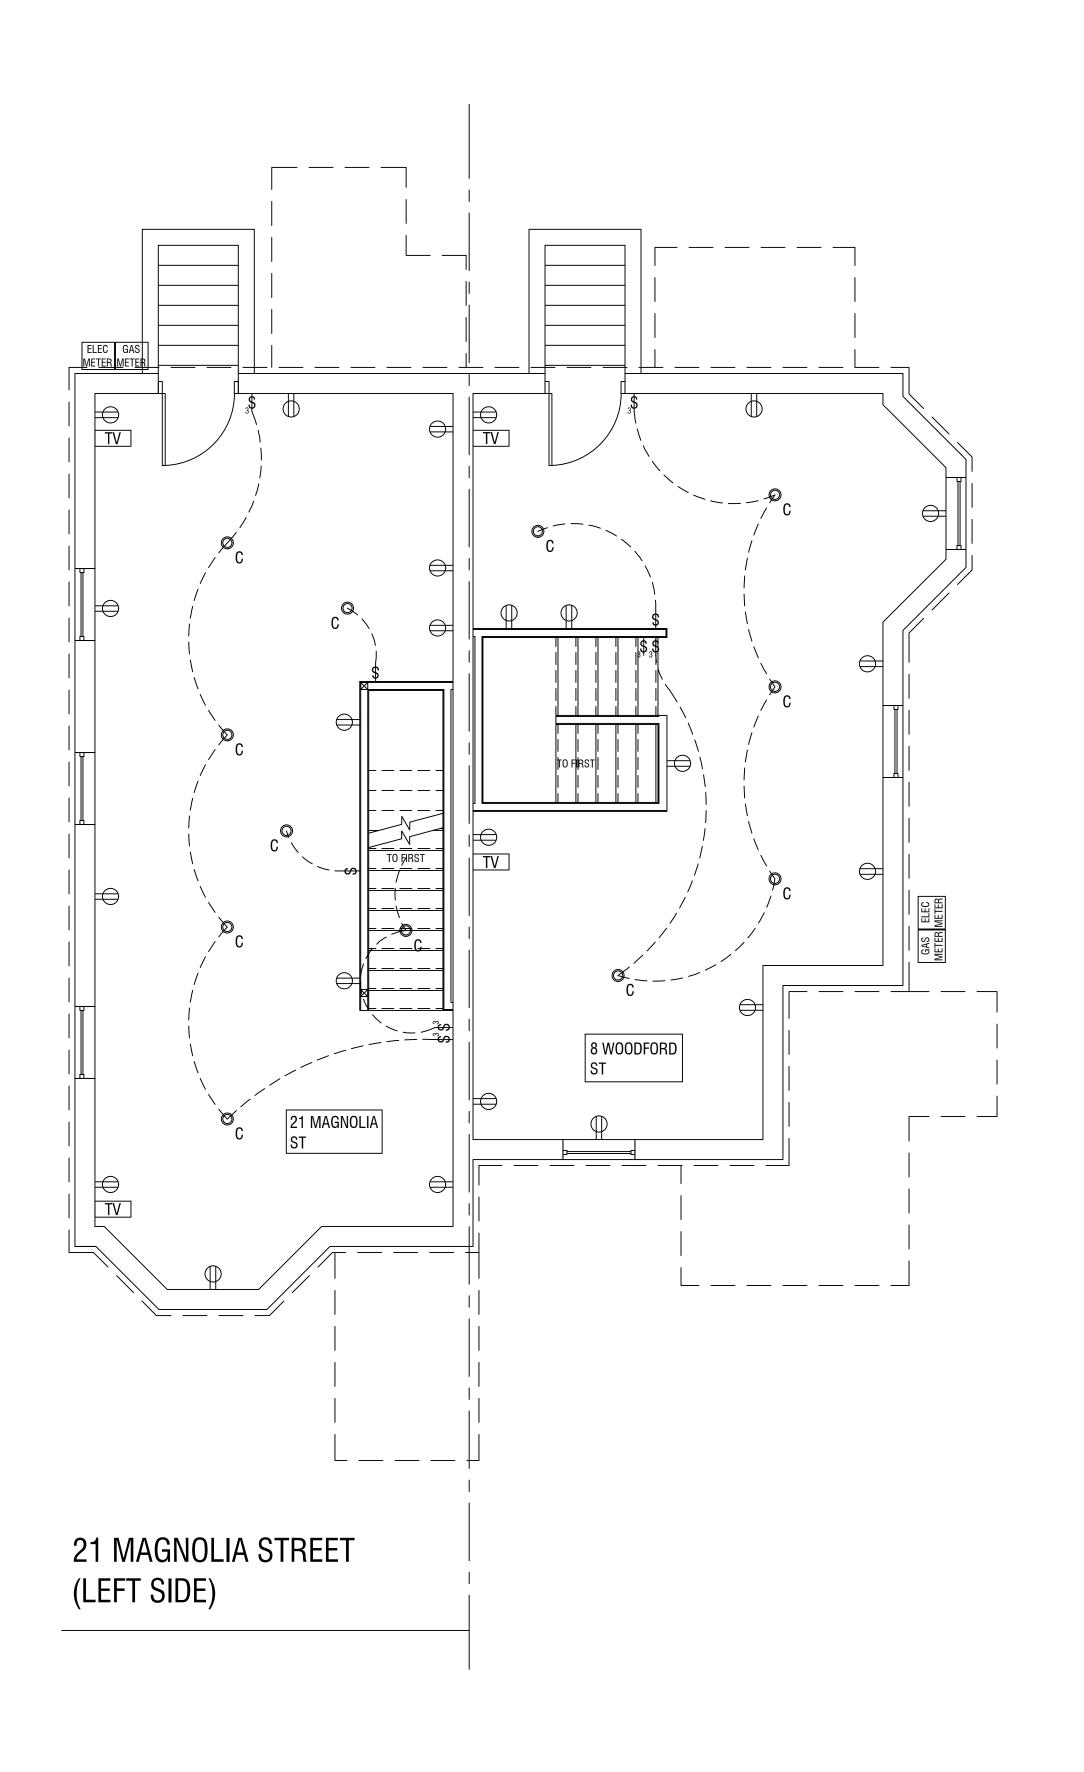
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DND - TYPE E SINGLE FAMILY

GENERAL NOTES -ELECTRICAL

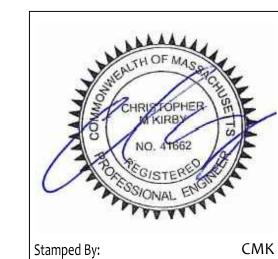1/4" = 1'-0"





UNIT TYPE E

BASEMENT ELECTRICAL PLAN

O'

SCALE: 1/4" = 1'-0"

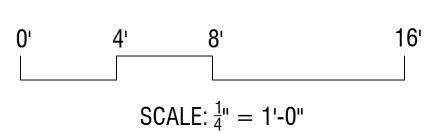

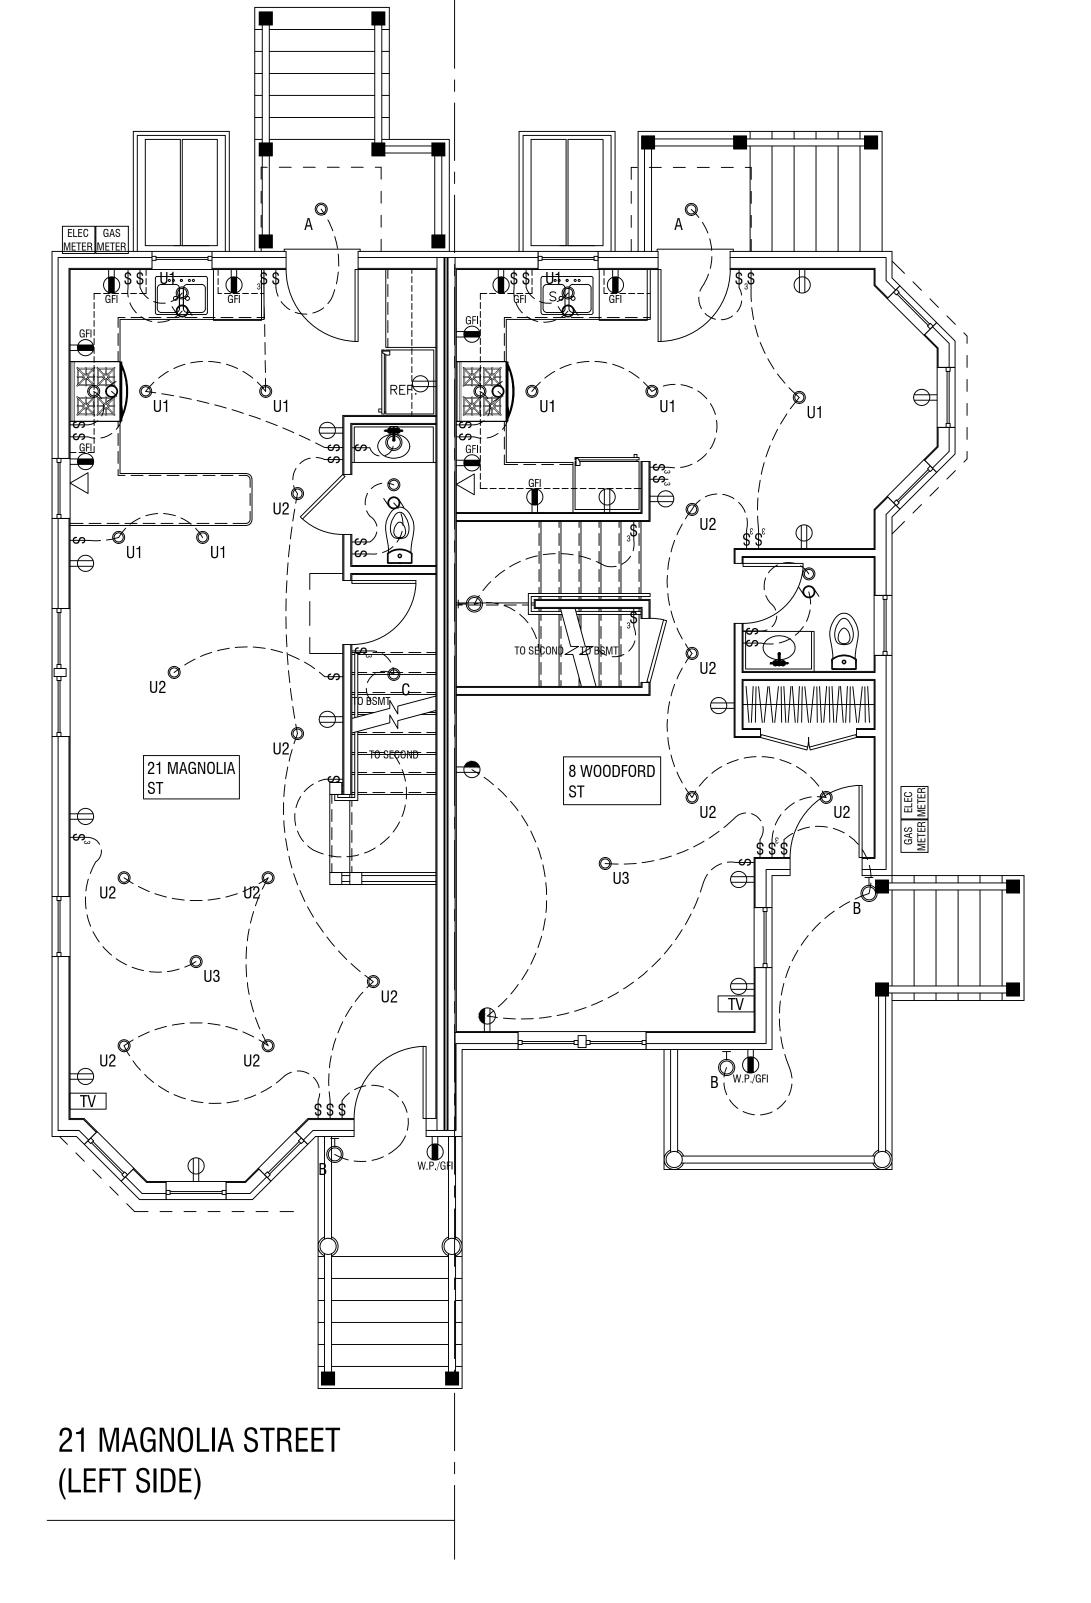

UNIT TYPE E FIRST FLOOR ELECTRICAL PLAN


SCALE: 1/4" = 1'-0"

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MA PE LICENSE No. 41662
EXPIRES 6/30/2020



DND - TYPE E SINGLE FAMILY


BASEMENT & FIRST FLOOR ELECTRICAL PLANS

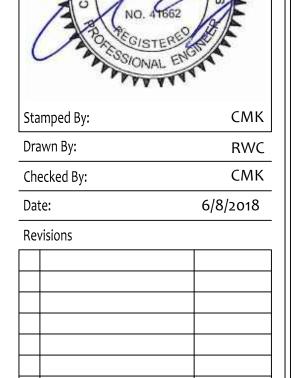
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Sheet No. E-1.1

Scale: 1/4" = 1'-0"



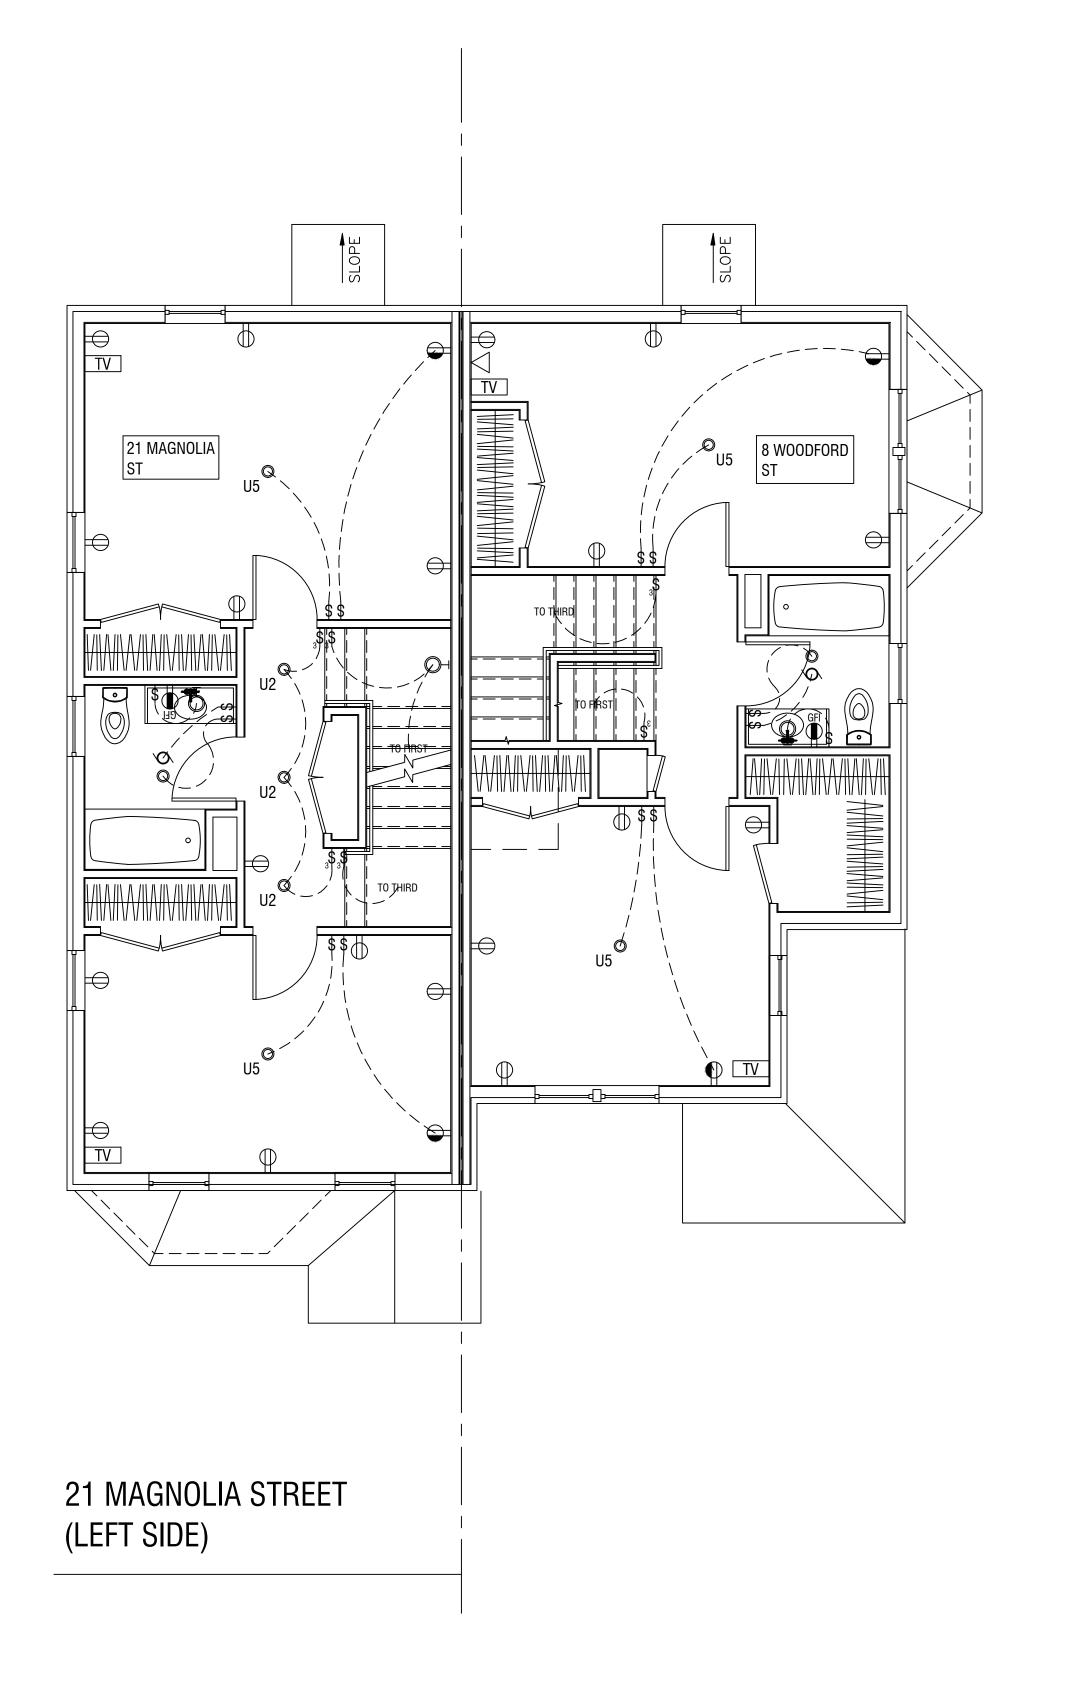

UNIT TYPE E
SECOND FLOOR ELECTRICAL PLAN

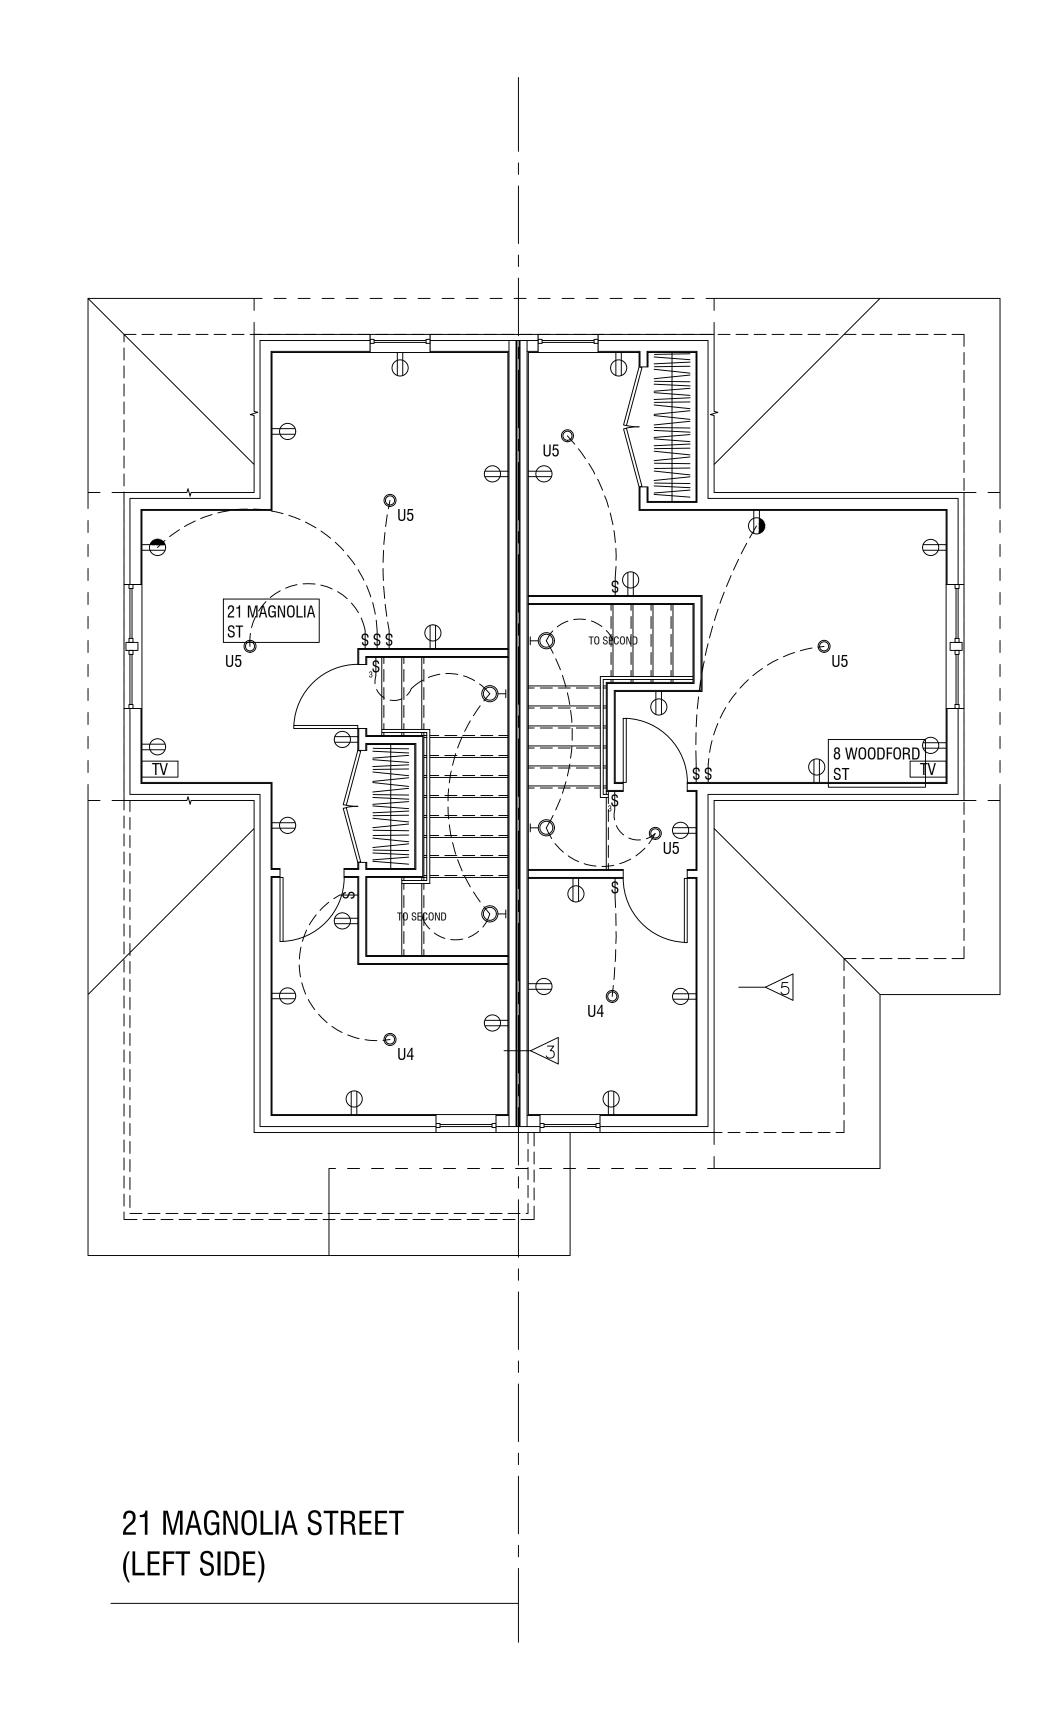SCALE: 1/4" = 1'-0"

0' 4' 8' 16'

SCALE: $\frac{1}{4}$ " = 1'-0"

UNIT TYPE E THIRD FLOOR ELECTRICAL PLAN

SCALE: 1/4" = 1'-0"

21 MAGNOLIA STREET BOSTON, MA

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CMK

Drawn By:

Checked By:

CMK

Date:

6/8/2018

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6/8/2018

DND - TYPE E SINGLE FAMILY

SECOND & THIRD FLOOR ELECTRIC PLANS

Sheet No. E-1.2

Scale: 1/4'' = 1'-0''

GENERAL NOTES

COUST.	ACOUSTICAL	E.	EAST	I.D.	INSIDE DIAMETER	R.	RISER
		EA.	EACH	INCL.	INCLUDED, INCLUDING	RAD.	RADIUS
D.	AREA DRAIN	E.B.	EXPANSION BOLT	INSUL.	INSULATION	RBR.	RUBBER
J.	ADJUSTABLE	E.J.	EXPANSION JOINT	INT.	INTERIOR	R.D.	ROOF DRAIN
F.F.	ABOVE FINISH FLOOR	EL.	ELEVATION			RECD.	RECESSED
GGR.	AGGREGATE	ELEC.	ELECTRICAL	JAN.	JANITOR	REF.	REFERENCE
LUM	ALUMINUM	ELEV.	ELEVATOR	JT.	JOINT	REFR.	REFRIGERATOR
PPROX.	APPROXIMATE	EMER.	EMERGENCY	•		REINF.	REINFORCED
RCH.	ARCHITECTURAL	ENCL.	ENCLOSURE	KIT.	KITCHEN	REQ.	REQUIRED
11011.	ALTOHITEGICINE	E.P.	ELECTRICAL PANELBOARD	IXII.	INTOTIEN	RESIL.	RESILIENT
SPH.	ASPHALT	EQ.	EQUAL	LAB.	LABORATORY	RM.	ROOM
TTD.	ATTACHED	EQPT.	EQUIPMENT	LAM.	LAMINATE	R.O.	ROUGH OPENING
IID.	ATTACILLO	E.W.C.	ELECTRIC WATER COOLER	LAV.	LAVATORY	n.o.	MODULI OF LINING
		EXST.	EXISTING	L.C.C.	LEAD-COATED COPPER	S.	SOUTH, SINK
D.	BOARD	EXPO.	EXPOSED	LCKR.	LOCKER	S.C.	SOLID CORE
F.	BI-FOLD						
ITUM.	BITUMINOUS	EXP.	EXPANSION	LT.	LIGHT	SCHED.	SCHEDULE
LDG.	BUILDING	EXT.	EXTERIOR	LTL.	LINTEL	SCR.	SCREEN
LK.	BLOCK	Ε Δ	FIDE ALADM	LVR.	LOUVER	SECT.	SECTION
LKG.	BLOCKING	F.A.	FIRE ALARM	L.W.C.	LIGHT WEIGHT CONCRETE	SEP.	SEPARATE
M.	BEAM	F.B.	FLAT BAR, FACE BRICK		AAA OLUME	SH.	SHELF
от.	BOTTOM	F.D.	FLOOR DRAIN	MACH.	MACHINE	SHT.	SHEET
SMT.	BASEMENT	FDN.	FOUNDATION	MATL.	MATERIAL	SHTG.	SHEATHING
J.VIII	J. (JEMEN)	F.E.	FIRE EXTINGUISHER	MAX.	MAXIMUM	SHWR.	SHOWER
		F.E.C.	FIRE EXTINGUISHER CABINET	M.B.	MACHINE BOLT	SIM.	SIMILAR
AB.	CABINET	F.H.C.	FIRE HOSE CABINET	MBR.	MEMBER, MEMBRANE	SPEC.	SPECIFICATION
.B.	CATCH BASIN	FIN.	FINISH, FINISHED	M.C.	MEDICINE CABINET	SQ.	SQUARE
		FL.	FL00R	MECH.	MECHANICAL	S.S.	STAINLESS STEEL
EM.	CEMENT	FLASH.	FLASHING	MEMB.	MEMBRANE	STA.	STATION
ER.	CERAMIC	FLUOR.	FLUORESCENT	MFR.	MANUFACTURER	STD.	STANDARD
.l.	CAST IRON	F.O.C.	FACE OF CONCRETE	MH.	MANHOLE	ST.	STEEL
.I.P.	CAST IN PLACE	F.O.F.	FACE OF FINISH	MIN.	MINIMUM	STOR.	STORAGE
.I.P.C.	CAST IN PLACE CONCRETE	F.O.S.	FACE OF STUDS	MIR.	MIRROR	STRL.	STRUCTURAL
.G.	CORNER GUARD	FPRF.	FIREPROOF	MISC.	MISCELLANEOUS	SUSP.	SUSPENDED
.J.	CONTROL JOINT	F.R.	FIRE RATED	MLDG.	MOULDING	SV RNG	SELF-VENTING RANGE HOO
LG.	CEILING	F.S.	FULL SIZE	MLWK.	MILLWORK	SYM.	SYMMETRICAL
LKG.	CAULKING	FT.	FOOT OR FEET	MOD.	MODULAR	SYS.	SYSTEM
LO.	CLOSET	FTG.	FOOTING	M.O.	MASONRY OPENING		
LR.	CLEAR	FURR.	FURRING	MTD.	MOUNTED		
.0.	CONCRETE OPENING	FUT.	FUTURE	MTL.	METAL	T. or TRD.	TREAD
0L.	COLUMN	101.	TOTOTIE	MUL.	MULLION	T.B.	TOWEL BAR
ONC.	CONCRETE	GA.	GAUGE			T.C.	TOP OF CURB
ONN.	CONNECTION	GALV.	GALVANIZED			TEL.	TELEPHONE
ONSTR.	CONSTRUCTION	G.B.	GRAB BAR	N.	NORTH	T. & G.	TONGUE and GROOVE
ONT.	CONTINUOUS	GL.	GLASS	N.I.C.	NOT IN CONTRACT	THK.	THICK
ORR.		GL. GND.	GROUND	NO. or #	NUMBER.		
	COUNTERCHNIK			NOM.	NOMINAL	THLD.	THRESHOLD
TSK.	COUNTERSUNK	GR.	GRADE	N.T.S.	NOT TO SCALE	TP.	TEMPERED
NTR.	COUNTER	GWB.	GYPSUM WALL BOARD			T.\/	TELEVIOLON
.T.	CERAMIC TILE	GYP.	GYPSUM	0.A.	OVERALL	T.V.	TELEVISION
TR.	CENTER			OBS.	OBSCURE	T.W.	TOP OF WALL
		H.B.	HOSE BIBB	0.C.	ON CENTER	TYP.	TYPICAL
BL.	DOUBLE	H.C.	HOLLOW CORE, HANDICAPPED	0.D.	OUTSIDE DIAMETER		
EM.	DEMOLITION	HDWD.	HARDWOOD	OFF.	OFFICE		
EPT.	DEPARTMENT	HDWE.	HARDWARE	OPNG.	OPENING	U.L.	UNDERWRITER'S LABORAT
.F.	DRINKING FOUNTAIN	H.M.	HOLLOW METAL	OPP.	OPPOSITE	UNF.	UNFINISHED
ET.	DETAIL	HORIZ.	HORIZONTAL			U.O.N.	UNLESS OTHERWISE NOTE
IA.	DIAMETER	HR.	HOUR	P.C.C.	PRECAST CONCRETE		
IM.	DIMENSION	HGT.	HEIGHT	PERF.	PERFORATED	V.B.	VAPOR BARRIER, VINYL BA
SP.	DISPENSER	HTR.	HEATER	PERIM.	PERIMETER	VCT	VINYL COMPOSITION TILE
٧.	DOWN	HVAC	HEATING, VENTILATING,	PKG.	PARKING	VEN.	VENEER
0.	DOOR OPENING		& AIR CONDITIONING	PRCST.	PRECAST	VERT.	VERTICAL
₹.	D00R	H.W.	HOT WATER	PL.	PLATE	VEST.	VESTIBULE
WR.	DRAWER			P.LAM.	PLASTIC LAMINATE	V.I.F.	VERIFY IN FIELD
S.	DOWNSPOUT			PLAS.	PLASTER	VIN.	VINYL
S.P.	DRY STANDPIPE			PLYWD.	PLYW00D		
N	DISHWASHER			PNL.	PANEL	W.	WEST
NG.	DRAWING			POL.	POLISHED	W/	WITH
u.	Districted			PR.	PAIR	W.C.	WATER CLOSET
				PK. PT.			
					POINT	WD.	WOOD
				PTD.	PAINTED	W.H.	WALL HUNG
				PTN.	PARTITION	WIN.	WINDOW
						W/0	WITHOUT
						WP.	WATERPROOF
				Q.T.	QUARRY TILE	W.R.	WATER RESISTENT
				QTR.	QUARTER	WSCT.	WAINSCOT
						WT.	WEIGHT

LEGEND:

EXTERIOR ELEVATION MARK -DRAWING NUMBER **BUILDING SECTION MARK** FLOOR TRANSITIONS - DETAIL NUMBER - STRIP (SEE SHEET XX) -SHEET NUMBER **WALL SECTION MARK DETAIL REFERENCE** -DETAIL NUMBER -SHEET NUMBER REFERENCE AREA **DETAIL KEY** - DETAIL NUMBER **PARTITION MARK** -SHEET NUMBER - PARTITION TYPE INTERIOR ELEVATION MARK WINDOW MARK 1 ★ SHEET NUMBER X → WINDOW TYPE - DETAIL NUMBER DOOR MARK -DOOR STYLE/SIZE **ELEVATION MARK** REFERENCE POINT

MECHANICAL SYSTEMS:

- 4 HEADS.

.95 OR HIGHER

READING MEASURED.

- SHOWERHEAD

- LAVATORY FAUCET

USE ENERGY STAR APPLIANCES

- TOILET

- COMPRESSOR SIZED

- HSPF OF 12 OR GREATER

- SEER OF 20 OR GREATER

- COMPRESSOR SIZED

HEATING/COOLING SYSTEM:

HOT WATER SYSTEM:

PASSIVE RADON SYSTEM:

TO BE SOLAR PV READY:

PLUMBING:

APPLIANCES:

ERV SYSTEM:

- NO DUCTS SHALL BE INSTALLED

2. DUCTED FORCED HOT AIR SYSTEM w/ AC SYSTEM

PROVIDE ENERGY RECOVERY SYSTEM (ERV) BY

PANASONIC FV04VE1. VENMAR OR EQUIVALENT

ASTM E1465 PRACTICE FOR RADON CONTROL OPTIONS

INSTALL CONDUIT FROM ROOF TO AREA IN BASEMENT

GUIDELINES, AN ACCESSIBLE SAFETY OFF SWITCH BOX

WATER SENSE (EPA) FOR ALL INTERIOR PLUMBING DEVICES;

USE NATURAL GAS RANGE AND EXHAUST RANGE TO EXTERIOR

2012 IECC STANDARDS FOR EFFICACY

- FURNACE TO BE NATURAL GAS, 95% EFFICIENT

- AC COMPRESSOR SEER OF 15 OR GREATER

- NO DUCTS OR SOFFITS SHALL BE EXPOSED. DUCT WORK SHALL BE

GAS DOMESTIC HOT WATER SYSTEM - INSTANTANEOUS GAS DHW SYSTEM EF OF

PROVIDE A RADON RESISTANT CONSTRUCTION TECHNIQUES INCLUDING A PASSIVE

ATTIC FOR INSTALLING A FAN, MAKING IT AN ACTIVE SYSTEM, IF THERE IS A HIGH

IN BASEMENT ROOM FOR A SOLAR METER, AN INVERTER AND A SWITCH BOX

ON EXTERIOR OF BASEMENT ROOM FOLLOWING THE LOCAL ELECTRIC COMPANY

SYSTEM WHICH FROM THE PERFORATED PIPE UNDER THE SLAB, UP THROUGH SLAB, AND HOUSE, TERMINATING ABOVE THE ROOF WITH AN ELECTRICAL OUTLET IN THE

CAPABLE OF MEETING VENTILATION CODE 50-80 CFM THAT MEETS THE

INSTALLED IN FLOOR BAYS BETWEEN JOIST OR IN WALLS BETWEEN STUDS

1. FAJITSU, MITSHUBISHI, OR EQUAL MINI SPLIT HEAT PUMP SYSTEM

GENERAL NOTES:

- 1. ALL MATERIALS, WORKMANSHIP AND DETAILS SHALL CONFORM WITH COMMONWEALTH OF MASSACHUSETTS BUILDING CODE-9TH EDITION.
- 2. THE CONTRACTOR SHALL FAMILIARIZE THEMSELVES WITH THE CONTRACT DOCUMENTS AND DISCREPANCIES SHALL BE BROUGHT TO THE ATTENTION OF THE ARCHITECT PRIOR TO PROCEEDING WITH THE AFFECTED WORK. THE PROJECT MANUAL SETS OUT THE HIERARCHY OF THE DRAWINGS AND SPECIFICATIONS. ANY VARIATION OR SUBSTITUTION OF MATERIALS OR DETAILS FROM THOSE SHOWN ON THE DRAWINGS MAY BE MADE ONLY WITH THE PRIOR APPROVAL OF THE ARCHITECT
- 3. THE CONTRACTOR SHALL VERIFY ALL SITE CONDITIONS, CHECK ALL DIMENSIONS PRIOR TO CONSTRUCTION AND NOTIFY THE ARCHITECT OF ANY CONDITIONS REQUIRING MODIFICATIONS TO THE DRAWINGS.
- 4. ABBREVIATIONS USED ON THE DRAWINGS ARE SELF-EVIDENT OR AS ACCEPTED IN THE INDUSTRY AND SUCH AS THE INTERPRETATION OF THE ARCHITECT. THE CONTRACTORS REQUEST FOR INTERPRETATION SHALL BE ADDRESSED TO THE ARCHITECT.
- 5. ALL DOCUMENTS INCLUDING THE PROJECT MANUAL(IF ANY) AND REFERENCED STANDARDS ARE INTENDED TO BE COMPLEMENTARY. IT IS INTENDED THAT ALL TRADES SHALL FAMILIARIZE THEMSELVES WITH THE ENTIRE SET OF DOCUMENTS AS IT IS RELATED TO THEIR TRADE.
- 6. INTERIOR DIMENSIONS ARE TAKEN FROM THE EXTERIOR FACE OF STUD OR MASONRY TO CENTERLINE OF INTERIOR PARTITIONS UNLESS OTHER WISE NOTED. CLEAR DIMENSIONS "CLR." FROM FACE OF FINISH TO FACE OF FINISH. MINIMUM CLEAR "MIN CLR." IS A MINIMUM DIMENSION THAT MUST BE
- 7. THERE SHALL BE NO EXPOSED ELECTRICAL DISTRIBUTION IN ALL HABITABLE
- 8. THE CONTRACTOR SHALL BE RESPONSIBLE FOR PROVIDING ALL BLOCKING, FRAMING AND FIRE STOPPING AS REQUIRED BY THE DOCUMENTS AND THE
- 10. ALL RISERS FOR DUCTS AND PIPES, SHALL BE BOXED IN WITH GYPSUM WALLBOARD TO PROVIDE TWO HOUR FIRE RATING. WHERE POSSIBLE, LOCATE RISER IN A CORNER OR WHERE SHOWN IN A CLOSET OR LINEN CLOSET. LOCATE AT END OF CLOSET TO PROVIDE MAXIMUM CLEAR SPACE, NOTIFY
- 11. CONSTRUCTION TO COMPLY WITH REQUIREMENTS OF ENERGY STAR. COMPLY WITH THE REQUIREMENTS CONTAINED IN THE FOLLOWING DOCUMENTS: ENERGY STAR HOMES TECHNICAL STANDARDS VERSION 3 FIELD
- 12.1. BASIC AIR SEALING: MAXIMUM ALLOWABLE AIR LEAKAGE IS 2 SQUARE
- 12.2. ALL RECESSED LIGHTS MUST BE AIRTIGHT. ANY RECESSED LIGHTS THAT PENETRATE THE SHELL OF THE BUILDING MUST BE INSULATION CONTACT (IC)
- CAREFULLY SEALED. TYPICAL PENETRATIONS INCLUDE CHIMNEY, DUCT AND PLUMBING CHASES AND PENETRATIONS OF PIPES AND WIRES THROUGH THE TOP PLATES OF TOP STORY WALLS. IT IS PARTICULARLY IMPORTANT TO SEAL ANY POSSIBLE AIR PATHS TO THE ATTIC AS THESE BY-PASSES ARE NOT ONLY SOURCE OF ENERGY LOSS BUT ALSO PROVIDE PATHS FOR MOISTURE TO MIGRATE INTO THE ATTIC.
- PLUMBING AND ELECTRICAL). PROPER INSTALLATION IS CRITICAL TO ENSURE
- 12.10. TO EFFECTIVELY REDUCE AIR LEAKAGE, BUILDING AREAS SUCH AS KNEEWALL-FLOOR TRANSITIONS, DROPPED SOFFITS, AND CANTILEVERS MUST BE IDENTIFIED AND SEALED CAREFULLY WITH CONTINUOUS AIR BARRIER. WHERE JOIST SPANS OR STUD BAYS RUN BETWEEN A HEATED AREA AND UNHEATED AREA, ALL BAYS MUST BE BLOCKED AND SEALED AT THE TRANSITION.

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MALLE STATE

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DND PROJECT

SYMBOLS, SYSTEMS, ABBREVIATIONS AND GENERAL NOTES

AS SHOWN Scale:

AREAS U.O.N.

BUILDING CODE.

ARCHITECT OF ALL CONFLICTS.

GUIDE TO RESIDENTIAL NEW CONSTRUCTION. AUGUST 2000

INCHES LEAKAGE PER 100 SQUARE FEET OF BUILDING SHELL AREA.

- RATED AND AIRTIGHT.
- 12.3. WINDOWS FRAMES AND DOOR JAMBS MUST BE SEALED TO THEIR ROUGH OPENINGS USING LOW EXPANSION FOAM, BACKER ROD, OR CAULK, DO NOT USE FIBERGLASS FOR THIS PURPOSE. IT IS NOT AN EFFECTIVE AIR BARRIER.
- 12.4. ALL PENETRATIONS THROUGH THE INSULATED ENVELOPE MUST BE
- 12.5. BATTS MUST BE INSTALLED AT FULL LOFT WITHOUT GAPS OR EMPTY POCKETS.
- 12.6. BATTS MUST BE CUT TO ACCOMMODATE ALL OBSTRUCTIONS (I.E. ITS RATED PERFORMANCE.
- 12.7. THE INSULATION MUST BE COMPLETELY FILL THE STUD CAVITIES.
- 12.8. ATTIC AND CRAWL SPACE ACCESS HATCHES MUST BE COVERED WITH A MINIMUM OF R-60 INSULATION, PERMANENTLY ATTACHED TO THE HATCH.
- 12.9. A VAPOR RETARDER IS REQUIRED ON THE WINTER WARM SIDE OF THE INSULATION.
- 12.11. ATTIC AND CRAWL SPACE ACCESS DOORS OR HATCHES MUST BE WEATHER-STRIPPED.

GENERAL CONSTRUCTION NOTES

- 1. ALL DIMENSIONS ARE CALCULATED FROM OUTSIDE FACE OF EXTERIOR WALLS TO THE CENTERLINE OF INTERIOR STUD WALLS UNLESS OTHERWISE NOTED. STUD WALLS NOT DIMENSIONED ARE TYPICALLY 2x6 (5 1/2") FOR BOTH INTERIOR AND EXTERIOR WALLS.
- 2. THE PROJECT IS A NEW STRUCTURE. EXACT DIMENSIONS, ELEVATIONS, TIE-IN POINTS, ROOF SLOPES, BEARING POINT LOCATIONS ARE REPRESENTED AS ACCURATE AS KNOWN AT THE TIME OF THE DRAWING SET CREATION. FIELD VERIFICATION OF ALL ELEMENTS IS REQUIRED BY THE CONTRACTOR AND IF INCONSISTENCIES OCCUR. NOTIFY THE ENGINEER FOR DIRECTION. THE ENGINEER IS NOT RESPONSIBLE FOR CHANGES TO THE PLANS WITHOUT DIRECTION.
- 3. WINDOWS APPEARING ON THE FLOOR PLANS AND EXTERIOR ELEVATIONS ARE TO BE CONFIRMED BY THE OWNER
- 4. THE WINDOW FINAL SILL HEIGHT AT THE FIRST FLOOR IS 24" ABOVE FINISH FLOOR UNLESS NOTED OTHERWISE.
- 5. GENERAL CONTRACTOR TO REVIEW ALL BUILT IN REQUIREMENTS WITH THE OWNER INCLUDING SHELVING, CLOSETS, PANTRY, ETC., IF APPLICABLE.
- 6. ALL REQUIREMENTS FOR SECURITY SYSTEMS, CENTRAL VACUUM, AND ANY AUDIO, COMPUTER OR CABLE TELEVISION SYSTEMS TO BE COORDINATED WITH OWNER.
- 7. ALL PERMITS AND VARIANCES, IF NECESSARY, ARE THE RESPONSIBILITY OF THE OWNER AND GENERAL CONTRACTOR PRIOR TO START OF
- 8. ALL FINISH COLORS TO BE THE RESPONSIBILITY OF THE OWNER.

GENERAL FLOOR PLAN NOTES

- 1. DO NOT SCALE DRAWINGS. FOLLOW DRAWING DIMENSIONS ONLY. DIMENSION IS NOT CALLED OUT, VERIFY DIMENSIONS WITH ENGINEER.
- 2. ALL DIMENSIONS ARE CALCULATED FROM OUTSIDE FACE OF EXTERIOR WALLS TO THE CENTERLINE OF INTERIOR STUD WALLS (UNO). STUD WALLS NOT DIMENSIONED ARE TYPICALLY 2x6 FOR EXTERIOR WALLS AND 2x4 FOR INTERIOR WALLS (UNO).
- 3. ALL INTERIOR WALLS ARE TO BE COVERED WITH 1/2" GYPSUM BOARD METAL CORNER REINFORCING, TAPE SEAMS AND PLASTER SKIMCOAT.
- 4. ALL WALLS IN THE GARAGE TO HAVE A LAYRER OF 5/8". TYPE "X" FIRE RATED GYPSUM BOARD (UNO).
- 5. ALL BATH AND TOILET AREA WALLS AND CEILINGS ADJACENT TO WET AREAS TO HAVE WATER RESISTANT GYPSUM BOARD
- 6. BEDROOM WINDOWS TO HAVE A MINIMUM NET CLEAR OPENING OF 3.38 SQFT., A MINIMUM NET CLEAR OPENING OF 20" WIDE x 24" HIGH IN EITHER DIRECTION. AND HAVE A MAXIMUM FINISHED SILL HEIGHT OF 44" FROM FINISHED FLOOR.
- 7. ALL GLASS LOCATED WITHIN 18" OF FLOOR OR 24" OF A DOOR SWING MUST BE TEMPERED GLASS.
- 8. BATHROOMS AND UTILITY ROOMS TO BE VENTED TO THE OUTSIDE WITH A MINIMUM OF 50 CFM FAN. RANGE HOODS TO BE VENTED TO THE OUTSIDE.
- 9. SUBCONTRACTOR TO FIFLD VERIFY ALL CABINET DIMENSIONS BEFORE FABRICATION.

GENERAL ELEVATION NOTES

- 1. ICE & WATER SHIELD TO BE INSTALLED CORRECTLY AT ALL CONNECTIONS BETWEEN ROOFS, WALLS, CHIMNEYS, PROJECTIONS, AND PENETRATIONS AND UNDER FIRST 36" OF PERIMETER OF ROOF.
- 2. ICE & WATER SHIELD TO BE PLACE OVER ENTIRE ROOF SURFACE WHEN ROOF SLOPE IS BELOW A 4/12 PITCH.
- 3. ADEQUATE ATTIC VENTILATION AND ROOF VENTS ARE TO BE PROVIDED AS SHOWN ON PLANS.
- 4. ALL PLUMBING AND MECHANICAL VENTS TO BE LOCATED CLOSE TOGETHER WITHIN THE ATTIC SPACE WHEN POSSIBLE TO MINIMIZE THE NUMBER OF ROOF PENETRATIONS. ALL PLUMBING AND MECHANICAL VENTS WHICH APPEAR ABOVE THE ROOF TO BE LOCATED AWAY FROM ANY PROMINENT VIEW. NO VENT TO BE ALLOWED ON THE FRONT ROOF. ALL METAL AND PVC VENTS AND PENETRATIONS TO BE PRIMED AND PAINTED TO CLOSELY MATCH ROOF COLOR.
- 5. GUTTERS AND DOWN SPOUTS ARE NOT LOCATED ON ELEVATION DRAWINGS. LOCATIONS OF DOWN SPOUTS ARE TO BE DETERMINED ON-SITE DUE TO TOPOGRAPHICAL CONDITIONS TO ALLOW POSITIVE DRAINAGE AWAY FROM THE HOUSE. DOWN SPOUTS NOT TO BE LOCATED IN PROMINENT LOCATIONS, GUTTERS AND DOWN SPOUTS ARE TO CLOSELY MATCH TRIM COLOR OF THE HOUSE.
- 6. ALL FLASHING TO BE OF THE SAME MATERIAL. DISSIMILAR METALS NOT ALLOWED.
- 7. OWNER RESPONSIBLE FOR SELECTING ROOF COLOR.

GENERAL STAIRWAY NOTES

- 1. STAIRWAYS SHALL NOT BE LESS THAN 36" IN CLEAR WIDTH AT ALL POINTS ABOVE THE PERMITTED HANDRAIL HEIGHT AND THE PERMITTED HEADROOM HEIGHT. THE MINIMUM WIDTH AT OR BELOW THE HANDRAIL HEIGHT SHALL NOT BE LESS THAN 32" WHERE A HANDRAIL IS INSTALLED ON ONE SIDE AND 28" WHERE HANDRAILS ARE PROVIDED ON BOTH SIDES.
- 2. THE MINIMUM HEADROOM IN ALL PARTS OF THE STAIRWAY SHALL NOT BE LESS THAN 6'-8" MEASURED VERTICALLY FROM THE SLOPED PLANE ADJOINING THE TREAD NOSING OR THE NOSING FROM THE FLOOR SURFACE OF THE LANDING OR PLATFORM.
- 3. THE MAXIMUM RISER HEIGHT SHALL BE 8 1/4" AND THE MINIMUM TREAD DEPTH SHALL BE 9". TREAD NOSING SHALL NOT EXTEND MORE THAN 1 1/2" BEYOND THE FACE OF THE RISER BELOW.
- 4. OPEN SIDES OF STAIRS WITH A TOTAL RISE OF MORE THAN 30" ABOVE THE FLOOR/GRADE SHALL HAVE GUARDRAILS, WHICH SHALL ALSO SERVE AS HANDRAILS, NOT LESS THAN 36" IN HEIGHT.
- 5. REQUIRED GUARDRAILS ON OPEN SIDES OF STAIRWAYS, BALCONIES, PORCHES, DECKS AND RAISED FLOOR AREAS, SHALL HAVE BALUSTERS WHICH PREVENT THE PASSAGE OF AN OBJECT 4" OR MORE IN DIAMETER.

GENERAL FOUNDATION NOTES

- 1. ALL CONCRETE WORK SHALL CONFORM WITH THE LATEST
- REQUIREMENTS OF THE AMERICAN CONCRETE INSTITUTE (ACI) 2. THE MINIMUM COMPRESSIVE STRENGTH OF CONCRETE AT THE END OF
- 28 DAYS SHALL BE 4000 PSI. 3. ALL SLABS TO BE PLACED ON A 6 MIL VAPOR BARRIER OVER 6" OF
- COMPACTED GRAVEL. 4. PROVIDE A 1/2" EXPANSION JOINT MATERIAL BETWEEN ALL CONCRETE SLABS ON ABUTTING CONCRETE OR MASONRY WALLS OCCURRING IN
- EXTERIOR OR UNHEATED AREAS. 5. PROVIDE DEEP SCORE CONTROL JOINTS AT MID POINTS OF ALL SLABS
- BOTH DIRECTIONS. 6. PROVIDE 1 COAT OF MASTIC ON EXTERIOR SURFACE OF FOUNDATION
- WALL BELOW GRADE. 7. FOUNDATION WALLS TO EXTEND A MINIMUM OF 36" ABOVE FINISH
- 8. PROVIDE 1" DIA ANCHOR BOLTS AS SHOWN ON THE FOUNDATION PLAN.

GENERAL FRAMING NOTES:

LIVE (PSF)	DEAD (PSF)	DEFLECTION
40	15	L / 360
30	15	L / 360
20	15	L / 240
) 10	15	L / 240
40	15	L / 240
40	15	L / 360
60	15	L / 360
	40 30 20) 10 40 40	40 15 30 15 20 15) 10 15 40 15 40 15

- 1. ALL FRAMING MATERIAL TO BE MINIMUM #2 OR BETTER KD LUMBER, 2. ALL WOOD FRAMING IN CONTACT WITH CONCRETE OR MASONRY TO BE PRESSURE TREATED (PT),
- 3. PROVIDE DOUBLE FLOOR JOISTS UNDER ALL WALLS WHICH RUN PARALLEL TO THE DIRECTION OF THE JOIST SPAN,
- 4. PROVIDE 1"x3" CROSS BRIDGING OR 2"x6" BLOCKING AT THE MIDSPAN OF ALL FLOOR JOISTS,
- 5. FLOOR CONSTRUCTION: 3/4" TONGUE AND GROOVE SUBFLOOR GLUED AND NAILED TO FLOOR FRAMING, FINISH FLOORING TO BE EITHER 3/4" HARDWOOD.
- 6. ALL STUD FRAMED WALLS TO BE FRAMED AT 16" ON CENTER.
- 7. ALL ANGLED WALLS ARE TO BE FRAMED AT 45 DEGREES (UNO),
- 8. HEADER SIZE OVER WINDOWS TO BE (3)2"x8" (UNO),
- 9. ALL HEADERS TO BE FREE FROM SPLITS AND CHECKS,
- 10. PROVIDE FULL SOLID BEARING OR STUD BEARING UNDER ALL BEAM
- BEARING POINTS, 11. ALL BEAM AND JOIST INTERSECTIONS TO BE FLUSH FRAMED WITH GALVANIZED JOIST HANGERS AND INSTALLED PER MANUFACTURERS
- RECOMMENDATIONS, 12. ALL BEAMS TO HAVE TRIPLE STUD BEARING UNDER EACH END,
- 13. UNLESS OTHERWISE NOTED, PROVIDE A 2x PLATE BOLTED TO THE TOP FLANGE OF ALL STEEL BEAMS WITH 3/8" DIAMETER GALVANIZED BOLTS STAGGERED AT 24" ON CENTER,
- 14. UNLESS OTHERWISE NOTED, PROVIDE DOUBLE HEADER JOIST AND TRIMMERS AT ALL FLOOR OPENINGS,
- 15. STAIR CONSTRUCTION TO CONSIST OF 3-2"x12" STRINGERS, MINIMUM,
- 16. TEMPORARY GUARDRAILS MUST BE INSTALLED AT ALL FLOOR OPENINGS,
- 17. ALL WALLS OVER 10'-0" HIGH TO BE 2"x6"s AT 16" ON CENTER AND RECEIVE 1 ROW OF 2"x6" BLOCKING AT MID-HEIGHT,
- 18. 2"x6" EXTERIOR WALLS TO BE SHEATHED WITH 1/2" EXTERIOR GRADE PLYWOOD. SHEATHING TO SPAN OVER ALL PLATES AND HEADERS. INSTALL SHEATHING WITH AN 1/8" GAP BETWEEN PANELS AND BLOCK ALL SEAMS - BOTH VERTICAL AND HORIZONTAL,
- 19. FLOOR FRAMING LAYOUT IS CONSTRUCTED AS TO PROVIDE BEST POSSIBLE ACCESS TO THE HVAC DUCTS AND UNOBSTRUCTED RUNS FOR THE DUCT WORK.
- 20. PROVIDE BLOCKING AT ALL CABINET LOCATIONS,
- 21. PROVIDE 2"x4" RAFTER TIES AT ALL PLATES WHERE JOIST RUN IS PERPENDICULAR TO RAFTERS.
- 22. HIP VALLEY RAFTERS AND RIDGE BOARDS TO BE ONE SIZE LARGER THAN TYPICAL RAFTERS UNLESS OTHERWISE NOTED ON PLANS.
- 23. PROVIDE 1"x6" COLLAR TIES AT UPPER 1/3 OF VERTICAL DISTANCE BETWEEN RIDGE BOARD AND CEILING JOIST AT 48" ON-CENTER,
- 24. PROVIDE INSULATION BAFFLES AT EAVE VENTS BETWEEN RAFTERS.
- 25. REQUIRED GUARDRAILS ON BALCONIES, PORCHES, DECKS, AND RAISED FLOOR AREAS, SHALL HAVE A MINIMUM HEIGHT OF 36" MEASURED VERTICALLY FROM THE FINISHED FLOOR.
- 26. ALL HARDWARE AND FLASHING IN CONTACT WITH ACQ TREATED LUMBER MUST BE HOT DIPPED GALVANIZED OR STAINLESS STEEL.
- 27. IF ON-SITE CONDITIONS DIFFER FROM THOSE SHOWN ON THE PLANS. CONTRACTOR TO NOTIFY ENGINEER IMMEDIATELY FOR DIRECTION.

GENERAL ELECTRICAL NOTES

- 1. ELECTRICAL CONTRACTOR TO BE RESPONSIBLE FOR ADHERING TO ALL CODES AND SAFETY REQUIREMENTS.
- 2. GENERAL AND ELECTRICAL CONTRACTOR TO REVIEW THE PLAN(S) AND WALK THROUGH THE JOB TO VERIFY THAT THE DESIGN INTENT IS MAINTAINED.
- 3. ELECTRICAL SERVICE TO BE PROVIDED AS REQUIRED FOR ALL APPLIANCES AND EQUIPMENT SUCH AS REFRIGERATOR, DISH WASHER, DISPOSAL, HVAC EQUIPMENT, ALARM PANEL, LAWN SPRINKLER SYSTEM, ETC. OUTLET TO BE PROVIDED ABOVE THE RANGE FOR MICROWAVE OR HOOD VENT IF FINAL KITCHEN LAYOUT REQUIRES.
- 4. ALL OUTLETS PLACED NEAR ANY WATER CONDITION TO BE G.F.C.I.
- SWITCHES AND OUTLETS TO BE COORDINATED WITH OWNER.
- PROVIDE EXTERIOR WATERPROOF OUTLETS AS REQUIRED BY CODE. ALL PHONE OUTLETS, COMPUTER OUTLETS, CABLE TV OUTLETS, AND ELECTRONIC DEVICE OUTLETS TO BE VERIFIED BY OWNER.
- 8. DIMMERS TO BE SIZED FOR THE APPROPRIATE LOAD OF THE FIXTURES AND LAMPS SELECTED.
- VERIFY TRIM SIZE FOR ALL DOORS AND WINDOWS PRIOR TO LOCATING SWITCHES. ALL LOCATIONS SHOULD BE CLOSE TO TRIM AND ALIGNED WITH ONE ANOTHER. IF THERE ARE MULTIPLE.
- 10. BLOCK AND PREWIRE SEPARATE SWITCHES TO EACH LIGHT AND CEILING.
- 11. IF EXTERIOR SECURITY LIGHTING IS DESIRED BY OWNER THE TYPE, LOCATION. AND REQUIRED SWITCHING MUST ALL BE VERIFIED BY
- 12. IF AN ALARM IS DESIRED ALL OF THE REQUIREMENTS MUST BE COORDINATED WITH THE OWNER.
- 13. PANEL BOX TO BE SIZED TO ACCOMMODATE ALL CALCULATED LOADS AND PROVIDE FOR A MINIMUM OF EIGHT (8) SPARES.
- 14. RECESSED FIXTURES LOCATED IN FIRE RATED WALLS (i.e. GARAGE CEILINGS OR FIRE SEPARATION ASSEMBLIES) SHALL BE RATED FIXTURES, FIRE RATED TO THE LEVEL OF FIRE SEPARATION OF THE WALL/CEILING IN WHICH THE FIXTURE IS INSTALLED.
- 15. PROVIDE ENERGY EFFICIENT LIGHTING AS REQUIRED PER THE 2015

GENERAL PLUMBING/HVAC NOTES

- 1. PLUMBING SUBCONTRACTOR IS RESPONSIBLE FOR ADHERING TO ALL APPLICABLE CODES AND SAFETY REQUIREMENTS.
- 2. PROVIDE GAS SERVICE TO ALL WATER HEATERS, APPLIANCES, AND HVAC EQUIPMENT, AS REQUIRED.
- 3. IF WALL PLATES OR JOISTS ARE CUT DURING INSTALLATION OF PLUMBING FIXTURES OR EQUIPMENT. PROVIDE BRACING TO TIE FRAMING BACK TOGETHER.
- 4. ALL GAS WATER HEATERS TO BE VENTED AT TOPOUT.
- 5. ALL PLUMBING AND MECHANICAL VENT STACKS TO BE LOCATED CLOSE TOGETHER IN THE ATTIC. VENT STACKS TO BE LOCATED TO THE REAR OF THE HOUSE AWAY FROM PROMINENT VIEW. ALL VENT STACKS TO BE PRIMED AND PAINTED TO CLOSELY MATCH ROOF COLOR.
- 6. HVAC CONTRACTOR TO PROPERLY SIZE HEATING AND COOLING SYSTEM FOR THE STRUCTURE.
- 7. IF A NEW KITHCEN EXHAUST FAN OVER 400 CFM IS INSTALLED, AN OUTSIDE MAKE-UP AIR SYSTEM IS REQUIRED.

ENERGY EFFICIENCY

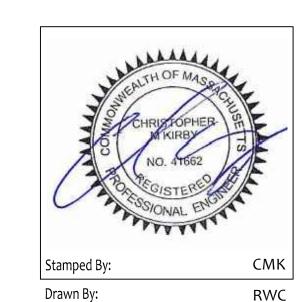
- 1. ENERGY EFFICIENCY TO BE THE "PRESCRIPTIVE METHOD" IN ACCORDANCE WITH CHAPTER 4 (RESIDENTIAL ENERGY EFFICIENCY) OF THE THE 2015 INTERNATIONAL ENERGY CONSERVATION CODE (2015) IECC). SEE THIS CHAPTER FOR COMPLETE REQUIREMENTS.
- 2. THE BUILDINGS (NEW PORTION) THERMAL ENVELOPE SHALL MEET THE REQUIREMENTS OF TABLE R402.1.2. A SHORT VERSION OF TABLE R402.1.2 IS LISTED BELOW AND THE FULL VERSION SHALL BE REVIEWED FOR COMPLETE REQUIREMENTS.
- 3. THE 2015 IECC HAS STRICT REQUIREMENTS FOR ENERGY EFFICIENCY AND CHANGES TO THE CODE INCLUDE; HIGHER WALL R-VALUES, PERMANENT CERTIFICATE OF BUILDING COMPONENTS POSTED, AIR LEAKAGE TEST, BASEMENT INSULATION TO A DEPTH OF 10 FEET BELOW GRADE OR THE BASEMENT FLOOR (WHICHEVER IS LESS), RIM JOIST/WALL SEALING, RECESSED LIGHTING SHALL BE SEALED FIXTURES. JUNCTION BOXES ON EXTERIOR WALLS SHALL BE INSULATED. ATTIC ACCESS SHALL BE SEALED, ETC.
- 4. THE CITY OF BOSTON HAS ADOPTED THE "STRETCH ENERGY CODE". ADDITIONAL ENERGY EFFICIENCY REQUIREMENTS MAY APPLY.

TABLE R402.1.2 - PARTIAL LIST (2015 IECC)					
CLIMATE ZONE	FENESTRATION U-FACTOR	SKYLIGHT U-FACTOR	CEILING R-VALUE	WOOD FRAME WALL R-VALUE	FLOOR R-VALUE
5	0.30	0.55	49	20	30

21 MAGNOLIA **STREET** BOSTON, MA

CM KIRBY ENGINEERING, PLLC

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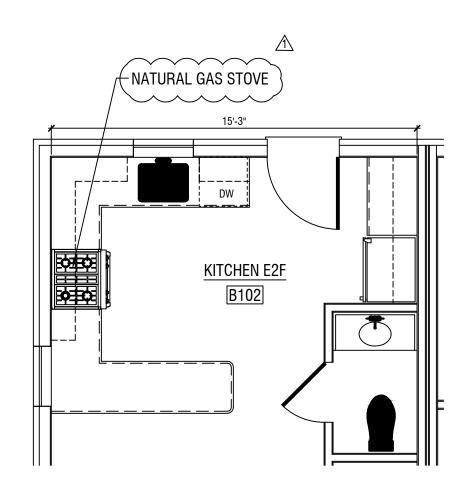
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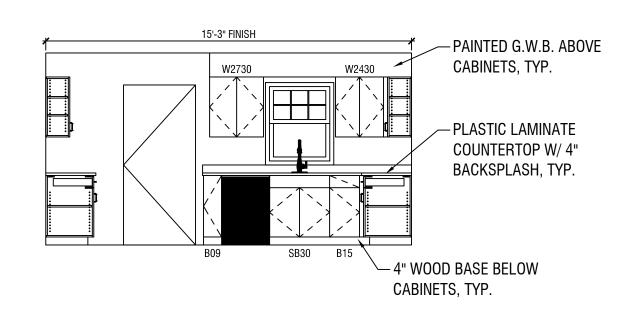
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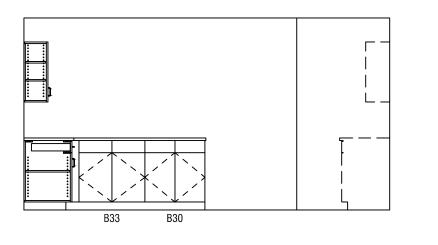
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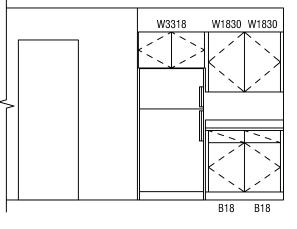
GENERAL NOTES


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3 ELEVATION 1/4" = 1'-0"

TYPE E2 & F KITCHEN PLAN

1/4" = 1'-0"

1 ELEVATION
1/4" = 1'-0"

2 ELEVATION

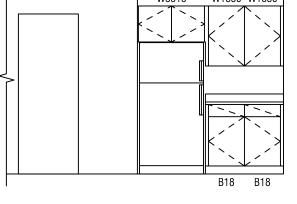1/4" = 1'-0"

3 ELEVATION 1/4" = 1'-0"

CM KIRBY ENGINEERING, PLLC ARCHITECTS ENGINEERS

21 MAGNOLIA

STREET

BOSTON, MA

CHRISTOPHER M. KIRBY, PE MA PE LICENSE No. 41662 EXPIRES 6/30/2020 CKIRBY83@GMAIL.COM

KITCHEN - GENERAL NOTES:

1. THESE KITCHEN PLANS & ELEVATIONS ARE PROVIDED FOR REFERENCE ONLY

2. MODEST REVISIONS TO THE LAYOUT & MATERIALS ARE ACCEPTABLE

3. D.N.D. HIGHLY ENCOURAGES THE APPLICATION OF UNIVERSAL DESIGN PRINCIPLES

4. COORDINATE PLANS & ELEVATIONS WITH FINAL DRAWINGS

KITCHEN CABINETS - GENERAL NOTES:

1. PLASTIC TRIM EDGE ON ALL EXPOSED PLASTIC LAMINATE WALL COVER EDGES.

2. IF USED, STAINLESS STEEL BACKSPLASH SHALL BE USED BEHIND THE STOVE AND EXTEND FROM THE BOTTOM OF THE CABINETS TO THE TOP OF THE COUNTERTOP BACKSPLASH

 \parallel 3. INSTALL DUPLEX OUTLET AT 6" ABOVE THE TOP \parallel OF THE COUNTERTOP TYP. SEE ELECTRICAL

4. ALL EXPOSED END PANELS SHALL BE FINISHED INSTALL WOOD BASE & BASE UNIT END PANELS INCLUDING BEHIND APPLIANCES

5. INSTALL WOOD BASE ON WALLS BEHIND ALL APPLIANCES.

6. VERIFY ALL DIMENSIONS AT SITE PRIOR TO SUBMISSION OF SHOP DRAWINGS.

7. INSTALL FILLER STRIPS TO MAKE UP VARIATIONS IN DIMENSIONS 3" MAXIMUM.

8. PROVIDE DOUBLE BOWL SINKS IN ALL UNITS.

9. FIELD MEASURE ROUGH FRAMING FOR, AND PROVIDE SHOP DRAWING FOR REVIEW


10. PROVIDE FILLER PANELS FOR SPACES UP TO 3". IF OVER 3" PROVIDE NEXT CABINET SIZES.




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Revisions	
PERMIT SET - REVIEW	5/7/2020
o INITIAL SUBMISSION	6/8/2018

DND PROJECT

KITCHEN ELEVATIONS AND DETAILS

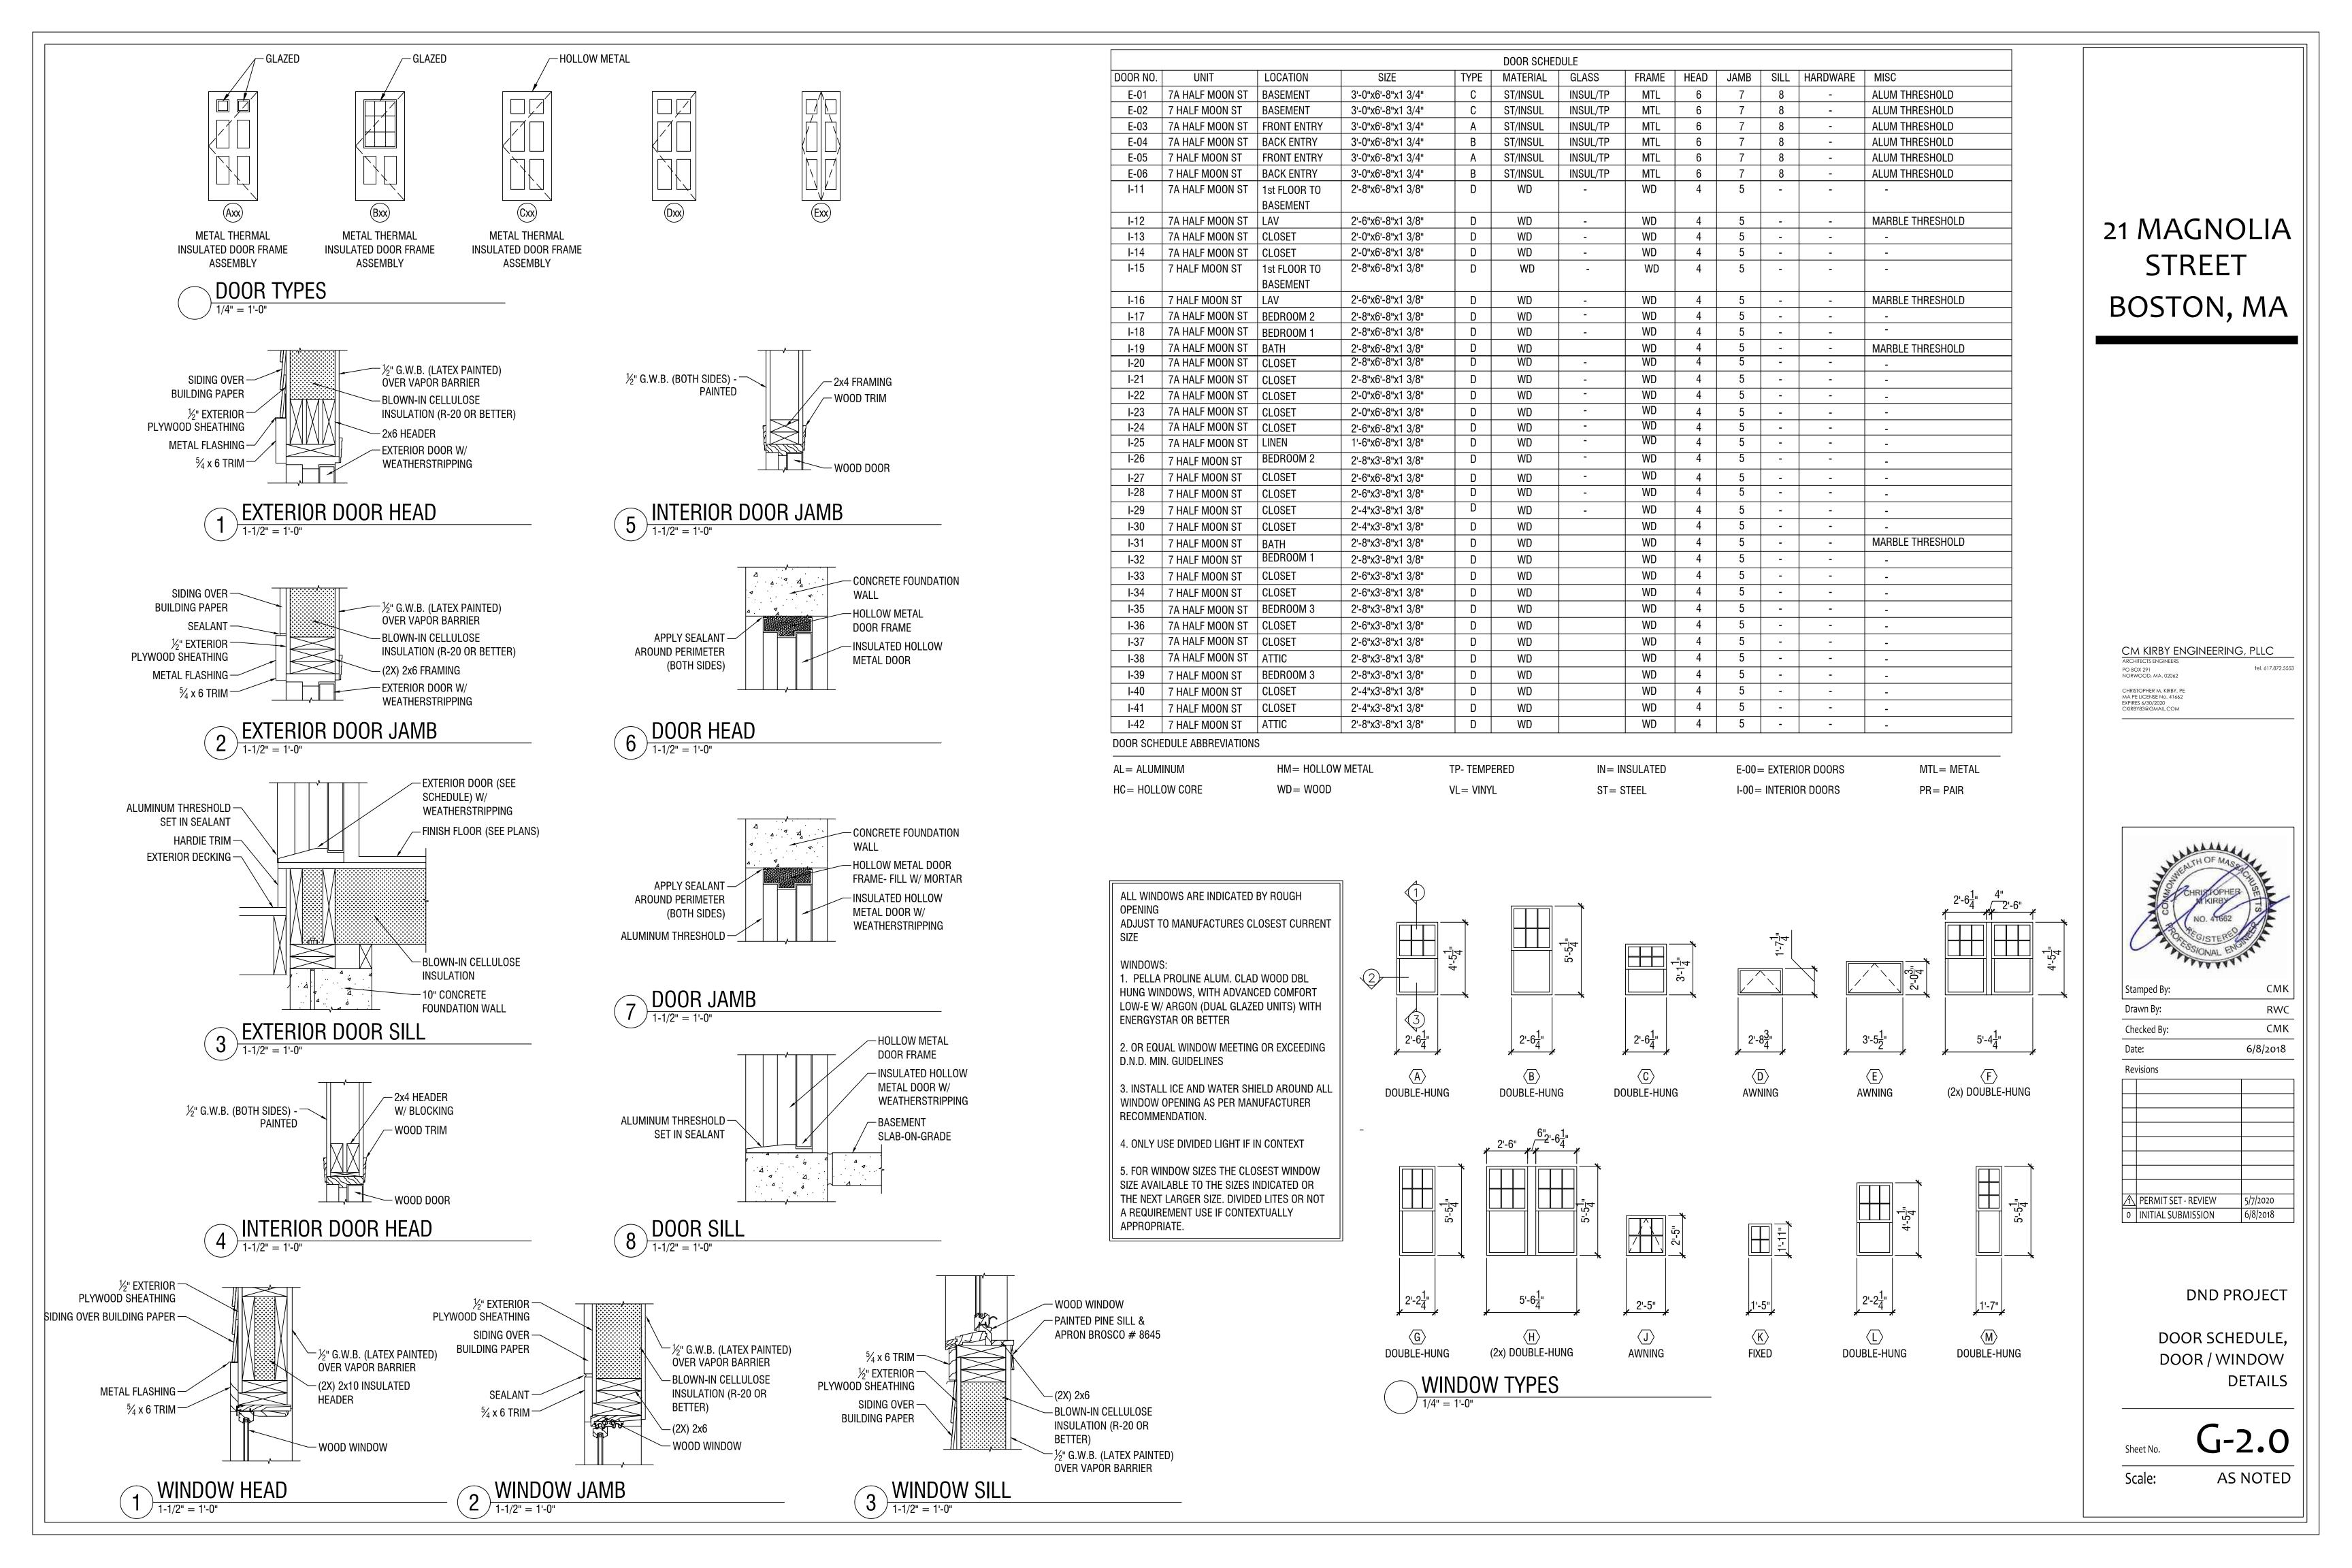

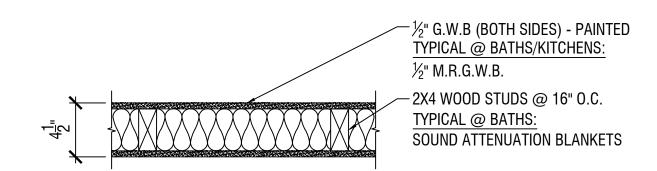

½" G.W.B - PAINTED TYPICAL @ BATHS/KITCHENS: ½" M.R.G.W.B. - 2x6 WOOD STUDS @ 16" O.C. W/ BLOWN-IN CELLULOSE INSULATION

INSULATION)

(VAPOR BARRIER ON WARM SIDE OF


-½" PLYWOOD SHEATHING; TYVEK BUILDING WRAP FLASHING; ICE & WATER SHIELD @ WINDOWS; CEMENTITIOUS CLAPBOARD SIDING (4" EXPOSURE); HARDI TRIM AS INDICATED

TYP. INTERIOR PARTITION 1-1/2" = 1'-0"



1/2" G.W.B (BOTH SIDES) - PAINTED TYPICAL @ BATHS/KITCHENS: ½" M.R.G.W.B. -2x6 WOOD STUDS @ 16" O.C. TYPICAL @ BATHS: SOUND ATTENUATION BLANKETS NOTE: ACOUSTICAL SEALANT - 3-1/2" SOUND ATTENUATION BLANKETS @ BASE & HEAD OF PARTITION

2 TYP. PLUMBING PARTITION

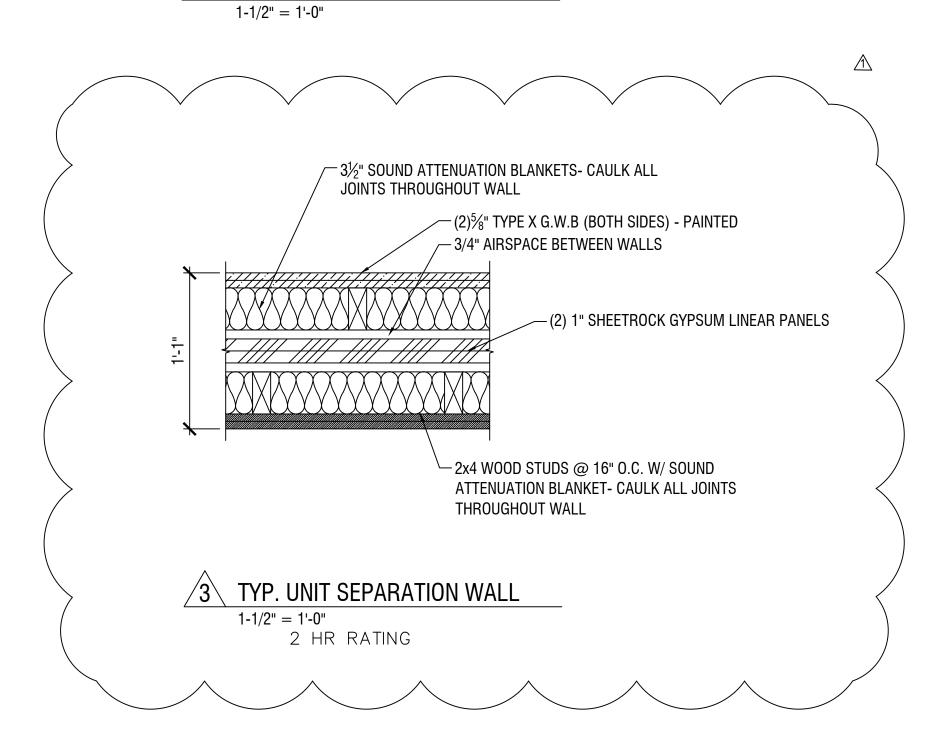

		ROOM	FINISH SCH	EDULE				
R00M N0.	ROOM NAME	WALLS/WAINSCOT	BASE	FL00R	CEILING	CLNG HGT	MISC	REMARKS
A001	BASEMENT	GWB	-	CONC	DS	8'-0"	-	-
A101	LIVING ROOM	GWB	WD	WD	GWB	8'-0"	-	-
A102	KITCHEN	GWB	WD	WD	GWB	8'-0"	-	-
A103	DINING ROOM	GWB	WD	WD	GWB	8'-0"	-	-
A104	1/2 BATH	MR BD	СТ	СТ	GWB	7'-6"	-	-
A201	BEDROOM 1	GWB	WD	WD	GWB	8'-0"	-	-
A202	BATH	MR BD	СТ	СТ	GWB	7'-6"	-	-
A203	BEDROOM 2	GWB	WD	WD	GWB	8'-0"	-	-
A301	BEDROOM 3	GWB	WD	WD	GWB	8'-0"	_	-
A302	STORAGE	GWB	WD	WD	GWB	8'-0"	-	-

ROOM FINISH SCHEDULE ABBREVIATIONS

CRPT = CARPET DS= DUST SHIELD CONC = CONCRETE

CMU= CONCRETE MASONRY UNIT

EXP= EXPOSED

GWB= GYPSUM WALL BOARD

PNT= PAINTED VB= VINYL BASE VNL= SHEET VINYL

MR BD= MOISTURE RESISTANT GYPSUM WALL BOARD

WD = WOOD

GENERAL NOTES:

- 1. TYP. FIRST FLOOR/ BASEMENT CEILING ASSEMBLY PROVIDE BATT, SPRAY FOAM OR NETTED LOOSE INSULATION R-30 W/ STRAPPING FIRE RATED G.W.B. AT BOILER AREA (TYP.)
- 2. CLOSET FINISHES AND LAUNDRY CLOSET TO MATCH ROOM CLOSET OPENS INTO.
- 3. PROVIDE OAK CAP AT STAIR HANDRAIL.
- 4. STAIR TREAD AND LANDING FINISHES BASEMENT TREADS PROVIDE UNPAINTED HARD PINE FIRST FLOOR LANDING - PROVIDE WOOD FLOORING
- 5. ALL WASHING MACHINES IN LIVING AREA TO HAVE CONNECTED METAL PAN TO DRAIN.
- 6. PROVIDE MIN. ONE HAND HANDRAIL AT ALL STAIRS. TWO WHEN SHOWED IN THE DRAWINGS.
- 7. STAIR HANDRAILS WITH OPEN BALUSTER B-720 BEECH NATURAL FINISH HANDRAIL 1-1/4" SQUARE PAINTED BALUSTER AND 3-1/4" SQUARE PAINTED NEWELL: BY BROSCO OR ARCHITECT APPROVED EQUAL.
- 8. INTERIOR STAIR RAIL BRACKET: C- 3002 BROSCO BRASS FINISH OR ARCHITECT APPROVED EQUAL.
- 9. WALL HANG RAILINGS BROSCO 1-1/2" x 1-11/16" NO. 75 ROUND AT BASEMENT STAIRS ONLY. NO. 66 TAPERED PROFILE PINE WITH INTERIOR STAIR HANDRAIL BRACKETS AT STAIRS WITHIN UNITS MITERED RETURNS.

21 MAGNOLIA STREET BOSTON, MA

CM KIRBY ENGINEERING, PLLC

tel. 617.872.5553

RWC

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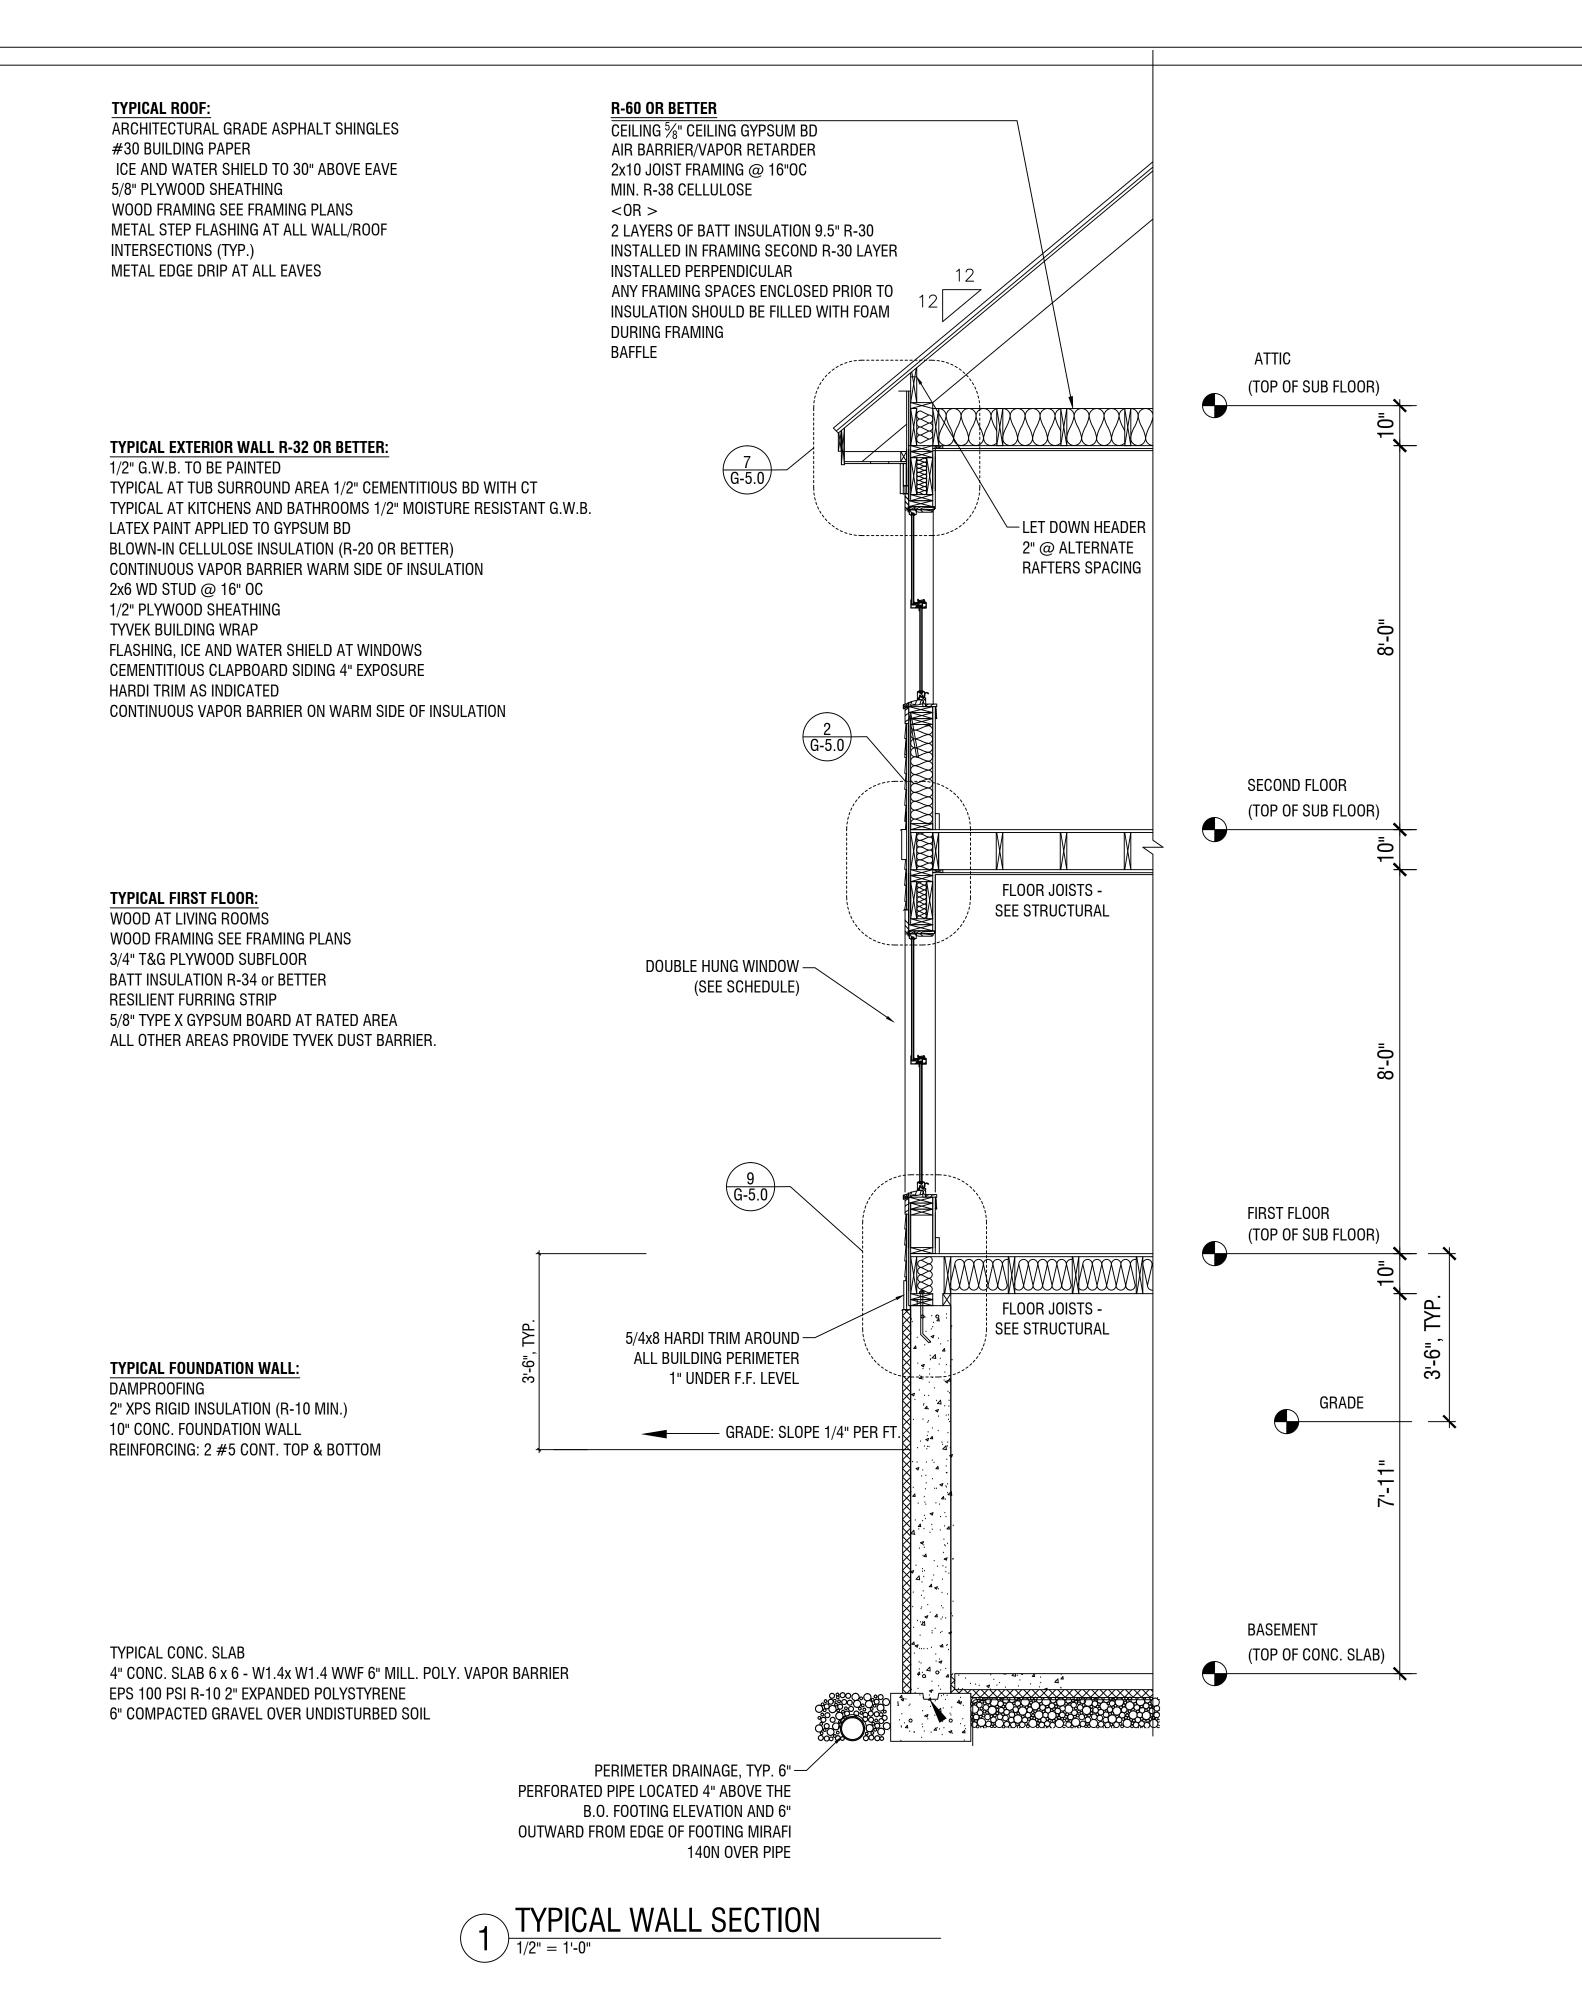
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Rev	visions	
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ROOM FINISH SCHEDULE AND PARTITION TYPES



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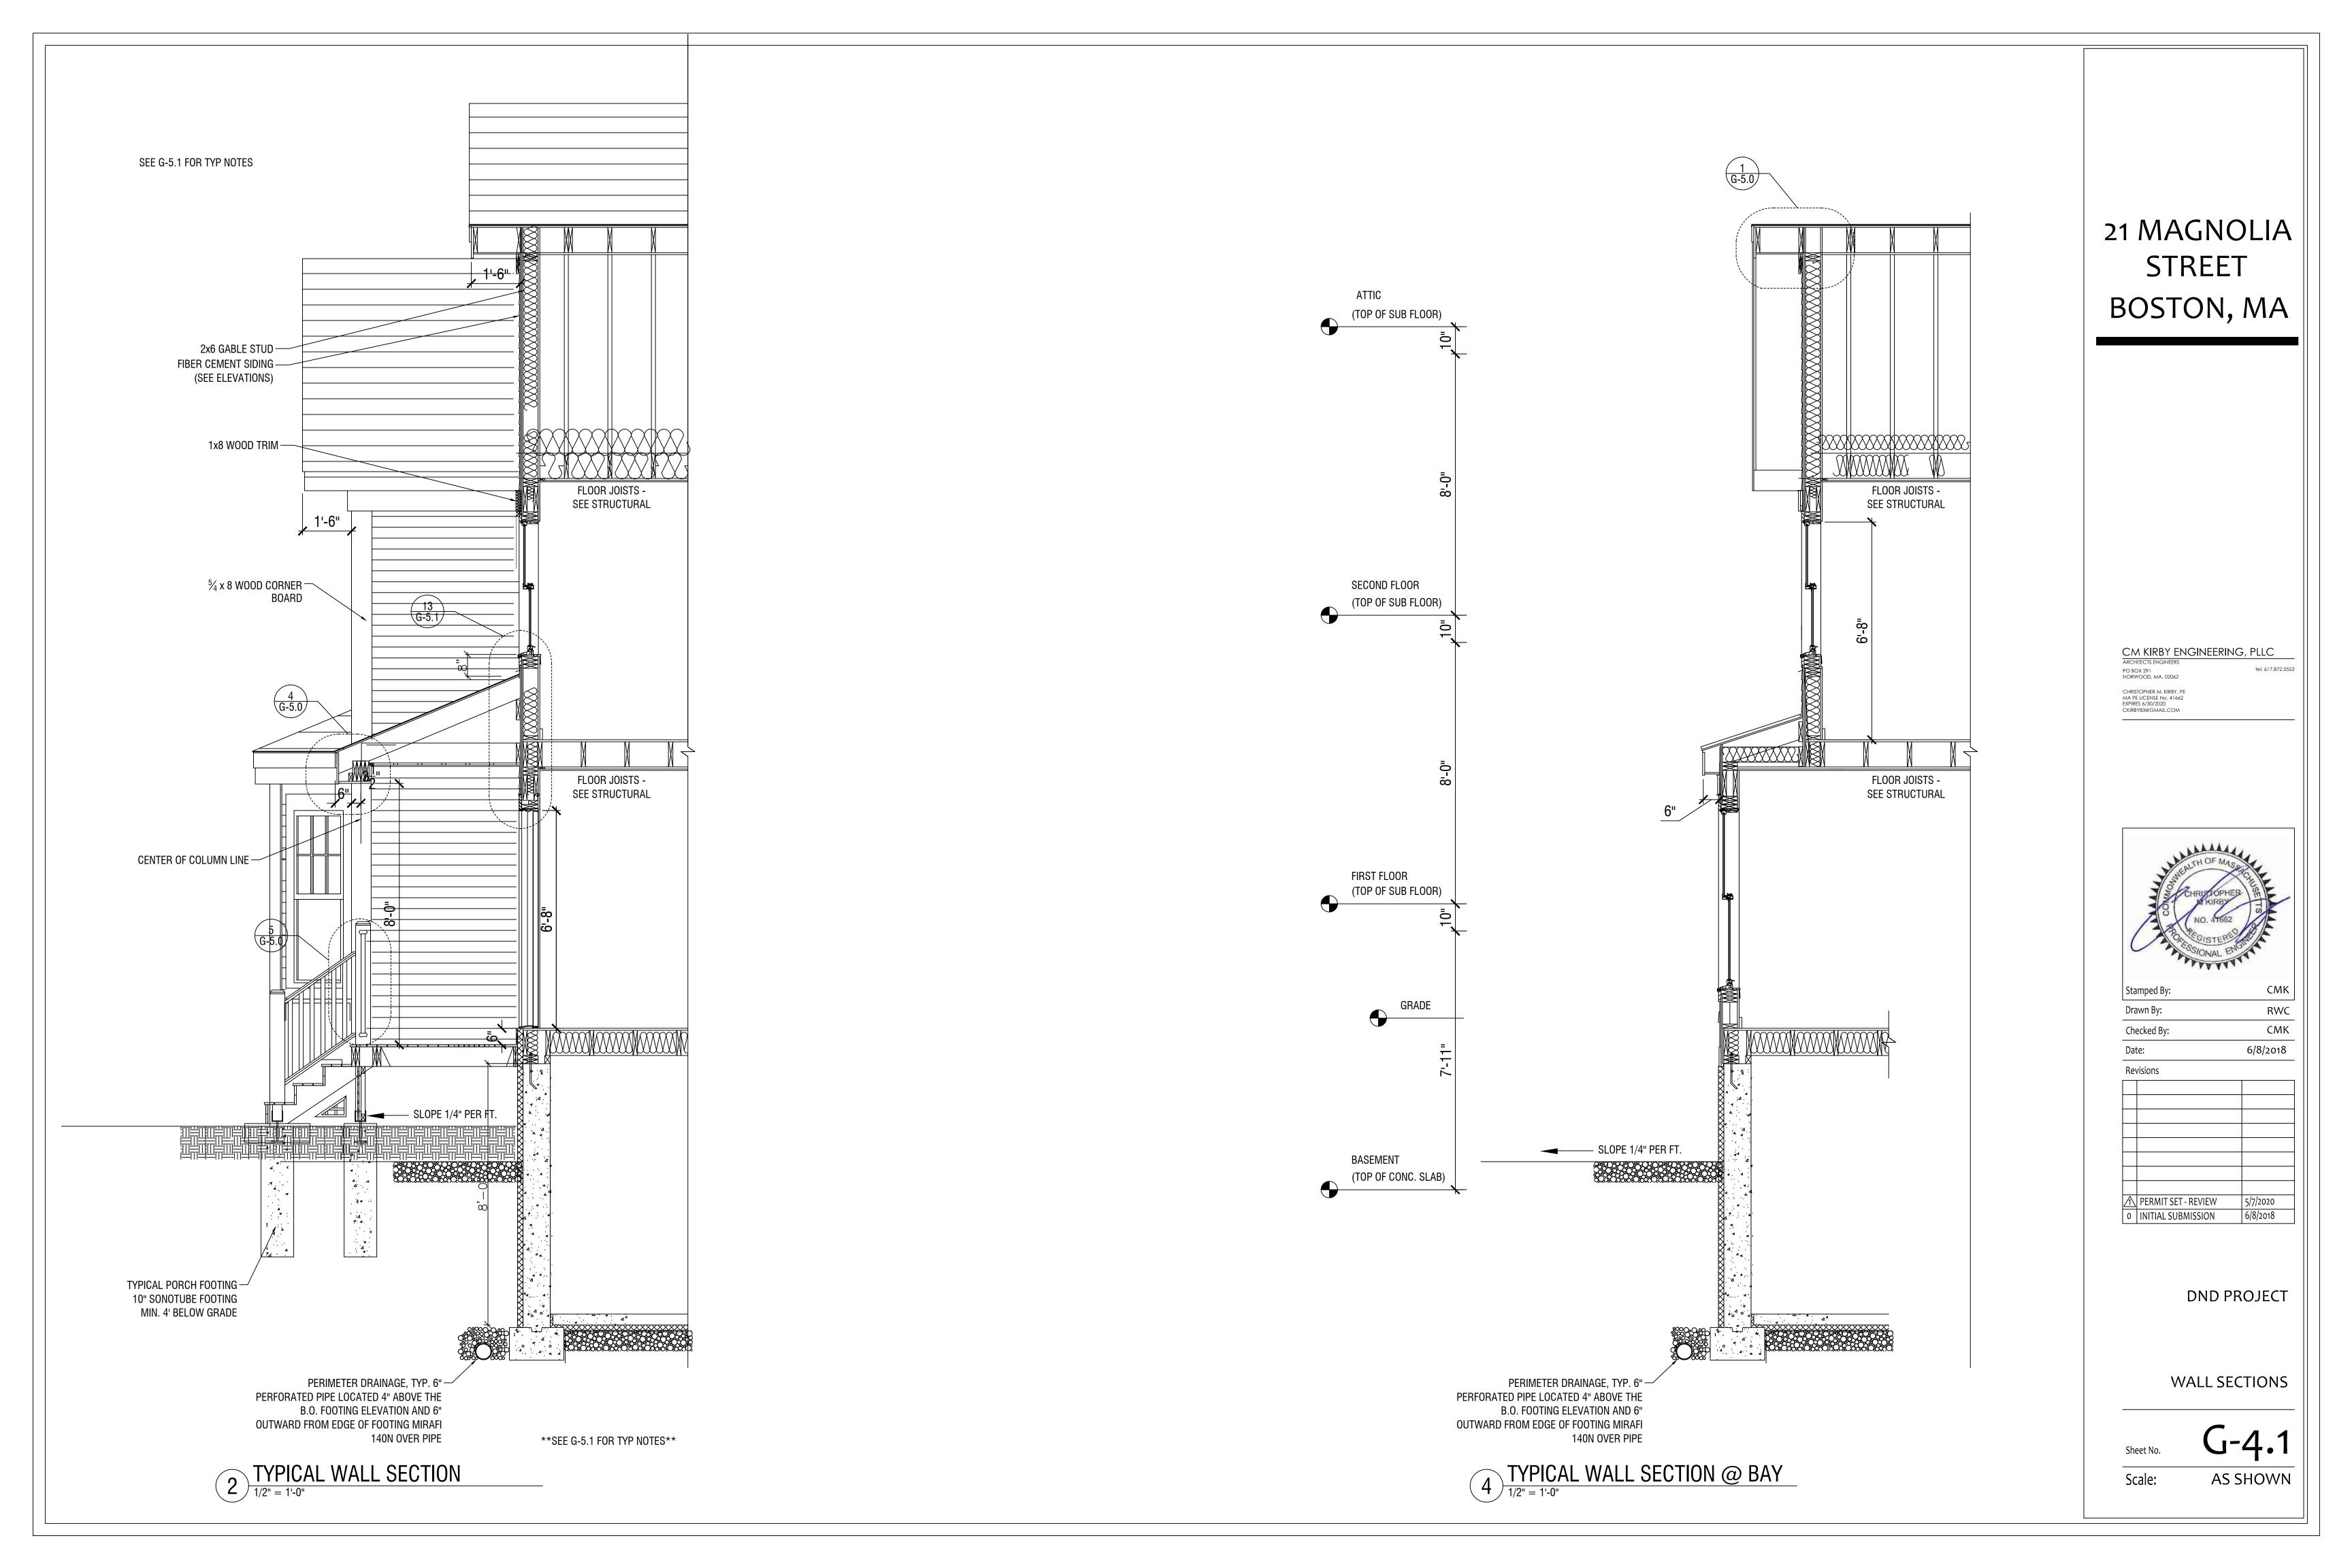



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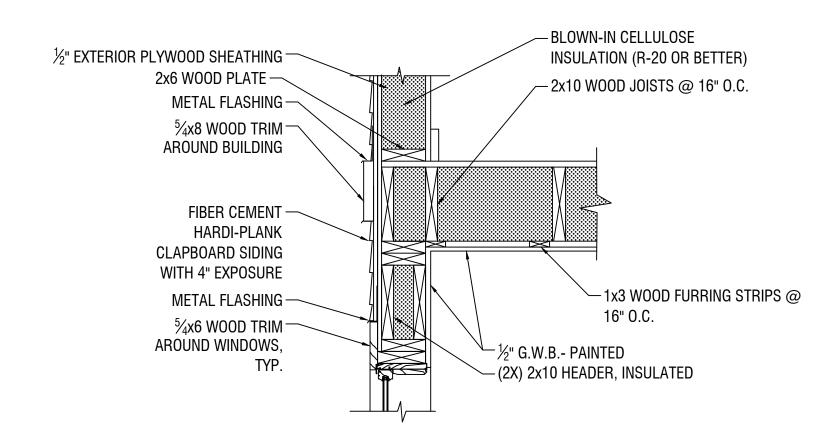
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WALL SECTIONS







1 RAKE DETAIL @ GABLE ROOF

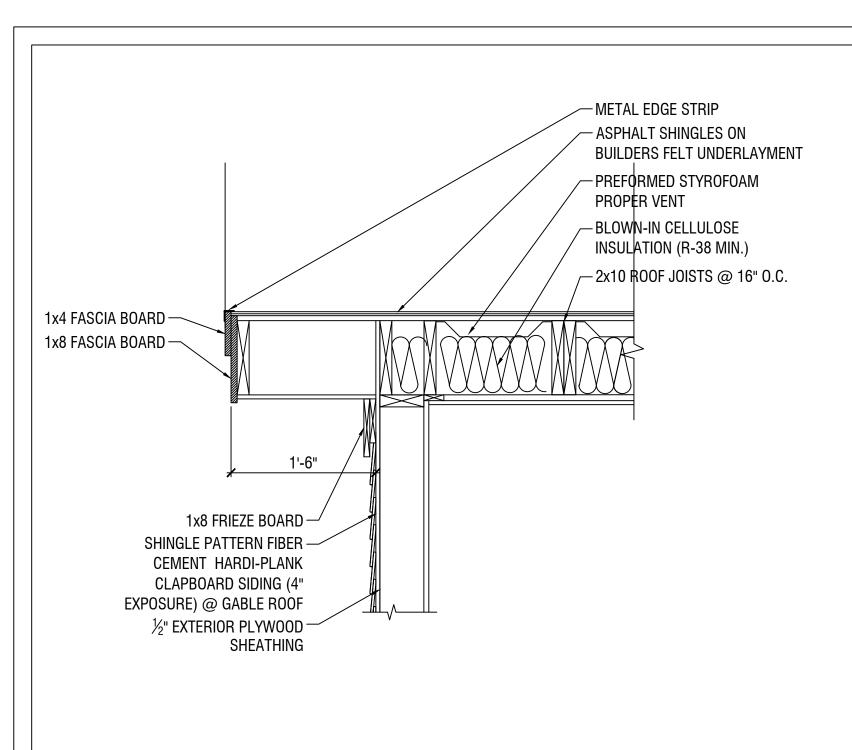

TYP. WALL DETAIL 1" = 1'-0"

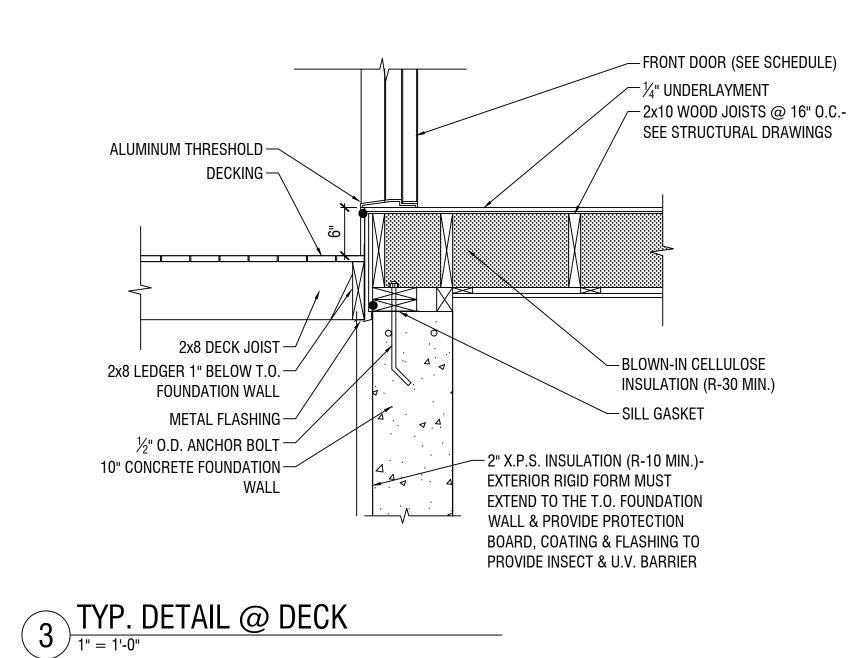


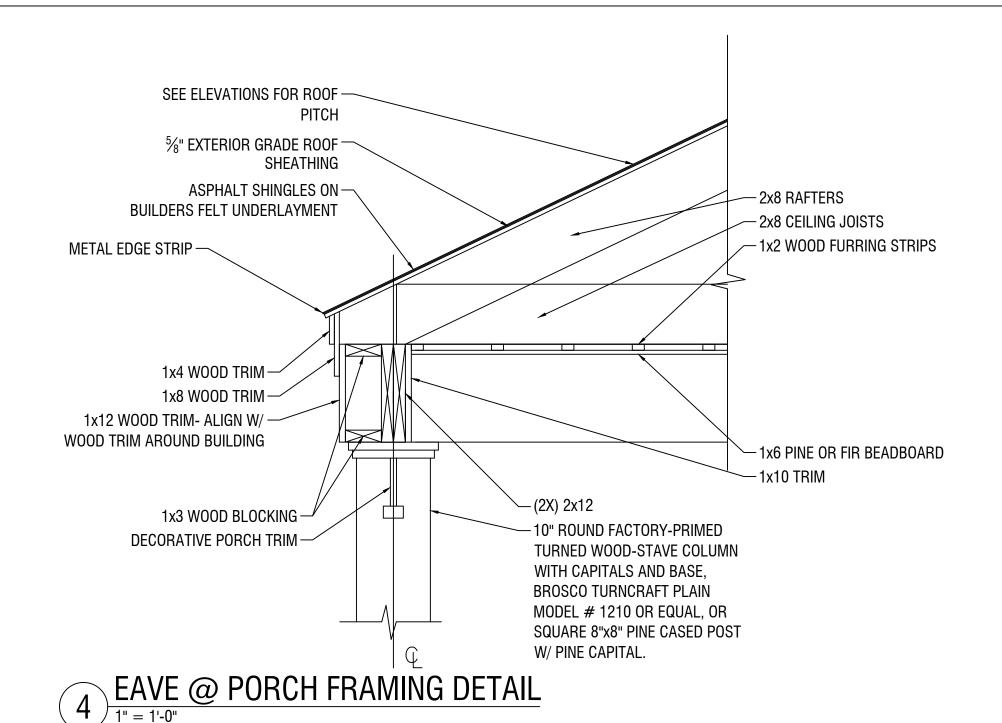

-NEWELS TO BE 31/4" SQUARE--6x6 WOOD POSTS FOR FRONT PORCH- USE 4x4 POSTS FOR REAR DECK $^{ extsf{-}}1lac{1}{2}$ " SQUARE FIR BALUSTERS-PAINTED $-3\frac{1}{4}$ " Beaded top & Bottom RAILS W/ SLOPED SURFACE-PAINTED -(2X) 2x8 WOOD JOISTS- PAINTED,


TYP. FRAMING DETAIL @ DECK 5 TYP. FRAMING DETAIL @ DECK


2x12 WOOD STRINGER

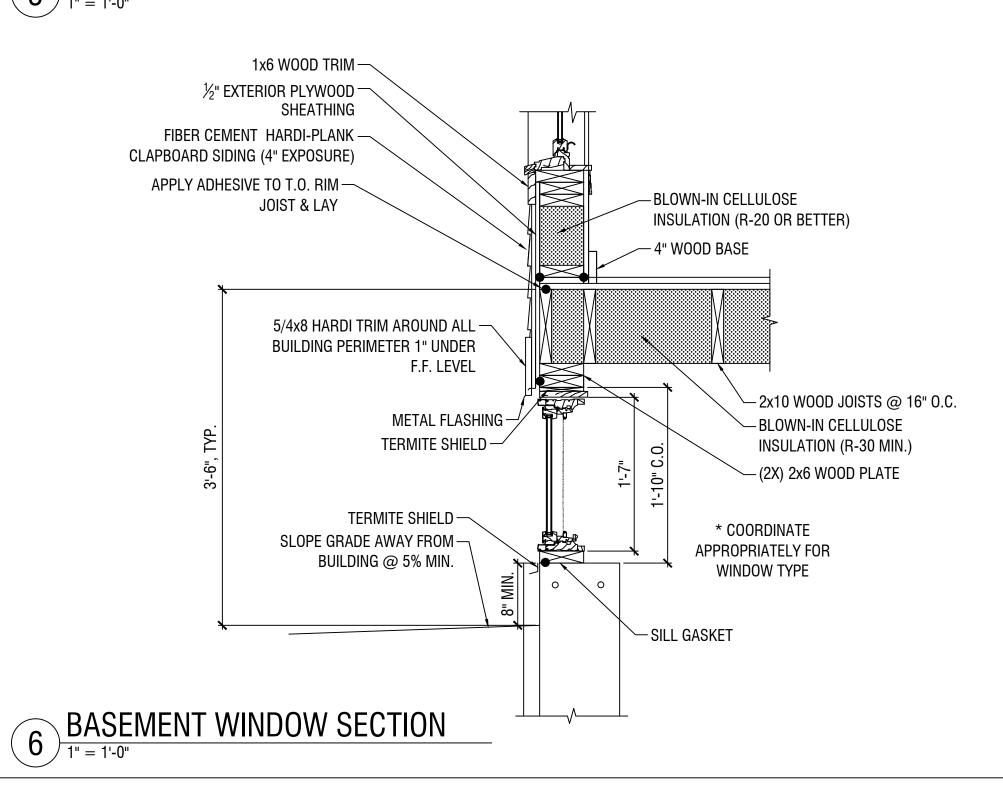

ANCHORED TO COLUMN

-1" WOOD LATTICE

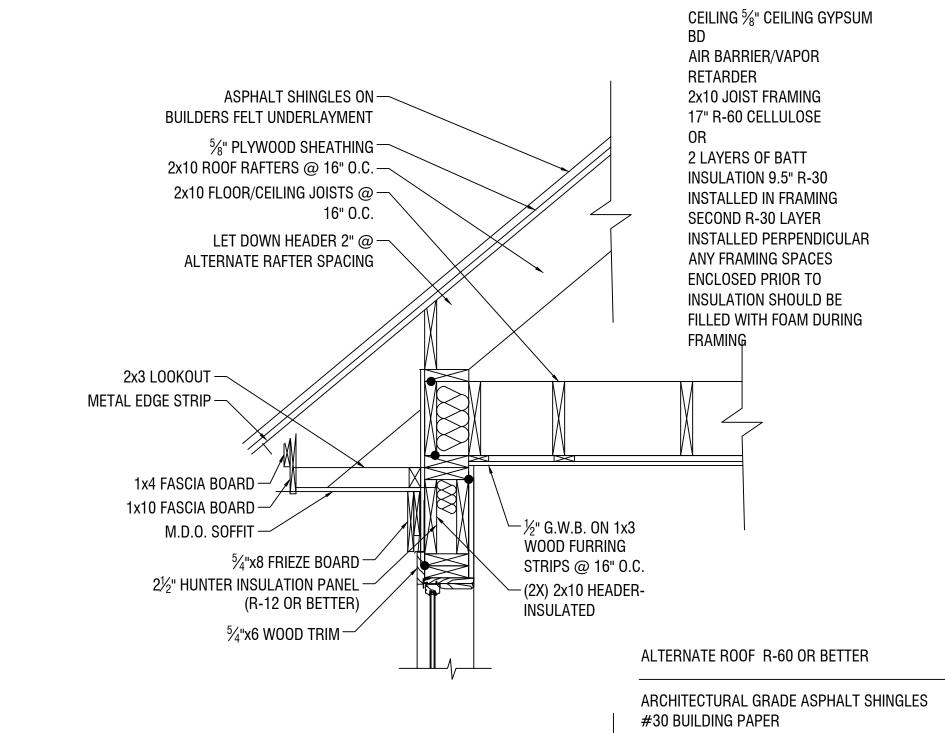


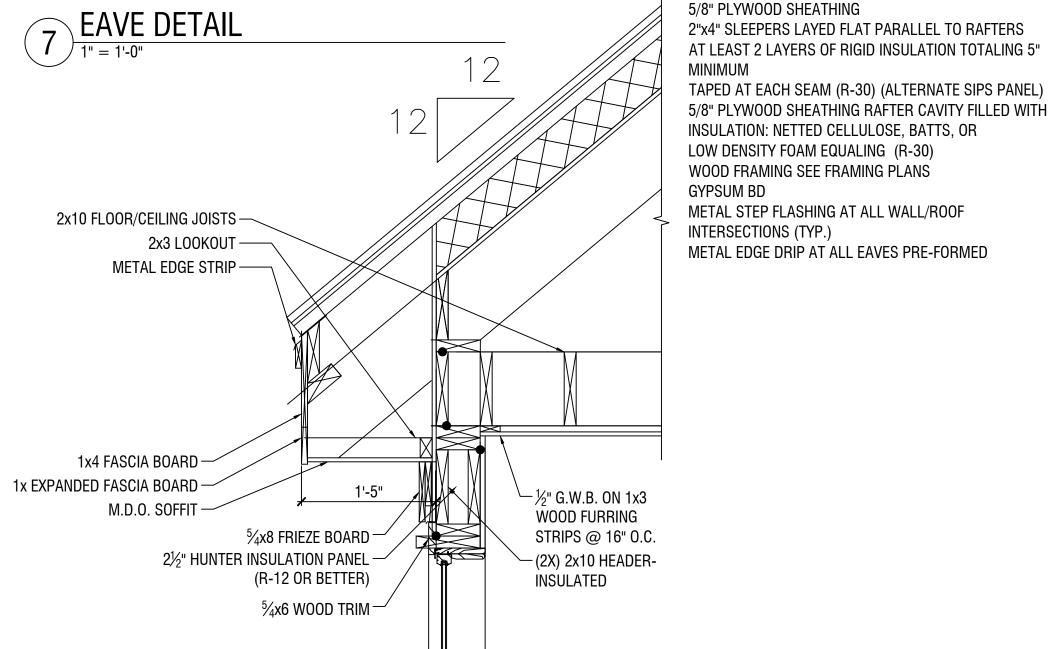

8 EAVE DETAIL ALTERNATE

 DOT REPRESENTS POINTS WHERE CAUKING IS REQUIRED. THIS IS TYPICAL OF ALL DETAILS.

INCLUDE ADHESIVE SEAM TAPE ON ALL SHEATHING INSTALLATION

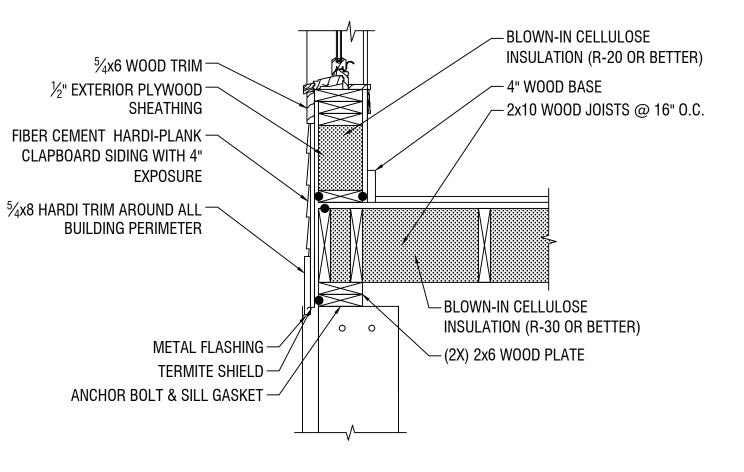

9 TYP. DETAIL @ FOUNDATION WALL

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TYPICAL DETAILS

G-5.0 Scale:

AS SHOWN

