GENERAL NOTES:

CONTRACTOR RESPONSIBILITY-CONTRACTOR IS SOLELY RESPONSIBLE FOR:

- . VIEWING SITE AND INCLUDING ANY SPECIAL CONDITIONS NECESSARY TO
- PERFORM THE WORK AS DESCRIBED IN THE DRAWINGS.
- 2. ESTABLISHING CONTROL OF THE SITE VIA SURVEY, AND LAYOUT.
- . OBTAINING AND PAYING FOR ALL PERMITS. 4. PAYING FOR ALL TEMPORARY UTILITIES AND FACILITIES
- 5. CHECKING AND CONFIRMING ALL DIMENSIONS, AND LAYOUTS.
- 6. SCHEDULING AND SEQUENCING.
- 7. CONSTRUCTION MEANS, METHODS AND TECHNIQUES
- 8. MAINTAINING DRAWINGS AND PERMITS ON SITE.
- 9. JOB SITE SAFETY
- 10. COORDINATION BETWEEN TRADES, AND SUPPLIERS 11. PROVIDE SCHEDULE TO OWNER AND ARCHITECT.
- 12. PROVIDE A SCHEDULE OF VALUES TO THE OWNER AND ARCHITECT 13. TEMPORARY HEAT, ICE AND SNOWPLOWING IS THE RESPONSIBILITY OF THE CONTRACTOR
- 14. SITE CLEANLINESS AND CONFORMANCE TO NFPA 241 REQUIREMENTS. 15. REPAIRING ANY WORK DAMAGED BY HIS FORCES WHILE PERFORMING THIS CONTRACT
- 16. GIVING WARRANTY FOR HIS WORK FOR A PERIOD OF ONE YEAR FROM THE DATE OF FINAL COMPLETION.

REVIEW OF WORK BY DESIGNERS-

CONTRACTOR SHALL NOTIFY ARCHITECT BEFORE PROJECT STARTS.

CONTRACTOR SHALL NOTIFY ARCHITECT, ONE WEEK PRIOR TO:

- **17. POURING CONCRETE**
- 18. INSULATING

19. INSTALLING DRYWALL 20. FINAL INSPECTION

SHOP DRAWINGS-

ALL SHOP DRAWINGS SHALL BE SUBMITTED 30 DAYS AFTER CONTRACT AWARD.

GENERAL CONTRACTOR SHALL APPROVE SHOP DRAWINGS, PRIOR TO SUBMITTING TO ARCHITECT OR ENGINEER

NON SUBMISSION DOES NOT CONSTITUTE APPROVAL OF ANY WORK.

NO EXCEPTIONS TAKEN DOES NOT RELIEVE THE CONTRACTOR OF PERFORMING ANY OTHER WORK ON THE DRAWINGS.

CONTRACTOR SHALL EXPECT A MINIMUM OF 2 WEEKS FOR DESIGNERS' REVIEW TIME.

ANY VARIANCE FROM THE ORIGINAL DESIGN SHALL BE NOTED.

ANY SUBSTITUTION NOT INDICATED SHALL NOT CONSTITUTE APPROVAL OF A CHANGE.

SHOP DRAWINGS ARE NOT COORDINATION DRAWINGS.

DESIGNERS ARE NOT RESPONSIBLE FOR DIMENSIONS.

CHANGE ORDERS-

CONTRACTOR SHALL VISIT THE SITE AND BE THOROUGHLY ACQUAINTED WITH THE PROJECT PRIOR TO SUBMITTING A PRICE. ADDITIONAL MONEY WILL NOT BE GRANTED FOR WORK NOT CLARIFIED PRIOR TO BIDDING.

DESIGNER SHALL BE NOTIFIED OF ANY CHANGE TO THE DRAWINGS, UNFORESEEN FIELD CONDITIONS OR DISCREPANCIES PRIOR TO PERFORMING WORK.

ANY PROPOSED CHANGES SHALL BE ACCOMPANIED WITH A WRITTEN DESCRIPTION OR A SKETCH FOR CLARIFICATION.

ALL CHANGE ORDERS SHALL BE APPROVED PRIOR TO PERFORMING WORK.

CHANGE ORDERS SHALL BE PRICED EITHER LUMP SUM OR UNIT PRICE OR TIME AND MATERIALS.

ANY SUBSTITUTION REQUEST SHALL BE MADE VIA CHANGE ORDER, AND NOT VIA SHOP DRAWINGS UNLESS AGREED TO.

ANY CHANGE SHALL STATE THE CREDIT OR COST ADD AND/OR ANY CHANGE TO THE SCHEDULE.

REQUISITIONS-

ANY REOUISITION REOUIRED TO BE SIGNED BY THE ARCHITECTED SHALL BE SUBMITTED A MINIMUM OF ONE WEEK PRIOR TO BEING SUBMITTED TO THE BANK FOR REVIEW.

CONTRACTOR SHALL PROVIDE RECEIPTS AND INSURANCE CERTIFICATES FOR ANY MATERIALS FOR PAYMENT FOR ANY UNINSTALLED MATERIALS.

NOTE: THERE HAS BEEN NO SOIL TESTING PROVIDED TO THIS OFFICE FOR THIS PROJECT. THE DESIGNING ARCHITECT OR STRUCTURAL ENGINEER ACCEPTS NO RESPONSIBILITY FOR EXISTING SOIL CONDITIONS. ANY SOIL BEARING CAPACITY OF THIS FOUNDATION SYSTEM IS DESIGNED BASED ON A 2 TON MINIMUM SOIL BEARING CAPACITY. IT SHALL BE THE CONTRACTORS OR OWNERS' RESPONSIBILITY TO DETERMINE SUITABLE SOIL CONDITIONS AND VERIFY THE BEARING PRESSURE. IF A SUITABLE SOIL THAT CAN WITHSTAND A 2 TON BEARING CAPACITY IS NOT AVAILABLE, THIS OFFICE SHOULD BE CONTACTED BY THE CONTRACTOR OR OWNER FOR A FOUNDATION REDESIGN



WOOD NOTES: 1. ALL LUMBER SHALL HAVE A MOISTURE CONTENT OF NOT MORE

THAN 19%.

- MINIMUM:
- 4. ALL STUD BEARING WALLS SHALL HAVE ONE ROW OF 2X THAN 6'-O" O.C. MAXIMUM.
- WITH ADEQUATE STRENGTH.
- FRAMING.
- JOIST FRAMING.
- - TYPE "RCWB" STRAP, OR EQUAL

WOOD LINTEL SCHEDULE:

Lintels	over openings	s in bearing walls shall be as	follows; or as noted on dr
Span of	f opening:	Size: 2x6 studs	Size: 2x4 studs
less tha	an 4'-0"	3 - 2x4	2 - 2x4
up to	6'-0"	3 - 2x6	2 - 2x6
up to	8'-0"	3 - 2x8	2 - 2x8
up to	10'-0"	3 - 2x10	2 - 2x10

DESIGN CRITERIA:

ALL WORK PERFORM	IED U
CONFORM TO THE NI	NTH I
BUILDING CODE.	
DESIGN LIVE LOAD	= 40]
	- FLC
	- PRI
DESIGN SNOW LOAD	= 40]
	WITH
	WHE
WIND LOAD	= 128
SEISMIC:	Ss =
	S1 =
ALL LUMBER SHALL	BE #2

CONTRACTOR NOTE: PRIOR TO COMMENCEMENT OF WORK OR FABRICATION OF COMPONENTS, CONTRACTOR SHALL INVESTIGATE AND VERIFY IN THE FIELD ALL CONDITIONS, DIMENSIONS, AND ELEVATIONS OF THE EXISTING CONSTRUCTION. ALL DISCREPANCIES BETWEEN FIELD-VERIFIED CONDITIONS, DIMENSIONS AND ELEVATIONS AND THOSE INDICATED ON THE DRAWINGS SHALL BE IMMEDIATELY MADE KNOWN TO THE ENGINEER IN WRITING. THE USE OF (V.I.F.) OR (+/-) OR OTHER SIMILAR NOTES AT CERTAIN LOCATIONS ON THE DRAWINGS DOES NOT RELIEVE THE CONTRACTOR OF RESPONSIBILITY FOR VERIFYING ALL CONDITIONS DESCRIBED ABOVE.

> NOTE: ENERGY CODE COMPLIANCE THE CONTRACTOR IS RESPONSIBLE FOR PROVIDING STRETCH/ ENERGY CODE COMPLIANCE PRIOR TO CLOSING OF WALLS. THE PROPER ENERGY CONSULTANT, HERS RATER, OR OTHER ALLOWED PROFESSIONAL SHALL PERFORM THE FINAL INSPECTIONS ASSOCIATED WITH THE CONSTRUCTION REQUIREMENTS AT THE DIRECTION OF THE CONTRACTOR.

RENOVATION & CHANGE OF USE FROM 1 FO 2 FAMILY

2. ALL FRAMING LUMBER SHALL BE #2 SPF, OR BETTER, HAVING A

FB=875 PSI, FV=135 PSI, E=1,300,000 PSI

3. ALL JOIST SPANS SHALL HAVE ONE ROW OF 1" X 3: CROSS

BRIDGING AT MID SPAN AND NOT MORE THAN 8'-O" O.C.

HORIZONTAL BLOCKING AT 1/2 STUD HEIGHT, AND NOT MORE

5. PROVIDE AND INSTALL ALL NECESSARY TIMBER CONNECTORS

6. PROVIDE DOUBLE JOIST BELOW PARTITIONS PARALLEL TO JOIST

7. PROVIDE SOLID BRIDGING BELOW PARTITIONS PERPENDICULAR TO

8. PROVIDE SOLID BRIDGING BETWEEN JOIST FRAMING MEMBERS WHEN BEARING ON STUD PARTITIONS OR BEAMS.

9. PROVIDE A CONTINUOUS BAND JOIST AT EXTERIOR STUD WALLS. 10. PROVIDE DIAGONAL METAL STRAP BRACING AT ALL CORNERS AND WALL INTERSECTIONS, AT THE INSIDE FACE OF STUDS, FROM TOP PLATE TO FLOOR PLATE AT A 45 DEGREE ANGLE WITH A SIMPSON

11. ALL BUILT-UP BEAMS SHALL BE BOLTED WITH 1/2" Ø THRU BOLTS, MEETING A307 STANDARDS, OR, AS NOTED ON DRAWINGS

drawıngs.

NDER THIS CONTRACT SHALL EDITION OF THE MASSACHUSETTS

POUNDS PER SQUARE FOOT OORS IVATE DECK POUNDS PER SOUARE FOOT

H SNOW DRIFT ERE APPLICABLE. 3 MILES PER HOUR 0.217

0.069

2 SPF, Fb= 875 PSI, Fv=135 PSI

175 HUMBOLDF AVENUE ROXBURY, MASSACHUSETTS

ZONING CODE ANALYSIS

175 HUMBOLDT AVENUE

Governing Article: 50 Subdistrict: ROXBURY NEIGHBORHOOD 3F-4000


Use Regulations: Section Table				
Existing Proposed				
SINGLE-FAMILY	TWO-FAMILY			
ALLOWED	ALLOWED			

Dimensional Regulations: Table


	Code Requirement	Existing Condition	Proposed Project	Notes
	3F-4000	SINGLE-FAMILY	TWO-FAMILY	
Lot Area Minimum	4,000 SF FOR 1 UNIT	-	-	-
Min Lot Area for Additional Units	2,000 SF	-	-	-
Total Required Lot Size	6,000 SF	-	6,222 SF +/-	NO CHANG
Min Required Lot Width and Frontage	25'	-	60.00'	NO CHANG
Max FAR	0.8	0.53	0.53	3321/5706
Max Building Height / Stories	3 STORIES / 35'-0"	2 1/2 STORIES / 37'-0" +/-	2 1/2 STORIES / 37'-0" +/-	NO CHANG
Usable Open Space	650 SF PER D.U.	4272 SF +/-	1452 SF +/- PER DU	2904/2
Min Front Yard	MODAL / 20'-0"	30.6'	30.6'	NO CHANG
Min L Side Yard	10'-0"	11.3'	11.3'	NO CHANG
Min R Side Yard	10'-0"	11.6'	11.6'	NO CHANG
Min Rear Yard	30'-0"	27.3'	27.3'	NO CHANG
Max Use of Rear Yard	25%	0%	0%	-


Overlays: NEIGHBORHOOD DESIGN REVIEW Parking: 1 SPACES PER D.U. **1 SPACE EXISTING** 1 ADDITIONAL SPACE REQ'D **2 SPACES PROVIDED**

Other Non-Dimensional Zoning Issues:

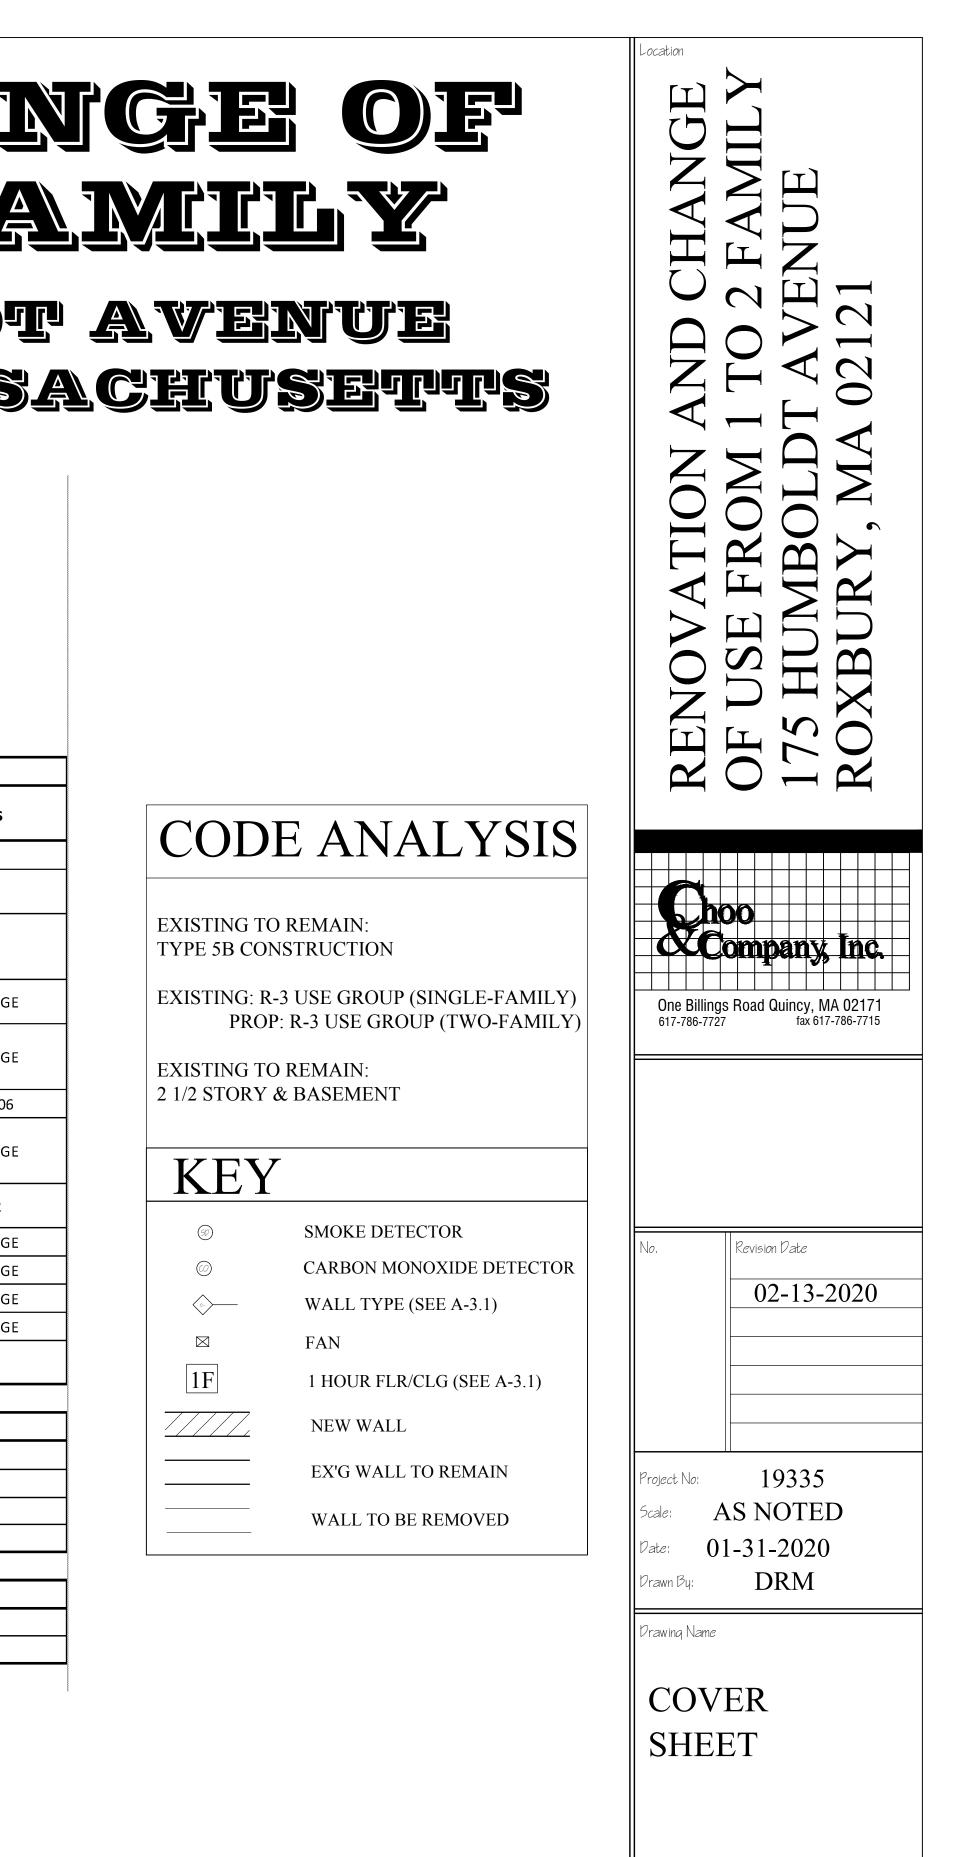



Sheet No.

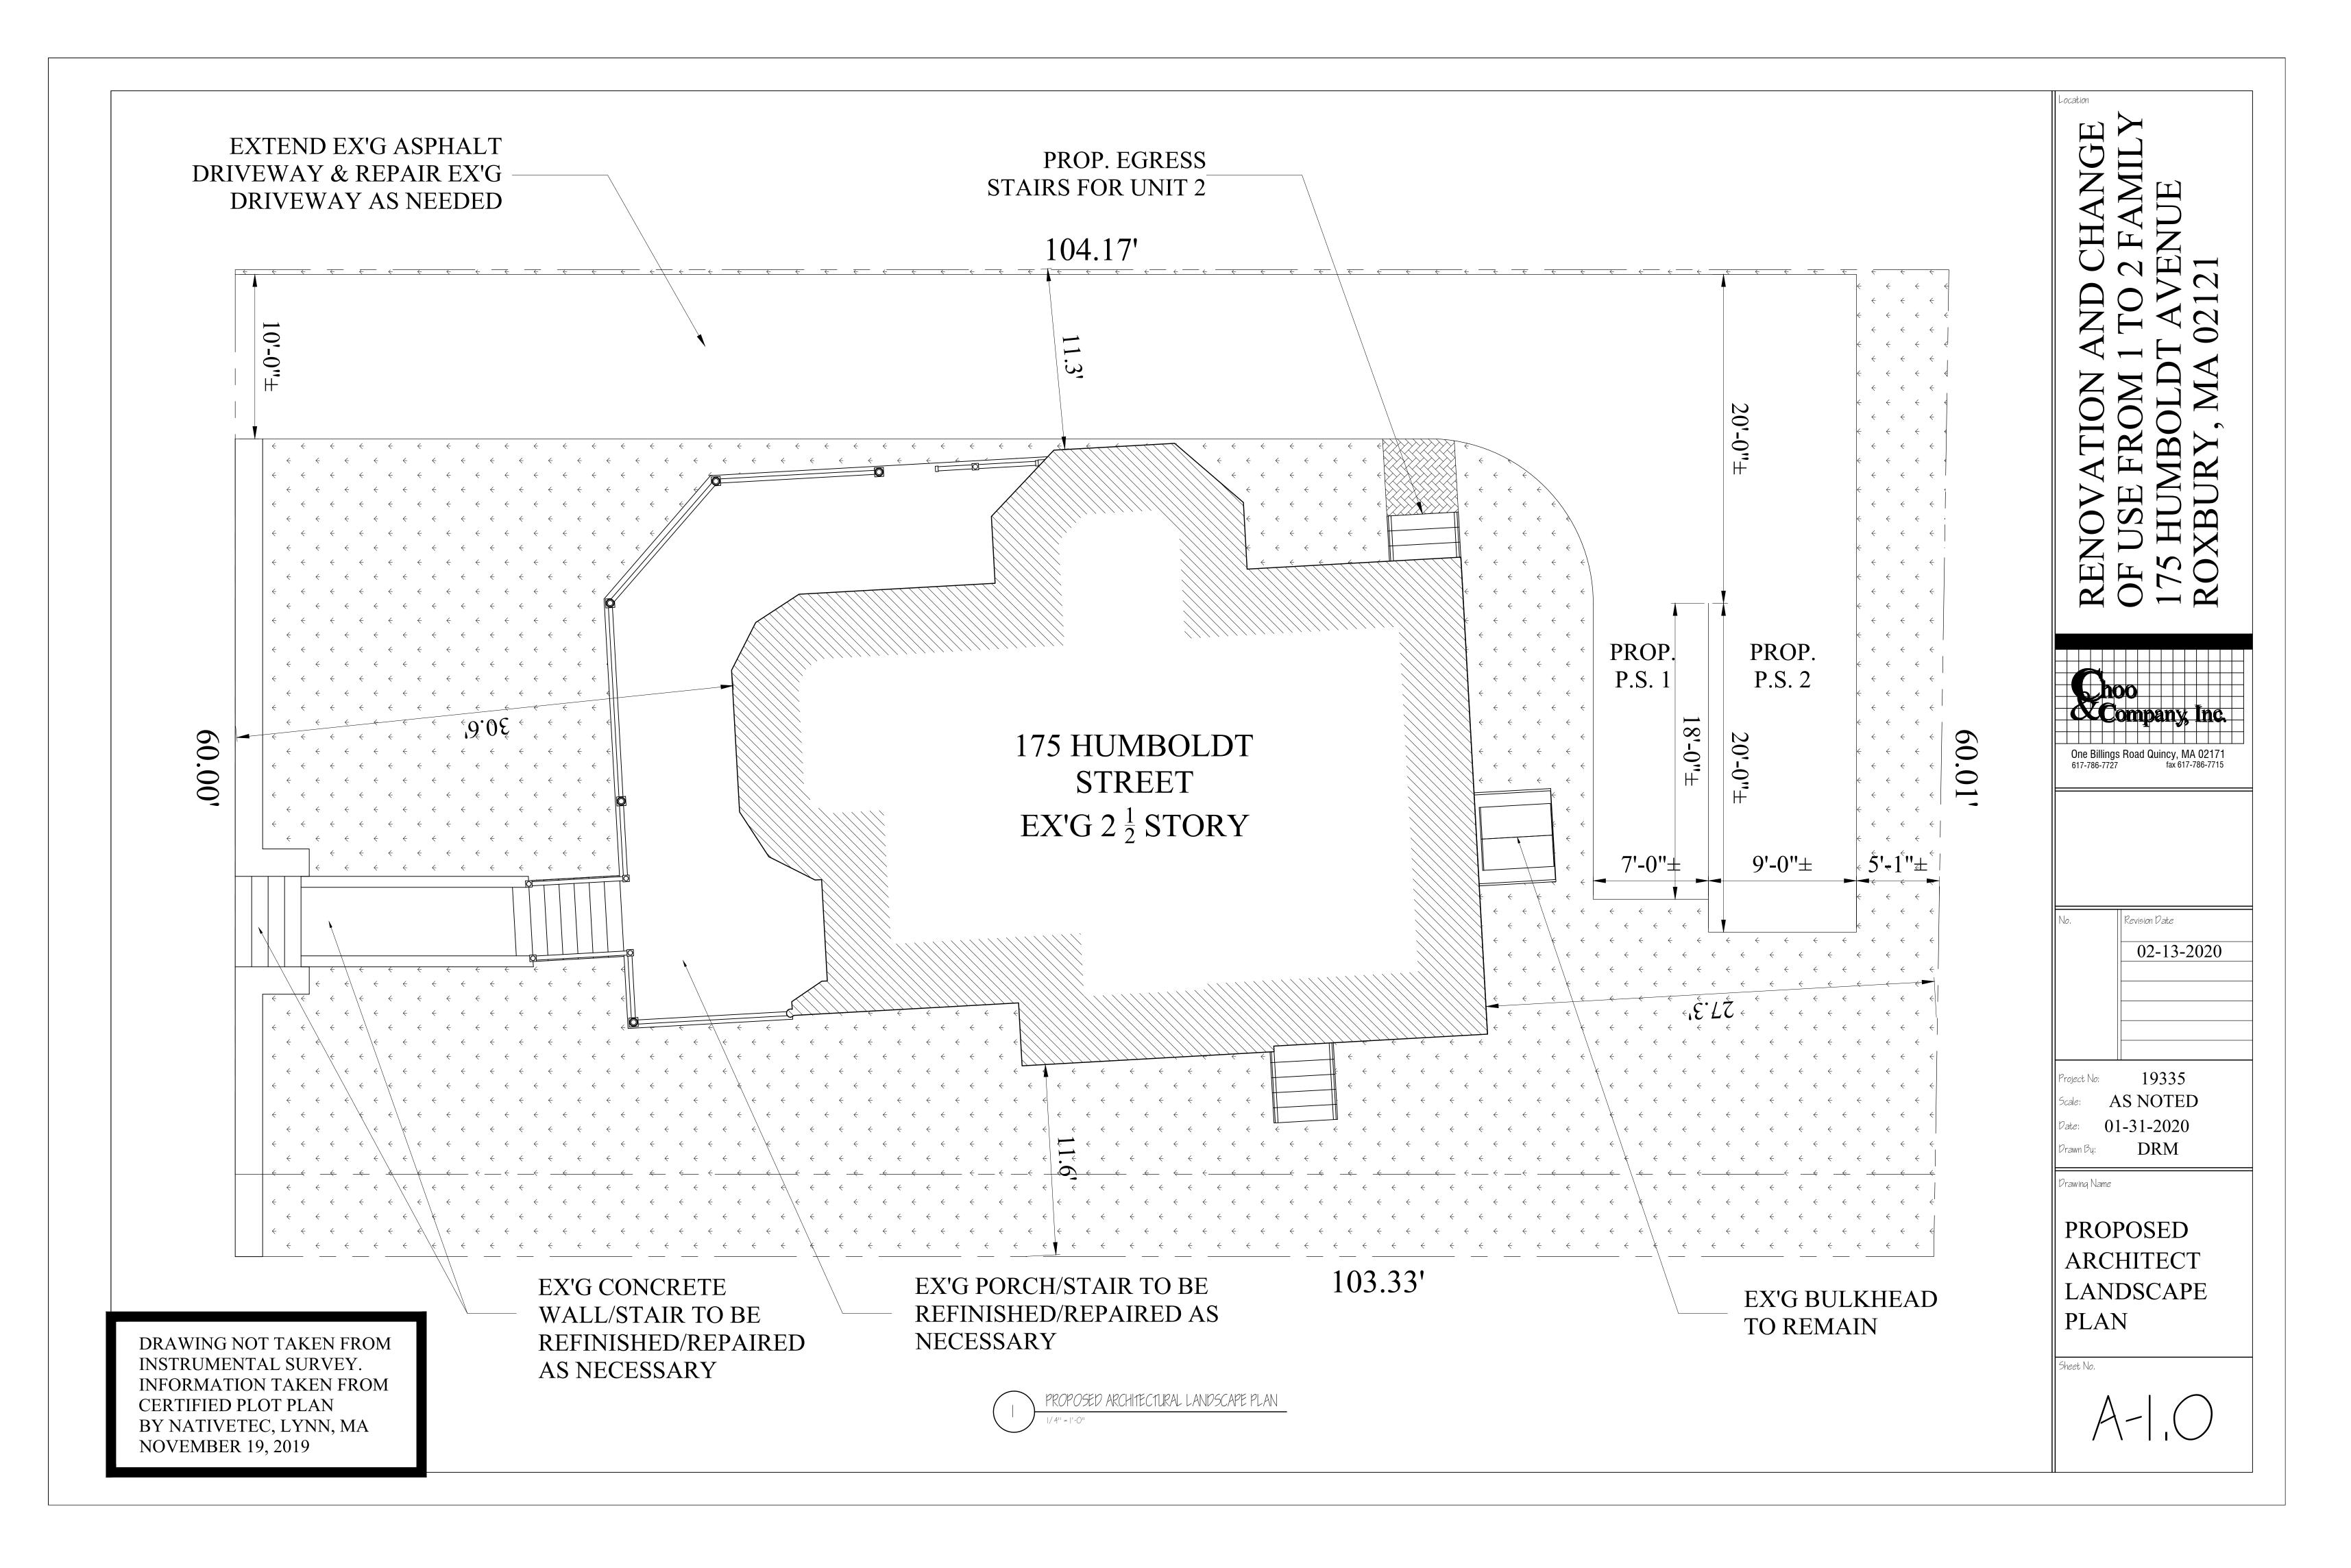


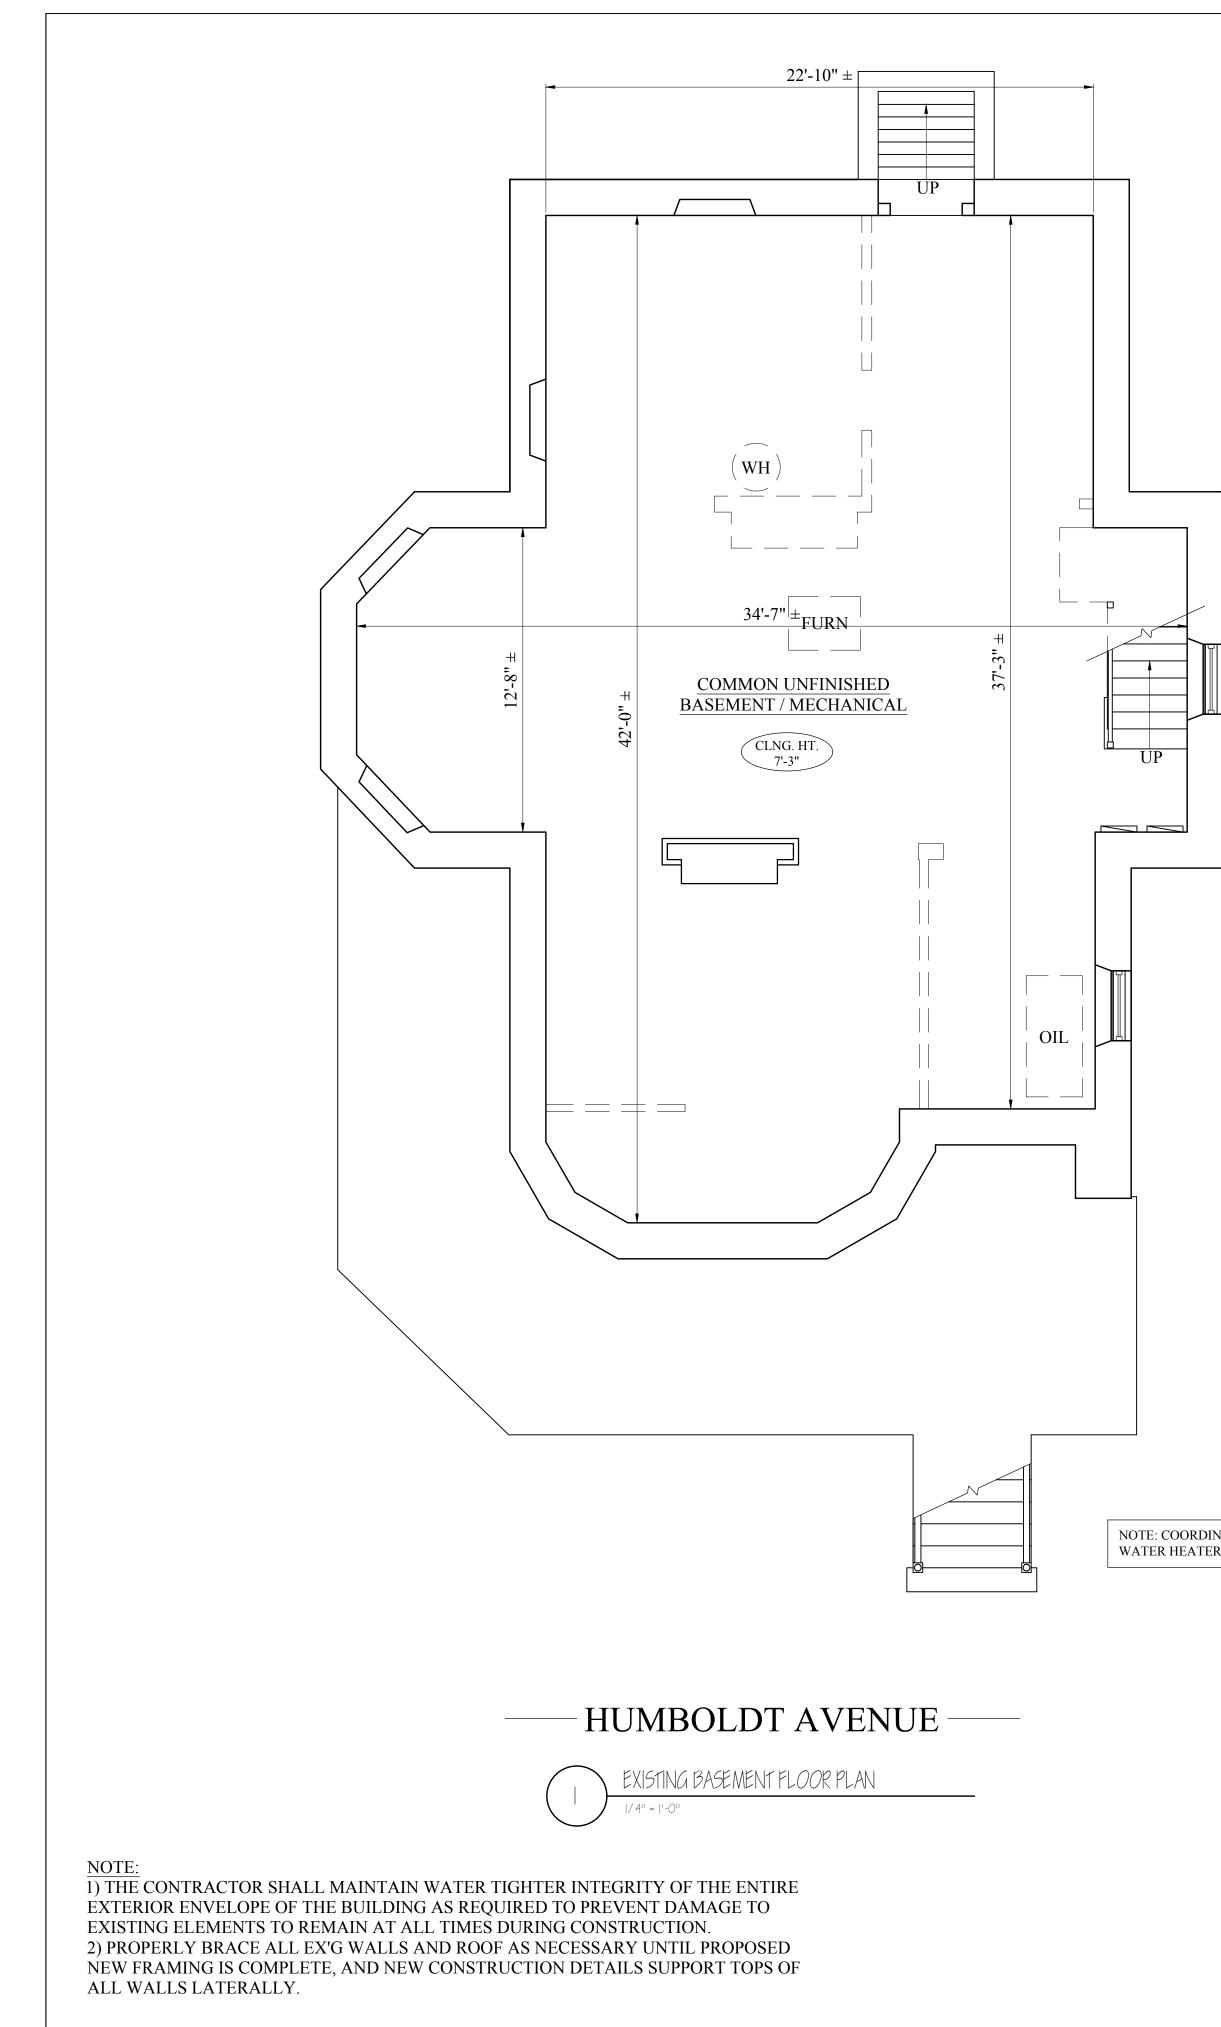

NOTE: COORDINATE REMOVAL OF OIL TANKS, WATER HEATER AND FURNACE WITH GC.

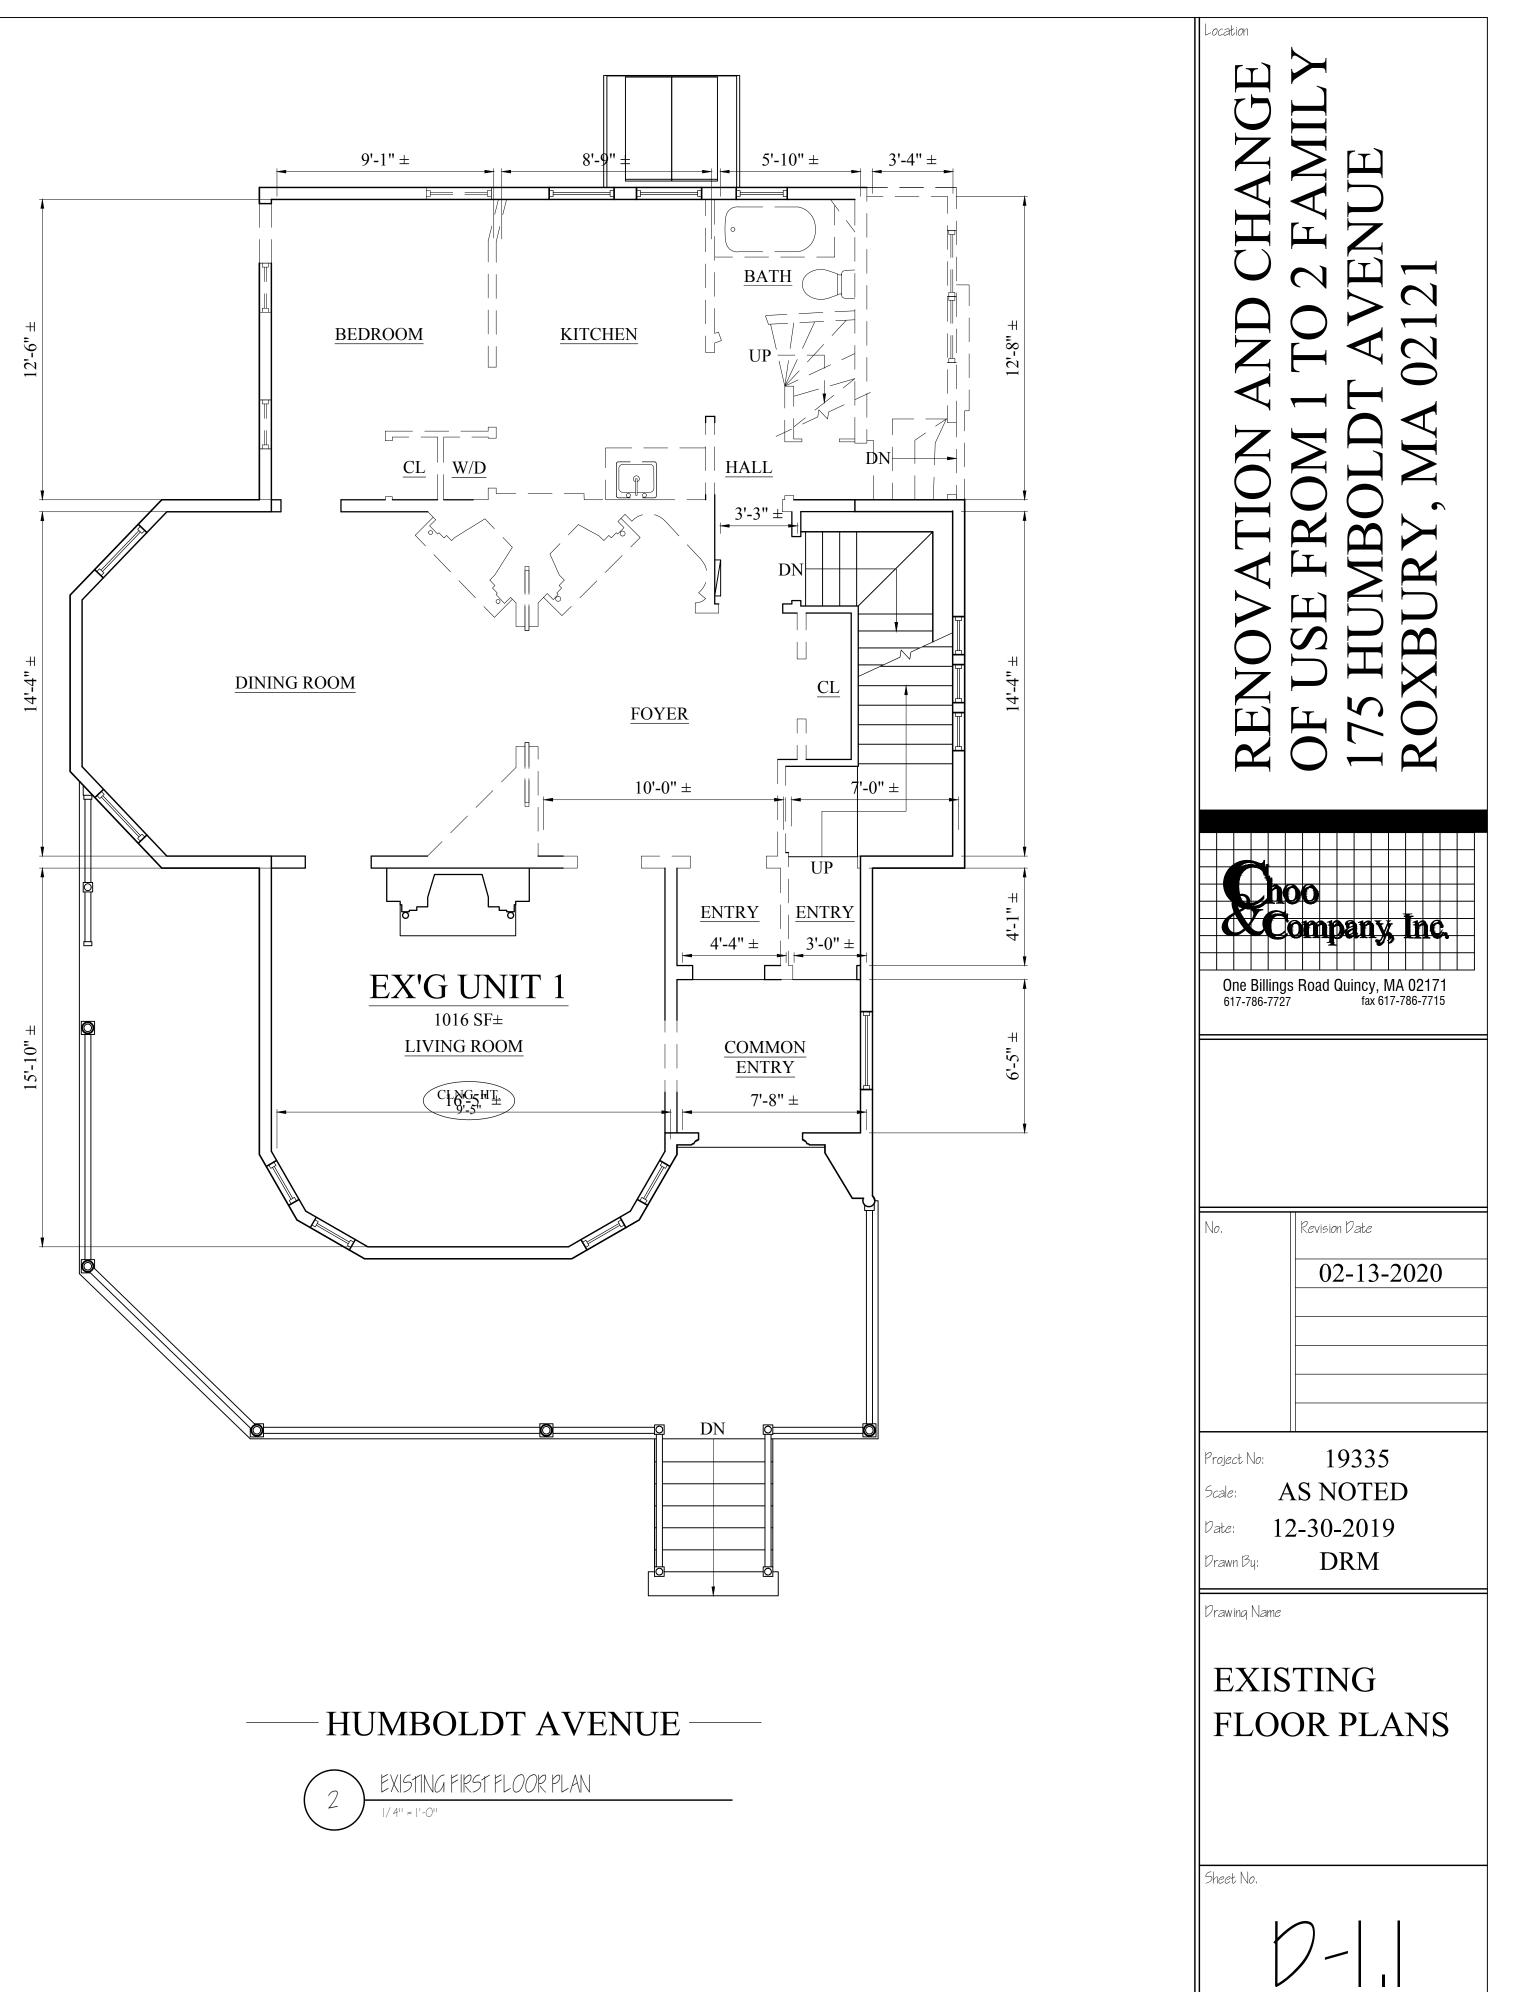


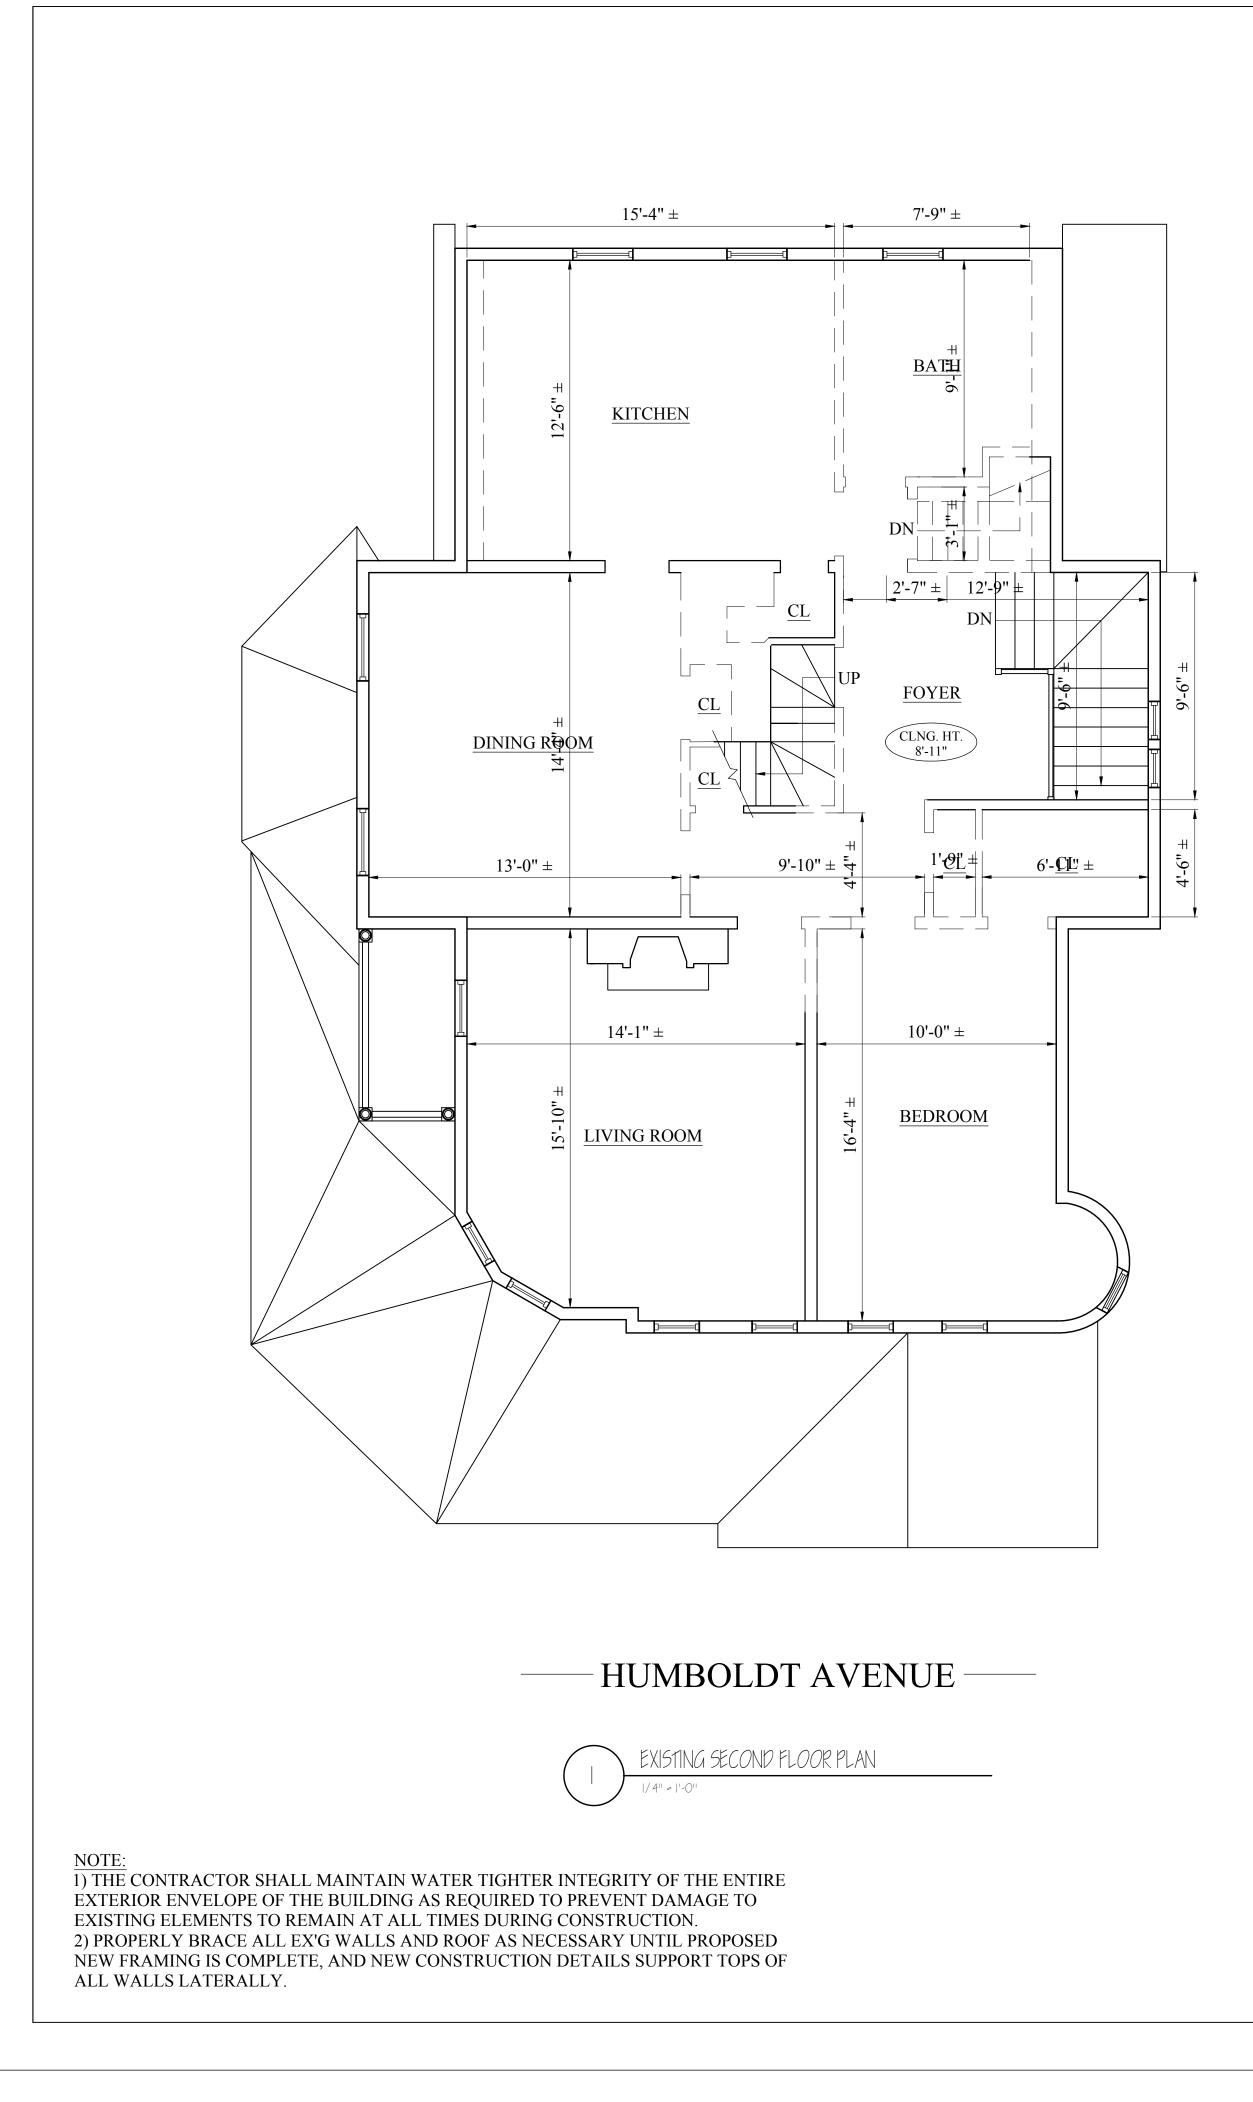


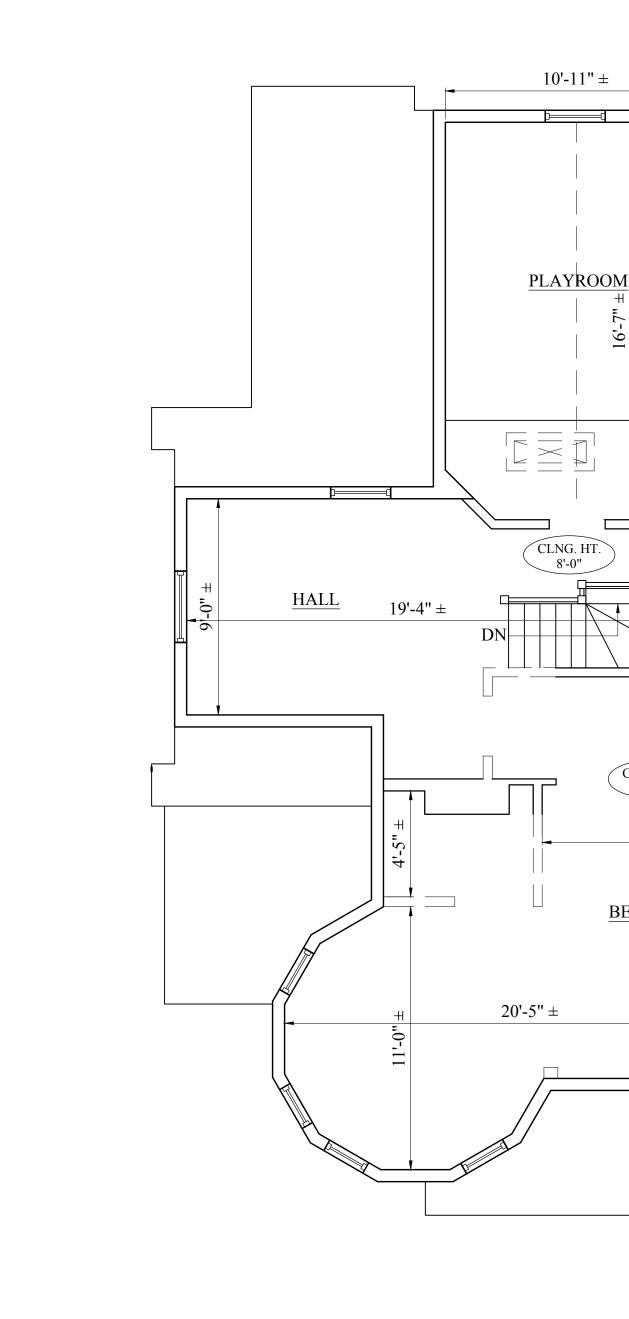






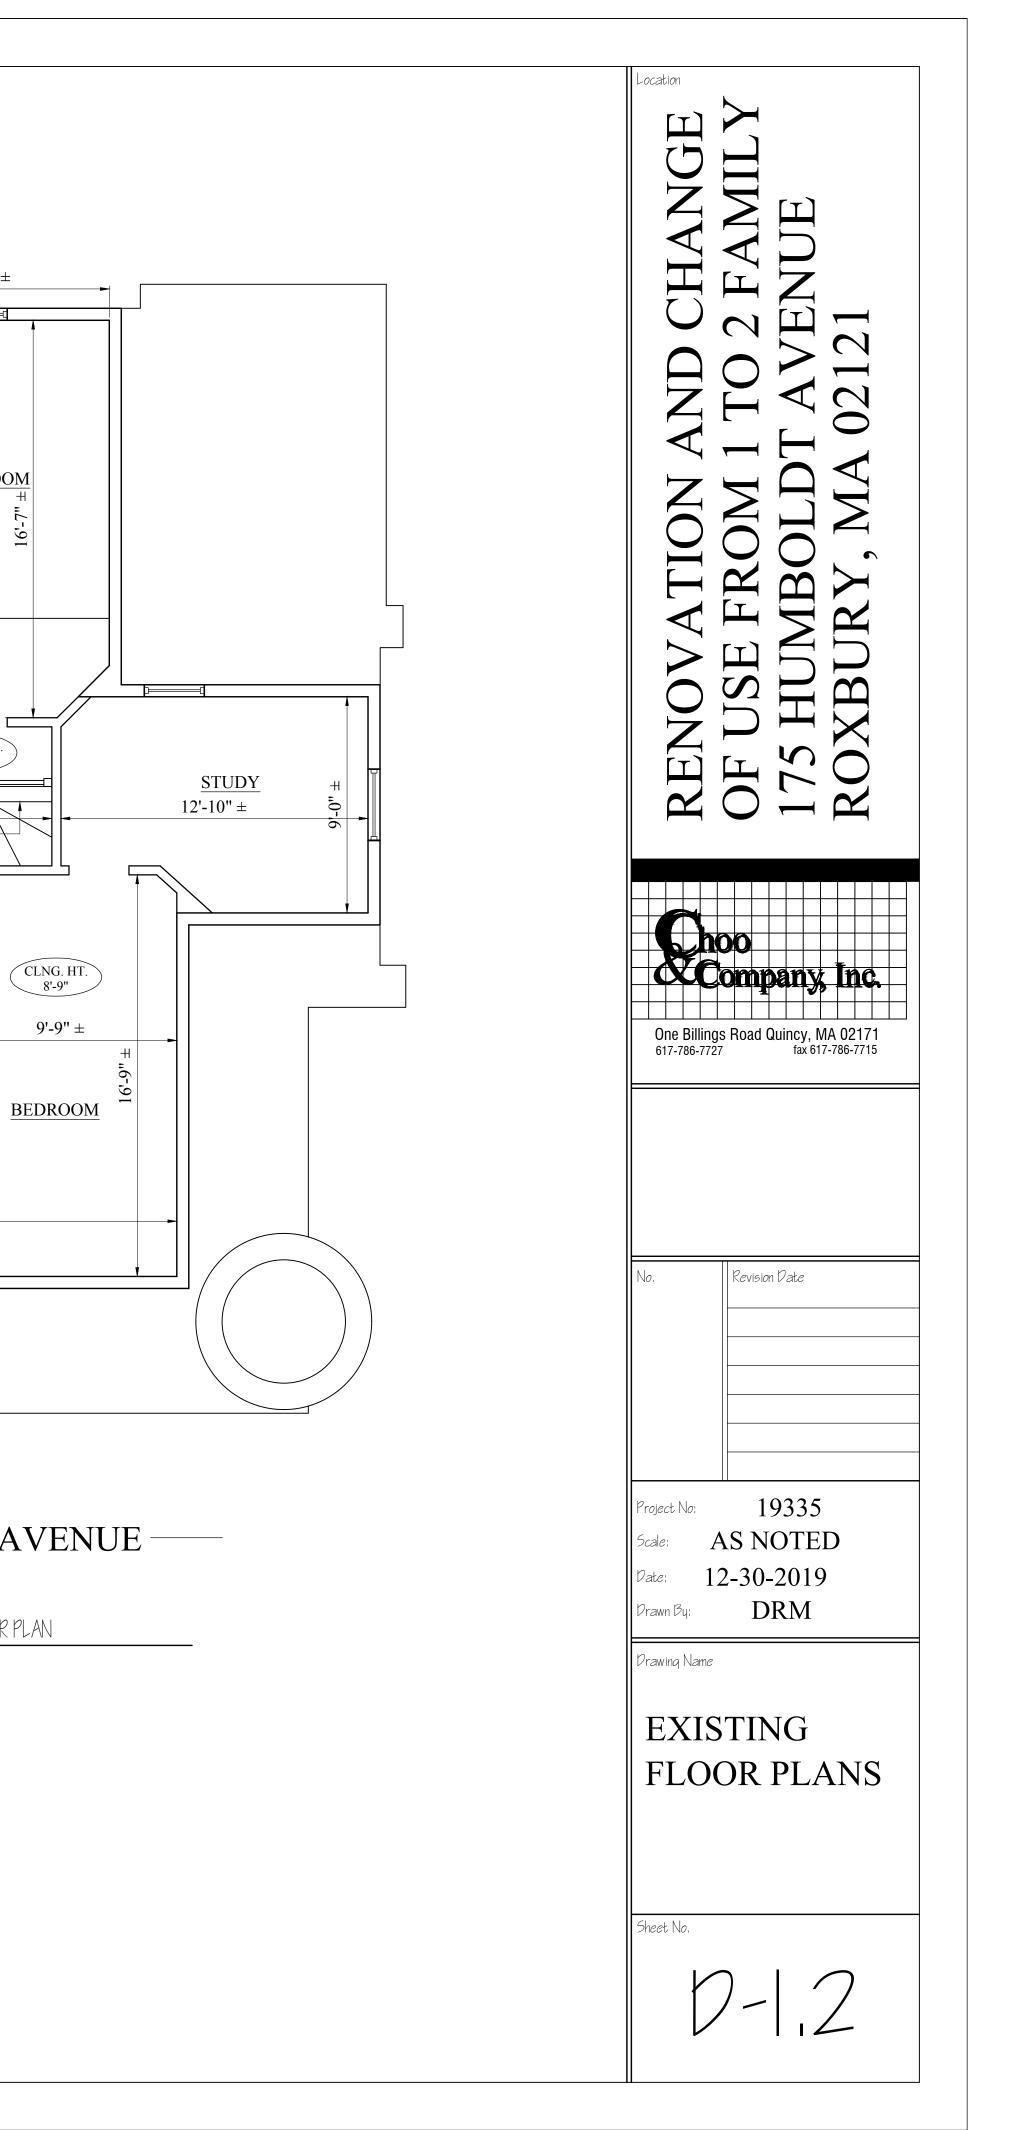

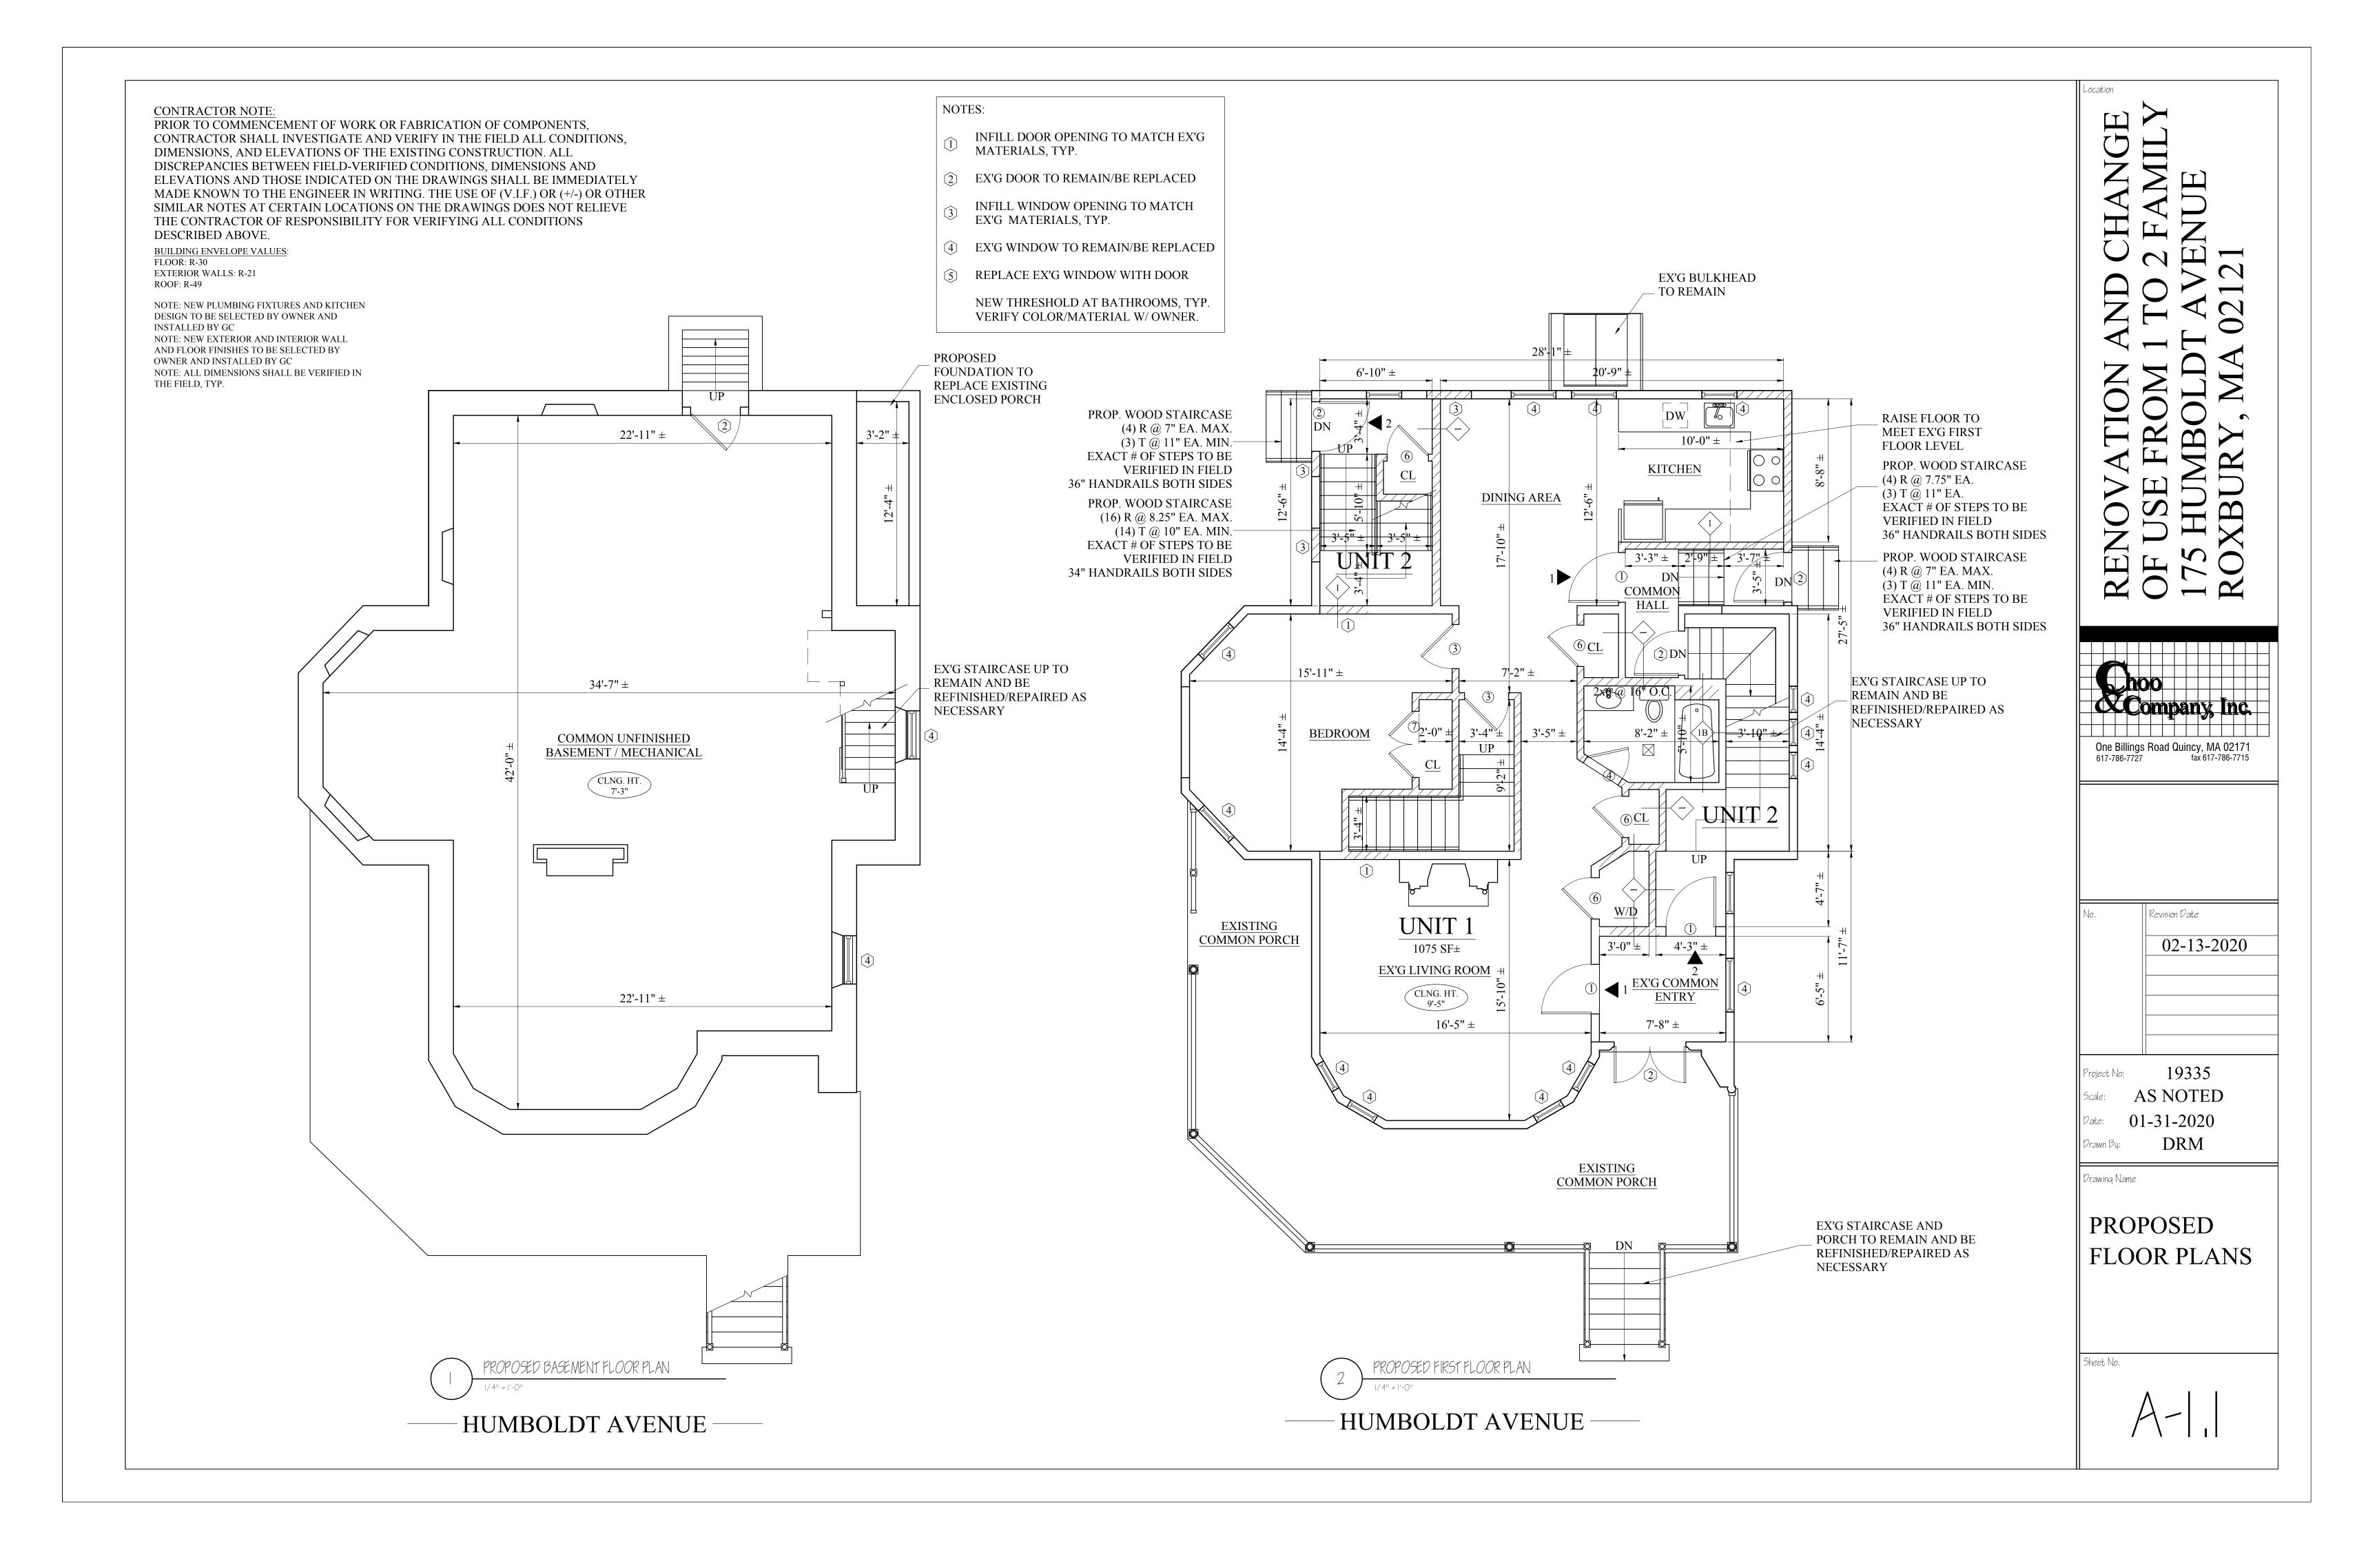

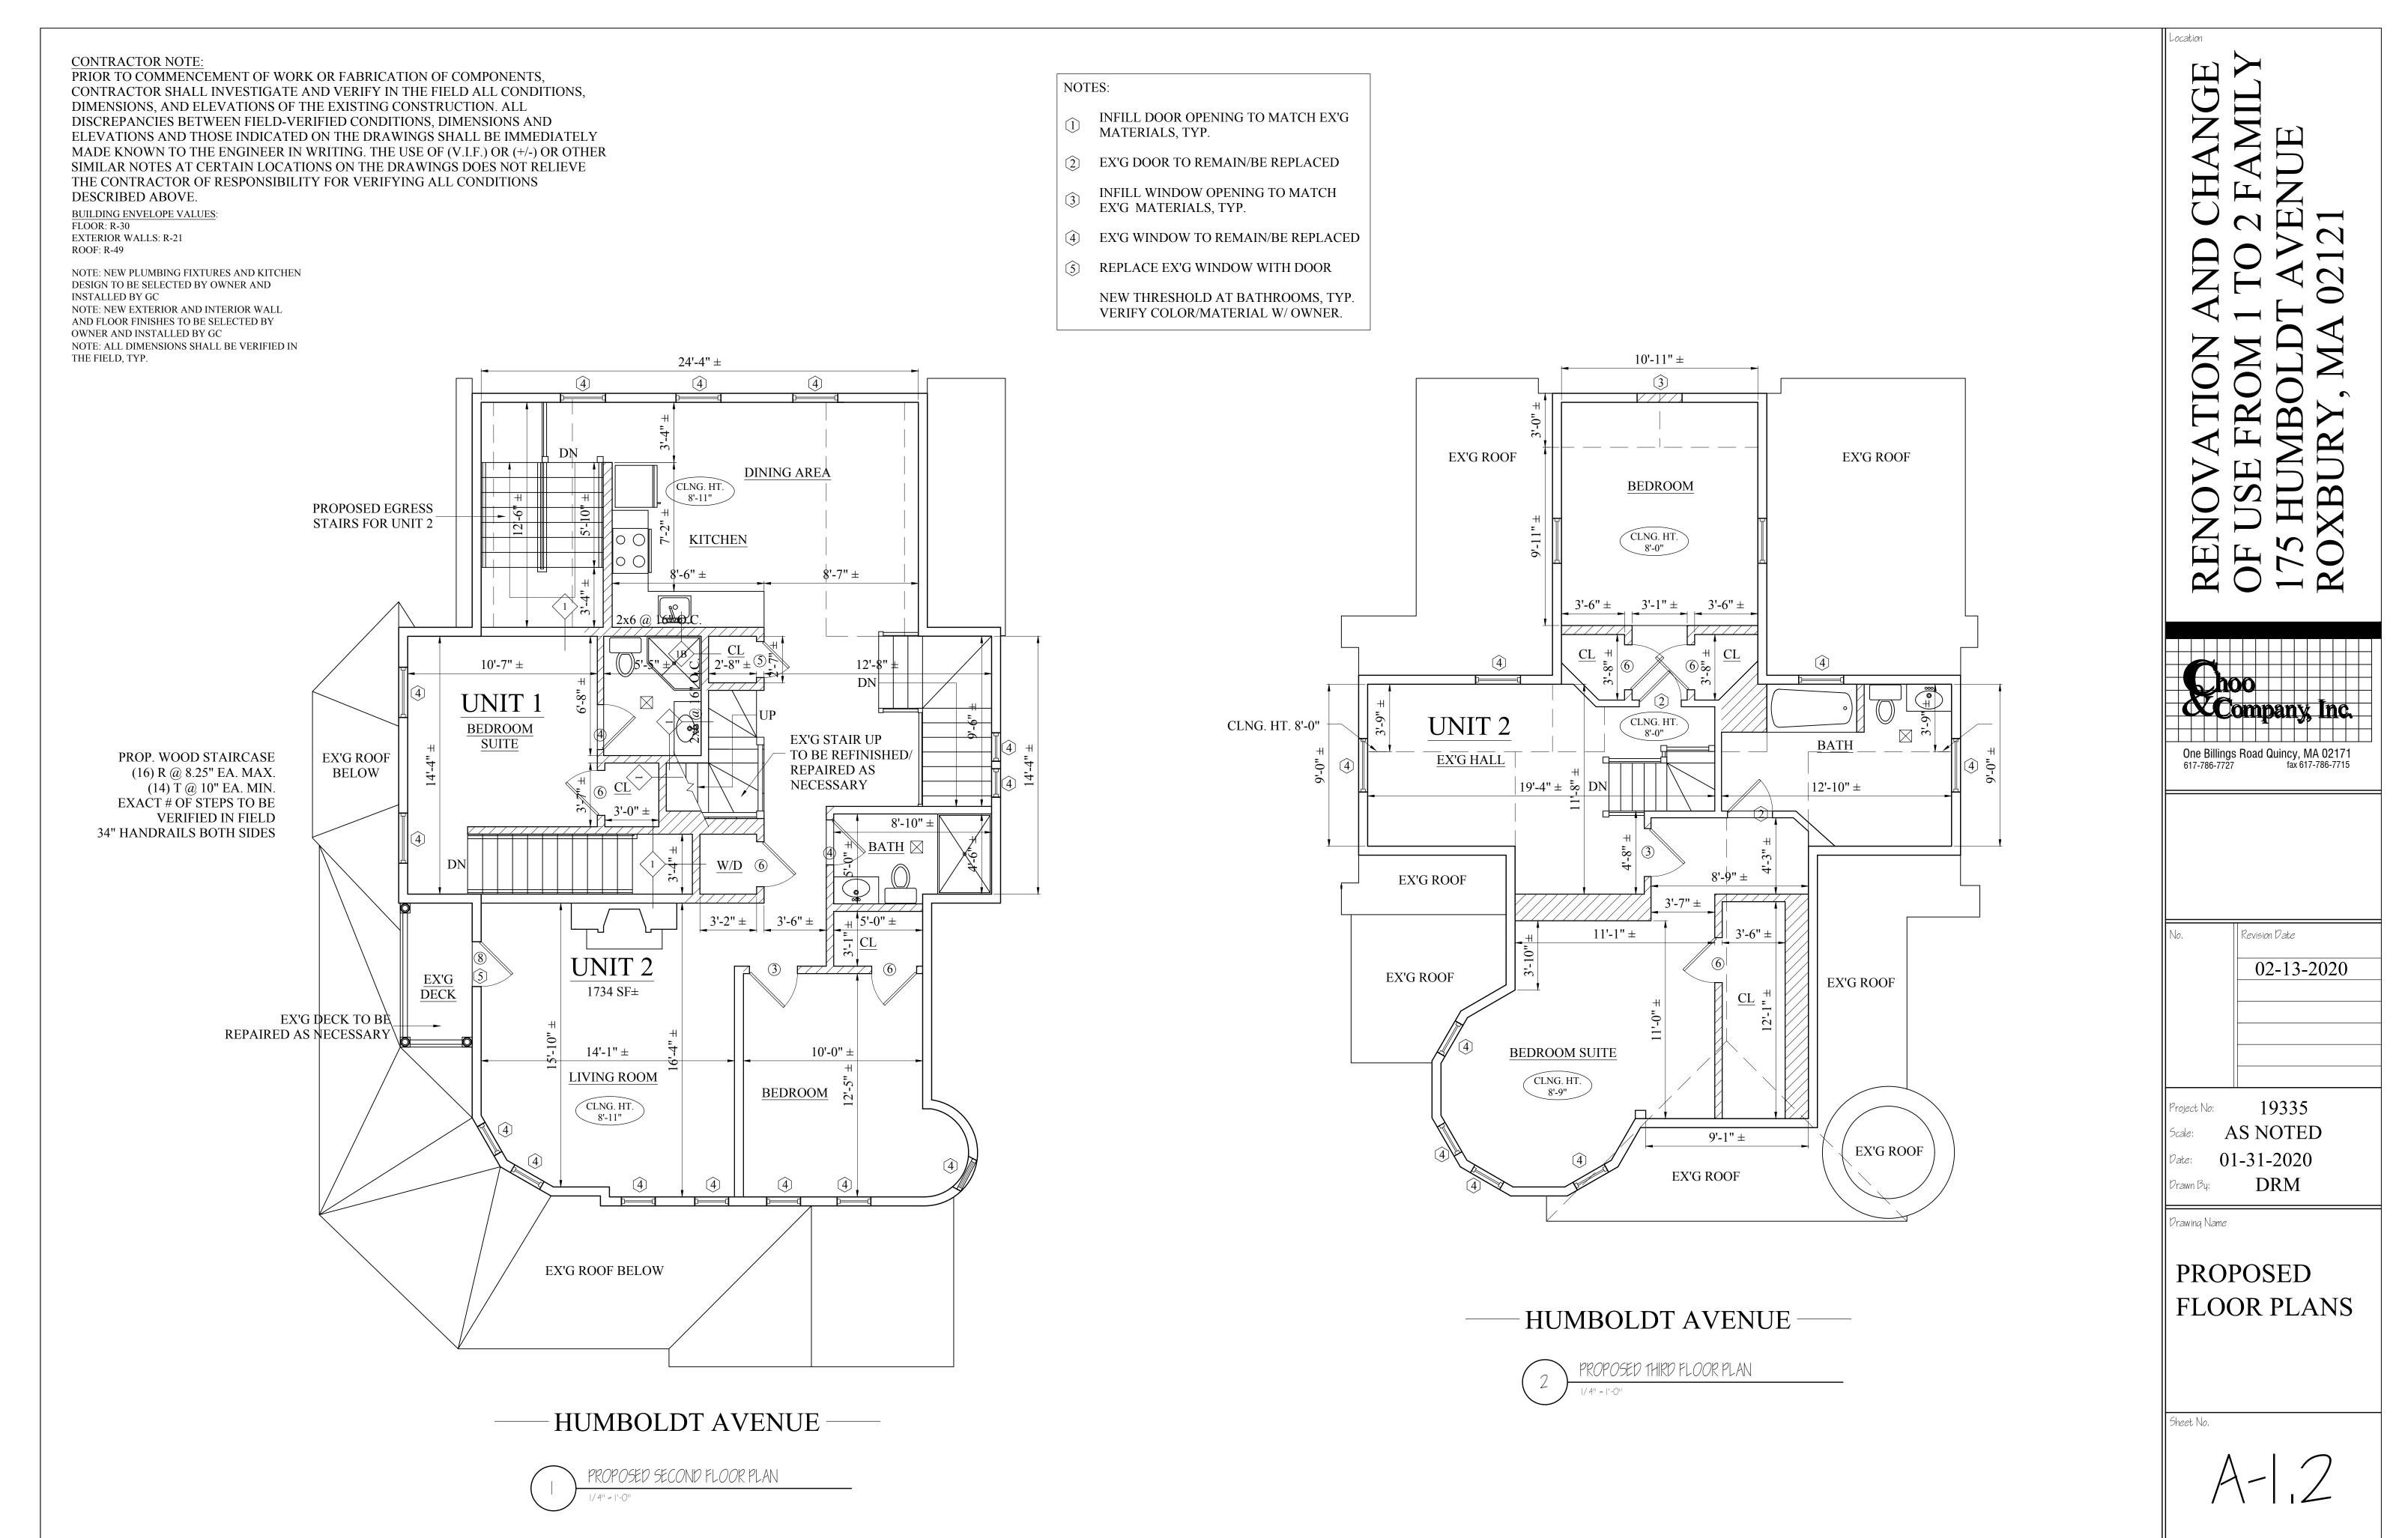


CONTRACTOR NOTE:

PRIOR TO COMMENCEMENT OF WORK OR FABRICATION OF COMPONENTS, CONTRACTOR SHALL INVESTIGATE AND VERIFY IN THE FIELD ALL CONDITIONS, DIMENSIONS, AND ELEVATIONS OF THE EXISTING CONSTRUCTION. ALL DISCREPANCIES BETWEEN FIELD-VERIFIED CONDITIONS, DIMENSIONS AND ELEVATIONS AND THOSE INDICATED ON THE DRAWINGS SHALL BE IMMEDIATELY MADE KNOWN TO THE ENGINEER IN WRITING. THE USE OF (V.I.F.) OR (+/-) OR OTHER SIMILAR NOTES AT CERTAIN LOCATIONS ON THE DRAWINGS DOES NOT RELIEVE THE CONTRACTOR OF RESPONSIBILITY FOR VERIFYING ALL CONDITIONS DESCRIBED ABOVE.

BUILDING ENVELOPE VALUES: FLOOR: R-30 EXTERIOR WALLS: R-21 ROOF: R-49

NOTE: NEW PLUMBING FIXTURES AND KITCHEN DESIGN TO BE SELECTED BY OWNER AND INSTALLED BY GC NOTE: NEW EXTERIOR AND INTERIOR WALL AND FLOOR FINISHES TO BE SELECTED BY OWNER AND INSTALLED BY GC NOTE: ALL DIMENSIONS SHALL BE VERIFIED IN THE FIELD, TYP.

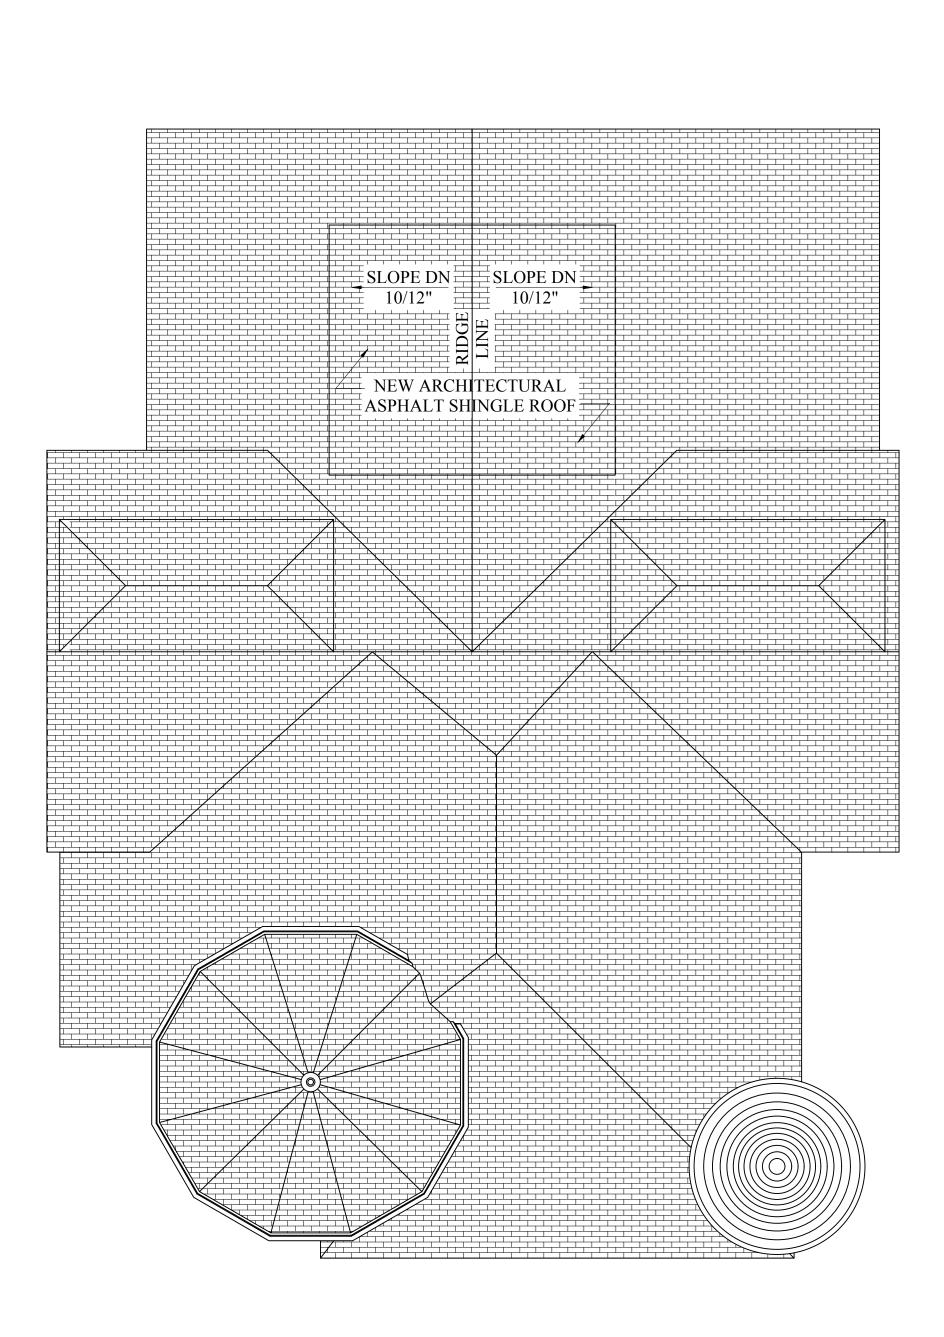


- HUMBOLDT AVENUE ------

|/4"' = |'-0"



PROPOSED THIRD FLOOR PLAN

RENOVATION AND CHANGE OF USE FROM 1 TO 2 FAMILY 175 HUMBOLDT AVENUE ROXBURY, MA 02121					
Company, Inc. One Billings Road Quincy, MA 02171 617-786-7727 fax 617-786-7715					
No. Revision Date					
Scale: AS NOTED Pate: 01-31-2020 Drawn By: DRM Drawing Name PROPOSED FLOOR PLANS					
Sheet No. A-J3					

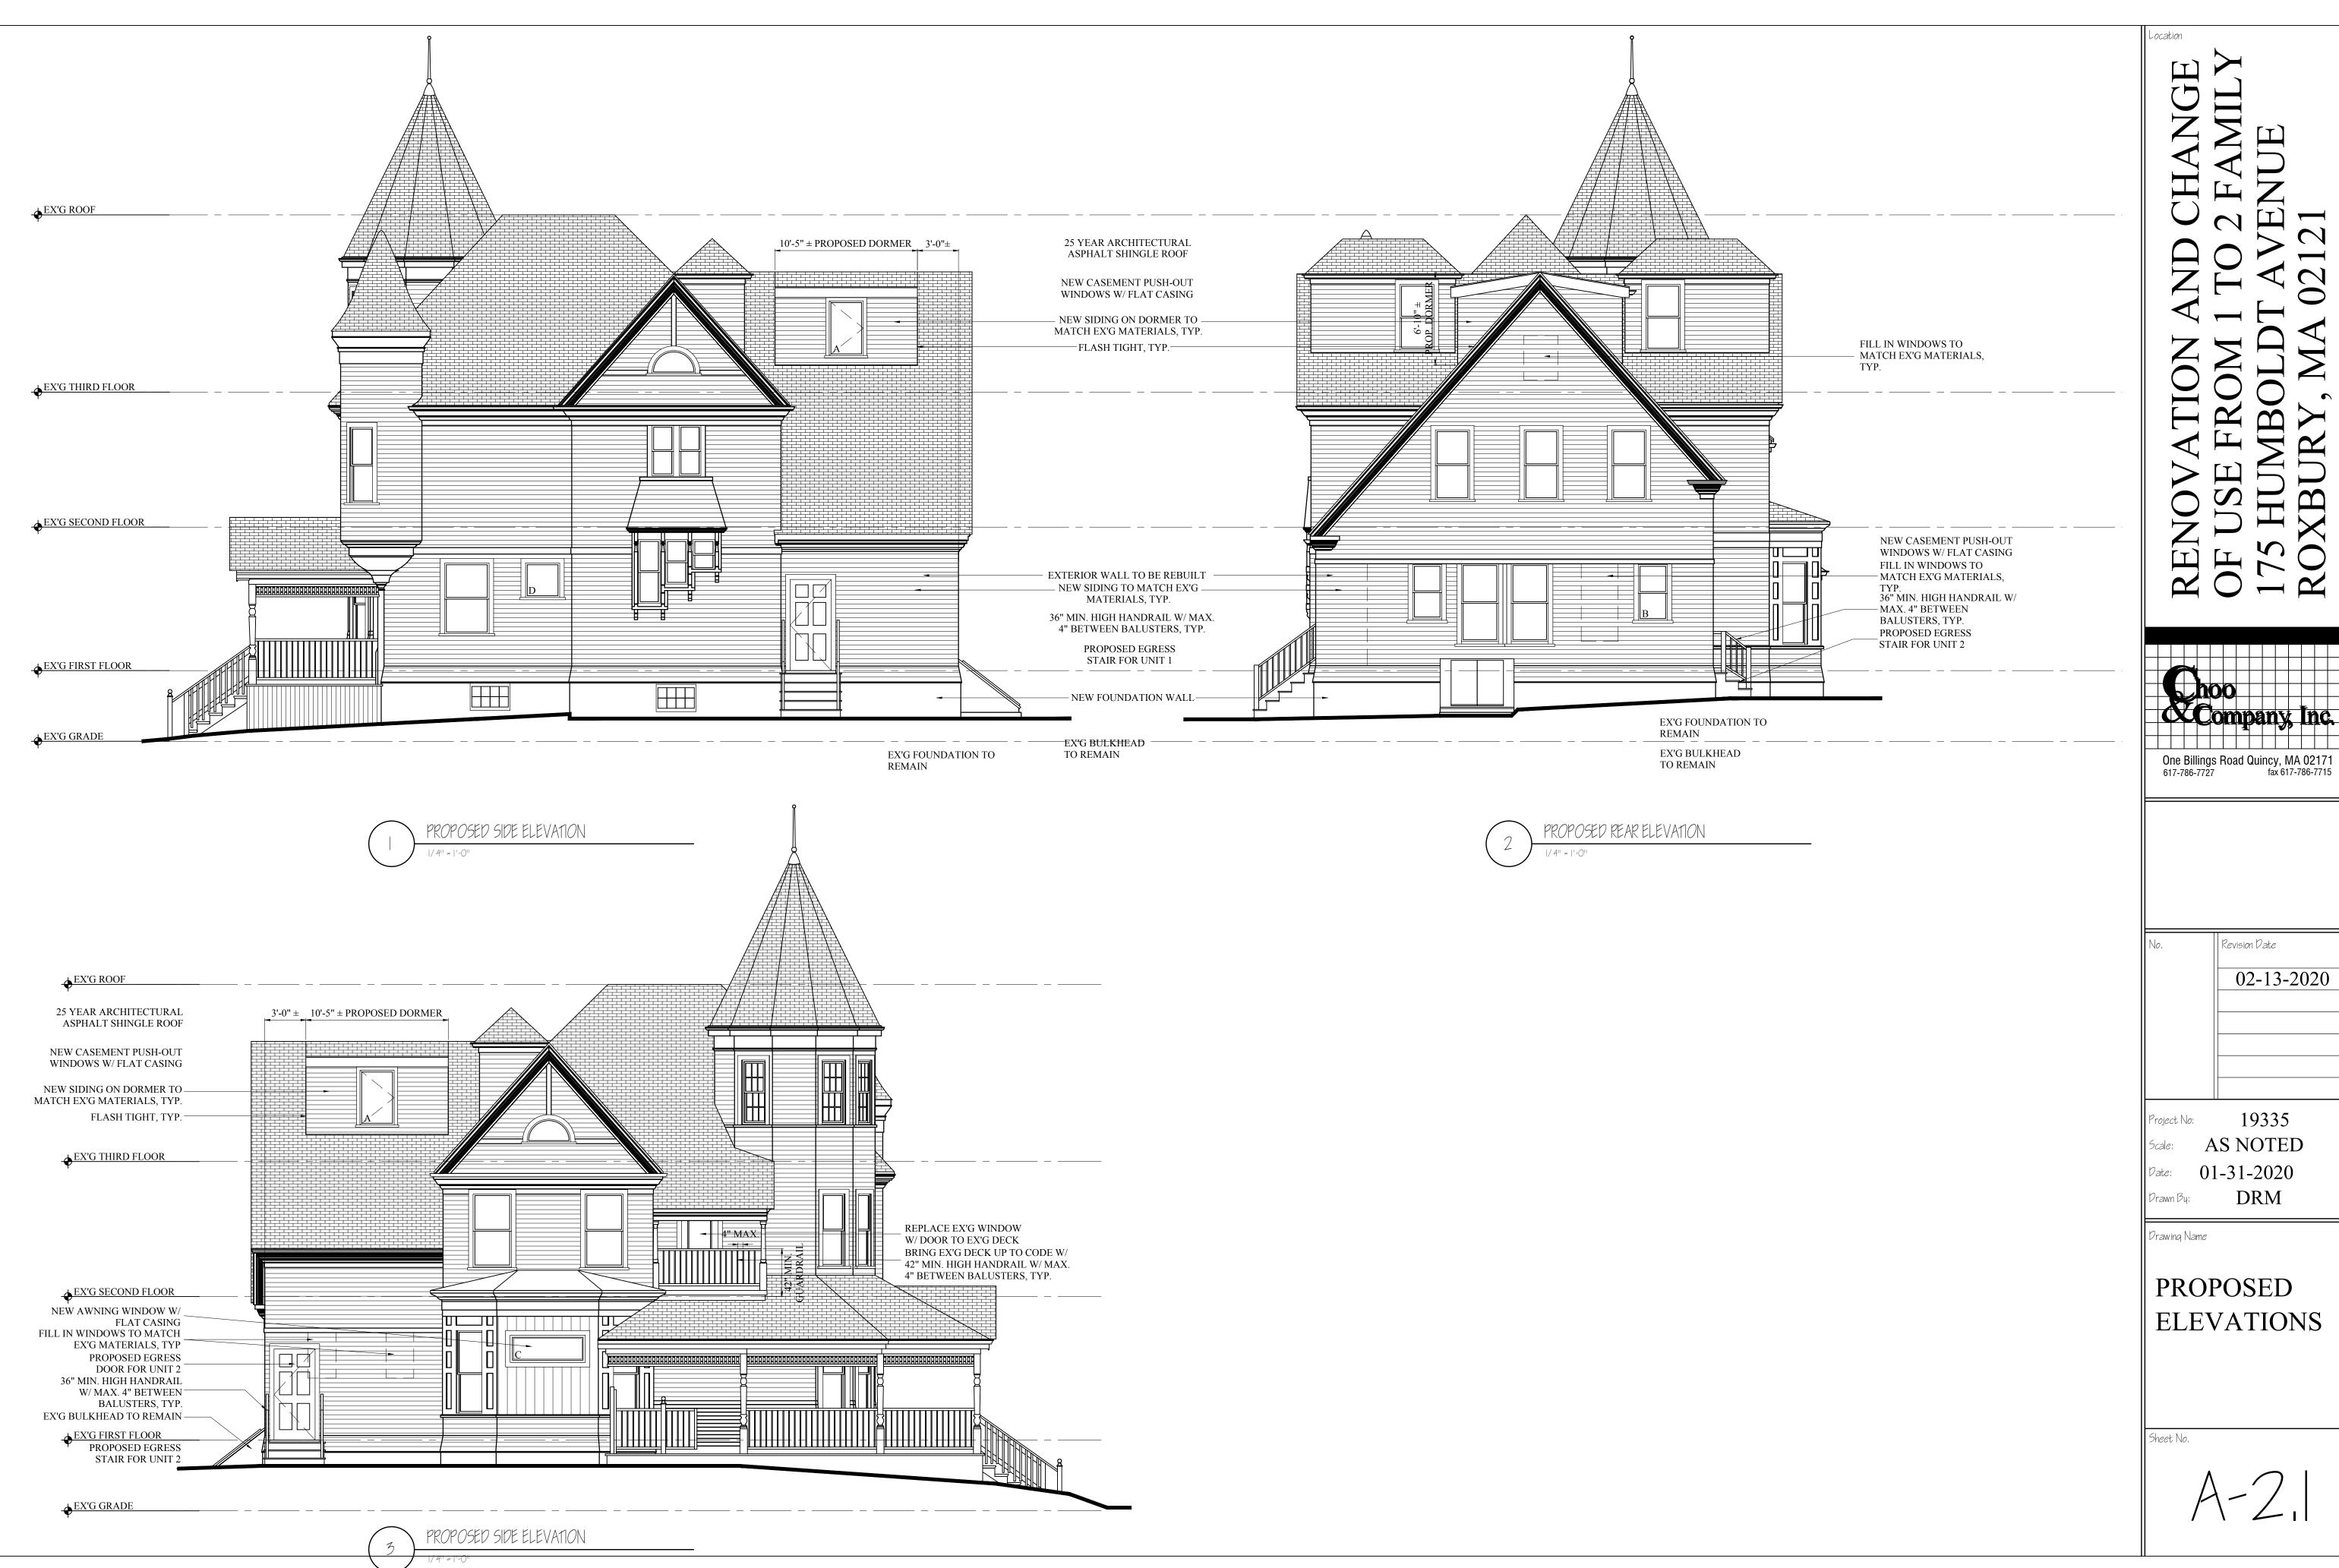

WINDOW SCHEDULE


NO.	MANUFACTURER	MODEL	# NEEDED	R.O.	SILL HEIGHT	HEAD HEIGHT	REMARKS
А	MARVIN OR SIM.	CUPCA2848E	2	2'-5" x 3'-11 5/8"	2'-8" ±	6'-8" ±	CASEMENT PUSHOUT, 4" V
В	MARVIN OR SIM.	CUDH-NG2020	1	2'-2 1/4" x 4'-0"	3'-8" ±	7'-9" ±	DOUBLE HUNG, 4" WOOD
C	MARVIN OR SIM.	CUAWN6424	2	5'-5" x 1'-11 5/8"	5'-8" ±	7'-9"±	AWNING FIXED PANE, 4" V
D	MARVIN OR SIM.	CUAWN3032	1	2'-7" x 2'-7 5/8"	5'-2" ±	7'-9"±	AWNING FIXED PANE, 4" V

* GC IS RESPONSIBLE FOR VERIFYING SIZES & QUANTITIES IN THE FIELD PRIOR TO ORDERING

* PROVIDE HALF SCREENS ON TRACKS, WHITE FINISH HARDWARE, COLOR SELECTED BY OWNER

WINDOW NOTES:

- 1. ALL WINDOWS ARE BASED ON MARVIN WINDOW OR EQUAL MEASUREMENTS
- GLAZING TO BE LOW-E TYPE
- DIMENSIONS SHOWN ARE BASED ON ROUGH OPENINGS. GC TO COORDINATE ROUGH
- 5. PROVIDE WINDOW OPENING CONTROL DEVICE

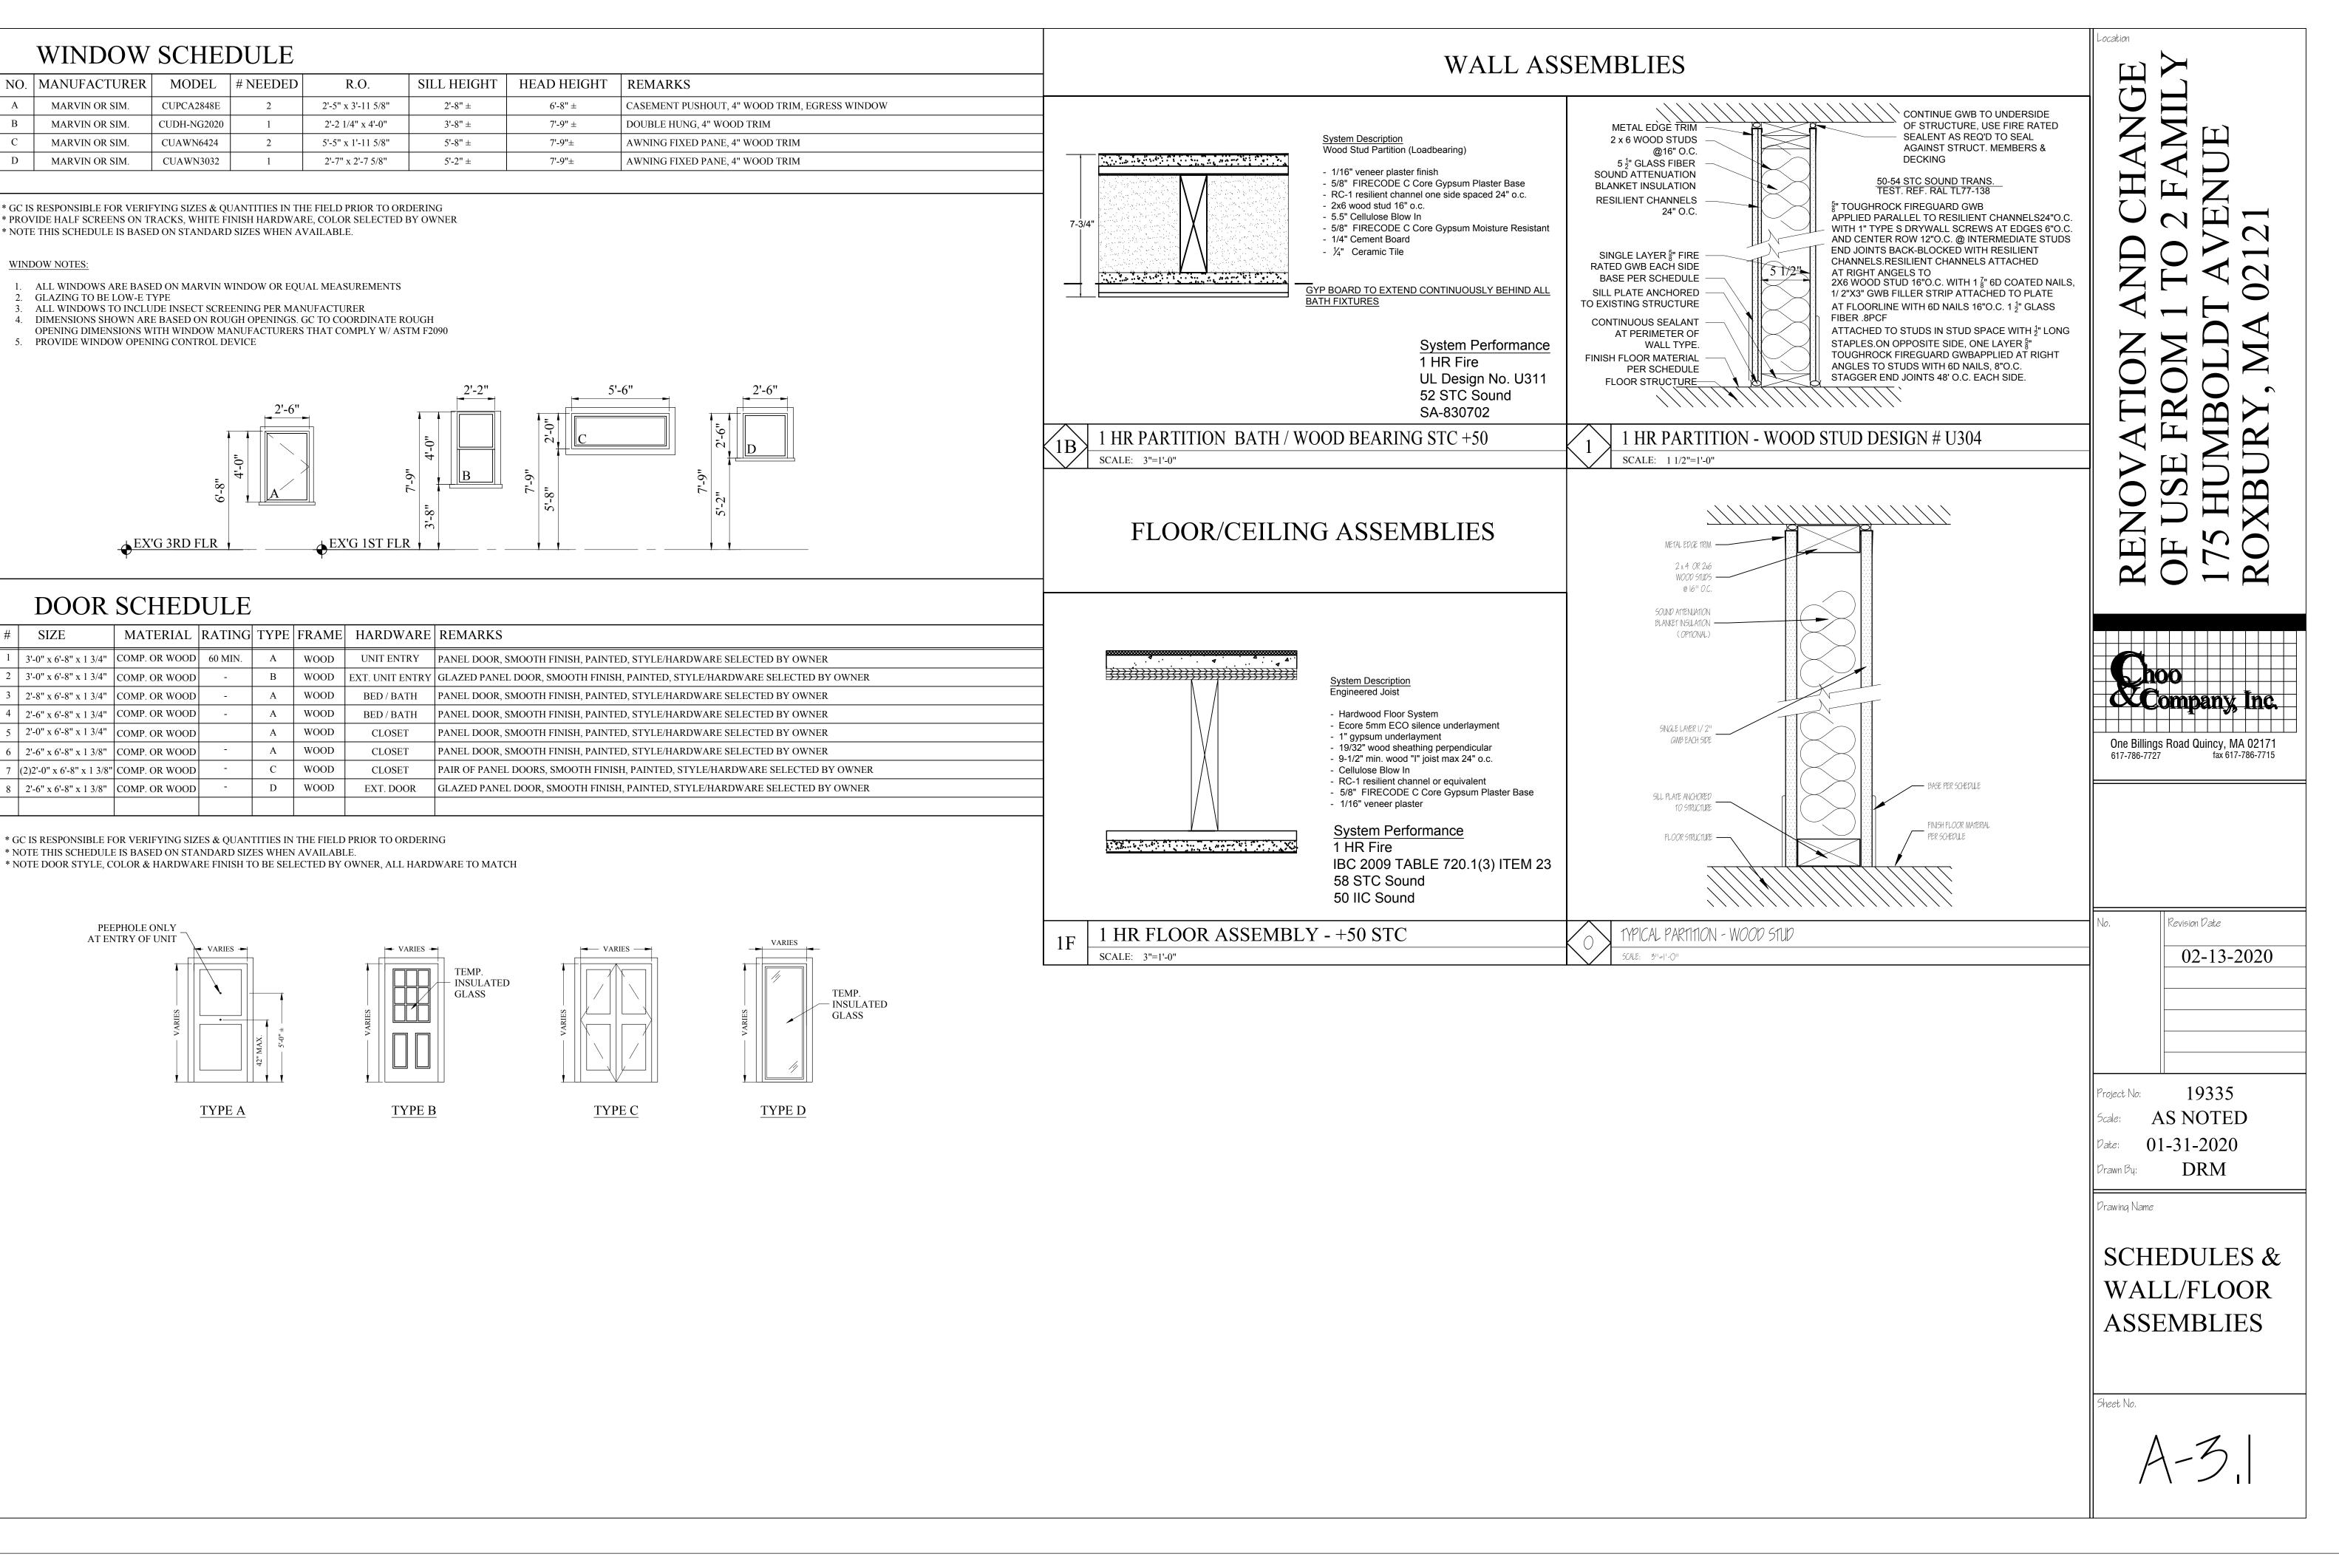



DOOR SCHEDULE


#	SIZE	MATERIAL	RATING	TYPE	FRAME	HARDWARE	REMARKS
1	3'-0" x 6'-8" x 1 3/4"	COMP. OR WOOD	60 MIN.	А	WOOD	UNIT ENTRY	PANEL DOOR, SMOOTH FINISH, PAINTED, STYLE/HARDWARE SELEC
2	3'-0" x 6'-8" x 1 3/4"	COMP. OR WOOD	-	В	WOOD	EXT. UNIT ENTRY	GLAZED PANEL DOOR, SMOOTH FINISH, PAINTED, STYLE/HARDWA
3	2'-8" x 6'-8" x 1 3/4"	COMP. OR WOOD	-	А	WOOD	BED / BATH	PANEL DOOR, SMOOTH FINISH, PAINTED, STYLE/HARDWARE SELEC
4	2'-6" x 6'-8" x 1 3/4"	COMP. OR WOOD	-	А	WOOD	BED / BATH	PANEL DOOR, SMOOTH FINISH, PAINTED, STYLE/HARDWARE SELEC
5	2'-0" x 6'-8" x 1 3/4"	COMP. OR WOOD		А	WOOD	CLOSET	PANEL DOOR, SMOOTH FINISH, PAINTED, STYLE/HARDWARE SELEC
6	2'-6" x 6'-8" x 1 3/8"	COMP. OR WOOD	-	А	WOOD	CLOSET	PANEL DOOR, SMOOTH FINISH, PAINTED, STYLE/HARDWARE SELEC
7	(2)2'-0" x 6'-8" x 1 3/8"	COMP. OR WOOD	-	С	WOOD	CLOSET	PAIR OF PANEL DOORS, SMOOTH FINISH, PAINTED, STYLE/HARDWA
8	2'-6" x 6'-8" x 1 3/8"	COMP. OR WOOD	-	D	WOOD	EXT. DOOR	GLAZED PANEL DOOR, SMOOTH FINISH, PAINTED, STYLE/HARDWA


* GC IS RESPONSIBLE FOR VERIFYING SIZES & QUANTITIES IN THE FIELD PRIOR TO ORDERING


* NOTE DOOR STYLE, COLOR & HARDWARE FINISH TO BE SELECTED BY OWNER, ALL HARDWARE TO MATCH

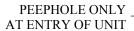

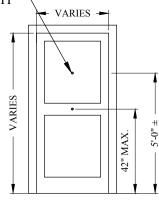


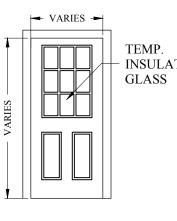

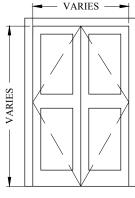

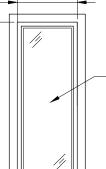

BUILDING ELEMENT	NAIL SIZE AND TYPE	NUMBER AND LOCATION	
STUD TO SOLE PLATE	8P COMMON	4 TOE-NAIL OR 2 DIRECT-NAIL	
STUD TO CAP PLATE	16P COMMON 16P COMMON	2 TOE-NAIL OR 2 DIRECT-NAIL	
DUBLE STUDS	IOP COMMON	12" O.C. DIRECT	
CORNER STUDS	IGD COMMON	24 ¹¹ O.C. DIRECT	
SOLE PLATE TO JOIST OR BLOCKING	IGD COMMON	16" O.C. DIRECT	
DOUBLE CAP PLATE	IOP COMMON	16" O.C. DIRECT	
CAP PLATE LAPS	IOP COMMON	2 DIRECT-NAIL	
RIBBON STRIP, 6'' OR LESS	IOP COMMON	2 EACH DIRECT BEARING	
RIBBON STRIP, 6'' OR MORE	IOP COMMON	3 EACH DIRECT BEARING	
ROOF RAFTER TO PLATE		3 TOE-NAIL	
JACK RAFTER TO RIDGE	1612 COMMON	2 TOE-NAIL OR DIRECT-NAIL	
JACK RAFTER 10 HIP	IOP COMMON IGP COMMON	3 TOE-NAIL OR 2 DIRECT-NAIL	
FLOOR JOISTS TO STUDS (NO CEILING JOISTS)	IOP COMMON IOP COMMON	5 DIRECT OR 3 DIRECT	
FLOOR JOISTS TO STUDS (WITH CEILING JOISTS)	IOP COMMON	2 DIRECT	
FLOOR JOISTS TO SILL OR GIRDER	3D COMMON	3 TOE-NAIL	
LEDGER STRIP	IGP COMMON	3 EACH DIRECT	
CEILING JOISTS TO PLATE	160 COMMON	3 TOE-NAIL	
CEILING JOISTS (LAPS OVER PARTITION)	IOD COMMON	3 DIRECT-NAIL	
CEILING JOISTS (PARALLEL TO RAFTER)	IOD COMMON	3 DIRECT	
COLLAR BEAM	IOD COMMON	3 DIRECT	
BRIDGING TO JOISTS	87 COMMON	2 EACH DIRECT END	
DIAGONAL BRACE (TO STUD AND PLATE)	87 COMMON	2 EACH DIRECT BEARING	
TAIL BEAMS TO HEADERS (WHEN NAILING PERMITTED)	20D COMMON	I EACH END 4 SQ. FT. FLOOR AREA	
HEADER BEAMS TO TRIMMERS	20D COMMON	I EACHEND 8 5Q, FT, FLOOR AREA	
I'' ROOF DECKING (OVER 6'' IN WIDTH)	817 COMMON 817 COMMON	2 EACH DIRECT RAFTER 3 EACH DIRECT RAFTER	
1" SUBFLOORING (6" OR LESS)	BP COMMON	2 EACH DIRECT JOIST	
I'' SUBFLOORING (8'' OR MORE)	BP COMMON	3 EACH DIRECT JOIST	
211 SUBFLOORING	IGP COMMON	2 EACH DIRECT JOIST	
I'' WALL SHEATHING (8'' OR LESS IN MIDTH)	BP COMMON	2 EACH DIRECT STUD	
I'' WALL SHEATHING (OVER 8'' IN WIDTH)	8p common	3 EACH DIRECT STUD	
PLYWOOD ROOF & WALL SHEATHING (1/2" OR LESS) (5/8" OR GREATER) (5/16",3/8", OR 1/2")	6D COMMON 8D COMMON 16 GALGE GALVANIZED WIRE STAPLES, 3/8'' MINIMUM CROWN; LENGTH OF I'' PLUS PLYWOOD THICKNESS	6" O.C. DIRECT EDGES & 12" O.C. INTERMEDIATE 6" O.C. DIRECT EDGES & 12" O.C. INTERMEDIATE 4" O.C. EDGES & 8" O.C. INTERMEDIATE	
(OVER 6" IN WIDTH) PLYWOOD SUBFLOORING	SAME AS IMMEDIATELY ABOVE	2 1 / 2" O.C. EDGES & 5" O.C. INTERMEDIATE	
(1/2") (3/8", 3/4") (1",11/8")	6D COMMON OR 6D ANNULAR OR SPIRAL THREAD 8D COMMON OR 8D ANNULAR OR SPIRAL THREAD 10D COMMON OR 8D RING SHANK OR 8D ANNULAR OR SPIRAL THREAD	6" O.C. DIRECT EDGES & 10" O.C. INTERMEDIATE 6" O.C. DIRECT EDGES & 10" O.C. INTERMEDIATE 6" O.C. DIRECT EDGES & 6" O.C. INTERMEDIATE	
(1/2") (3/8")	16D GALVANIZED WIRE STAPLES 3/8'' MINIMUM CROWN; 13/8' LENGTH	4'' O.C. EDGES & 7'' O.C. INTERMEDIATE 2 1/2'' O.C. EDGES & 4'' O.C. INTERMEDIATE	
BUILT-UP GIRDERS AND BEAMS	200 COMMON	32" O.C. DIRECT	
CONTINUOUS HEADER TO STUD	8D COMMON	4 TOE-NAIL	
CONTINUOUS HEADER, TWO PIECES	IGD COMMON	16" O.C. DIRECT	
1 / 2'' FIBER BOARD SHEATHING 25 / 32'' FIBER BOARD SHEATHING	I I / 2'' GALVANIZED ROOFING NAIL OR 16 GAUGE STAPLE, I I / 2'' LONG WITH MIN. CROWN OF 7/16'' I 3/ 4'' GALVANIZED ROOFING NAIL OR 8D COMMON	3" O.C. EXTERIOR EDGE 6" O.C. INTERMEDIATE 3" O.C. EXTERIOR EDGE 6" O.C. INTERMEDIATE	
297 92 " FIDER DUARD PILATRIINU	NAIL OR 16 GAUGE STAPLE, 11/2" LONG WITH MIN. CROWN OF 7/16"		
GYPSUM SHEATHING	12 GAUGE 1 3/ 4'' LARGE HEAD CORROSION- RESISTANT	4" O.C. EDGE 8" O.C. INTERMEDIATE	
PARTICLE BOARD UNDERLAYMENT (1/4''-3/4'') PARTICLE BOARD ROOF AND WALL SHEATHING	6D ANNULAR THREADED 6D COMMON	6" O.C. DIRECT EDGES 10" O.C. INTERMEDIATE 6" O.C. DIRECT EDGES 12" O.C. INTERMEDIATE	
1/211 OR LESS			
5/8" OR GREATER PARTICLE BOARD SUBFLOORING	8P COMMON 8P COMMON	6" O.C. DIRECT EDGES 12" O.C. INTERMEDIATE 6" O.C. DIRECT EDGES 12" O.C. INTERMEDIATE	
(5/8" OR GREATER)			
SHINGLES, WOOD*	NO. 14 B&S GAGE CORROSION RESISTIVE	2 EACH BEARING	

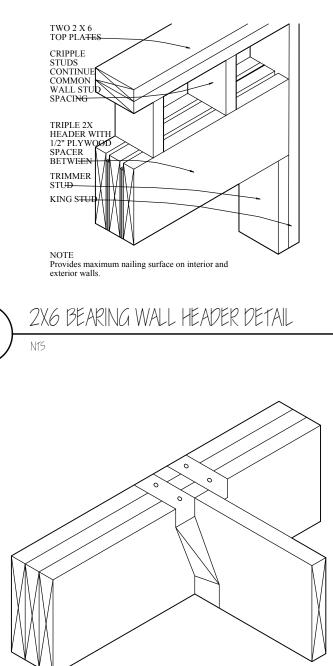



#

NOTE *: SHINGLE NAILS SHALL PENETRATE NOT LESS THAN 3/4" INTO NAILING STRIPS, SHEATHING OR SUPPORTING CONSTRUCTION EXCEPT AS OTHERWISE PROVIDED IN 780 CMR 1225.4.4.

WOOD JOISTS SUPPORTED ON WOOD GIRDERS

