

# **Boston Inspectional Services Department**

### **Planning and Zoning Division**

1010 Massachusetts Avenue, 5th Floor, Boston, MA 02118 Telephone: (617) 635-5300

### MORE INFORMATION REQUEST LETTER

Marc Joseph
Inspector of Buildings

June 25, 2021

FLORRIE MAHONEY 11 HILTON ST HYDE PARK, MA 02136

RE: Application #: ERT1197720

Location: 77A W Milton St, Ward 18

Zoning District: Hyde Park Neighborhood, 1F-6000

Purpose: Erect new single family home on a vacant lot consisting of 7972 sq ft of land.

eplan

The following information shall be provided to Inspectional Services Department to complete the Building Permit Plan Review:


#### 1. City Agencies' Approvals:

- Boston Planning and Development Agency: Two Sets of Approved Drawings: 1 electronic copy. NDOD
- Department of Public Works: curb cut review.
- Environmental Sanitation Department

#### 2. Additional Information/Comments:

- The applicant shall e-mail <a href="ISDPZReview@boston.gov">ISDPZReview@boston.gov</a> copying <a href="Jordi.segalesperez@boston.gov">Jordi.segalesperez@boston.gov</a> after uploading all the requested information and obtaining all the necessary approvals (if requested). Please don't email until <a href="everything">everything</a> requested here is ready. We don't do partial reviews to be more efficient. If you have any questions, the best way to reach me is through email.

All construction documents shall be organized in two sets, submitted together (no partial information will be accepted), and dropped off at Inspectional Services Department with the above referenced application number or re-uploaded on the portal if it is an ePlan application. More information may be required. Please be advised that the time limitation of your application shall be 180 days, otherwise it shall be deemed abandoned per 780 CMR. Thank you for your assistance.

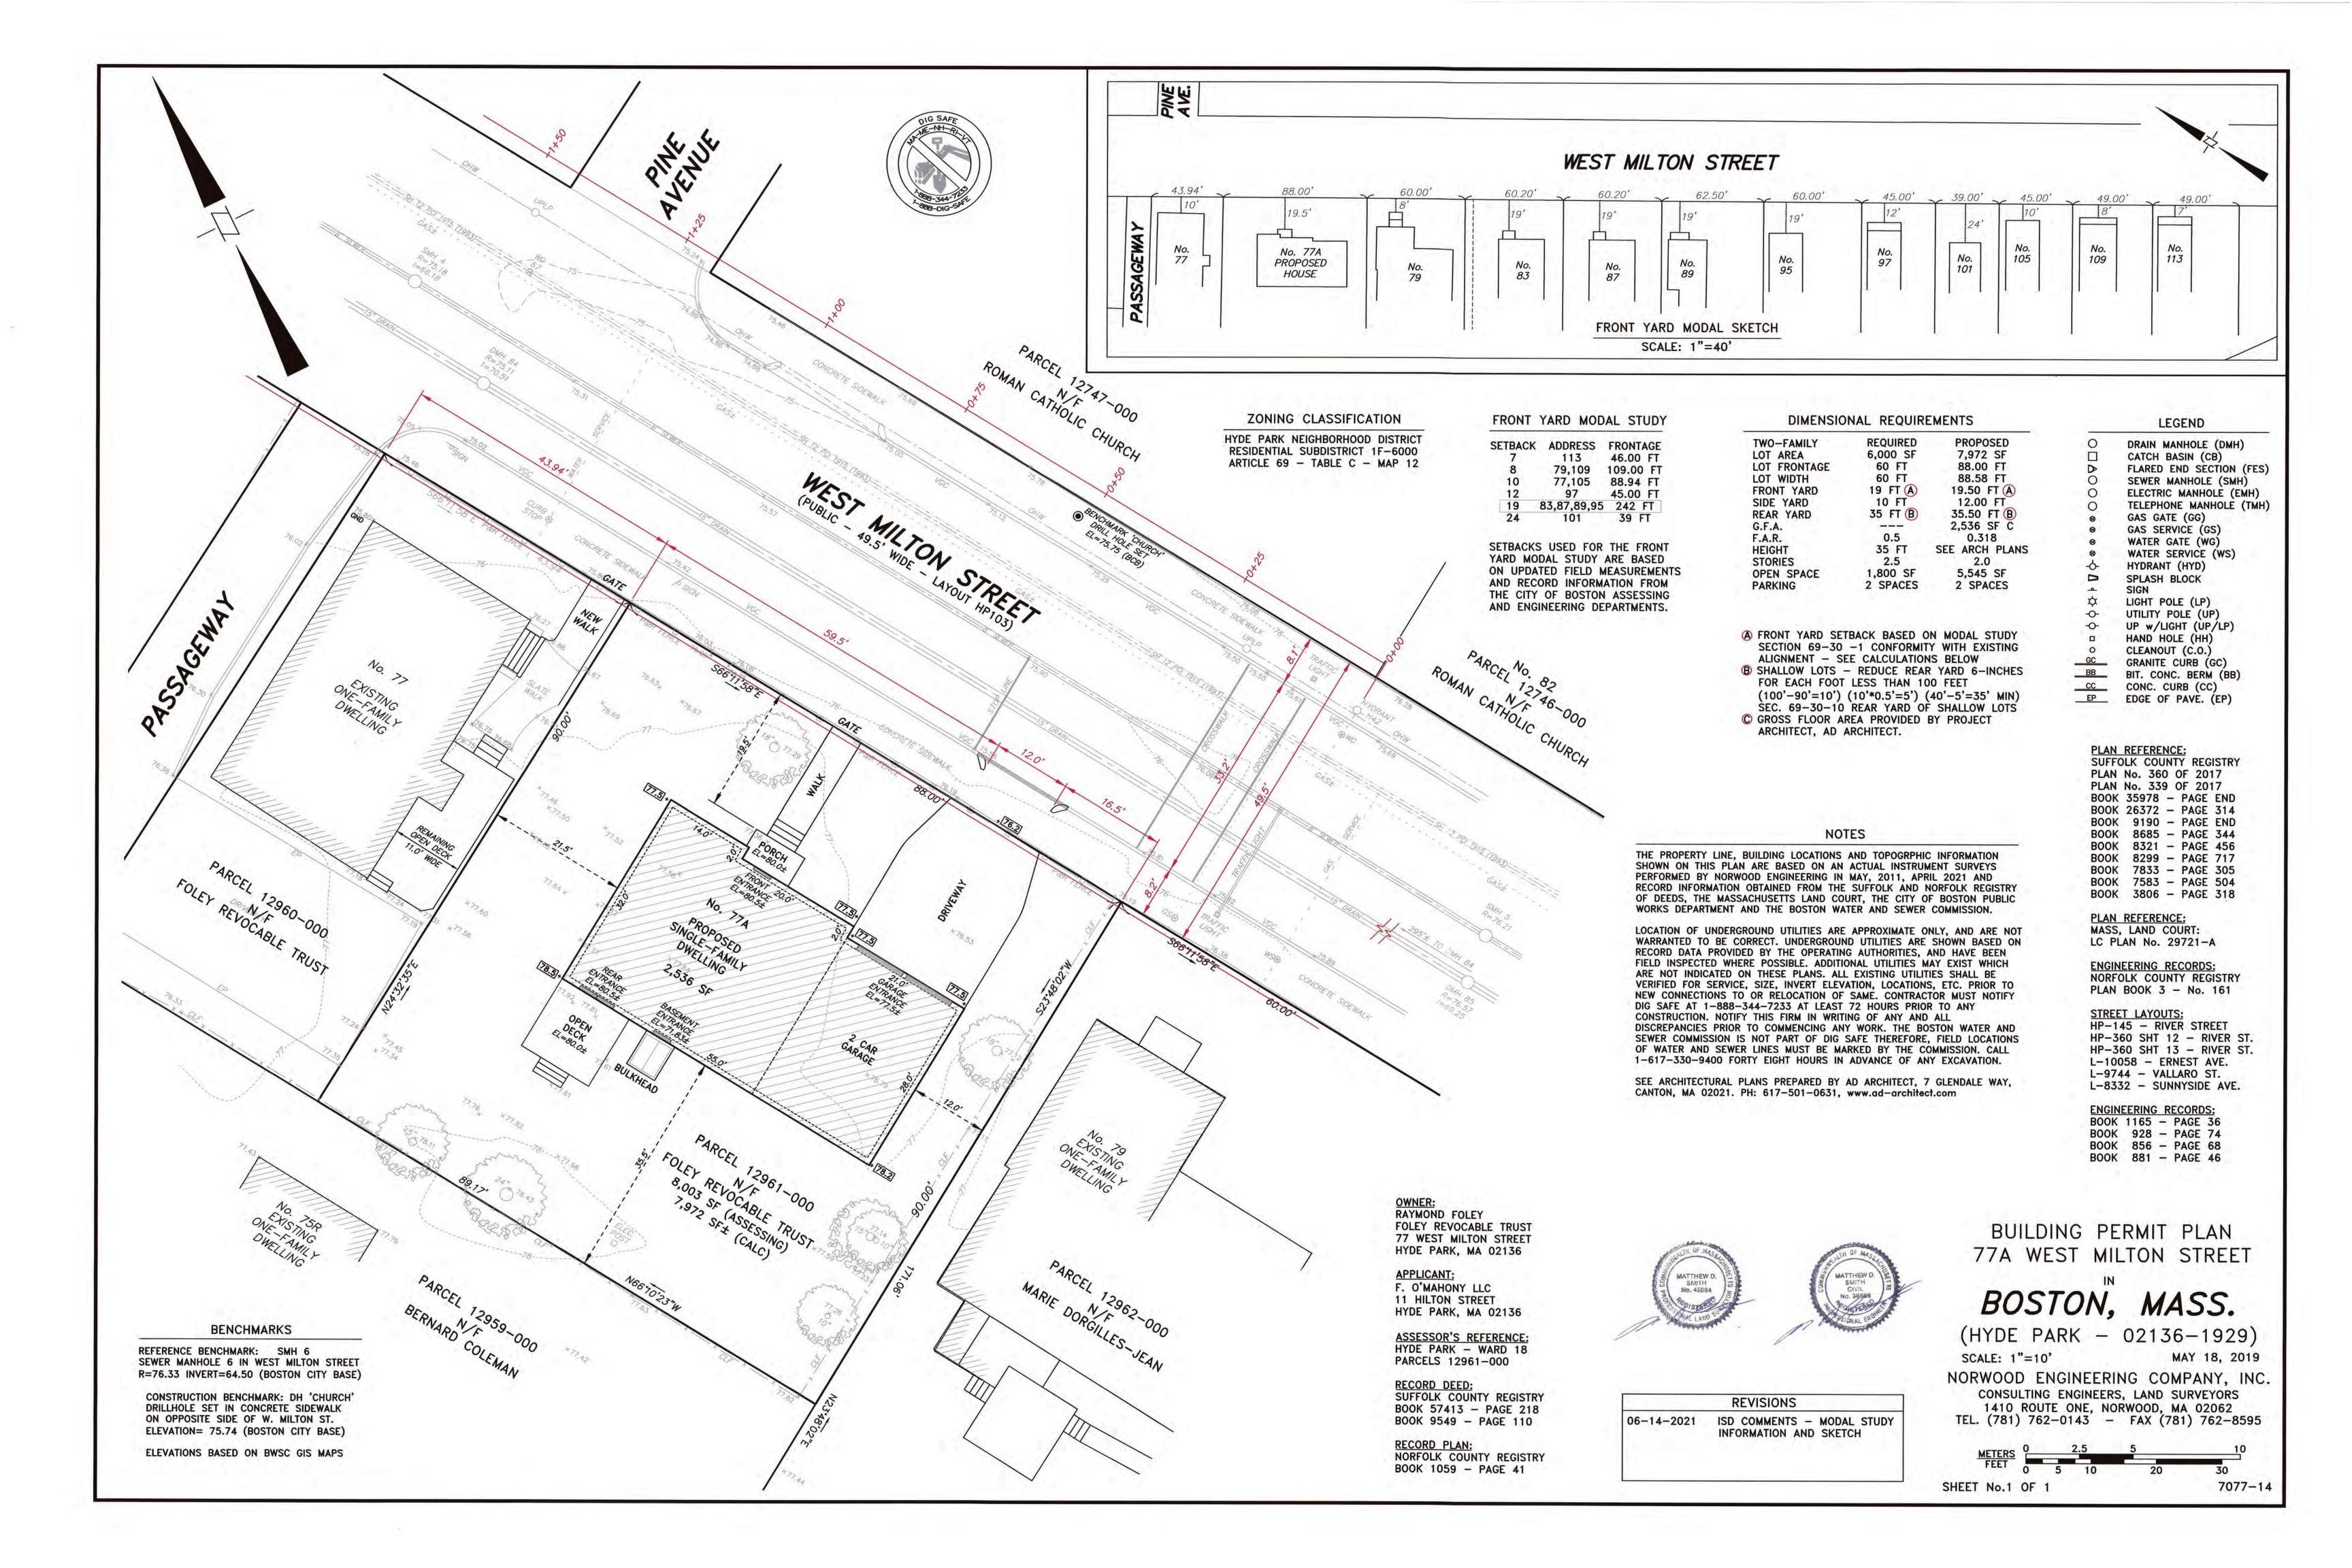

'SC SITE PLAN No.

COURSE


THERE IS 1.214 SQUARE FEET OF IMPERVIOUS AREA ON THE EXISTING LOT. THE PROPOSED IMPERVIOUS AREA ON THE LOT WILL BE APPROXIMATELY 2,337 SQUARE FEET, AN INCREASE 1,123 SQUARE FEET. TO COMPLY WITH THE COMMISSION'S REQUIRED MINIMUM 1" OF STORMWATER STORAGE PER SQUARE FOOT OF IMPERVIOUS AREA THE PROPOSED INFILTRATION SYSTEMS MUST HAVE A COMBINED MINIMUM STORAGE CAPCITY OF 194 CUBIC FEET (1,451 GALLONS).  $(2337 \text{ SF } \times 0.083 \text{ FT} = 193.97 \text{ CF REQ'D, USE } 194 \text{ CF}).$ 


THE TWO CULTEC RECHARGER 150XLHD INFILTRATION SYSTEMS WILL EACH PROVIDE 99.87 CUBIC FEET (747.08 GALLONS) OF STORMWATER STORAGE. THE CAPCITY OF THE TWO SYSTEMS COMBINED WILL BE 199.74 CUBIC FEET (1,494 GALLONS) WITH 1.019 INCHES OF STORMWATER STORAGE PER SQUARE FOOT OF POST-CONSTRUCTION IMPERVIOUS AREA ON THE LOT (1.0 INCH REQ'D).  $(199.74 \text{ CF/2,337 SF}) \times 12 \text{ IN/FT} = 1.026 \text{ IN/SF}$ .

THE STORAGE VOLUME WAS CALCULATED USING THE CULTEC STORMGENIE PROGRAM. THE OVERFLOW OUTLETS OF THE INFILTRATION SYSTEMS ARE SET TO ENSURE THAT THE SYSTEMS REACH THE PROPOSED STORAGE CAPACITY. THE CALCULATED STORAGE CAPACITY OF THE SYSTEM DOES NOT INCLUDE ANY POTENTIAL STORAGE IN THE DRAIN PIPES CONNECTING THE SYSTEMS,

SEE INFILTRATION SYSTEM DETAILS AND ADDITIONAL INFILTRATION NOTES ON SHEET No. 2 OF 2.


### PROPOSED STORMWATER INFILTRATION NOTES

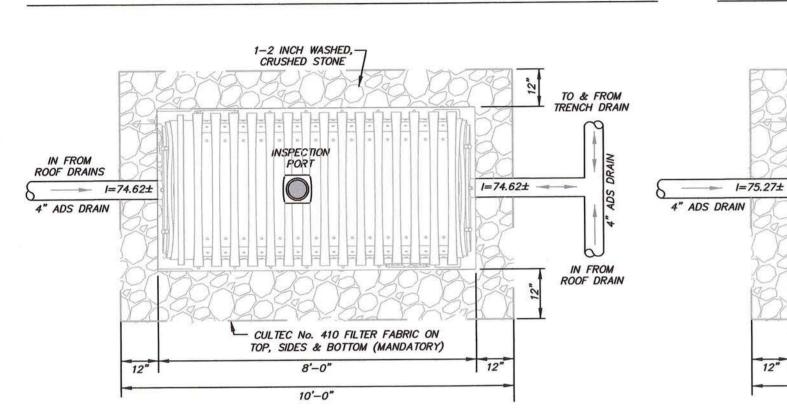

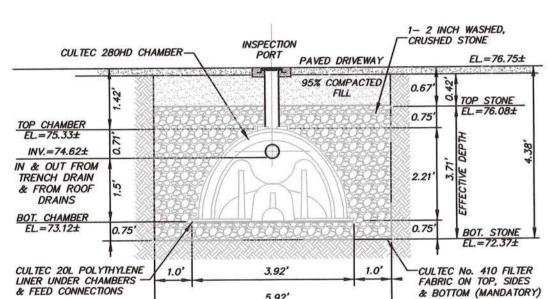


INFILTRATION SYSTEM A CULTEC 280HD CHAMBER (OR EQUAL)


NOT TO SCALE

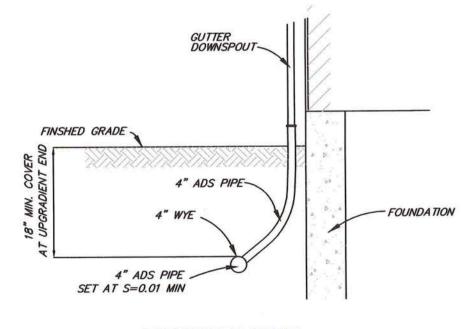

DOWNSPOUT DETAIL NOT TO SCALE

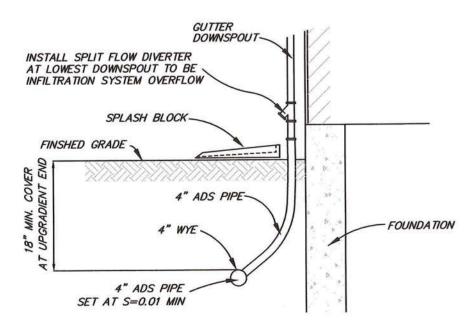


DOWNSPOUT W/ DIVERTER DETAIL NOT TO SCALE

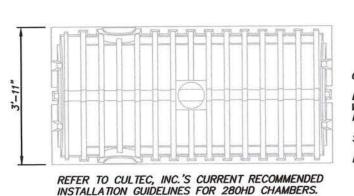

CULTEC RECHARGER 280HD CHAMBER HEIGHT = 2.21 FEET

STORAGE CAPACITY= 8.68 CUBIC FEET

MAXIMUM COVERAGE=14 FEET

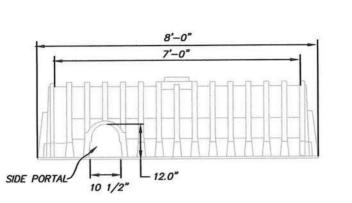

CULTEC 280HD CHAMBER DETAIL

NOT TO SCALE

CULTEC No. 410 FILTER FABRIC ON

5.92'

INFILTRATION SYSTEM B

CULTEC 280HD CHAMBER (OR EQUAL)

NOT TO SCALE

-30° BEND

SIDEWALK

STREET LINE-

10'-0'

CULTEC 280HD

INV.=75.27±

IN & OUT FROM

CULTEC 20L POLYTHYLENE

LINER UNDER CHAMBERS

& FEED CONNECTIONS

30° BEND -

SEWER SERVICE

STREET LINE

SIDEWALK-

- STREET LINE

TRENCH DRAIN


& FROM ROOF DRAINS

TOP, SIDES & BOTTOM (MANDATORY)

95% COMPACTED

CRUSHED STONE

PORT

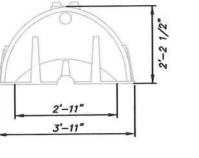

DIVERTER

I=75.27±

1— 2 INCH WASHED, CRUSHED STONE

-CULTEC No. 410 FILTER FABRIC ON TOP, SIDES

& BOTTOM (MANDATORY)

0.75

JOSAM SERIES 58480 CAST IRON CLEANOUT WITH PLUG (SET FLUSH W/ GRADE) 4' DIAMETER.

FINISHED GRADE -

CAST IRON CLEANOUT-

WITH PLUG (SET FLUSH

W/ GRADE) 6" DIAMETER.

FINISHED GRADE -

45° BEND

NOTE: TRENCH DRAIN IS THE OVERFLOW

TOP OF STONE BED ELEVATION=76.08± TRENCH DRAIN RIM ELEVATION=76.30±

OUTLET FOR INFILTRATION SYSTEM 'A'.

DRIVEWAY

4" ADS DRAIN TO &

FROM INFILTRATION SYSTEM

4" ADS DRAIN /

12" DIA. x 6"

3000 PSI CONC

DRESSER

COUPLING

3000 PSI CONO

COUPLING

-6" P.V.C.

CLEANOUT DETAIL NOT TO SCALE

 $RIM = 76.3 \pm$ 

SUMP

J & R PRECAST


TRENCH DRAIN


TRENCH DRAIN DETAIL


NOT TO SCALE

INSPECTION PORT DETAIL


NOT TO SCALE

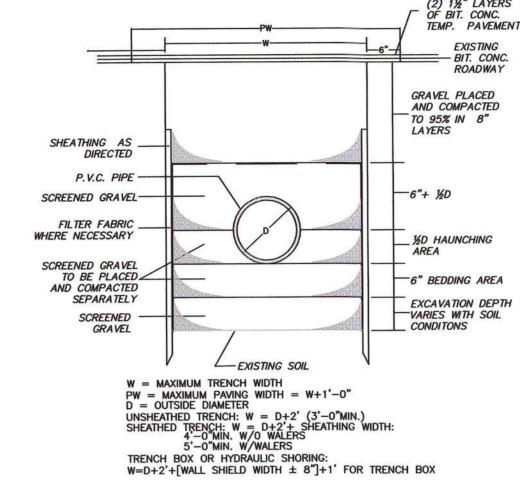

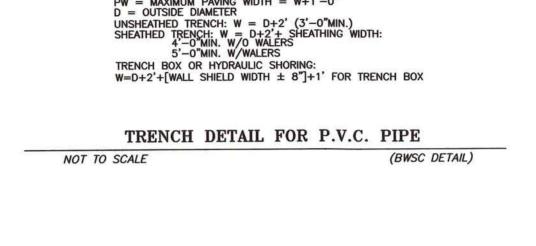

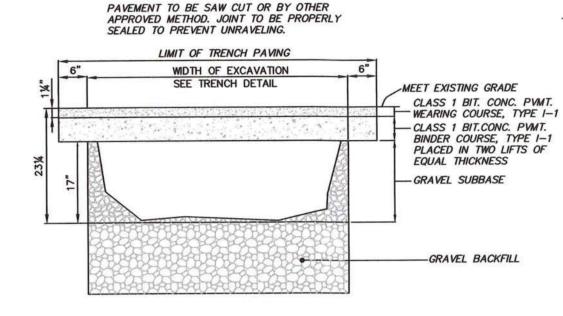



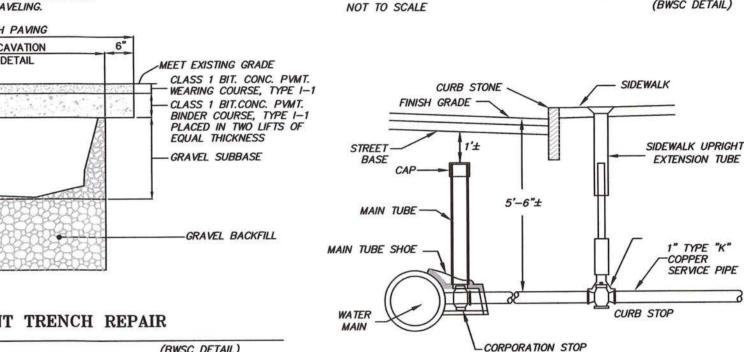

WATER SERVICE CONNECTION NOT TO SCALE

- STAINLESS STEEL STRAPPING

EXISTING SEWER OR DRAIN PIPE

1. FULL PVC OR IRON SADDLE MAY BE USED TO CONNECT TO EXISTING PVC,

5. CONNECTIONS DIRECTLY INTO THE EXISTING PIPE WITHOUT A SADDLE OR A

SANITARY SEWER SADDLE CONNECTION DETAIL

METER SPACING DETAIL

NOT TO SCALE

METER COUPLINGS

SPACE FOR 5/8" METER

7 1/2" BACK WATER

GATE VALVE

TO HOUSE FIXTURE

(BWSC DETAIL)

SADDLES MUST HAVE RUBBER GASKETS AND SHALL BE TIGHTENED WITH STRAPS. SADDLES WILL NOT BE CEMENTED ONTO THE PIPE.

4. PIPE SHALL BE CUT TO CONFORM TO THE OPENING IN THE SADDLE.

CLAY, CONCRETE, OR IRON PIPE.


3. FULL WYE CONNECTION FITTINGS MAY BE USED.

FULL WYE FITTING ARE NOT ALLOWED.

FOUNDATION WALL


TO CITY MAIN

SADDLE CONNECTION WITH WYE

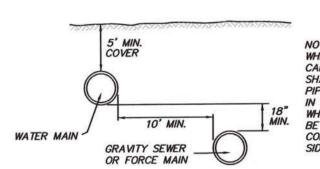


SIDEWALK

WHERE MIN. SEPARATION DISTANCES CANNOT BE MAINTAINED, BOTH PIPES SHALL BE CL. 150 MIN. PRESSURE PIPE TESTED IN PLACE AND ENCASEL IN 6" MIN. CONCRETE. AT CROSSINGS WHERE MIN. SEPARATION OF 18" CANNOT BE MET. ENCASE BOTH PIPES IN 6" CONCRETE TO DISTANCE OF 10' EACH

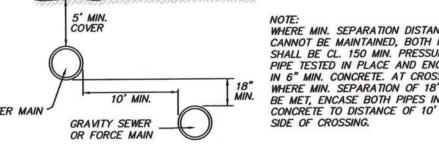

SEWER/WATER SEPARATION DETAIL

NOT TO SCALE

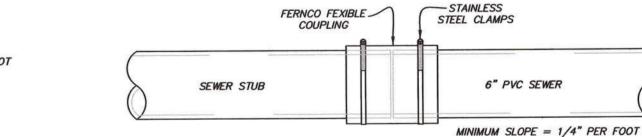

#### NOTES: (FERNCO.COM) 1. LOOSEN THE STAINLESS STEEL CLAMPS. DO NOT REMOVE CLAMPS FROM

- 2. SLIDE FLEXIBLE COUPLING OVER EXISTING PIPE AND INSERT NEW 6" PVC
- 3. STAINLESS STEEL CLAMPS TO BE TIGHTENED TO 60 INCH-LBS OR
- 4. PRESSUE TEST BEFORE BACKFILLING OR CONCEALLING JOINT. BED AND BACKFILL PROPERLY. (MAXIMUM TEST PRESSURE 4.3 P.S.I.)

FERNCO FLEXIBLE COUPLING INSTALLATION NOT TO SCALE

# MATERIAL SPECIFICATIONS

THE PROPOSED WATER SERVICE SHALL BE 1-INCH TYPE K COPPER PIPE AND FITTINGS.


THE PROPOSED SEWER SERVICE AND CLEANOUT SHALL BE 6-INCH SDR-35 PVC PIPE AND FITTINGS.

THE DRAIN PIPES SHALL CONSIST OF 4" ADS PIPE FITTINGS CONNECTING THE ROOF DRAINS AND DRIVEWAY TRENCH DRAIN TO THE PROPOSED INFILTRATION SYSTEMS AS SHOWN ON THE PLANS.

THE INFILTRATION SYSTEMS AND APPURTENANCES SHALL CONSIST OF TWO (2) SEPARATE CULTEC RECHARGER 280HD CHAMBERS MANUFACTURED BY CULTEC INC. OF BROOKFIELD CT OR APPROVED EQUAL. EACH SYSTEM WILL REQUIRE 28.89 SQUARE FEET OF CULTEC No. 410 FILTER FABRIC, 5.92 FEET OF CULTEC No. 20L POLYETHYLENE LINER, AND 6.33 CUBIC YARDS OF STONE.



REVISIONS

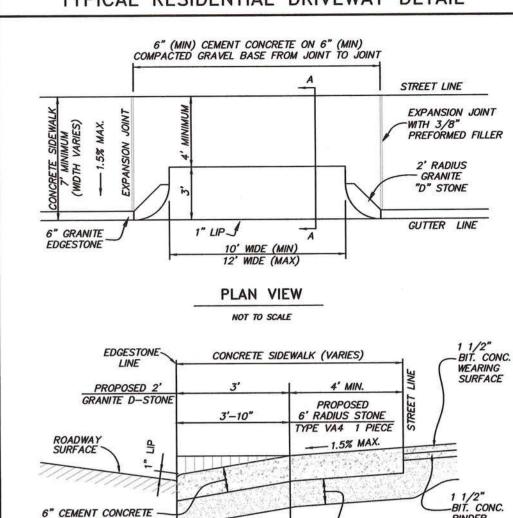

## CONDITIONS OF THE CURB CUT PERMIT

CONCRETE DRIVEWAY SECTION A-A

THE PERMITEE AGREES TO SAVE AND HOLD HARMLESS THE CITY OF BOSTON FROM ALL LIABILITY ARISING FROM THE CONSTRUCTION ASSOCIATED WITH PERMIT. THIS PERMIT IS NON-TRANSFERABLE.

THIS PERMIT IS CONDITIONAL AND ONLY BECOMES VALID UPON THE ISSUANCE OF A USE OF PREMISES PERMIT BY THE CITY OF BOSTON INSPECTIONAL SERVICES DEPARTMENT ("ISD") FOR THE SAME PLAN SUBMITTED WITH THIS PERMIT. THIS PERMIT IS NOT VALID IF THE PLAN ASSOCIATED WITH THE USE OF PREMISES PERMIT HAS BEEN ALTERED IN ANY WAY FROM THE PLAN SUBMITTED WITH THIS PERMIT.

UNLESS OTHERWISE NOTED, THIS PERMIT AUTOMATICALLY EXPIRES 18 MONTHS FROM THE DATE OF THE ISSUANCE UNLESS EXTENDED IN WRITING BY THE CHIEF ENGINEER OF THE PUBLIC WORKS DEPARTMENT. AN EXTENSION MAY BE GRANTED AFTER A REQUEST IS MADE IN WRITING AND THEAPPROPRIATE FEES ARE PAID PRIOR TO THE 30 DAYS PRIOR TO THE EXPIRATION DATE OF THE PERMIT.

THE PROPOSED SIDEWALK SHALL CONFORM TO THE RULES AND REGULATIONS OF THE MASSACHUSETTS ARCHITECTURAL ACCESS BOARD (521 CMR).

ALL WORK DONE UNDER THIS PERMIT SHALL COMPLY WITH WRITTEN REQUIREMENTS OR DIRECTIONS WHICH MAY BE ISSUED BY THE COMMISSIONER OF PUBLIC WORKS RELATING TO THE PARTICULAR PROJECT. IF ANY OF THE CONDITIONS OF THIS PERMIT ARE VIOLATED, THIS PERMIT MAY BE REVOKED BY THE COMMISSIONER OF PUBLIC

THE WORK, MATERIALS, PLANS AND SPECIFICATIONS SHALL BE AVAILABLE AT ALL TIMES FOR INSPECTION BY DULY AUTHORIZED OFFICIALS OF THE CITY OF BOSTON.

DRIVEWAY APRON(S) CONSTRUCTED UNDER THIS PERMIT ARE FOR THE PURPOSE OF PROVIDING ACCESS TO LOTS ADJACENT TO THE RIGHT OF WAY. MAINTENANCE SHALL BE THE RESPONSIBILITY OF THE PROPERTY

PRIOR TO THE ISSUANCE OF ANY PERMIT FOR THE CONSTRUCTION OF A DRIVEWAY, A PERMIT FROM THE CITY OF BOSTON PARKS & RECREATION DEPARTMENT IS REQUIRED FOR THE REMOVAL. AND/OR PLANTING OF ANY TREES ON OR ALONG A PUBLIC WAY. THE OPENING FOR THE DRIVEWAY MUST BE AT LEAST FIVE FEET AWAY FROM ANY TREE, POLE, STREET LIGHT, OR OTHER EXISTING APPURTENANCES. CONTACT (617) 635-4500 TO BE DIRECTED TO THE PARKS DEPARTMENT.

THE RELOCATION AND/OR ADJUSTMENT OF ANY PUBLIC OR PRIVATE UTILITY SHALL BE THE RESPONSIBILITY OF THE PERMITEE PRIOR TO ANY CONSTRUCTION AUTHORIZED BY THIS PERMIT.

COORDINATE THE RELOCATION OF ANY TRAFFIC CONTROL SIGNS, PARKING METERS OR SIGNALIZATION DEVICES WITH THE TRANSPORTATION DEPARTMENT. CONTACT (617) 635-4500 FOR THE TRANSPORTATION DEPARTMENT.

PRIOR TO THE RELEASE OF THIS PERMIT, COMPLETE REPAIR (RESTORATION OF RIGHT OF WAY) SHALL BE MADE OF ANY AND ALL DAMAGES DONE TO THE EXISTING IMPROVEMENTS IN THE PUBLIC RIGHT OF WAY CAUSED BY CONSTRUCTION OPERATIONS ON THIS SITE. ALL DISTURBED AREAS SHALL BE FINE GRADED AND SODDED.PROPER PRECAUTIONS MUST BE TAKEN TO KEEP EXISTING ROADWAYS FREE OF MUD, DEBRIS AND OTHER OBSTRUCTIONS.


THE PROPOSED WORK SHALL BE PERFORMED IN ACCORDANCE WITH THE CONDITIONS OF THIS PERMIT, SUBJECT TO THE PROVISIONS OF THE MASSACHUSETTS GENERAL LAWS, THE ORDINANCES OF THE CITY OF BOSTON, AND ALL APPLICABLE REGULATIONS, STANDARDS, SPECIFICATIONS AND INSPECTION AND CONTROL OF THE COMMISSIONERS OF THE DEPARTMENT OF PUBLIC WORKS, INSPECTIONAL SERVICES DEPARTMENT AND TRANSPORTATION DEPARTMENT.



NORWOOD ENGINEERING CO., INC. CIVIL ENGINEERS & LAND SURVEYORS 1410 ROUTE ONE, NORWOOD, MA 02062 PHONE: 781-762-0143 FAX 781-762-8595

7077-14

SHEET No. 2 OF 2

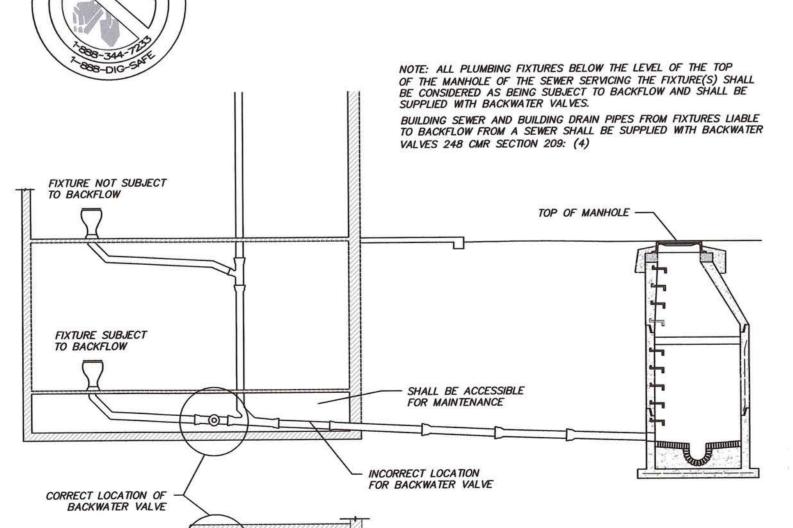

PLAN SHOWING CORRECT LOCATION FOR BACKWATER VALVE IN CELLARS

BACKWATER VALVE LOCATION NOT TO SCALE

SANITARY SEWER WYE CONNECTION NOT TO SCALE (BWSC DETAIL)

COMMON SEWER

MIN.SLOPE 1/4"/FT.

MIN.SLOPE 1/4"/FT.

SECTION A-A



NOTE: WINDOW MODEL NUMBER/SIZES PROVIDED ARE UNITED 5500 SERIES VINYL WINDOWS WITH TYPE AND GRILLE PATTERN AS

AL 3 6 =

7 Glendale Way Canton, MA 02021 617.501.0631 www.ad-architect.com STERED ARC




Street New Residence 77A West Milton Hyde Park, MA

Project Number: 21.0109 05.05.2021

Revisions: 05/10 2021 PERMIT DRAWIGS 06/09 2021 06/24 2021 ISD RESPONSE ADD'L ISD RESPONSE

3/16"=1'-0"

FRONT ELEVATION

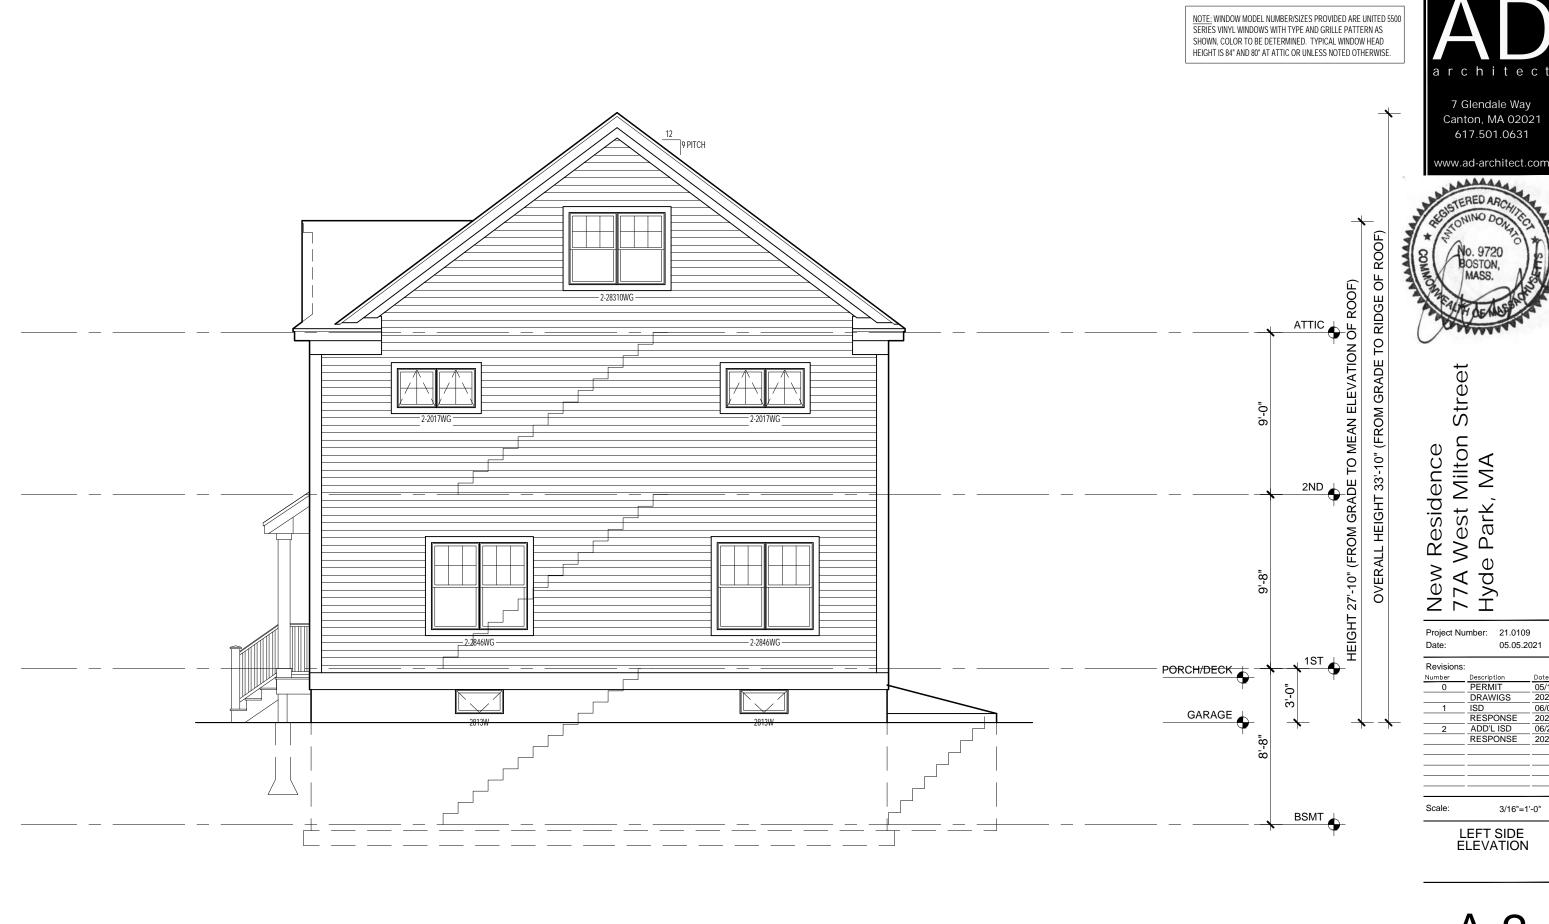





New Residence 77A West Milton Street Hyde Park, MA

Project Number: 21.0109
Date: 05.05.2021 Revisions:

05/10 2021 06/09 2021 06/24 2021 PERMIT DRAWIGS ISD
RESPONSE
ADD'L ISD
RESPONSE

3/16"=1'-0" LEFT SIDE ELEVATION

A-2

L AT O

AL 3 6 =

L FT



R AR L AT O
AL 3 6 =



STERED ARCA




Project Number: 21.0109 Date: 05.05.2021 Revisions:

Scale: 3/16"=1'-0"

REAR ELEVATION

A-3

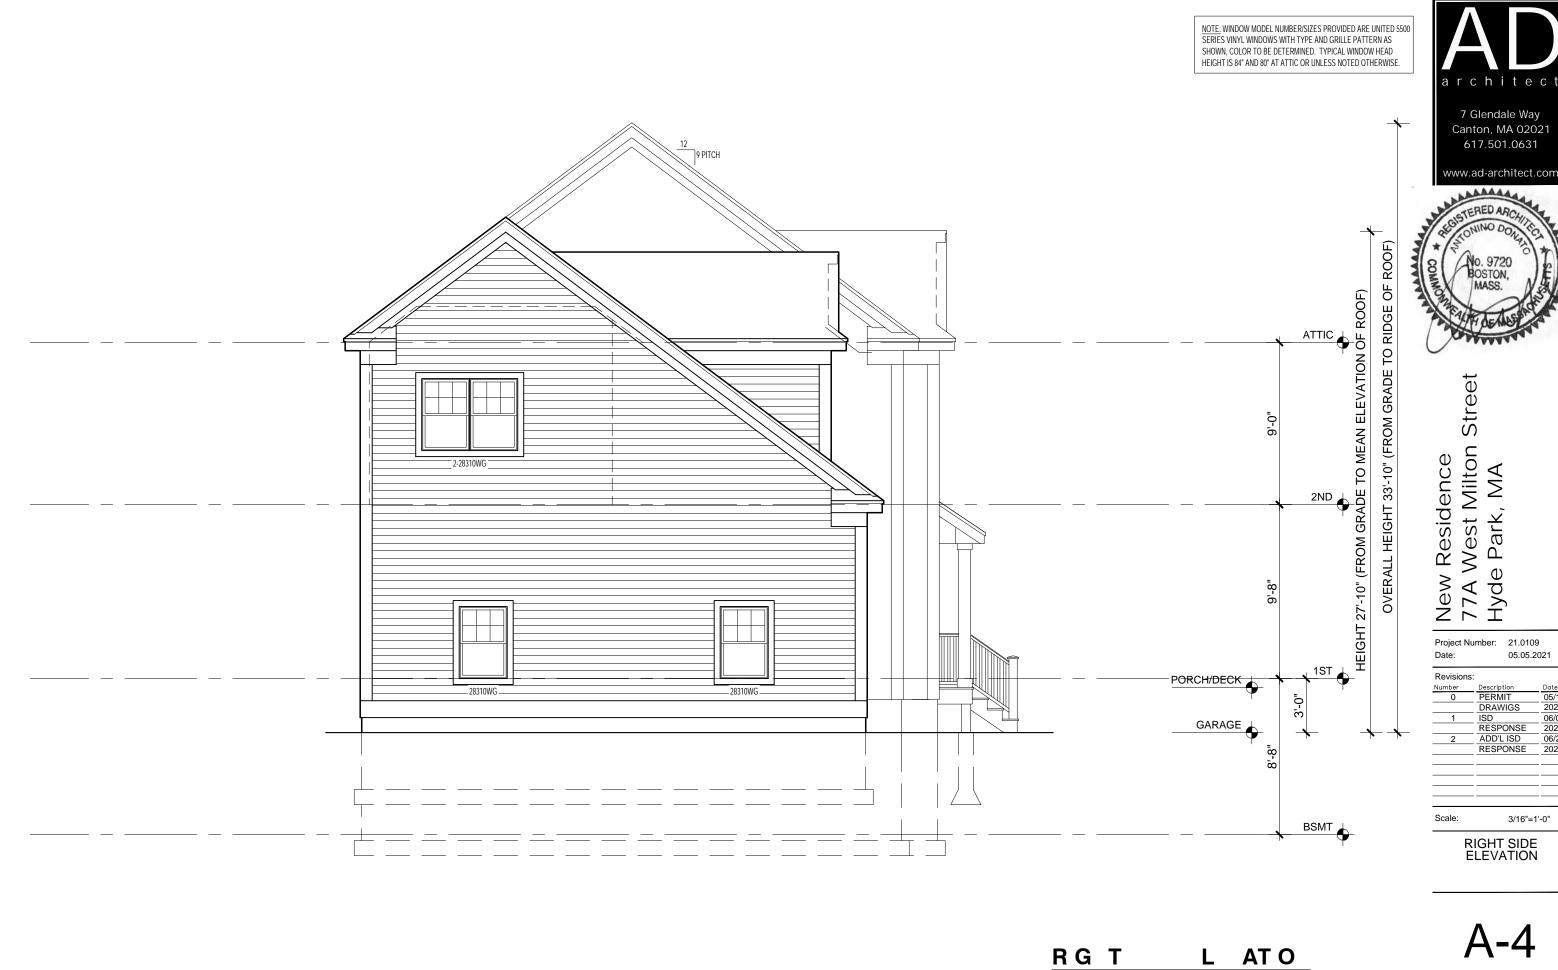

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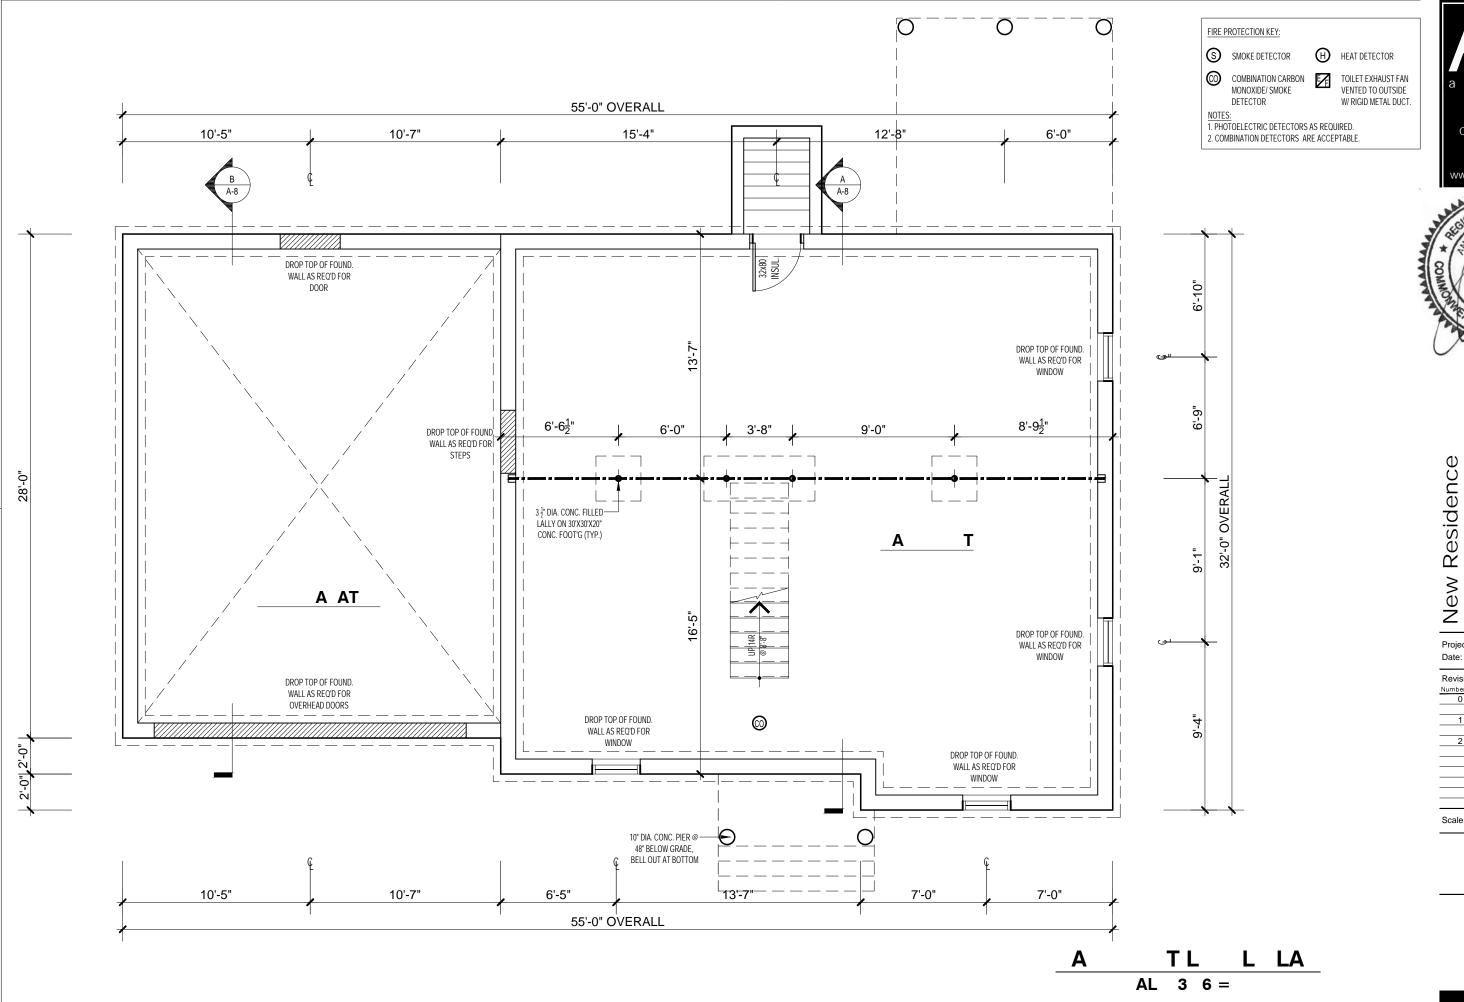
New Residence 77A West Milton Street Hyde Park, MA

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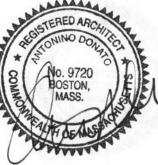
Revisions: Date 05/10 2021 06/09 2021 06/24 2021 PERMIT DRAWIGS ISD
RESPONSE
ADD'L ISD
RESPONSE

3/16"=1'-0" RIGHT SIDE ELEVATION

AL 3 6 =








77A West Milton Street
Hyde Park, MA

Project Number: 21.0109
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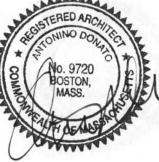
Revisions Number	Description	Date
0	PERMIT	05/10
	DRAWIGS	2021
1	ISD	06/09
	RESPONSE	2021
2	ADD'L ISD	06/24
	RESPONSE	2021
Scale:	2/16"_	1' 0"

BASEMENT LEVEL PLAN

**A-5** 



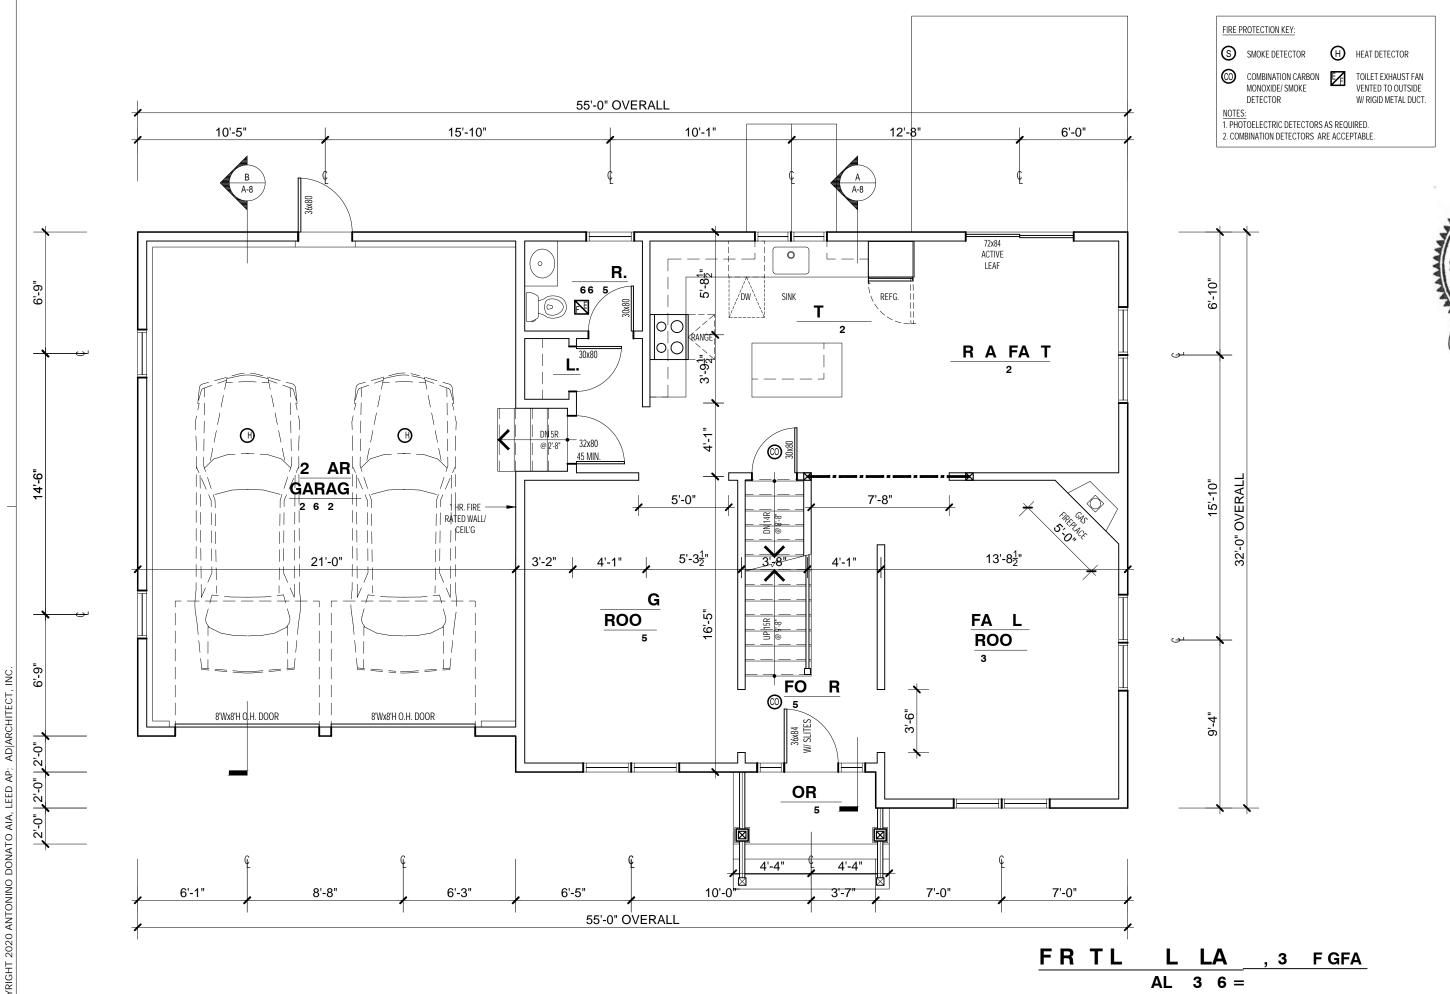



New Residence
77A West Milton Street
Hyde Park, MA

DRAWIGS 2021

1 ISD 06/09

RESPONSE 2021


2 ADD'L ISD 06/24

RESPONSE 2021

Scale: 3/16"=1'-0"

FIRST LEVEL PLAN

A-6

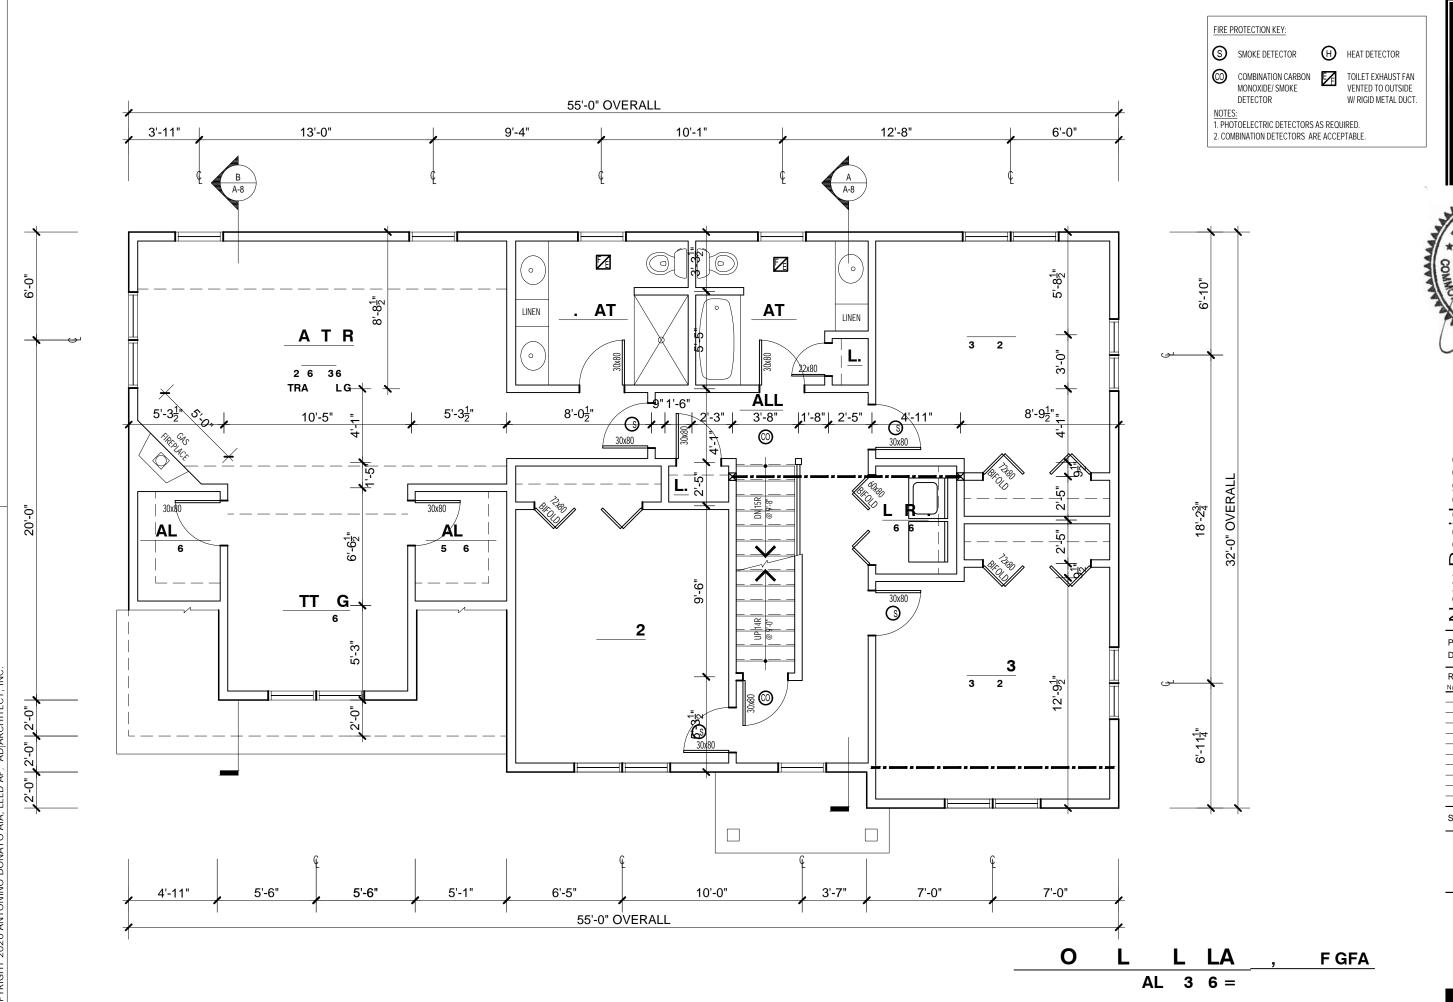



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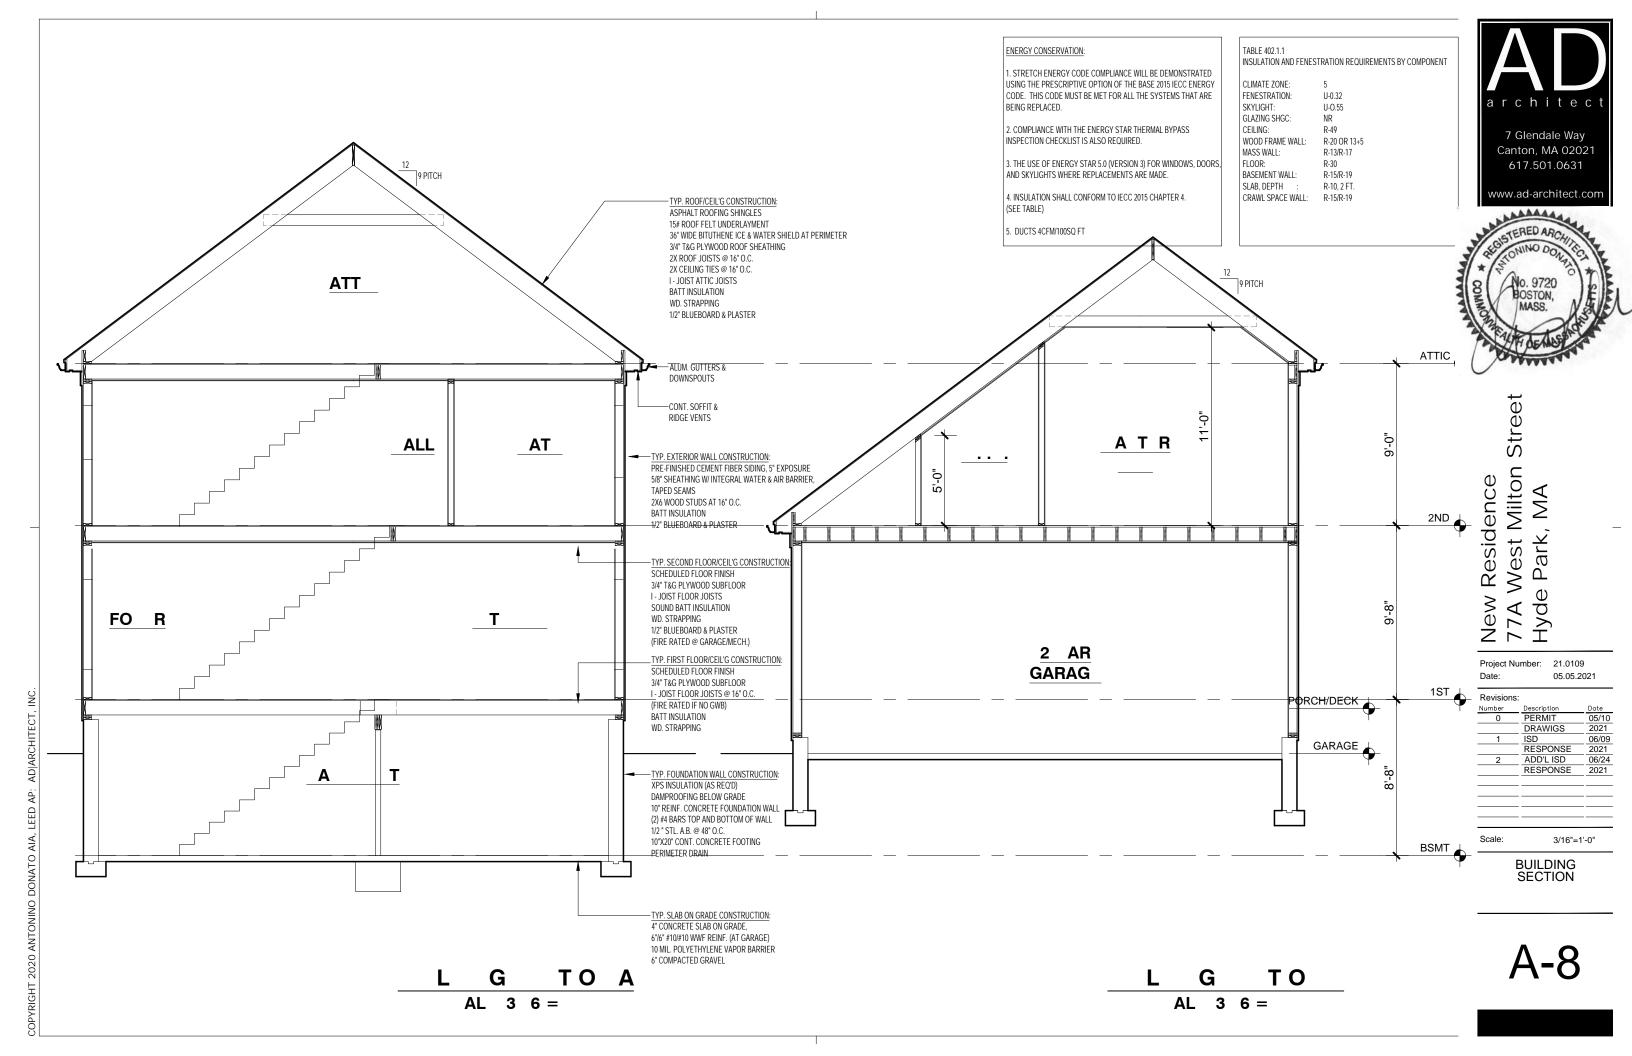



Street New Residence 77A West Milton Hyde Park, MA

Project Number: 21.0109 05.05.2021

Revisions: 05/10 2021 PERMIT DRAWIGS ISD
RESPONSE
ADD'L ISD
RESPONSE 06/09 2021 06/24 2021 3/16"=1'-0"

SECOND LEVEL PLAN



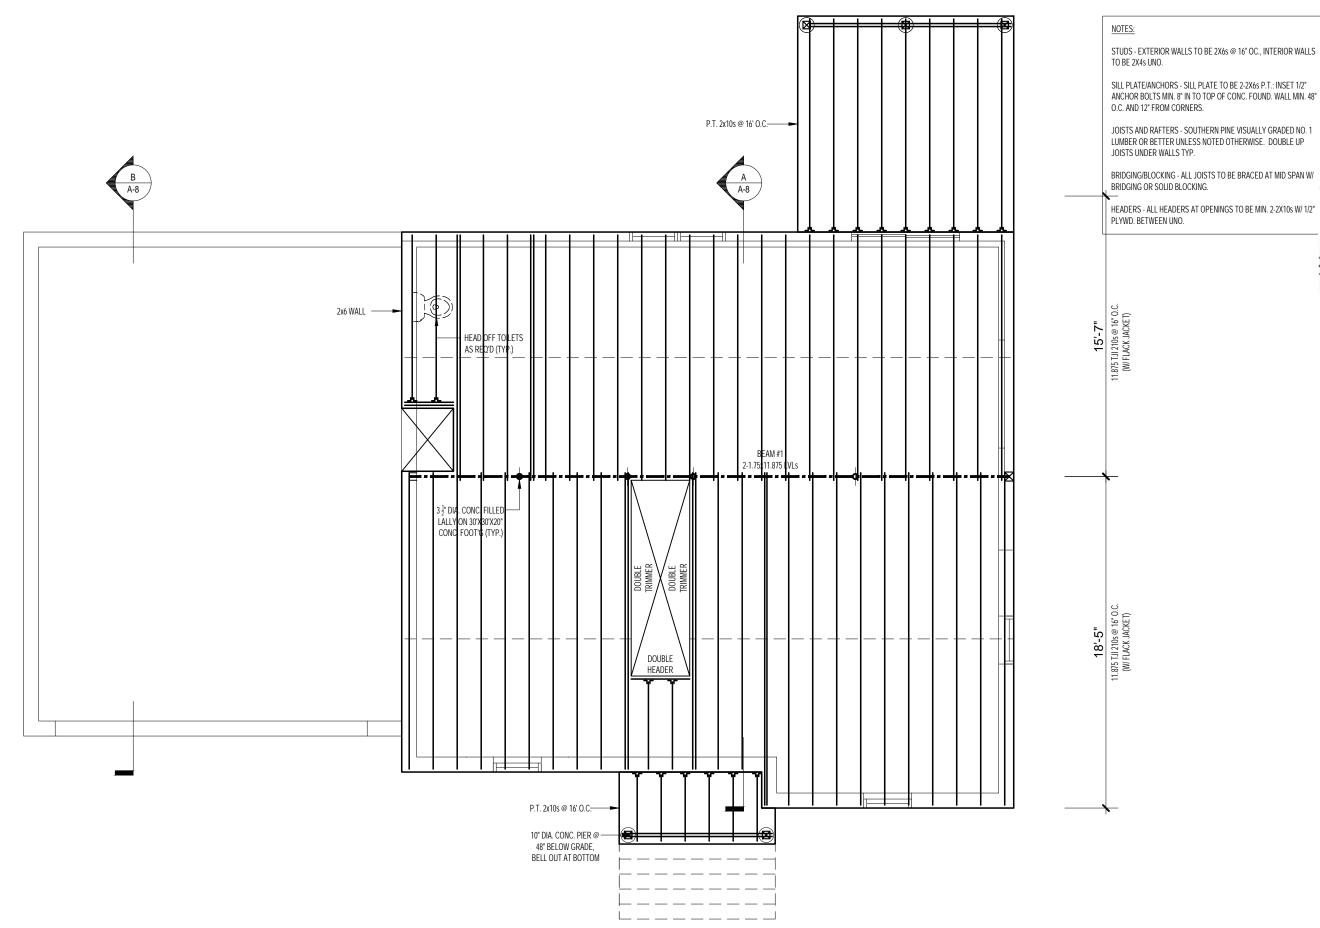

FR TL

L FRA

AL 3 6 =

G LA

New Residence 77A West Milton Street Hyde Park, MA

Project Number: 21.0109 Date: 05.05.2021

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Canton, MA 02021

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GISTERED ARCH


Revisions: 05/10 2021 PERMIT DRAWIGS 
 ISD
 06/09

 RESPONSE
 2021

 ADD'L ISD
 06/24
 ADD'L ISD RESPONSE

Scale: 3/16"=1'-0"

FIRST LEVEL FRAMING PLAN

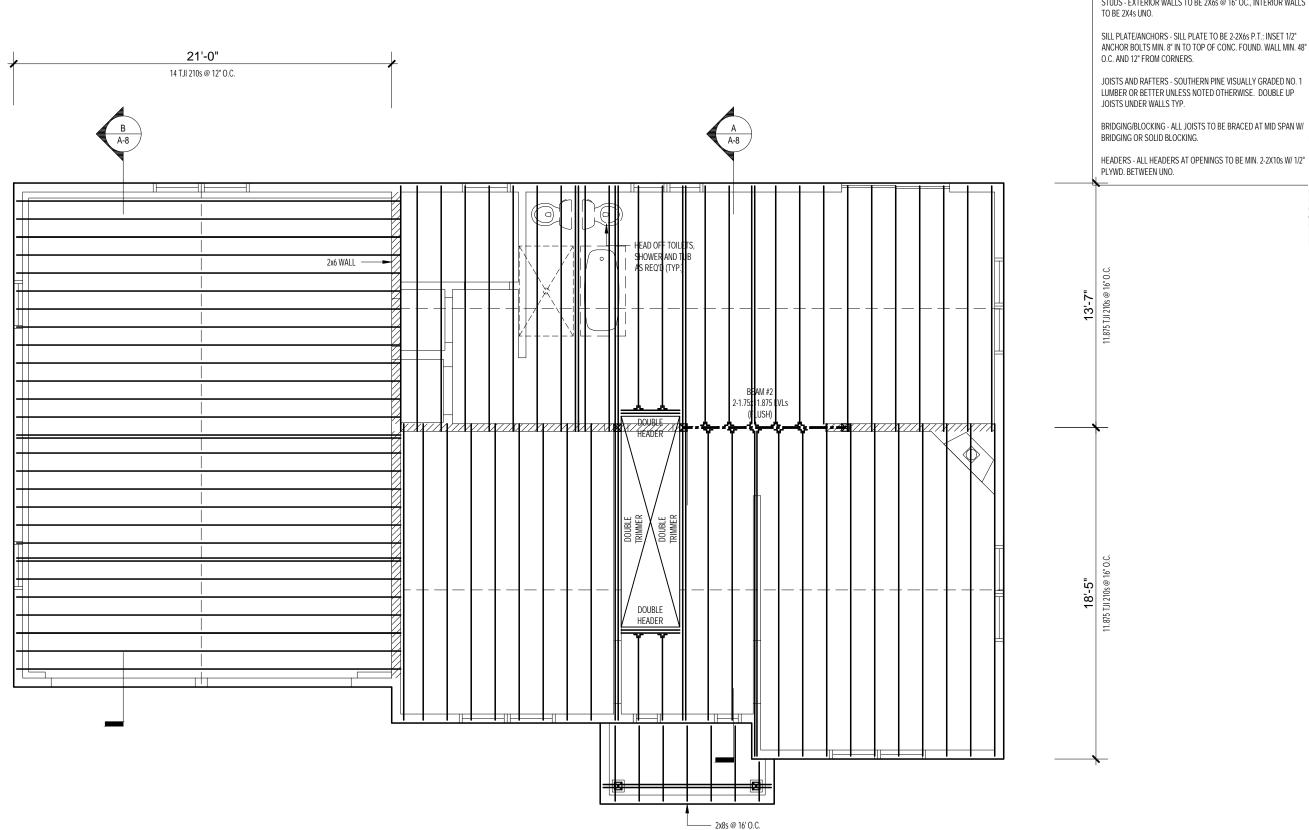

NOTES:

STUDS - EXTERIOR WALLS TO BE 2X6s @ 16" OC., INTERIOR WALLS TO BE 2X4s UNO.

SILL PLATE/ANCHORS - SILL PLATE TO BE 2-2X6s P.T.; INSET 1/2" ANCHOR BOLTS MIN. 8" IN TO TOP OF CONC. FOUND. WALL MIN. 48"

LUMBER OR BETTER UNLESS NOTED OTHERWISE. DOUBLE UP

GISTERED ARCH

7 Glendale Way

Canton, MA 02021

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Street New Residence 77A West Milton S Hyde Park, MA

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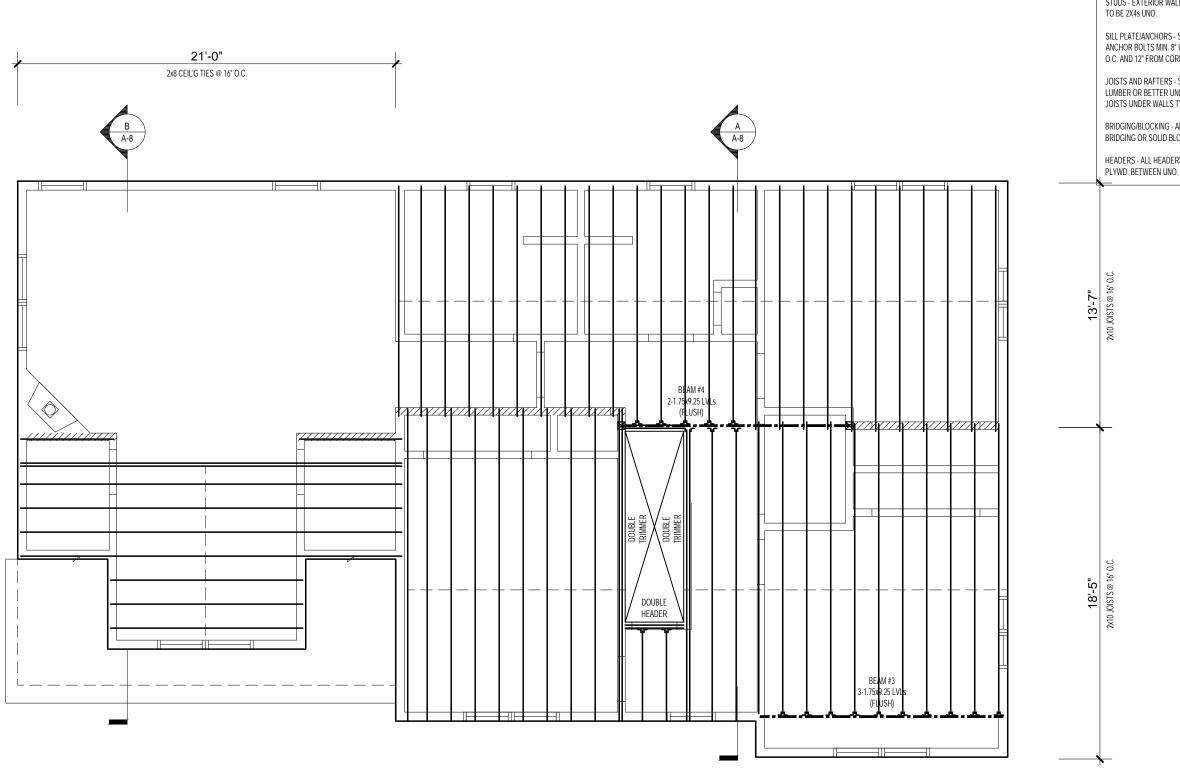
Revisions: 05/10 2021 PERMIT DRAWIGS | ISD | 06/09 | RESPONSE | 2021 | ADD'L ISD | 06/24 | RESPONSE | 2021 |

Scale:

SECOND LEVEL FRAMING PLAN

3/16"=1'-0"

G LA 0 L FRA AL 3 6 =



NOTES

STUDS - EXTERIOR WALLS TO BE 2X6s @ 16" OC., INTERIOR WALLS TO BE 2X4s UNO.

SILL PLATE/ANCHORS - SILL PLATE TO BE 2-2X6s P.T.; INSET 1/2" ANCHOR BOLTS MIN. 8" IN TO TOP OF CONC. FOUND. WALL MIN. 48" O.C. AND 12" FROM CORNERS.

JOISTS AND RAFTERS - SOUTHERN PINE VISUALLY GRADED NO. 1 LUMBER OR BETTER UNLESS NOTED OTHERWISE. DOUBLE UP JOISTS UNDER WALLS TYP.

BRIDGING/BLOCKING - ALL JOISTS TO BE BRACED AT MID SPAN W/BRIDGING OR SOLID BLOCKING.

HEADERS - ALL HEADERS AT OPENINGS TO BE MIN. 2-2X10s W/ 1/2" PLYWD. BETWEEN UNO.

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Canton, MA 02021

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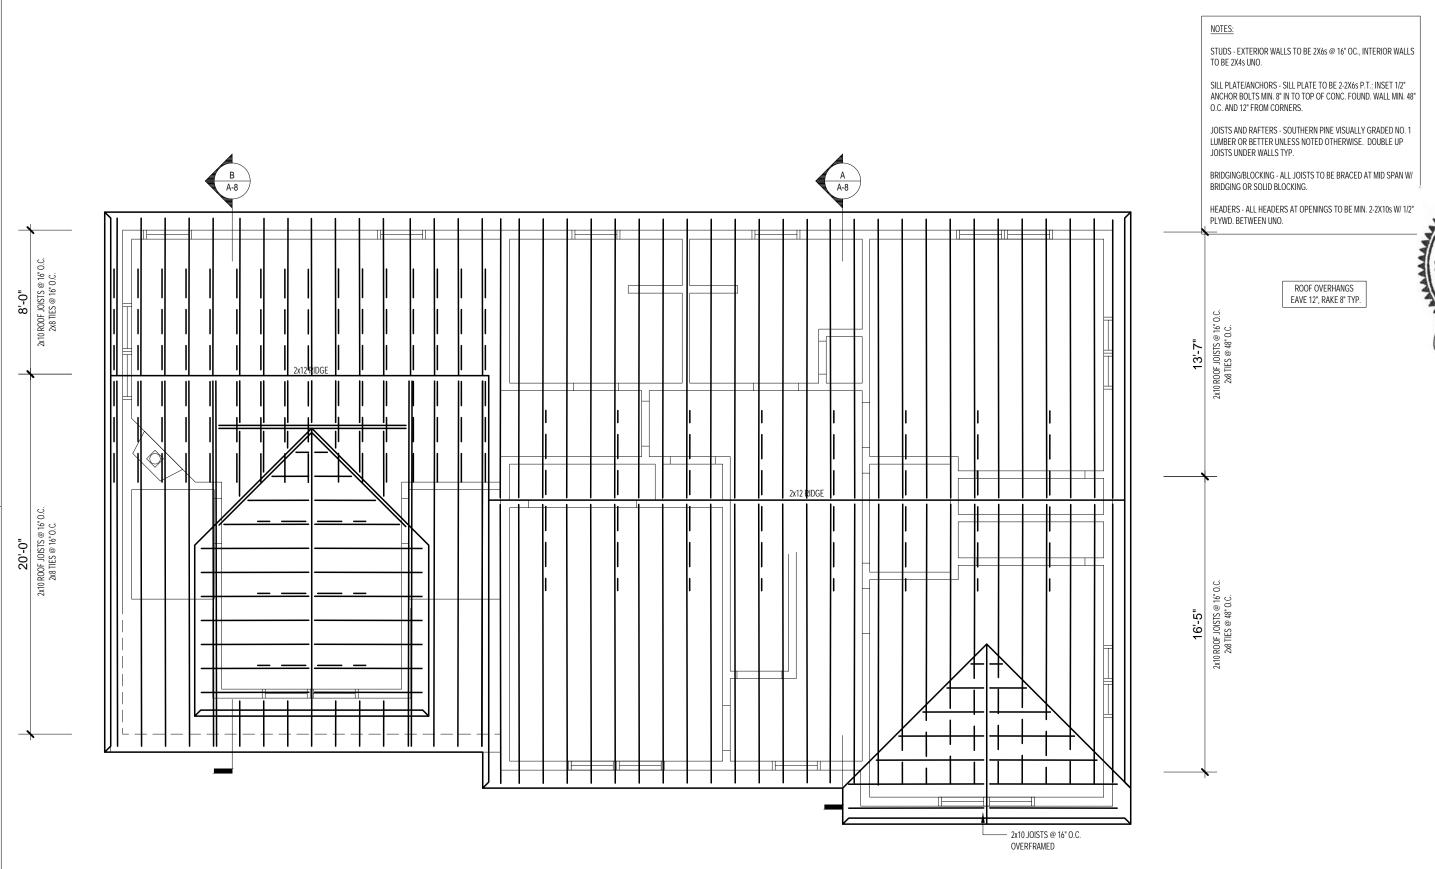
Project Number: 21.0109
Date: 05.05.2021

Scale: 3/16"=1'-0"

ATTIC/ CEILING FRAMING PLAN

A-11

ATT L G FRA G LA
AL 3 6 =



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Hyde Park, MA

7 Glendale Way Canton, MA 02021

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COSTERED ARCA

Project Number: 21.0109
Date: 05.05.2021

Scale: 3/16"=1'-0"

ROOF FRAMING

A-12

ROOF FRA G LA

AL 3 6 =