

REFERENCES
ASSESSORS REF. WARD 2 PCL. 3258
DEED BK. 34,198 PG. 51
PLAN #474 of 2009
PLAN BY YUNITS ENGINEERING CO.
JULY 8, 1969 SHEET: S-13

ZONING
3F-2000
OS-P
CHARLESTOWN NEIGHBORHOOD
DISTRICT
LOT AREA 2,000 S.F. MIN.
FRONTAGE 25' MIN.
F.A.R. 2.0 (MAX.)
MIN.
SETBACKS {S 2.5'
R 20'

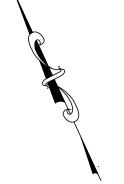

MONUMENT SQ.

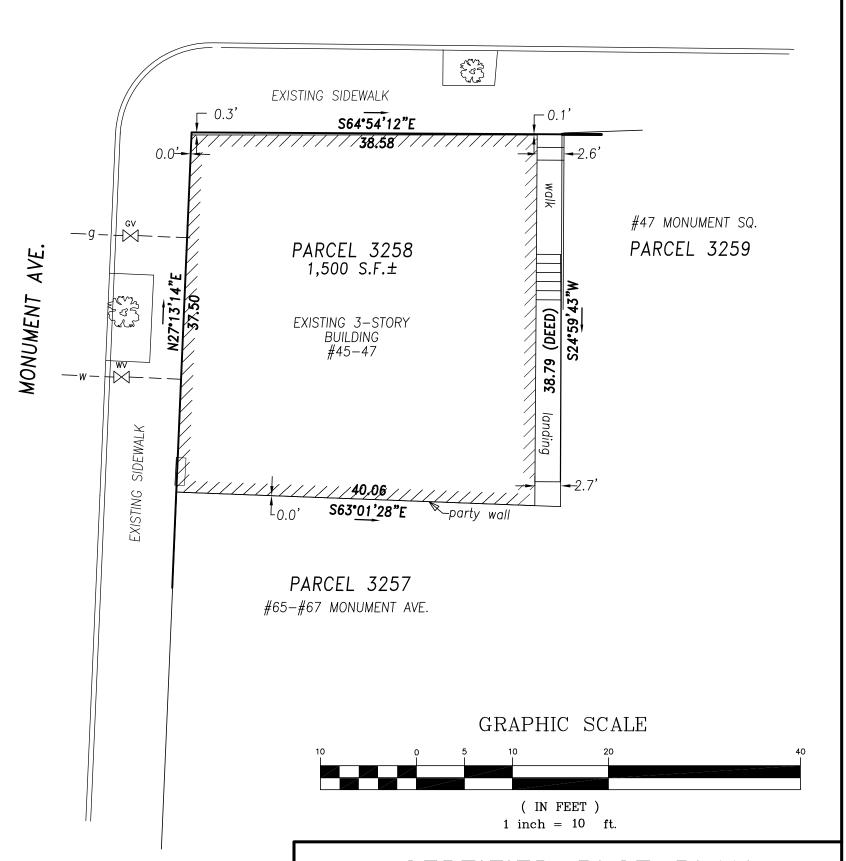

I HEREBY CERTIFY THAT THE DWELLING SHOWN HEREON HAS BEEN LOCATED FROM INSTUMENT SURVEY AND PROPERTY LINES HAVE BEEN DETERMINED FROM DEEDS AND PLANS OF RECORD. CERTIFIED PLOT PLAN for GREGORY McCARTHY at 45-47 MONUMENT SQ. CHARLESTOWN, MA

CIVIL ENVIRONMENTAL CONSULTANTS 8 OAK STREET PEABODY, MA 01960 (978)531-1191

SHEET NO: 1 OF 1

DATE: 8-17-2021 JOB NO: 4379 DRAWN BY: W.R.D. SCALE: 1"=10'

LBS

POUNDS

ALT AFF AFG or A.F.G. ASTM  AWS APPROX ARCH @ BAL BTWN BM BRG BLK BLKG B.O. BRKT BLDG  CIP CTRD CTRD CLR COL	ALTERNATE ABOVE FINISH FLOOR ABOVE FINISH GRADE AMERICAN SOCIETY FOR TESTING AND MATERIALS AMERICAN WELDING SOCIETY APPROXIMATELY ARCHITECT OR ARCHITECTURAL AT  BALANCE BETWEEN BEAM BEARING BLOCK BLOCKING BOTTOM OF BRACKET BUILDING  CAST-IN-PLACE CENTERED	MEP MID MID-PT MIN MR NFPA  NTH NIC NTS NO OR #  OC OPNG	MATERIAL MAXIMUM MECHANICAL MEMBRANE MECHANICA, ELECTRICAL, PLUMBIN MIDDLE MID-POINT MINIMUM MOISTURE RESISTANT  NATIONAL FIRE PROTECTION AGENCY NORTH NOT IN CONTRACT NOT TO SCALE NUMBER  ON CENTER
AFG or A.F.G. ASTM  AWS APPROX ARCH @ BAL BTWN BM BRG BLK BLKG B.O. BRKT BLDG  CIP CTRD CTRD CLR COL	ABOVE FINISH GRADE AMERICAN SOCIETY FOR TESTING AND MATERIALS AMERICAN WELDING SOCIETY APPROXIMATELY ARCHITECT OR ARCHITECTURAL AT  BALANCE BETWEEN BEAM BEARING BLOCK BLOCKING BOTTOM OF BRACKET BUILDING  CAST-IN-PLACE	MECH MEMB MEP MID MID-PT MIN MR  NFPA  NTH NIC NTS NO OR #  OC OPNG	MECHANICAL MEMBRANE MECHANICA, ELECTRICAL, PLUMBIN MIDDLE MID-POINT MINIMUM MOISTURE RESISTANT  NATIONAL FIRE PROTECTION AGENCY NORTH NOT IN CONTRACT NOT TO SCALE NUMBER
ASTM  AWS  APPROX  ARCH	AMERICAN SOCIETY FOR TESTING AND MATERIALS AMERICAN WELDING SOCIETY APPROXIMATELY ARCHITECT OR ARCHITECTURAL AT  BALANCE BETWEEN BEAM BEARING BLOCK BLOCKING BOTTOM OF BRACKET BUILDING  CAST-IN-PLACE	MEMB MEP MID MID-PT MIN MR  NFPA  NTH NIC NTS NO OR #  OC OPNG	MEMBRANE MECHANICA, ELECTRICAL, PLUMBIN MIDDLE MID-POINT MINIMUM MOISTURE RESISTANT  NATIONAL FIRE PROTECTION AGENCY NORTH NOT IN CONTRACT NOT TO SCALE NUMBER
AWS APPROX ARCH @ BAL BTWN BM BRG BLK BLKG B.O. BRKT BLDG CIP CTRD CTRD CLR COL	AND MATERIALS AMERICAN WELDING SOCIETY APPROXIMATELY ARCHITECT OR ARCHITECTURAL AT  BALANCE BETWEEN BEAM BEARING BLOCK BLOCKING BOTTOM OF BRACKET BUILDING  CAST-IN-PLACE	MEP MID MID-PT MIN MR  NFPA  NTH NIC NTS NO OR #  OC OPNG	MECHANICA, ELECTRICAL, PLUMBIN MIDDLE MID-POINT MINIMUM MOISTURE RESISTANT  NATIONAL FIRE PROTECTION AGENCY NORTH NOT IN CONTRACT NOT TO SCALE NUMBER
APPROX ARCH @  BAL BTWN BM BRG BLK BLKG B.O. BRKT BLDG  CIP CTRD CTRD CTRD CLR COL	AMERICAN WELDING SOCIETY APPROXIMATELY ARCHITECT OR ARCHITECTURAL AT  BALANCE BETWEEN BEAM BEARING BLOCK BLOCKING BOTTOM OF BRACKET BUILDING  CAST-IN-PLACE	MID-PT MIN MR  NFPA  NTH NIC NTS NO OR #  OC OPNG	MIDDLE MID-POINT MINIMUM MOISTURE RESISTANT  NATIONAL FIRE PROTECTION AGENCY NORTH NOT IN CONTRACT NOT TO SCALE NUMBER
APPROX ARCH @  BAL BTWN BM BRG BLK BLKG B.O. BRKT BLDG  CIP CTRD CTRD CTRD CLR COL	APPROXIMATELY ARCHITECT OR ARCHITECTURAL AT  BALANCE BETWEEN BEAM BEARING BLOCK BLOCKING BOTTOM OF BRACKET BUILDING  CAST-IN-PLACE	MIN MR  NFPA  NTH NIC NTS NO OR #  OC OPNG	MINIMUM MOISTURE RESISTANT  NATIONAL FIRE PROTECTION AGENCY NORTH NOT IN CONTRACT NOT TO SCALE NUMBER
ARCH @  BAL BTWN BM BRG BLK BLKG B.O. BRKT BLDG  CIP CTRD CTRD CLR COL	ARCHITECT OR ARCHITECTURAL AT  BALANCE BETWEEN BEAM BEARING BLOCK BLOCKING BOTTOM OF BRACKET BUILDING  CAST-IN-PLACE	MR NFPA NTH NIC NTS NO OR # OC OPNG	MOISTURE RESISTANT  NATIONAL FIRE PROTECTION AGENCY NORTH NOT IN CONTRACT NOT TO SCALE NUMBER
@ BAL BTWN BM BRG BLK BLKG B.O. BRKT BLDG  CIP CTRD CTRD CLR COL	BALANCE BETWEEN BEAM BEARING BLOCK BLOCKING BOTTOM OF BRACKET BUILDING  CAST-IN-PLACE	NFPA  NTH NIC NTS NO OR #  OC OPNG	NATIONAL FIRE PROTECTION AGENCY NORTH NOT IN CONTRACT NOT TO SCALE NUMBER
BTWN BM BRG BLK BLKG B.O. BRKT BLDG  CIP CTRD CTRD CLR COL	BETWEEN BEAM BEARING BLOCK BLOCKING BOTTOM OF BRACKET BUILDING  CAST-IN-PLACE	NTH NIC NTS NO OR # OC OPNG	AGENCY NORTH NOT IN CONTRACT NOT TO SCALE NUMBER
BM BRG BLK BLKG B.O. BRKT BLDG  CIP CTRD CTRD CLR COL	BEAM BEARING BLOCK BLOCKING BOTTOM OF BRACKET BUILDING  CAST-IN-PLACE	NIC NTS NO OR # OC OPNG	NORTH NOT IN CONTRACT NOT TO SCALE NUMBER
BRG BLK BLKG B.O. BRKT BLDG  CIP CTRD CTRD CLR COL	BEARING BLOCK BLOCKING BOTTOM OF BRACKET BUILDING  CAST-IN-PLACE	NIC NTS NO OR # OC OPNG	NOT IN CONTRACT NOT TO SCALE NUMBER
BLK BLKG B.O. BRKT BLDG  CIP CTRD CTRD CLR COL	BLOCK BLOCKING BOTTOM OF BRACKET BUILDING  CAST-IN-PLACE	NTS NO OR # OC OPNG	NOT TO SCALE NUMBER
BLKG B.O. BRKT BLDG  CIP CTRD  CLR COL	BLOCKING BOTTOM OF BRACKET BUILDING  CAST-IN-PLACE	NO OR # OC OPNG	NUMBER
BRKT BLDG  CIP CTRD  CLR COL	BRACKET BUILDING CAST-IN-PLACE	OC OPNG	
CIP CTRD Q CLR COL	BUILDING CAST-IN-PLACE	OPNG	ON CENTER
CIP CTRD & CLR COL	CAST-IN-PLACE	OPNG	
CTRD © CLR COL			OPENING
CTRD © CLR COL		OPP	OPPOSITE
Ф CLR COL	CENTERED	OD	OUTSIDE DIAMETER
CLR COL		OF	OUTSIDE FACE
COL	CENTERLINE		
	CLEAR	P.T.	PRESSURE TREATED
$\triangle \triangle N \triangle$	COLOWIN	PTD	PAINTED
CONC	CONCRETE		
CMU	CONCRETE MASONRY UNIT	PSF PSI	POUNDS PER SQUARE FOOT POUNDS PER SQUARE INCH
CONST	CONSTRUCTION	PVC	POLYVINYL CHLORIDE
CONSTJT OR CONT	CONSTRUCTION JOINT CONTINUOUS	PC	PRECAST CONCRETE
CJ	CONTROL JOINT	-	
00		R	DADILIC
DIA OR Ø	DIAMETER	REF	RADIUS REFERENCE
DIM	DIMENSION	REINF	REINFORCE, REINFORCING
DN	DOWN		OR REINFORCEMENT
DWG	DRAWING	REQ'D	REQUIRED
		RD	ROOF DRAIN
EA	EACH		
ELECT	ELECTRICAL	S	SEALANT
EL OR	ELEVATION	SCH OR SCHED	SCHEDULE
ELEV	ELEVATOR	SECT	SECTION
EMBED	EMBEDMENT	SHT	SHEET
ENCL	ENCLOSURE	SHTG	SHEATHING
EQ	EQUAL	SIM SOG	SIMILAR SLAB ON GRADE
EQUIP	EQUIPMENT	STH	SOUTH
EXIST'G	EXISTING	SPECS	SPECIFICATIONS
EXP BOLT	EXPANSION BOLT EXPANSION JOINT	SPKR	SPRINKLER
EXT	EXTERIOR	SQ or SQR	SQUARE
		SQD or SQRD	SQUARED
FF 	FINISH FACE	S.S. or STN STL	STAINLESS STEEL
FT	FEET OR FOOT	STD	STANDARD
FIN FIN FL	FINISH FINISHED FLOOR	STL	STEEL
FPRF	FIREPROOF	ST STL	STAINLESS STEEL
FL		STRUCT	STRUCTURAL
FD	FLOOR DRAIN	SYM	SYMMETRICAL
FTG	FOOTING	TEMP	TEMPODARY
FDN	FOUNDATION	TEMP	TEMPORARY
		THK T.O.	THICK OR THICKNESS TOP OF
GA	GAGE ON GAUGE	T & B	TOP OF TOP AND BOTTOM
GALV	OALVANIZED	T.O.C.	TOP OF CURB or CONCRETE
GWB	GYPSUM WALL BOARD	1.0.0.	TOT OF COILD OF COILCILE
HGT	HEIGHT	TOP	TOP PLATE
HORIZ	HORIZONTAL	T.O.S.	TOP OF STEEL
IN	INCH	T.O.W.	TOP OF WALL
INFO	INFORMATION	TYP	TYPICAL
INCL	INCLUDING OR INCLUSIVE	UNO	UNLESS NOTED OTHERWISE
ID	INSIDE DIAMETER	VERT	VERTICAL
INSUL	INSULATION	VIF	
INT	INTERIOR		VERIFY IN FIELD
INV		WST	WEST WESTERN WOOD PRODUCTS
JT	JOINT	WWPA	ASSOCIATION
1 411	LAUNDRY	W/	WITH
LAU		W/O	WITHOUT
LWC	LIGHT WEIGHT CONCRETE	V V / O	VVIIIOOI

WP

**WORKING POINT** 

# MONUMENT SQUARE RESIDENCES

45 Monument Square, Charlestown, MA 02129

IRC 2015 (780 CMR 9TH EDITION)

REQ'D

2.5'

SECOND FLOOR: 1,350GSF

20'

CONFORMITY

35'/3 STORIES

UNFINISHED

1,175GSF

3,875GSF

**CODE ANALYSIS:** 

APPLICABLE CODES:

**BUILDING CODE** 

SUBDISTRICT: 3F-2000

**FRONT** 

SIDE:

REAR:

**HEIGHT** 

FAR: 2.0

LOT SIZE: 1,500SF

ALLOWED: 3,000GSF

EXISTING: 4,068GSF

PROPOSED: 3,875GSF

BASEMENT:

FIRST FLOOR:

THIRD FLOOR:

5. MEANS OF EGRESS: EMERENCY ESCAPE & RESCUE:

5.7SF OPERABLE CLEAR AREA,

**EXISTING WOOD FRAMING** 

DOUBLE PANE LOW E

DOUBLE PANE LOW E

EXISTING; NO CHANGE 8" CIP, 3,500PSI MIN

8 1/4" MAX RISER 10" MIN TREAD

42" MIN TO TOP RAIL BALUSTERS: 4" MAX CLEAR WIDTH

**R49 MIN INSULATION VALUE** 

MIN. U-FACTOR: .30

MIN. U-FACTOR: .30

1 WINDOW MINIMUM REQUIREMENTS

R21 MIN INSULATION VALUE (CAVITY)

REQUIREMENTS FOR 1 WDW MIN PER BEDROOM:

34" MIN. TO 38" MAXIMUM ABOVE STAIR NOSING

5.7SF OPERABLE CLEAR AREA, 44" MAX SILL HGT

VINYL OR METAL (METAL MUST HAVE THERMAL BRAKE)

**BEDROOM EGRESS:** 

44" MAX SILL HGT

PERFORMANCE REQUIREMENTS

1.EXTERIOR WALLS:

3. EXTERIOR DOORS:

4. CEILING/ROOF

5. FOUNDATION

HANDRAILS:

6. STAIRS:

2. WINDOWS:

**SETBACKS**:

**IEBC 2015** 

**IECC 2018** 

IFC 2015 (527 CMR)

2. ZONING DISTRICT: CHARLESTOWN NEIGHBORHOOD

# SYMBOL LEGEND EXISTING WALL PROPOSED WALL [=====] EXISTING WALL TO BE REMOVED 1HR RATED PARTITION (UL DESIGN U309) **PROPOSED** NO CHANGE **EXISTING DOOR** NO CHANGE **NO CHANGE NO CHANGE** PROPOSED DOOR EXISTING DOOR TO BE REMOVED Room name **ROOM TAG** 101 3. USE GROUP CLASSIFICATION: RESIDENTIAL R3 (SINGLE FAMILY) SHEET# 4. CONSTRUCTION CLASSIFICATION: TYPE 5B CONSTRUCTION **ELEVATION TAG** VIEW # SECTION TAG COMBO SMOKE/CO2 DETECTOR -KIDDE I12010SCO COMBO SMOKE/CO2 DETECTOR (PHOTOELECTRIC) VINYL OR METAL (METAL MUST HAVE THERMAL BRAKE)

KIDDE KN-COPE-IC

SHEET NAME TITLE SHEET

A100 **DEMO PLANS** A101 **DEMO PLANS** FLOOR PLANS A102 A200 **EXTERIOR ELEVATIONS** 

DRAWING LIST

FRAMING PLANS - BASEMENT & 1STR FLOOR FRAMING PLANS - 2ND, 3RD & ROOF FRAMING PLANS - ROOF DECK & HEAD HOUSE

**GENERAL NOTES:** 

1. WORK SHALL COMPLY WITH FEDERAL, STATE AND LOCAL BUILDING CODES AND REGULATIONS. UNLESS OTHERWISE AGREED UPON, THE CONTRACTOR IS RESPONSIBLE FOR SECURING ALL BUILDING PERMITS AS REQUIRED TO PERFORM HIS OR HER WORK AND WILL RETAIN AND PAY FOR ALL REQUIRED INSPECTIONS FOR THE DURATION OF CONSTRUCTION.

2. CONTRACTOR SHALL ENGAGE A LICENSED ELECTRICIAN FOR ALL ELECTRICAL WORK AND IN COMPLIANCE WITH NFPA 70.

4. CONTRACTOR RESPONSIBLE FOR ALL PREPARATION WORK REQUIRED BY MANUFACTURER'S SPECIFICATIONS.

5. CONTRACTOR SHALL PROVIDE PRODUCT SUBMITTAL FOR SMOKE ALARM FIXTURES FOR APPORVAL

6. CONFLICTS BETWEEN SITE CONDITIONS AND DRAWINGS SHALL BE BROUGHT TO THE IMMEDIATE ATTENTION OF THE ARCHITECT OR THE APPROPRIATE CONSULTING ENGINEERS.


7. CONFIRM DIMENSIONS WITH THE ARCHITECT OR APPROPRIATE CONSULTING ENGINEER.

8. CONTRACTOR TO NOTIFY ARCHITECT, AFTER LAYOUT AND PRIOR TO FRAMING, OF ANY DISCREPANCY, OMISSION, OR UNANTICIPATED FIELD CONDITIONS ALTER THE DESIGN INTENT.

9. CONTRACTOR TO NOTIFY ARCHITECT, AFTER LAYOUT AND PRIOR TO FRAMING, IF DIMENSIONS INDICATED WITH "+/-" VARIES MORE THAN 3" FROM ACTUAL FIELD MEASURMENTS.

10. CONTRACTOR RESPONSIBLE FOR ALL PREPARATION WORK REQUIRED BY MANUFACTURER'S SPECIFICATIONS.

11. DAMAGED TO EXISTING OR NEW CONSTRUCTION CAUSED BY THE CONTRACTOR, HIS OR HER SUB-CONTRACTORS OR CREW IS THE RESPONSIBILITY OF THE CONTRACTOR.

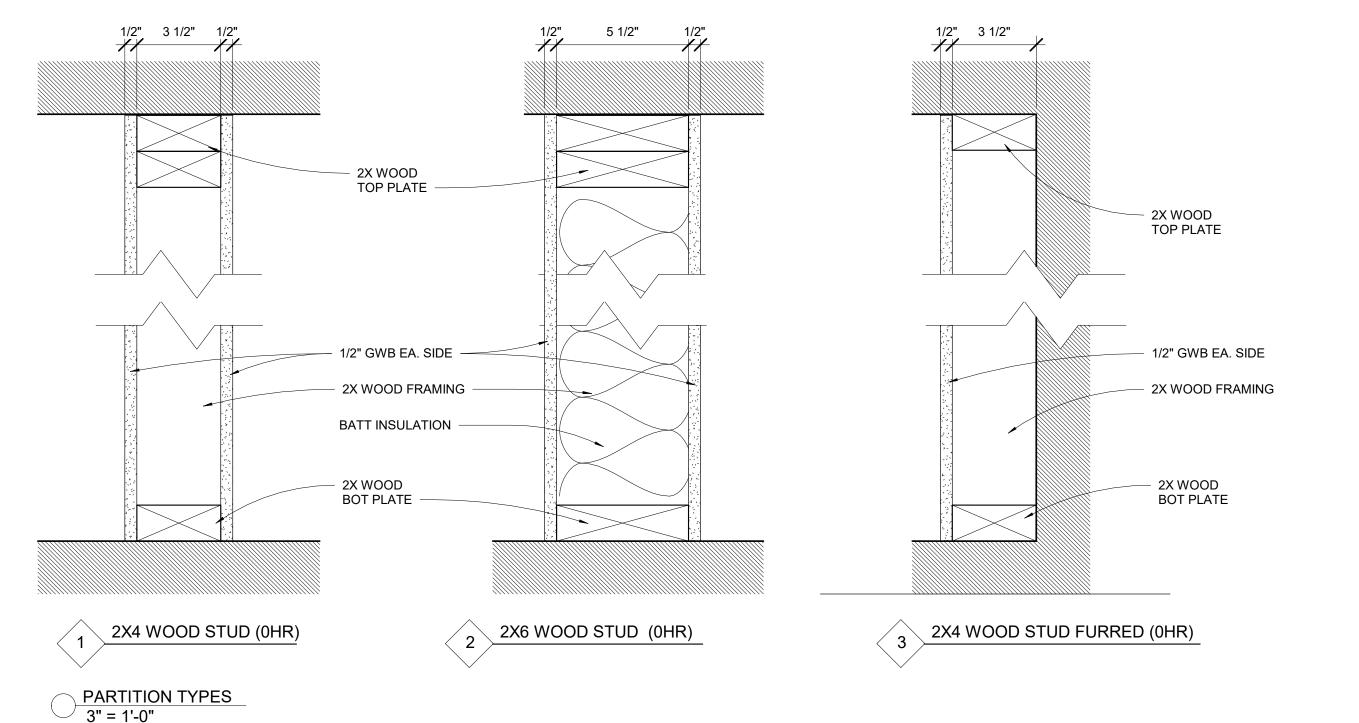

517 boston post rd suite #30 sudbury, ma 01776

p: 508.500.4730 www.s47a.com

PROJECT: **Monument Square** Residence

45 Monument Square Charlestown, MA 02129

CLIENT: River Front Realty

275 Main St Boston, MA 02129

PROJECT TEAM:

**REVISIONS:** 

DRAWING TITLE:


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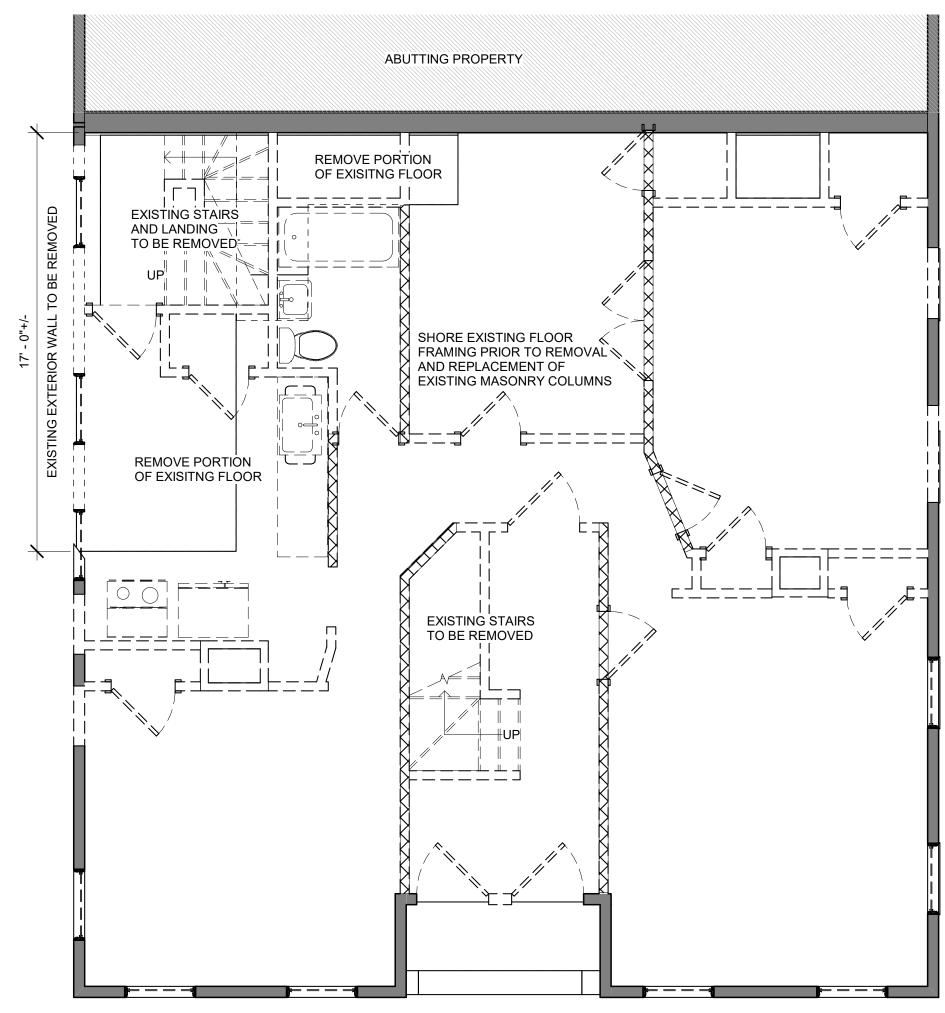
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**DESIGN REVIEW** 

As indicated SCALE

DRAWING NUMBER:



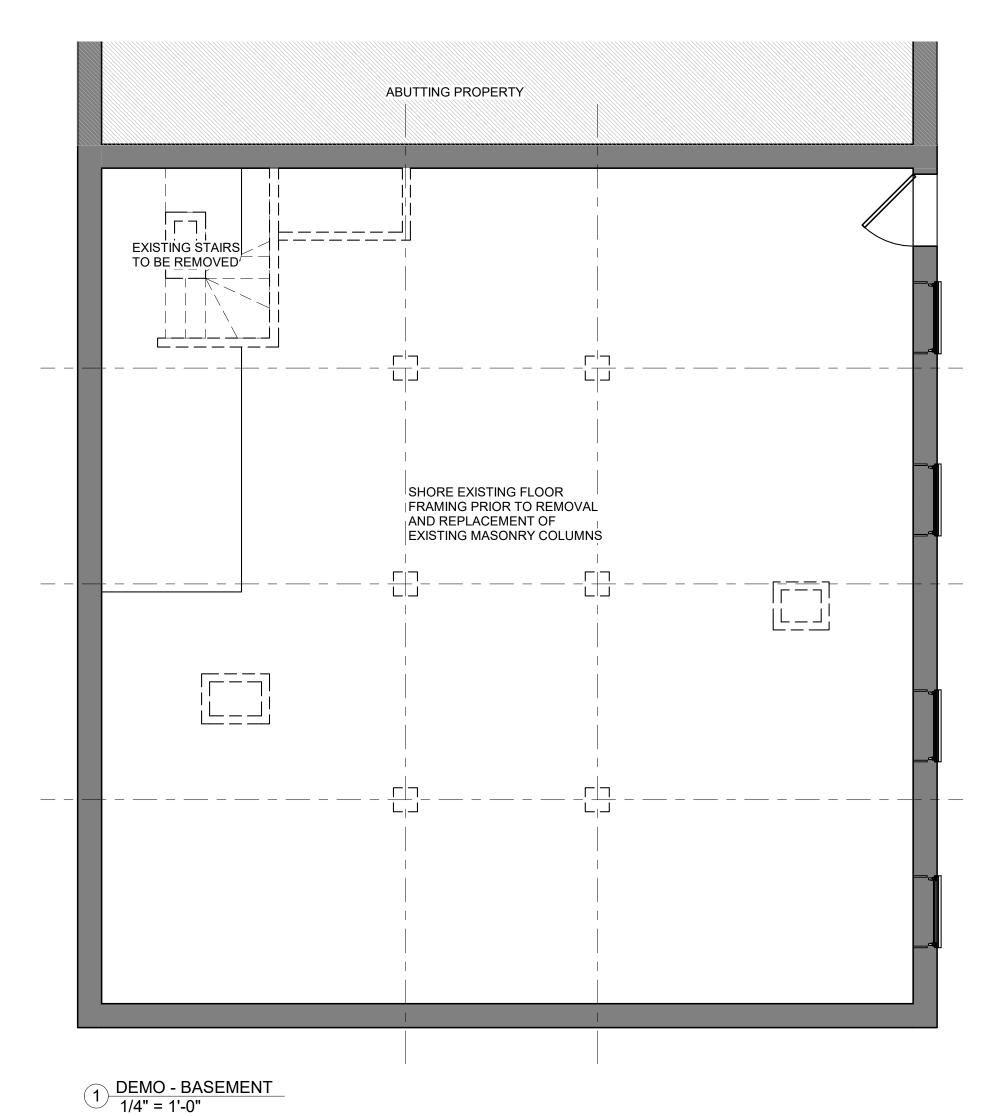

2 DEMO - 1ST FLOOR 1/4" = 1'-0"

**DEMO NOTES:** 

1. ALL EXISTING CEILING AND FLOOR FINISHES TO REMOVED.

2. ALL EXISTING INTERIOR PARTITIONS TO BE REMOVED AS SHOWN.


2. ALL EXISTING PLUMBING AND LIGHTING FIXTURES TO BE REMOVED ON FLOORS 2 THROUGH 4.

3. ALL EXISITNG WDWS & DOORS TO BE REMOVED

EXISTING WALL

4. G.C. TO ENSURE ALL BEARING WALLS NOTED FOR REMOVAL ARE PROPERLY SHORED PRIOR TO DEMO AND UNTIL PROPOSED NEW STRUCTURAL COMPONENT IS INSTALLED

[ \_ \_ \_ \_ \_ EXISTING WALL TO BE REMOVED

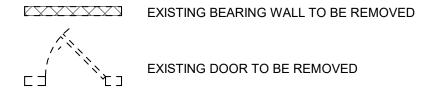

EXISTING DOOR TO BE REMOVED

ARCHITECT

suite #30

PROJECT:

Residence

517 boston post rd

sudbury, ma 01776 p: 508.500.4730 www.s47a.com

Monument Square

45 Monument Square Charlestown, MA 02129

CLIENT: River Front Realty

275 Main St Boston, MA 02129

PROJECT TEAM:

**REVISIONS:** 

**DRAWING TITLE:** 

**DEMO PLANS** 


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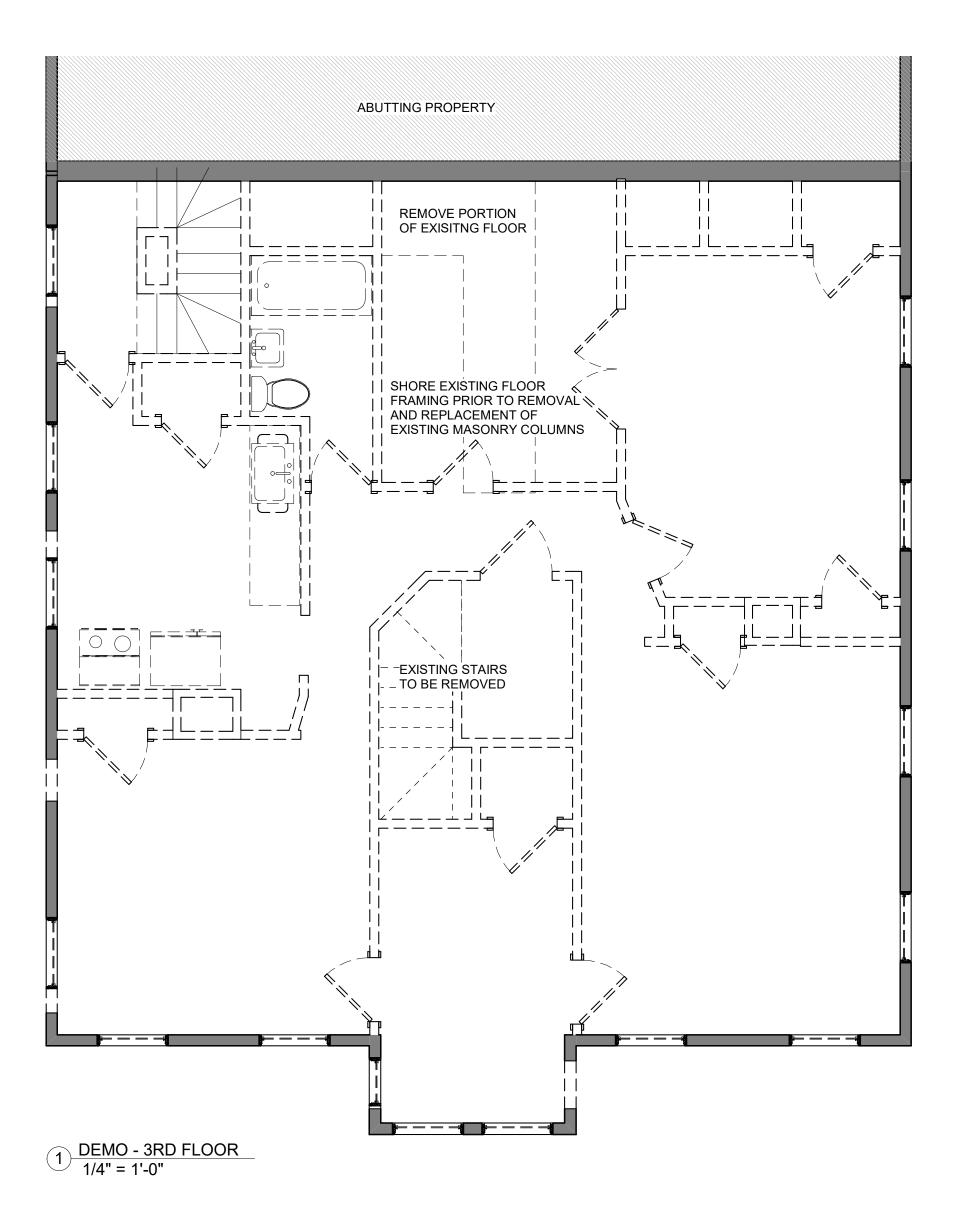


**DESIGN REVIEW** DOCUMENT PHASE

**DRAWING NUMBER:** 

A100



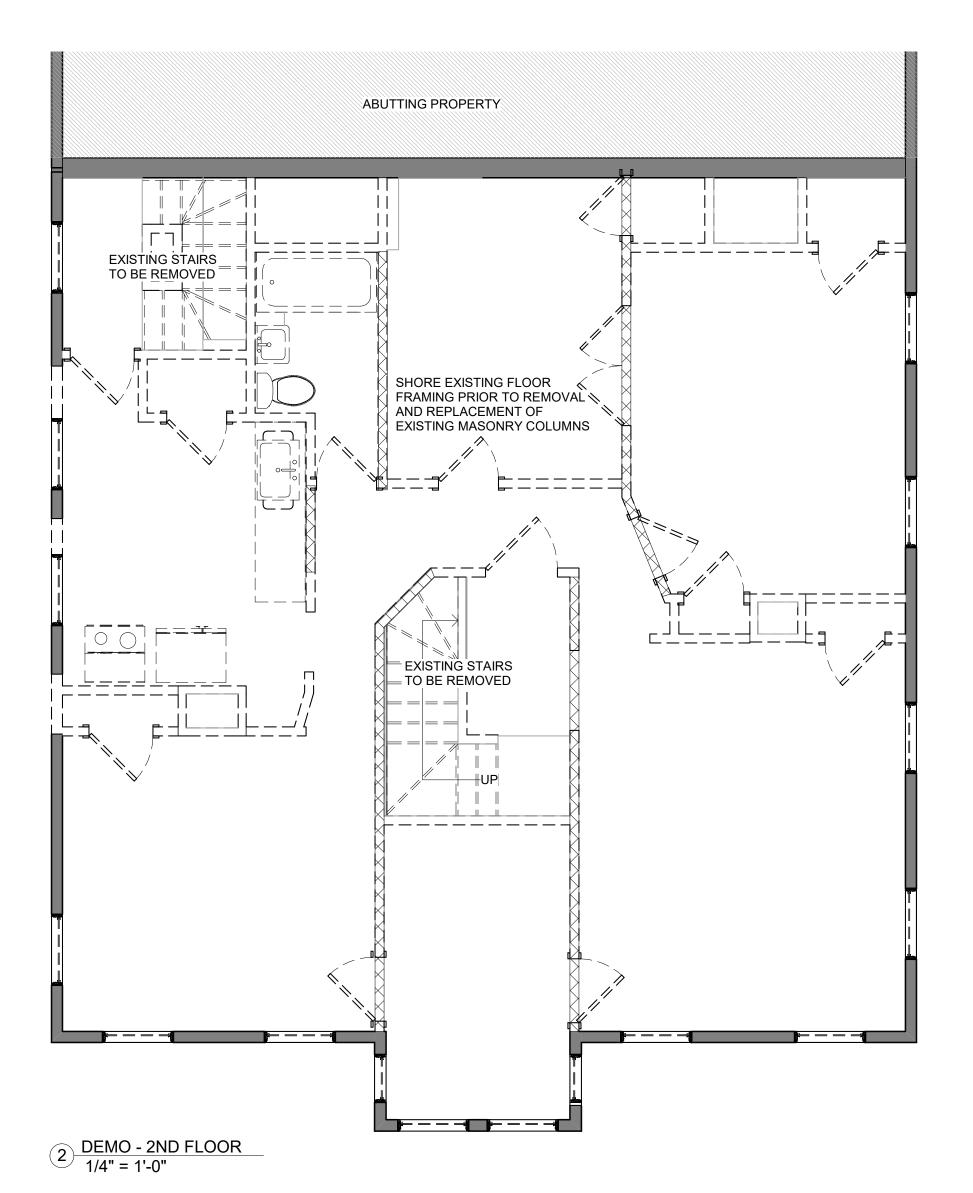


#### **DEMO NOTES:**

- 1. ALL EXISTING CEILING AND FLOOR FINISHES TO REMOVED.
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- 2. ALL EXISTING PLUMBING AND LIGHTING FIXTURES TO BE REMOVED ON FLOORS 2 THROUGH 4.
- 3. ALL EXISITNG WDWS & DOORS TO BE REMOVED
- 4. G.C. TO ENSURE ALL BEARING WALLS NOTED FOR REMOVAL ARE PROPERLY SHORED PRIOR TO DEMO AND UNTIL PROPOSED NEW STRUCTURAL COMPONENT IS INSTALLED

EXISTING WALL

[ \_ \_ \_ \_ \_ EXISTING WALL TO BE REMOVED

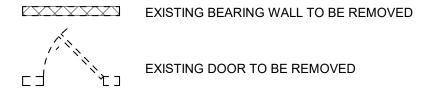

EXISTING DOOR TO BE REMOVED

517 boston post rd suite #30 sudbury, ma 01776

p: 508.500.4730 www.s47a.com

PROJECT: Monument Square Residence

45 Monument Square Charlestown, MA 02129

CLIENT:

River Front Realty

275 Main St

Boston, MA 02129

PROJECT TEAM:

**REVISIONS:** 

**DRAWING TITLE:** 

**DEMO PLANS** 

STAMP




**DESIGN REVIEW** 

DOCUMENT PHASE

2114.00 PROJECT #

**DRAWING NUMBER:** 

A101

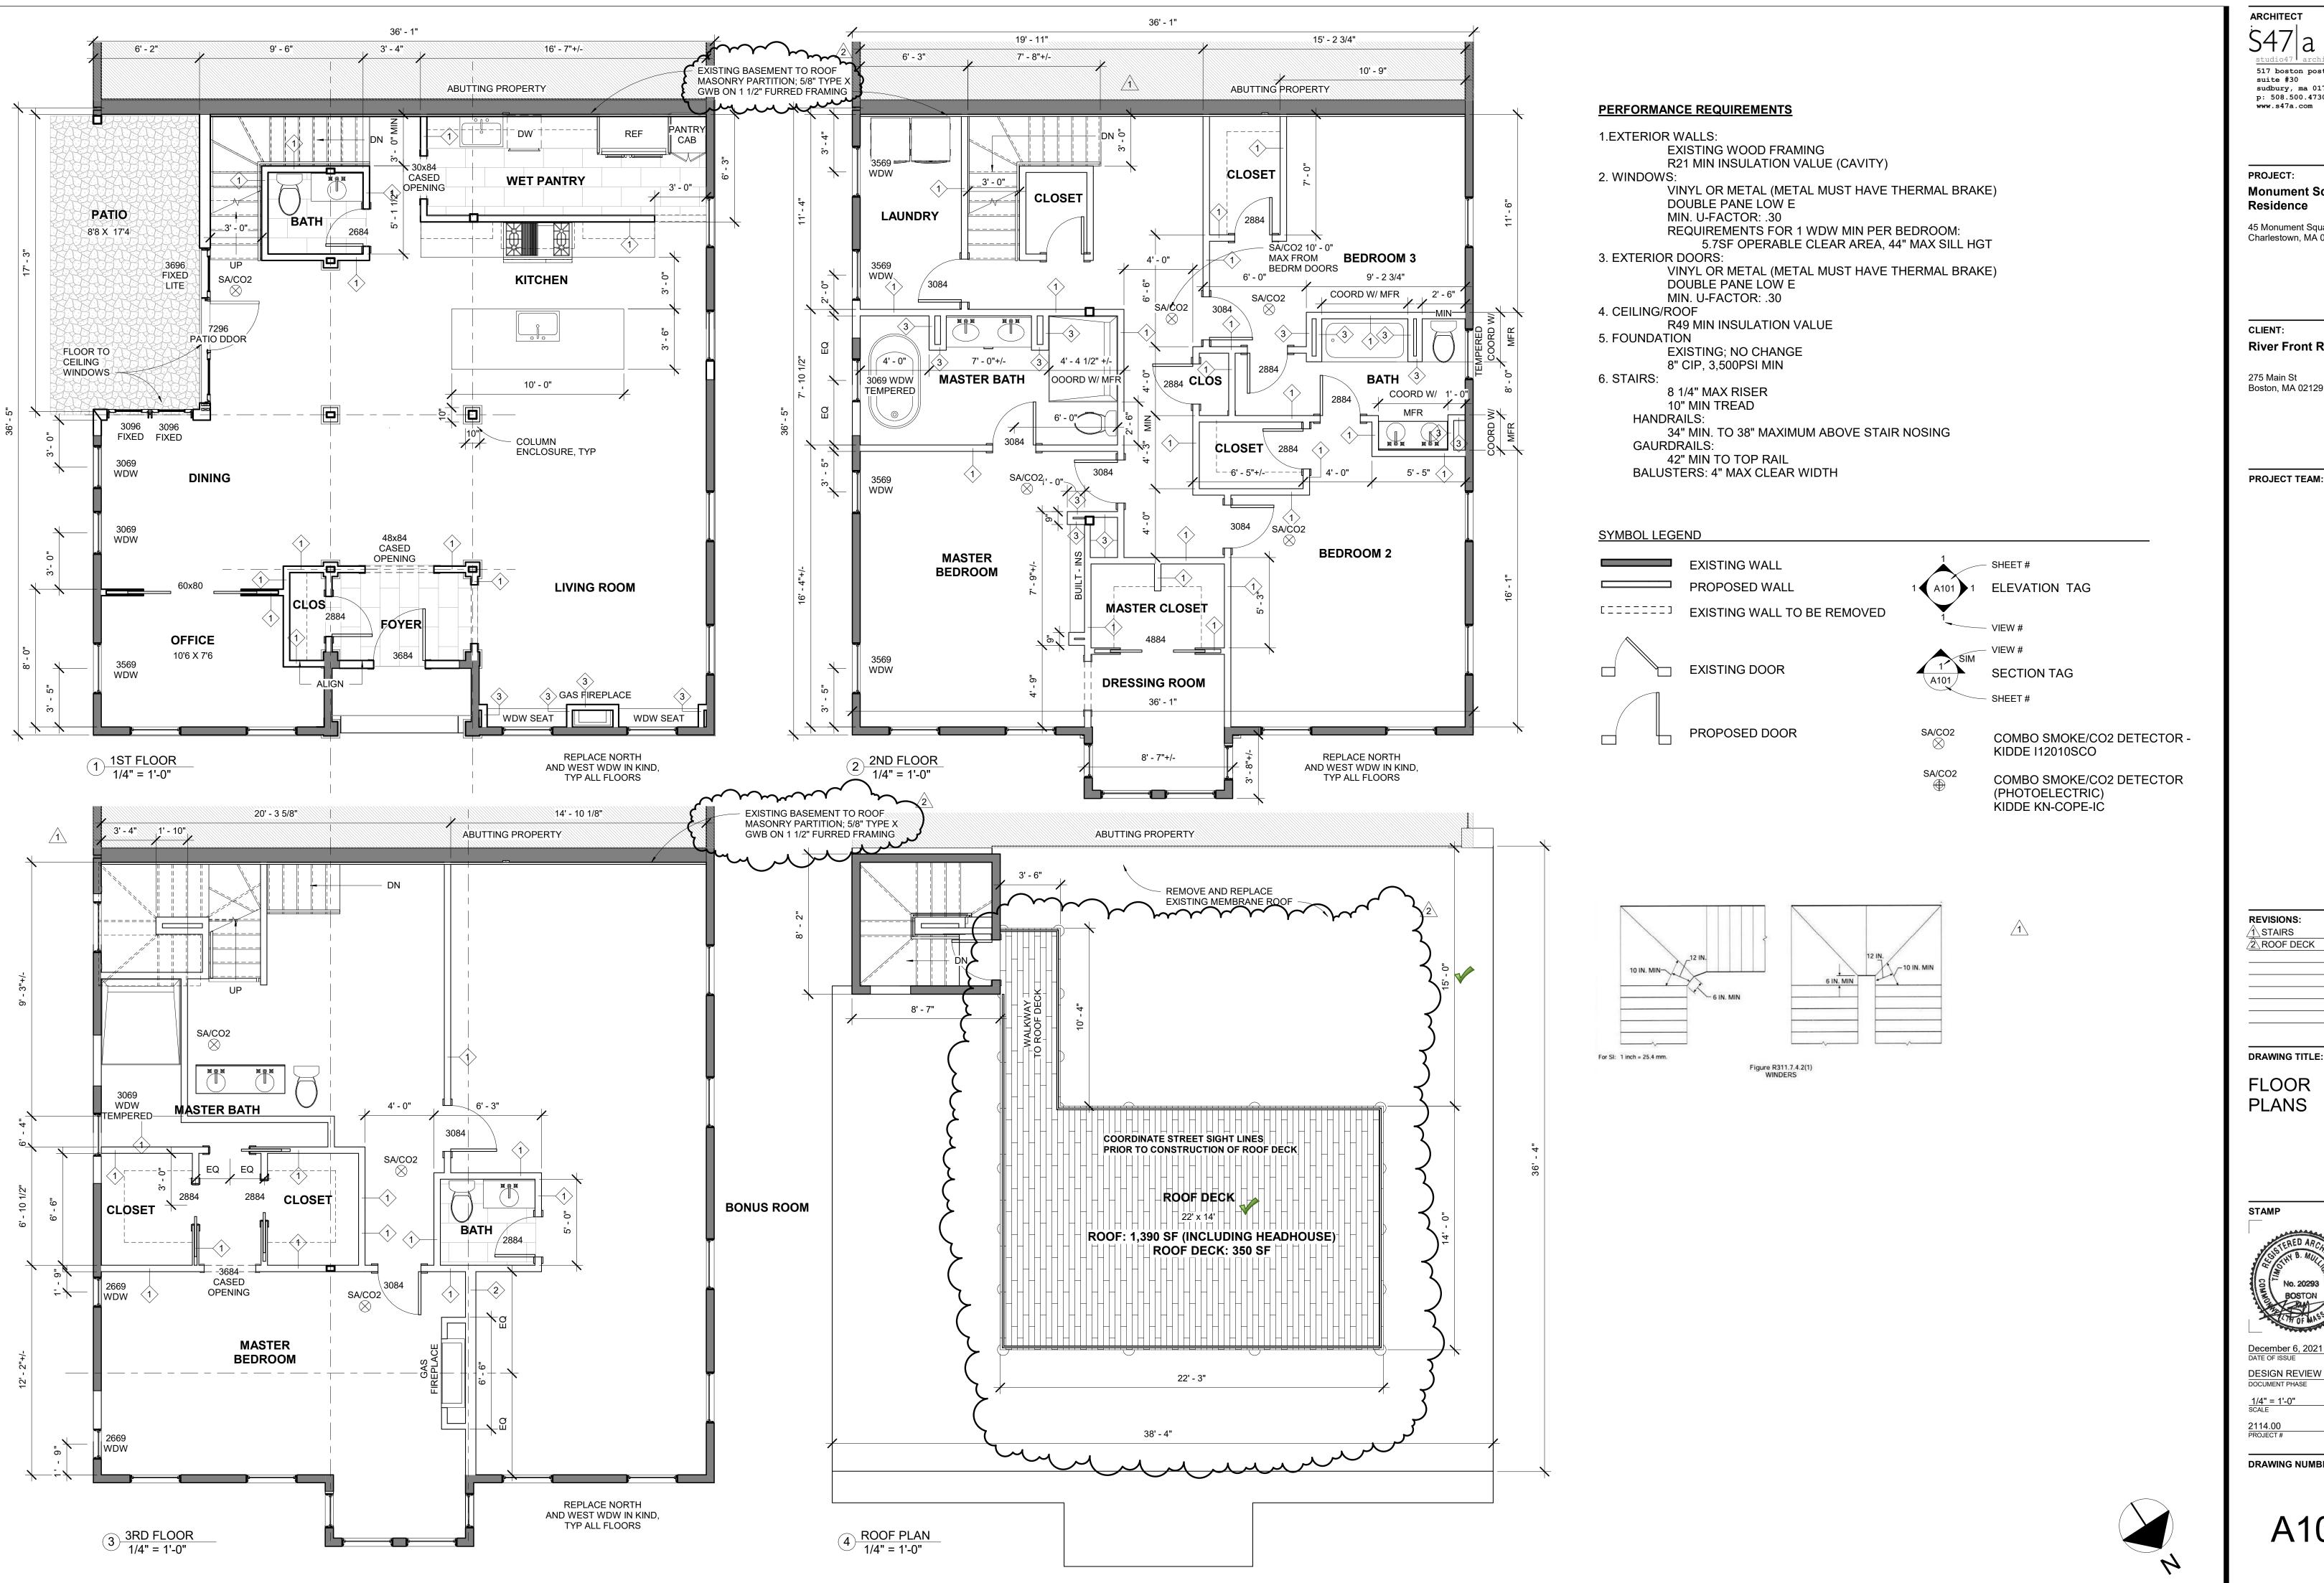

ARCHITECT

517 boston post rd suite #30 sudbury, ma 01776 p: 508.500.4730

> PROJECT: Monument Square Residence

45 Monument Square Charlestown, MA 02129

CLIENT:

River Front Realty

275 Main St Boston, MA 02129

PROJECT TEAM:

12.27.21

DRAWING TITLE:

**FLOOR PLANS** 

STAMP





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DRAWING NUMBER:

A102





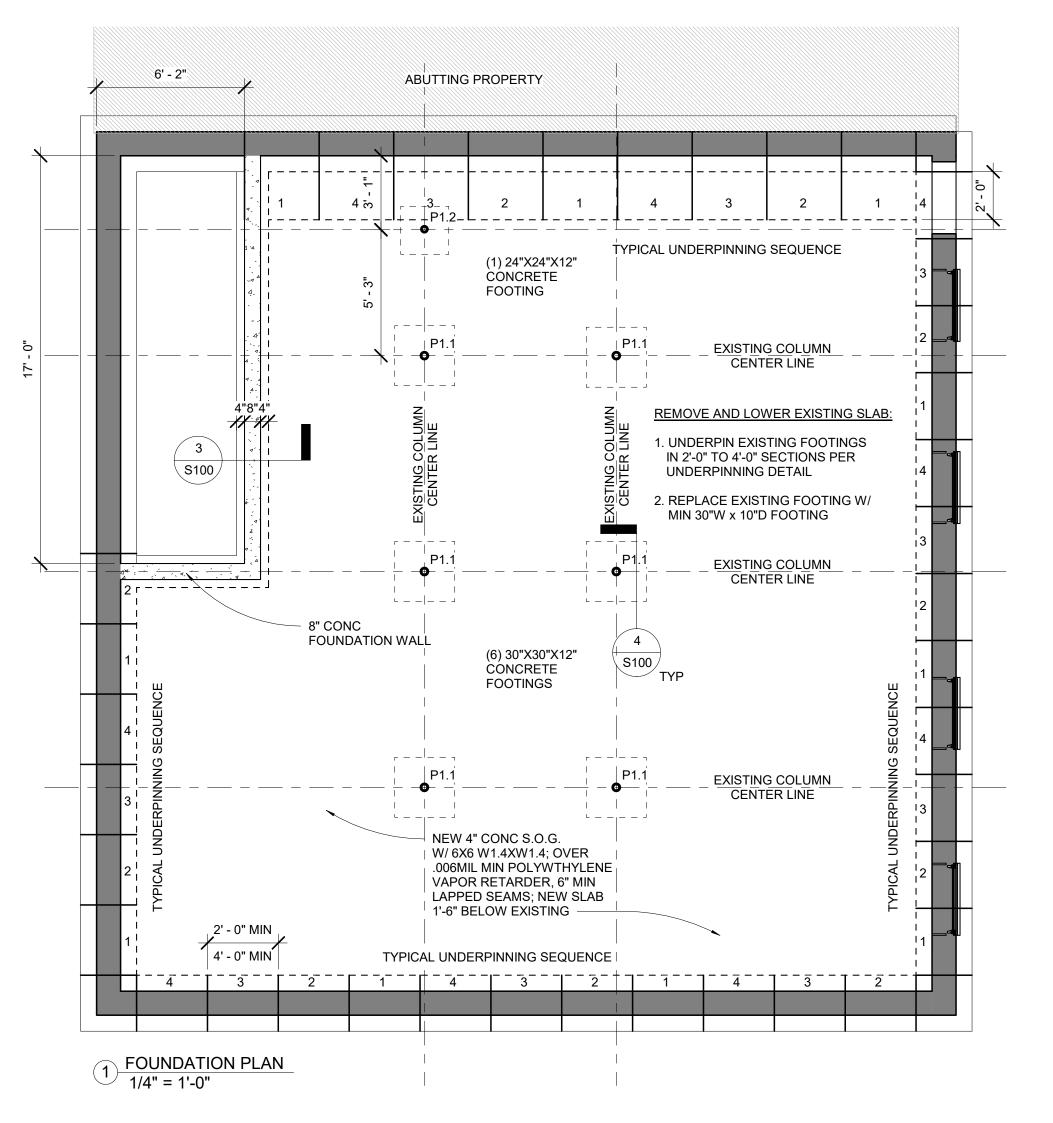


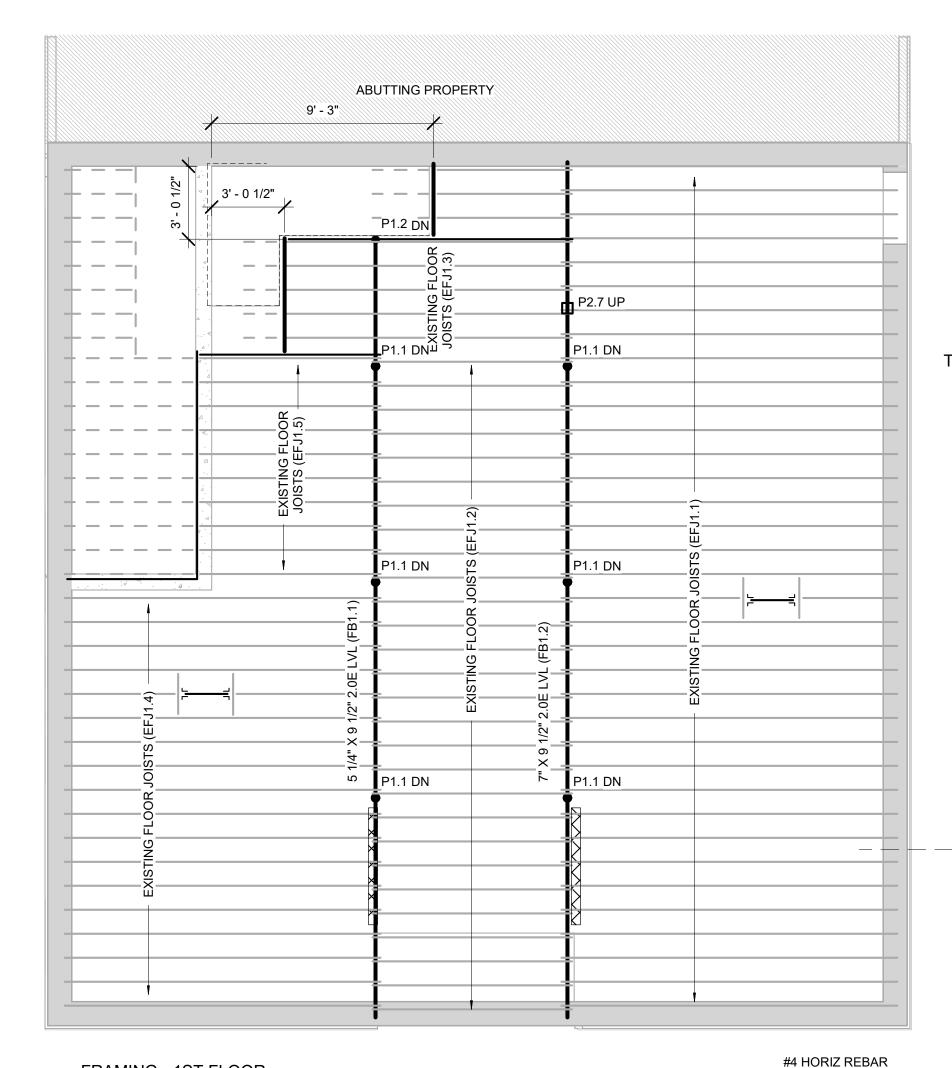(PER TABLE R4041.2(1))

#6 VERT REBAR

#4 HORIZ REBAR

NEIGHBOR: EXISTING BASEMENT WALL EXISTING BASEMENT WALL **EXISTING FOOTING** EXISTING FOOTING DRILL & EPOXY #4 REBAR INTO EXISTING WALL 6" MIN EMBED; (2) PER UNDERPIN SECTION CONCRETE UNDERPINNING; #4 HORIZ DOWEL INTO ADJ PIER EXCAVATE AT 2' TO 4' INCREMENTS 1 PER 24" HGT IN STEM WALL 4" CONCRETE SLAB 4" CONCRETE SLAB #5 DOWEL @ 12" O.C. 90DEG STD HOOK .006MIL MIN VAPOR RETARDER .006MIL MIN VAPOR 6" GRAVEL BASE RETARDER 6" GRAVEL BASE TYPICAL UNDERPINNING DETAIL (N.T.S.) CONCRETE UNDERPINNING; EXCAVATE AT 2' TO 4' INCREMENTS UNDERPINNING DETAIL @ ABBUTTING PROPERTY (N.T.S.)

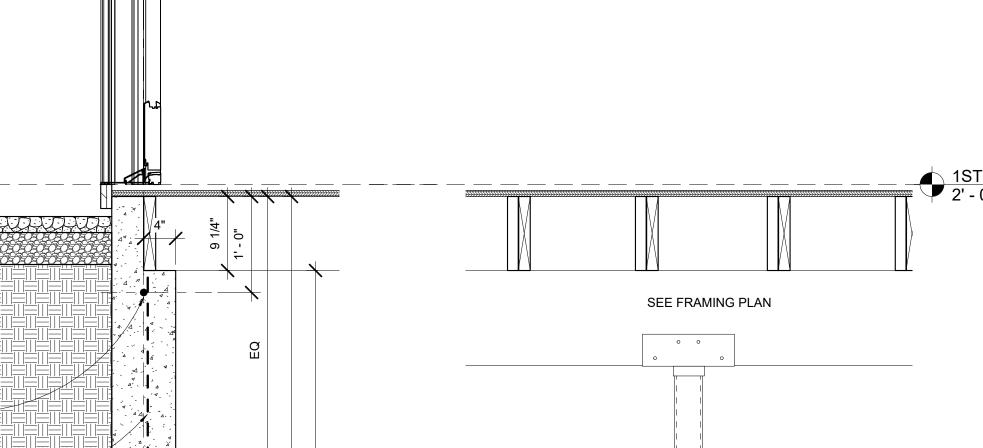

FRAMING NOTES:

1. FRAMING BASED ON ASSUMPTIONS OF EXISTING CONDITIONS; ALERT ARCHITECT OF CONDITIONS THAT VARY FROM EXISTING LAYOUT

2. COMMODITY FRAMING GRADE TO BE DOUGLAS FIR #2 (EQUAL OR BETTER) ALL EXTERIOR FRAMING TO BE PRESSURE TREATED (P.T.)

3. INSTALL BTWN JOIST FULL DEPTH BLOCKING AT DROP BEAMS AND BEARING WALLS.

4. INSTALL SIMPSON JOIST HANGERS AT ALL FACE MOUNT JOIST, U.N.O.

5. INSTALL 3/4" T&G PLYWOOD SUB-FLOOR GLUE AND NAIL, TYP ALL FLOORS

6. NOTCHING OR DRILLING HOLES IN JOISTS TO BE APPROVED BY ENGINEER

7. SPLICE BEAMS AT SUPPORTS

8. INSULATE AT ALL WINDOWS AND EXTERIOR DOOR HEADERS.

9. <u>LIVE LOADS:</u> BEDROOMS OTHER THAN BEDROOMS EXTERIOR DECK SNOW LOAD	30 PSF 40 PSF 40 PSF 50PSF
	EXISTING FRAMING
	EXISTING FRAMING TO BE REMOVED

⇒ PROPOSED FRAMING

COLUMN SCHEDULE				
MARK	DESCRIPTION	COMMENTS		
P1.1	3 1/2" DIA SCHED 80 PIPE	A501 OR A53 GRADE B		
P1.2	3" DIA SCHED 80 PIPE			
P2.1	4X6 DF2			
P2.2	4X6 DF2			
P2.3	4X6 DF2			
P2.4	4X6 DF2			
P2.5	4X6 DF2			
P2.6	6X6 DF2			
P2.7	5 1/4" X 5 1/4" 1.8E PSL			
P2.9	6X6 P.T. DF2			
P4.1A	6X6 DF2			
P4.1B	6X6 DF2			
P5.1	4X6 DF2			

2 FRAMING - 1ST FLOOR 1/4" = 1'-0"

**CONCRETE NOTES:** 

1. ALL CONCRETE WORK SHALL COMPLY WITH ACI 318: BUILDING CODE REQUIREMENTS FOR REINFORCED CONCRETE.


2. ALL CONCRETE SHALL COMPLY WITH ACI 301; SPECIFICATIONS FOR STRUCTURAL CONCRETE FOR BUILDINGS.

3. 2,500 MIN PSI COMPRESSIVE STRENGTH POST 28 DAYS

4. ALL CONCRETE TO BE POURED MONOLITHICALLY. UNO

5. CONCRETE FOUNDATIONS SHALL COMPLY WITH SECTION 18 OF IBC 2015 780CMR.

6. STEEL REINFORCING SHALL COMPLY WITH ASTM 615 GRADE 60, U.N.O.

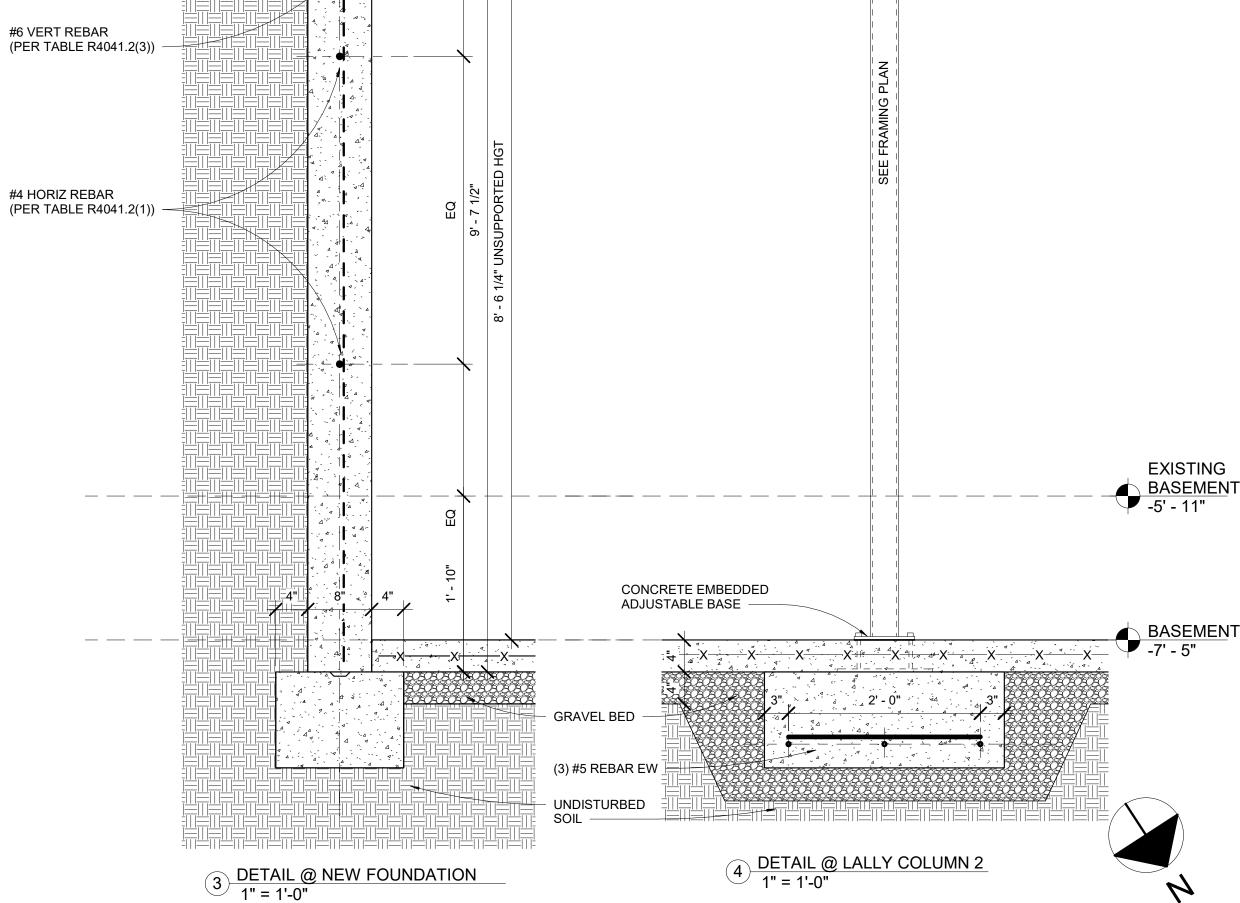

ARCHITECT

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45 Monument Square

Charlestown, MA 02129

CLIENT:

Boston, MA 02129

River Front Realty 275 Main St

PROJECT TEAM:

**REVISIONS:** 

DRAWING TITLE:

FRAMING PLANS -BASEMENT &

1STR FLOOR


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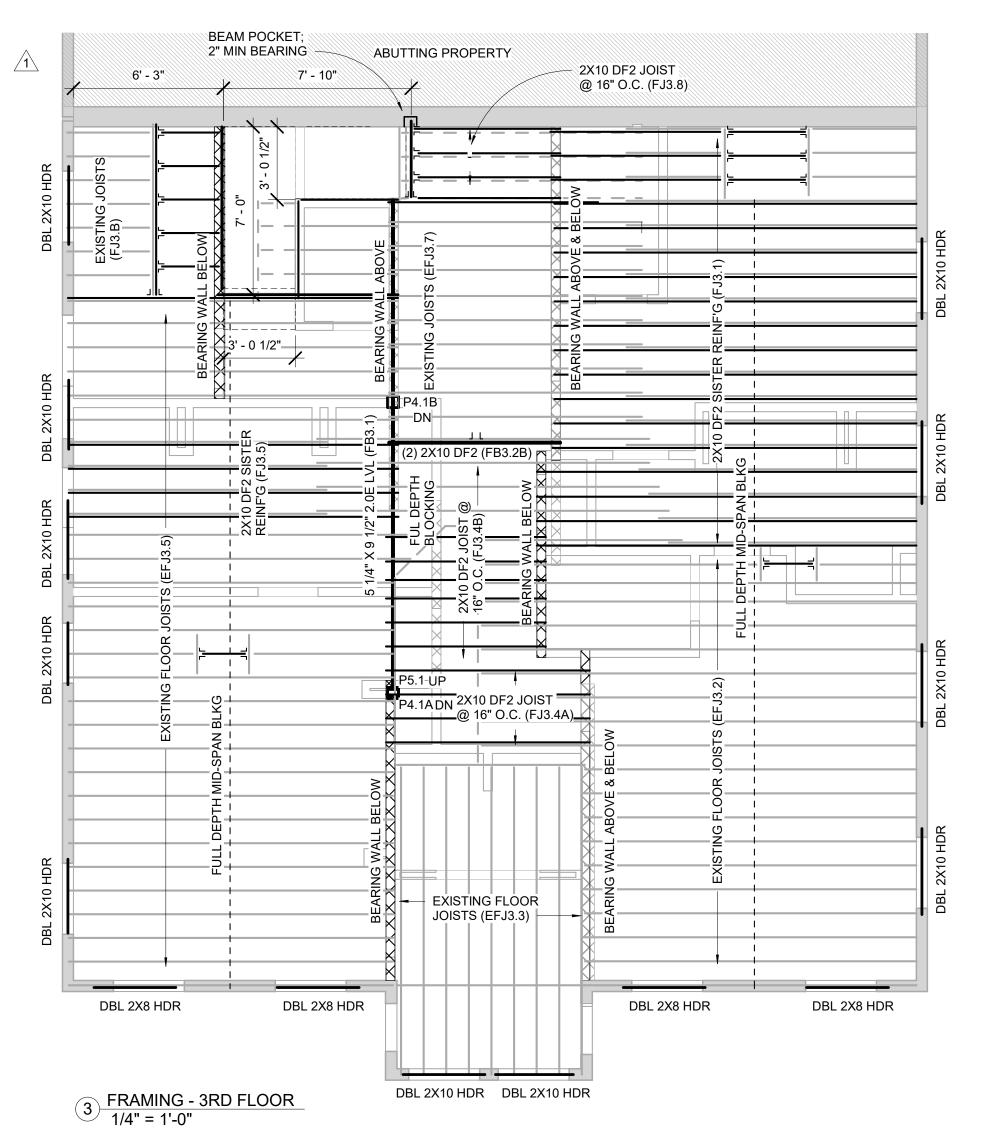
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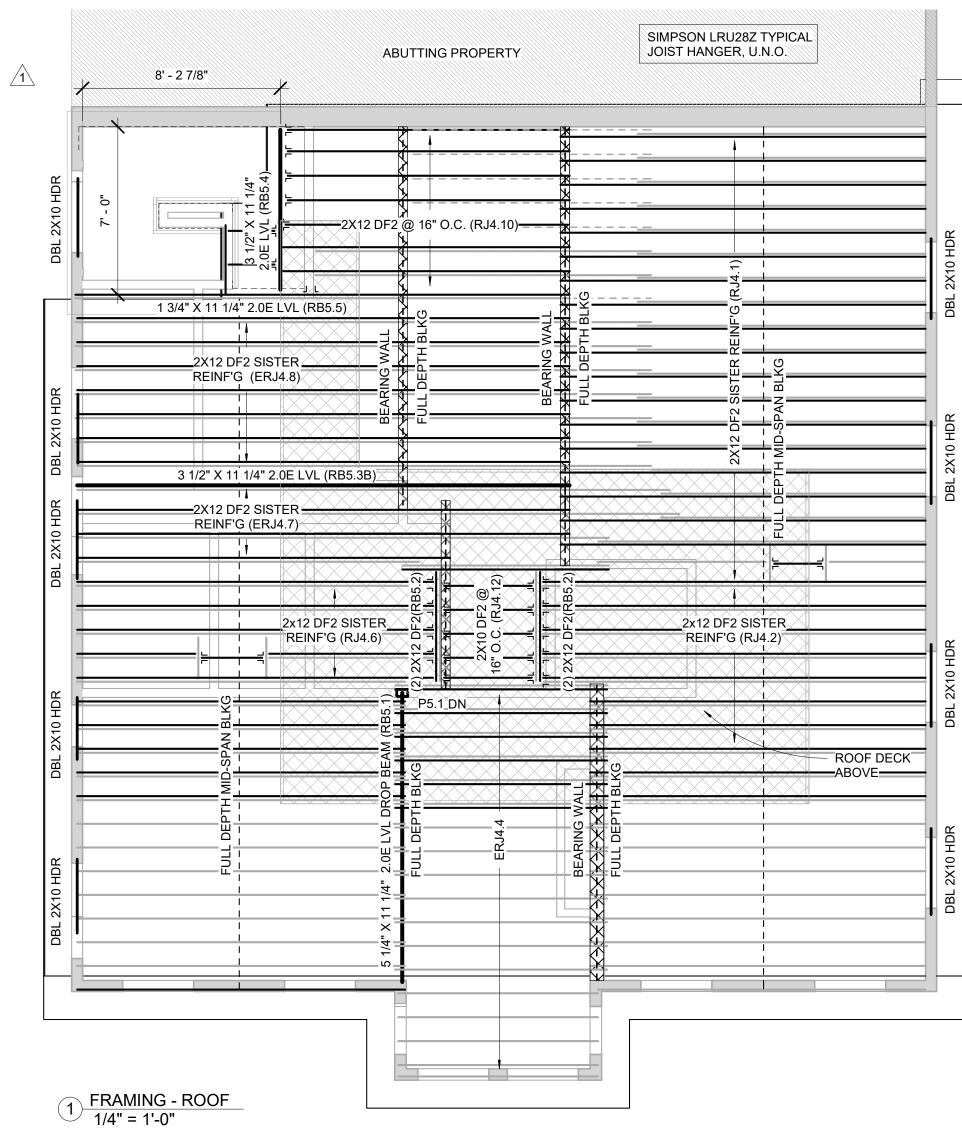
DOCUMENT PHASE As indicated SCALE

DRAWING NUMBER:

S100





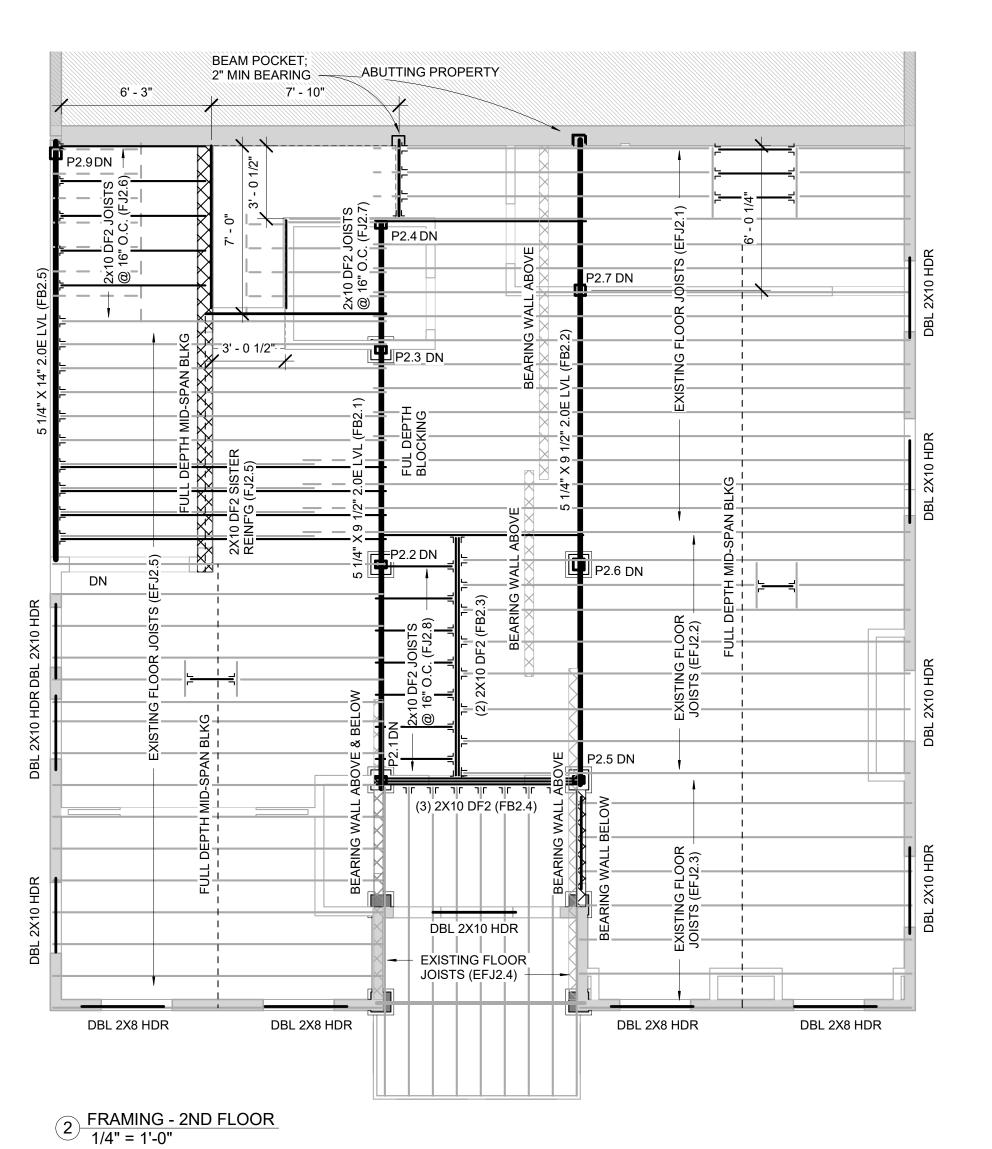

### FRAMING NOTES:

1. FRAMING BASED ON ASSUMPTIONS OF EXISTING CONDITIONS; ALERT ARCHITECT OF CONDITIONS THAT VARY FROM EXISTING LAYOUT

2. COMMODITY FRAMING GRADE TO BE DOUGLAS FIR #2 (EQUAL OR BETTER) ALL EXTERIOR FRAMING TO BE PRESSURE TREATED (P.T.)

3. INSTALL BTWN JOIST FULL DEPTH BLOCKING AT DROP BEAMS AND BEARING WALLS.

4. INSTALL SIMPSON JOIST HANGERS AT ALL FACE MOUNT JOIST, U.N.O.

5. INSTALL 3/4" T&G PLYWOOD SUB-FLOOR GLUE AND NAIL, TYP ALL FLOORS

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8. INSULATE AT ALL WINDOWS AND EXTERIOR DOOR HEADERS.

9. LIVE LOADS:
BEDROOMS
OTHER THAN BEDROOMS
EXTERIOR DECK
SNOW LOAD

EXISTING FRAMING
TO BE REMOVED

PROPOSED FRAMING

COLUMN SCHEDULE			
MARK	DESCRIPTION	COMMENTS	
P1.1	3 1/2" DIA SCHED 80 PIPE	A501 OR A53 GRADE B	
P1.2	3" DIA SCHED 80 PIPE		
P2.1	4X6 DF2		
P2.2	4X6 DF2		
P2.3	4X6 DF2		
P2.4	4X6 DF2		
P2.5	4X6 DF2		
P2.6	6X6 DF2		
P2.7	5 1/4" X 5 1/4" 1.8E PSL		
P2.9	6X6 P.T. DF2		
P4.1A	6X6 DF2		
P4.1B	6X6 DF2		
P5.1	4X6 DF2		

ARCHITECT

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PROJECT:
Monument Square
Residence

45 Monument Square Charlestown, MA 02129

CLIENT:

River Front Realty

275 Main St Boston, MA 02129

PROJECT TEAM:

REVISIONS:

\_\_\_\_

DRAWING TITLE:

FRAMING PLANS - 2ND, 3RD & ROOF

12.27.21

STAMP




December 6, 2021
DATE OF ISSUE
DESIGN REVIEW
DOCUMENT PHASE

2114.00 PROJECT#

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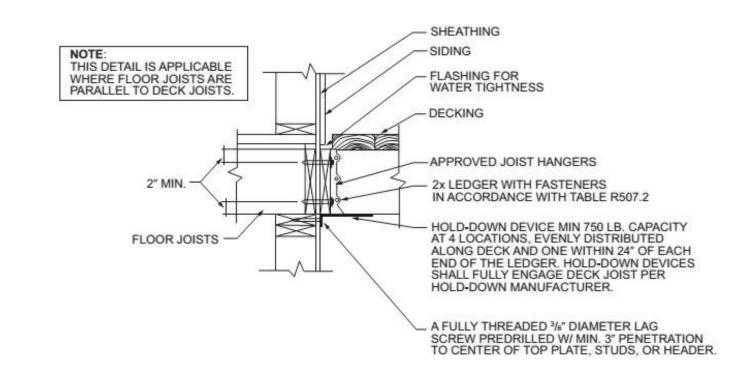
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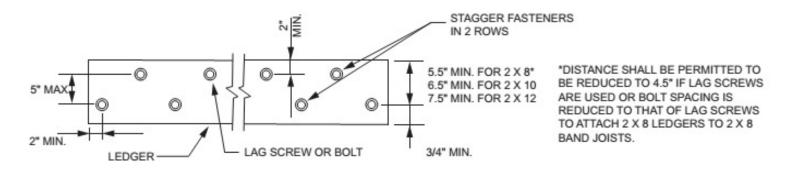


## FRAMING NOTES:

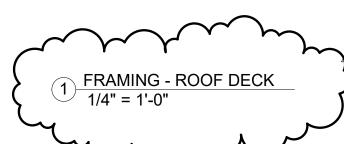- 1. FRAMING BASED ON ASSUMPTIONS OF EXISTING CONDITIONS; ALERT ARCHITECT OF CONDITIONS THAT VARY FROM EXISTING LAYOUT
- 2. COMMODITY FRAMING GRADE TO BE DOUGLAS FIR #2 (EQUAL OR BETTER) ALL EXTERIOR FRAMING TO BE PRESSURE TREATED (P.T.)
- 3. INSTALL BTWN JOIST FULL DEPTH BLOCKING AT DROP BEAMS AND BEARING WALLS.
- 4. INSTALL SIMPSON JOIST HANGERS AT ALL FACE MOUNT JOIST, U.N.O.
- 5. INSTALL 3/4" T&G PLYWOOD SUB-FLOOR GLUE AND NAIL, TYP ALL FLOORS
- 6. NOTCHING OR DRILLING HOLES IN JOISTS TO BE APPROVED BY ENGINEER
- 7. SPLICE BEAMS AT SUPPORTS
- 8. INSULATE AT ALL WINDOWS AND EXTERIOR DOOR HEADERS.

9. <u>LIVE LOADS:</u> BEDROOMS OTHER THAN BEDROOMS EXTERIOR DECK SNOW LOAD	30 PSF 40 PSF 40 PSF 50PSF
	EXISTING FRAMING
	EXISTING FRAMING TO BE REMOVED
=======================================	PROPOSED FRAMING





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PROJECT TEAM:

REVISIONS:

PROOF DECK 1.31.22

**DRAWING TITLE:** 

FRAMING
PLANS ROOF DECK
& HEAD
HOUSE

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