
PLAN OF LAND

LOCATED AT 1084-1086 CANTERBURY STREET BOSTON, MA


SCALE: 1 INCH = 20 FEET

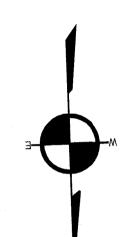

1082 CANTERBURY ST. **ESPINAL**

REFERENCES

DEED: BOOK 14204, PAGE 339 PLAN: BOOK 5005-END

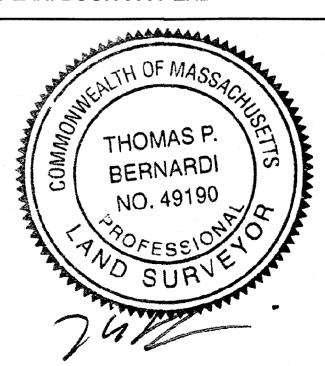


CERTIFICATION

I CERTIFY THAT THIS PLAN WAS MADE FROM AN INSTRUMENT SURVEY ON THE GROUND BETWEEN THE DATES OF APRIL 15 AND APRIL 29, 2018 AND ALL STRUCTURES ARE LOCATED AS SHOWN HEREON.

I HEREBY CERTIFY THAT THIS PLAN WAS PREPARED IN CONFORMITY WITH THE RULES AND REGULATIONS OF THE REGISTERS OF DEEDS OF THE COMMONWEALTH OF MASSACHUSETTS.

THOMAS BERNARDI P.L.S.


DATE: MAY 3, 2018

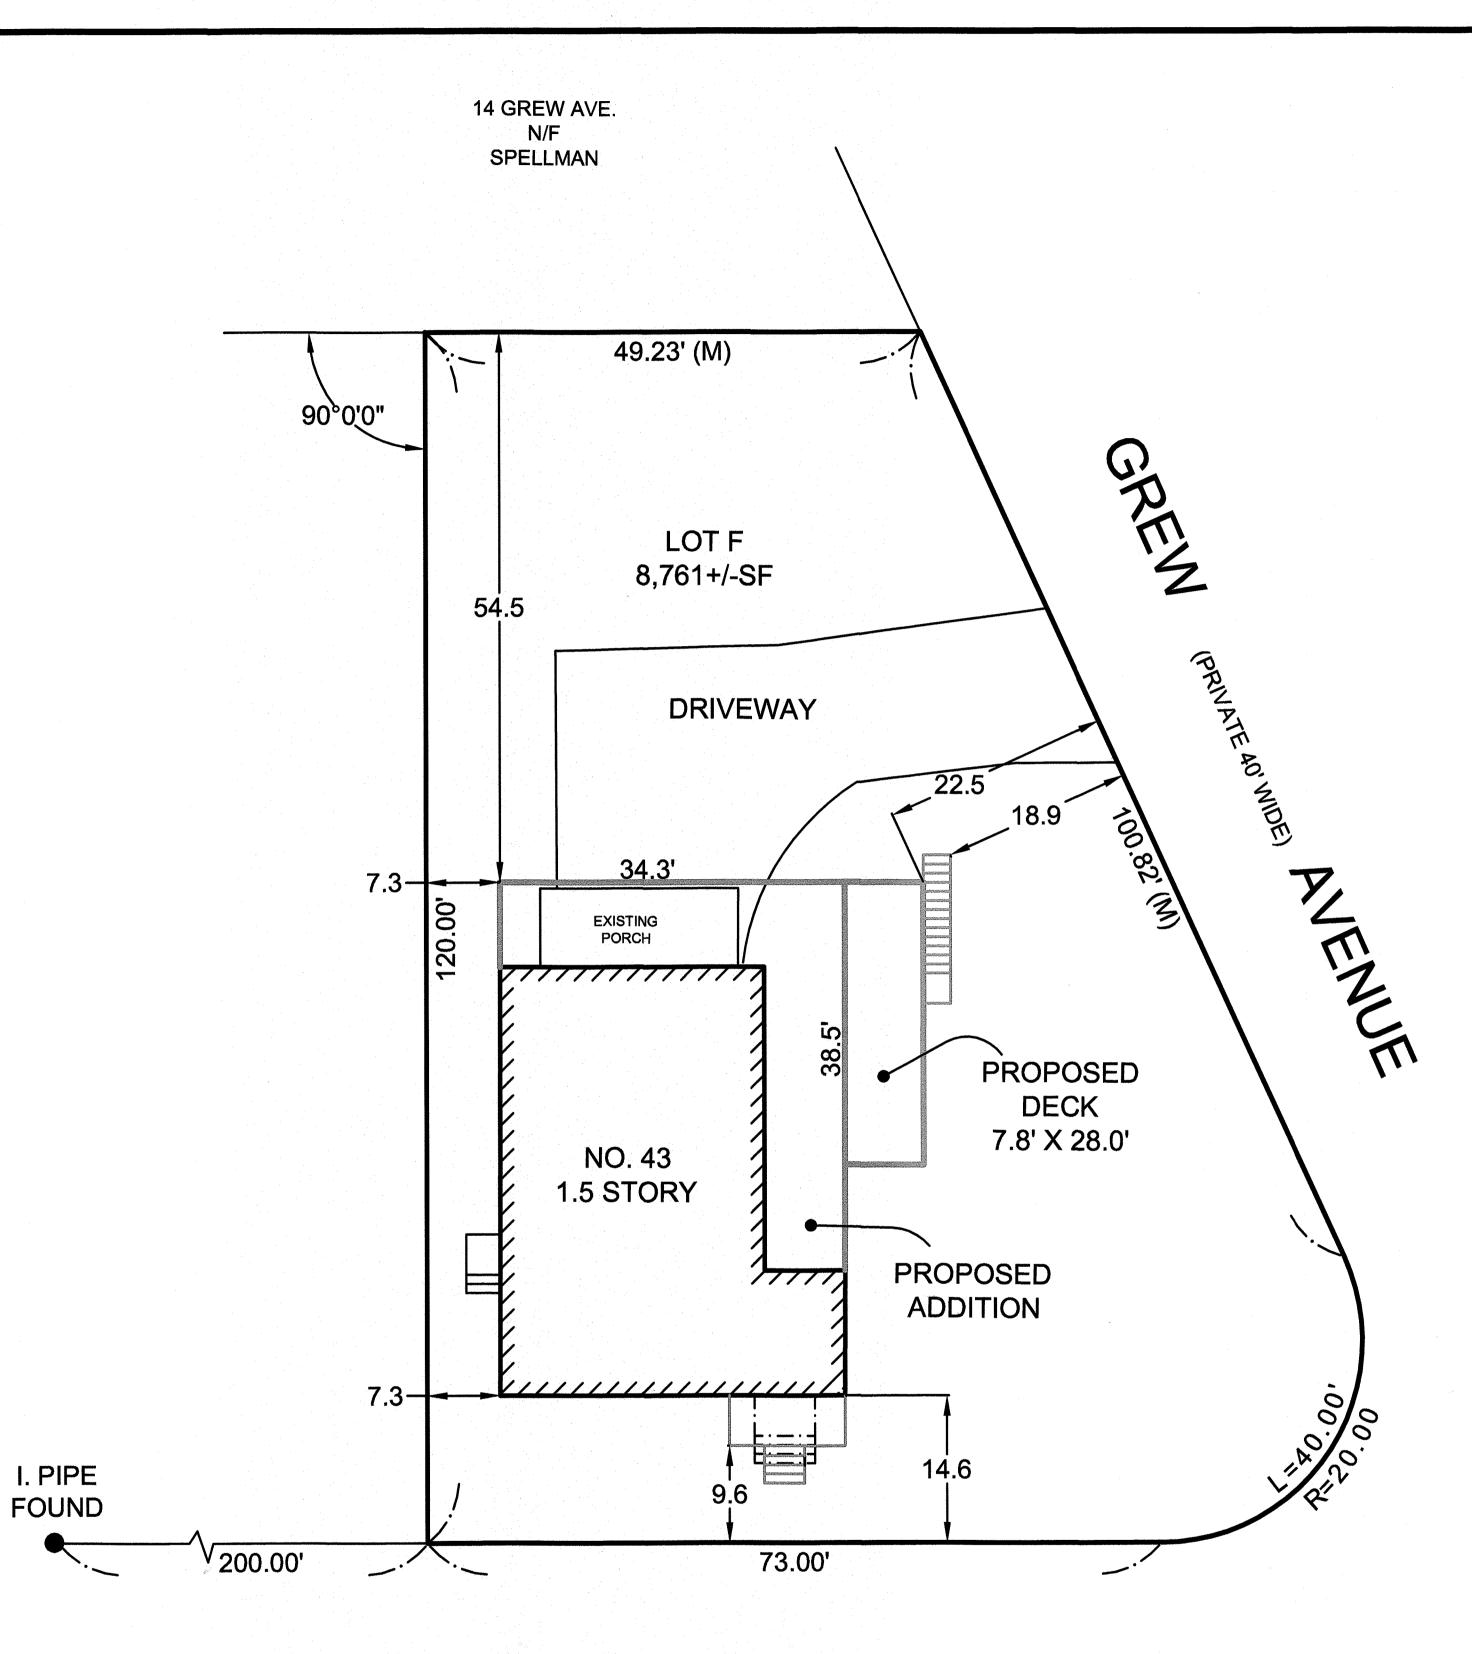

MASSACHUSETTS SURVEY CONSULTANTS

14 SUMNER STREET GLOUCESTER, MA 01930 617 899-0703 WWW.MASSACHUSETTSSURVEY.COM

CANTERBURY (PUBLIC VAR. WIDTH) STREET

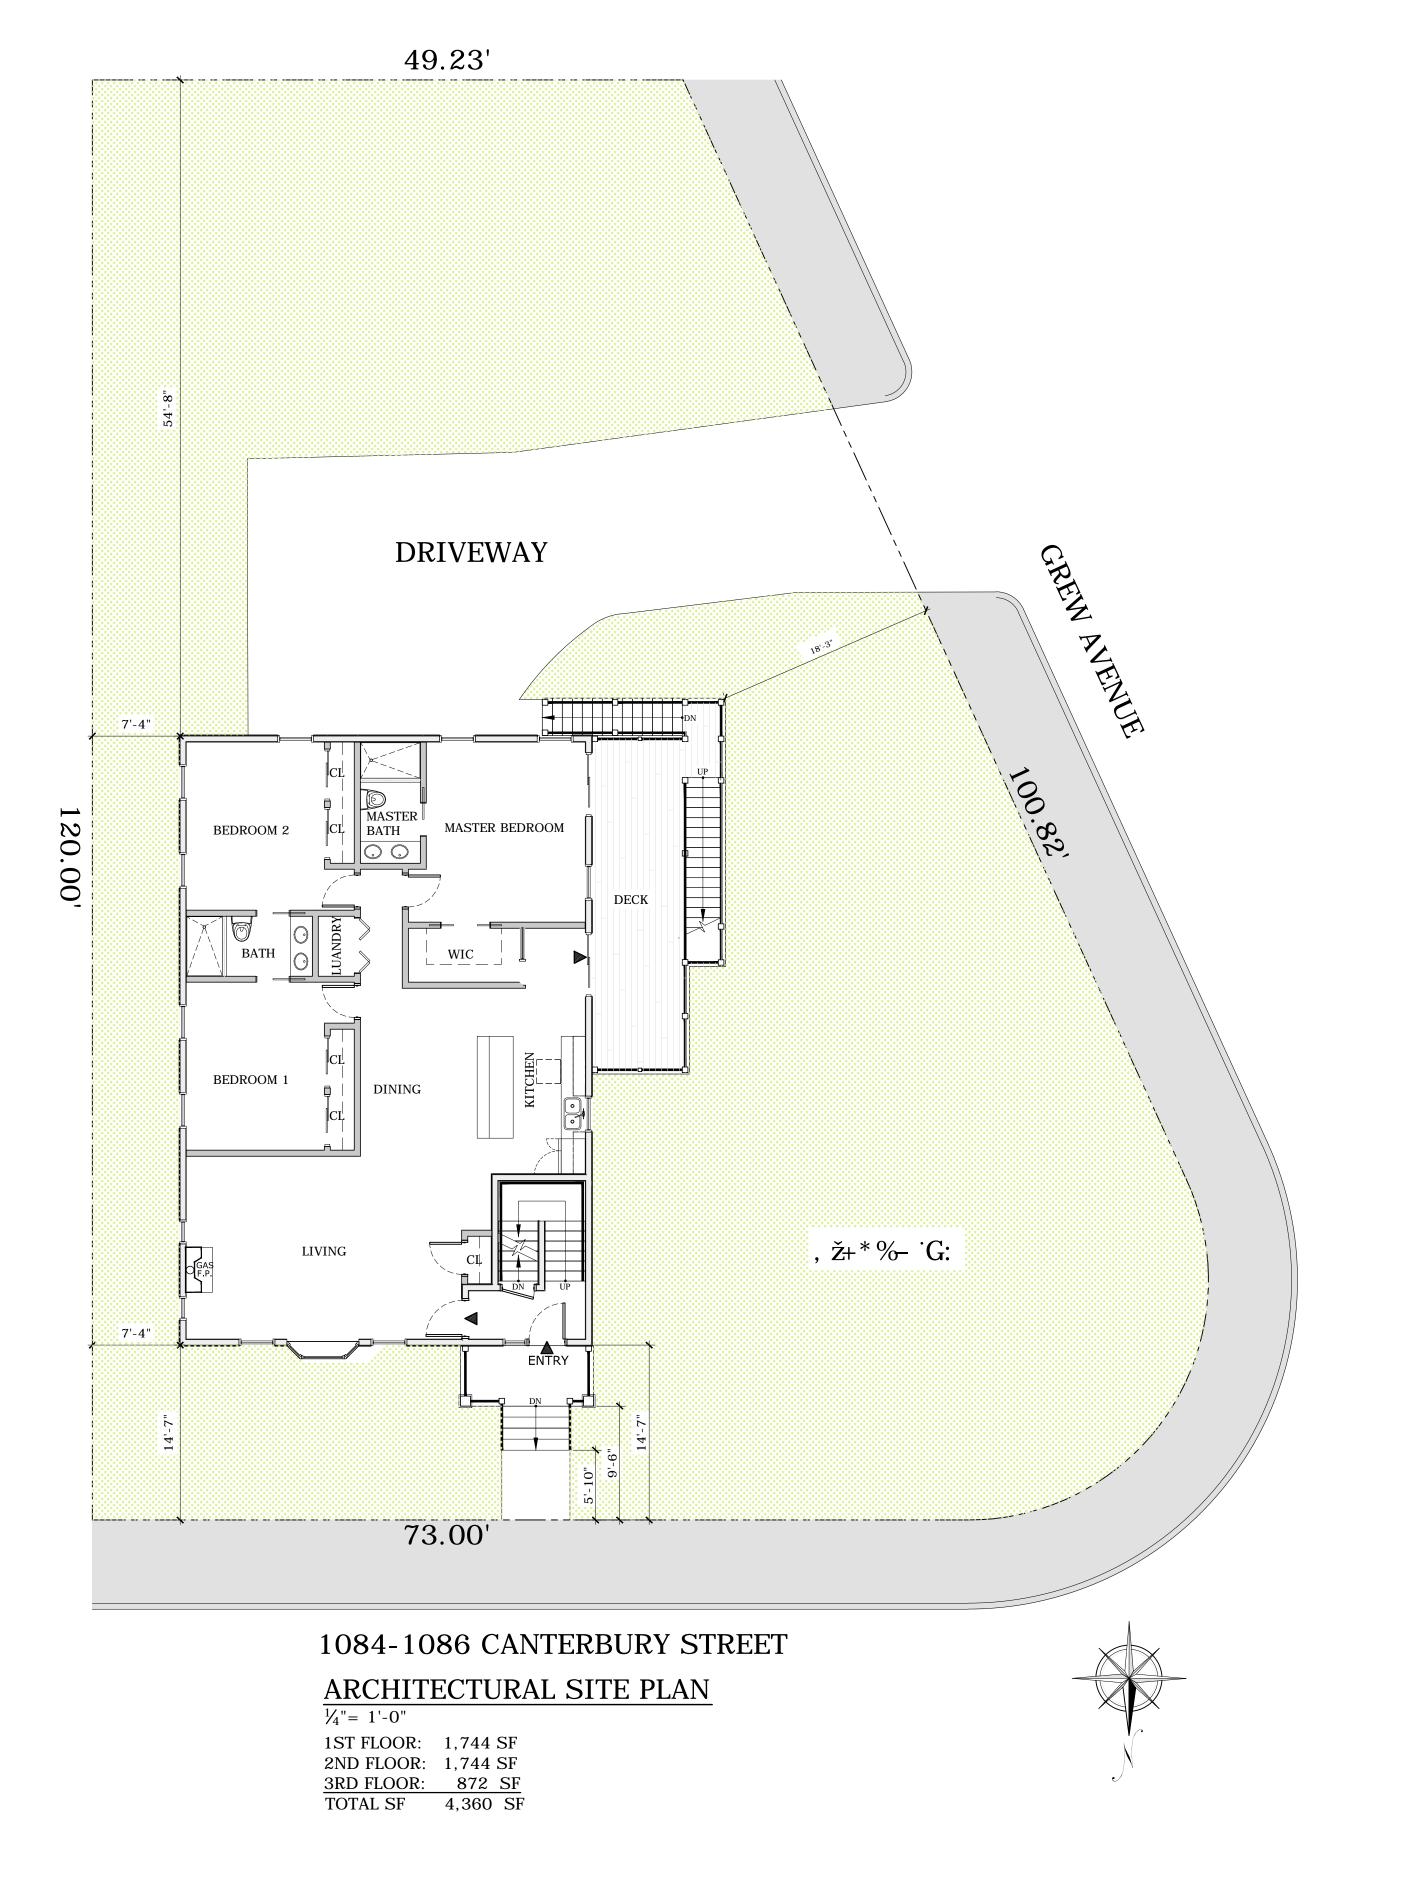

SHEET INDEX:

TITLE:

A-O COVER SHEET - GENERAL NOTES - ZONING

SURVEY:

C-CPP CERTIFIED PLOT PLAN

ARCHITECTURAL:

- -O ARCHITECTURAL SITE PLAN
- A-1 ELEVATIONS I
- -2 ELEVATIONS II
- A-3 FLOOR PLANS I
- A-4 FLOOR PLANS II
- A-5 FLOOR FRAMING & DETAILS
- A-6 FLOOR FRAMING & SECTION

CANTERBURY STREET ADDITION

1084-1086 STREET, ROSLINDALE, BOSTON, MA


Article 67

Two Family Residential Subdistrict: Zoned 2F-5000

Current Property Use: Two Family Residential

Proposed Property Use: 2 Family Residential Units						
REGULATIONS	EXISTING	PROPOSED	REQUIRED	COMMENTS		
Lot Area Min. /Dwelling units Specified (SF)	1 Lot @8,761	1 Lot @ 8,661	5,000 sf	COMPLY		
Additional Lot Area/Dwelling units Specified (SF)	2,424 sf	1,932 sf	3,000 sf	COMPLY		
Lot Width Min. (Ft)	92'±	92'±	50'	COMPLY		
Lot Frontage Min. (Ft)	92'±	92'±	50'	COMPLY		
FAR Max.	0.28	0.49	0.5	COMPLY		
Building Height (Stories)	.2½	2½	2½	COMPLY		
Building Height (Ft)	33'-2"±	33'-2"±	35'	COMPLY		
Open Space Min. SF per Dwelling unit	3,458±/Unit	3,150±/Unit	1,750/Unit	COMPLY		
Front Yard Setback Min. (Ft)	4-0"±	4'-0"±	20'	GRAND-FATHERED		
Side Yard Setback Min. (Ft)	R-Side 7'-4 L-Side 40'-5"	R-Side 7'-4 L-Side 18'-10"	10'	GRAND-FATHERED		
Rear Yard Setback Min. (Ft)	62'-11"	54'-6"	40'	COMPLY		
Accessory Building %	0%	0%	25%	COMPLY		

DIMENSIONAL CONTROL CHART:

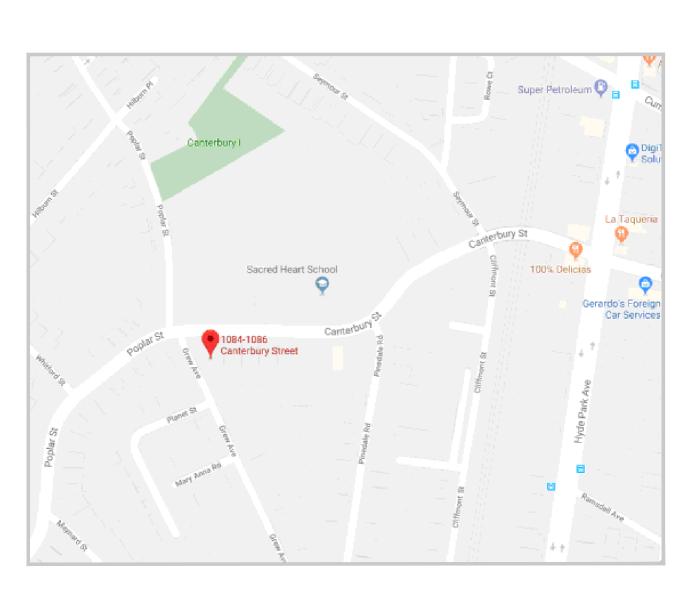

 $\frac{\text{LOCATION MAP:}}{N.T.S.}$

CITY OF BOSTON ZONING EVALUATION:

2F/5000 USE:

Two Family Residential Subdistrict

GENERAL NOTES:

TWO FAMILY RENOVATION @ 1084-1086 Canterbury Street, Roslindale, Boston, MA.

Rear and side addition; conventional wood construction anchored to standard concrete foundation, interior remodeling with open floor layouts including; Kitchens, Bathrooms, Closets & Storage areas. Up to date, HVAC Mechanicals, Electrical, plumbing as regulated per current building regulations per Mass State Building Codes.

All renovations, repairs, alterations, additions, and demolition shall conform to the regulations of the Massachusetts State Building Code, 9th Edition 780 CMR. and all amendments to the 2015 International Building Codes. Including all Plumbing/Mechanical, Electrical, Life Safety, and Fire Protection Codes and regulations.

General Contractor to verify all dimensions and existing site conditions and is responsible for the coordination of all mechanical, electrical and demolition work, as well as the installation provided by these subcontractors, including; dumpster permits, fire department permits and general building permits.

Door & Window styles to be determined by contractor and owner. Windows @ bedrooms must meet egress requirements. All egress doors must be 3' x 6'-8" Min. Doors between heated & unheated spaces to be weather stripped and have bottom sweep.

All vents including baths, dryer & hood range to vent out 25'-0" min. duct length


Consult Massachusetts Building Code for all openings in framing including structural support, crippling studs, headers, sills, jack studs & blocking. Exterior deck framing tied to exterior wall structure with post securely fastened to resist wind lift.

ELECTRICAL NOTES:


All work to be performed by a licensed Electrician in compliance with the latest edition of the ICEC & National Electrical Codes, including switches, outlets and all other electrical fixtures.


MECHANICAL NOTES:

All work to be performed by a licensed Heating/AC/Mechanical Contractor and shall conform to the regulations of the Massachusetts State Building Code, 9th Edition 780 CMR. and all amendments to the 2015 IMC - International Building Codes.

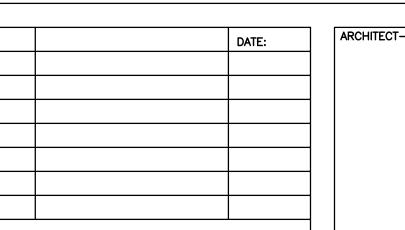



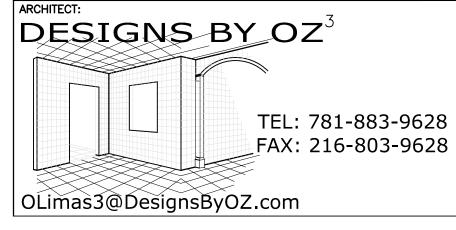

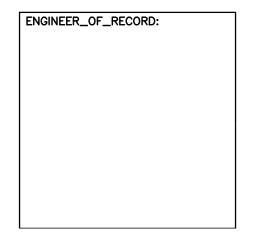

CANTERBURY STREET ADDITION 1084 - 1086 Canterbury Street Roslindale, MA 02131 PROJEC

Canterbury Street Addition 1084-86 Canterbury Street Roslindale, MA 02131

ARCHITECTURAL SITE PLAN & ZONING

DATE: May 21, 2018

SCALE: As Shown


DRAWN: OL³


CHECKED:

A-O



DATE:

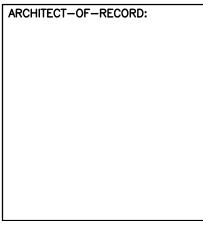

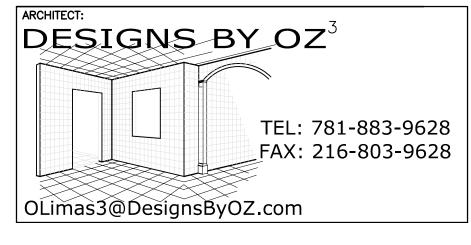

ENGINEER_OF_RECORD:

CANTERBURY STREET ADDITION 1084 - 1086 Canterbury Street Roslindale, MA 02131

Canterbury Street Addition 1084-86 Canterbury Street Roslindale, MA 02131

ARCHITECTURAL ELEVATIONS I

DATE: May 21, 2018


SCALE: As Shown

DRAWN: OL 3

CHECKED: ____


DRAWING NO.

A-]

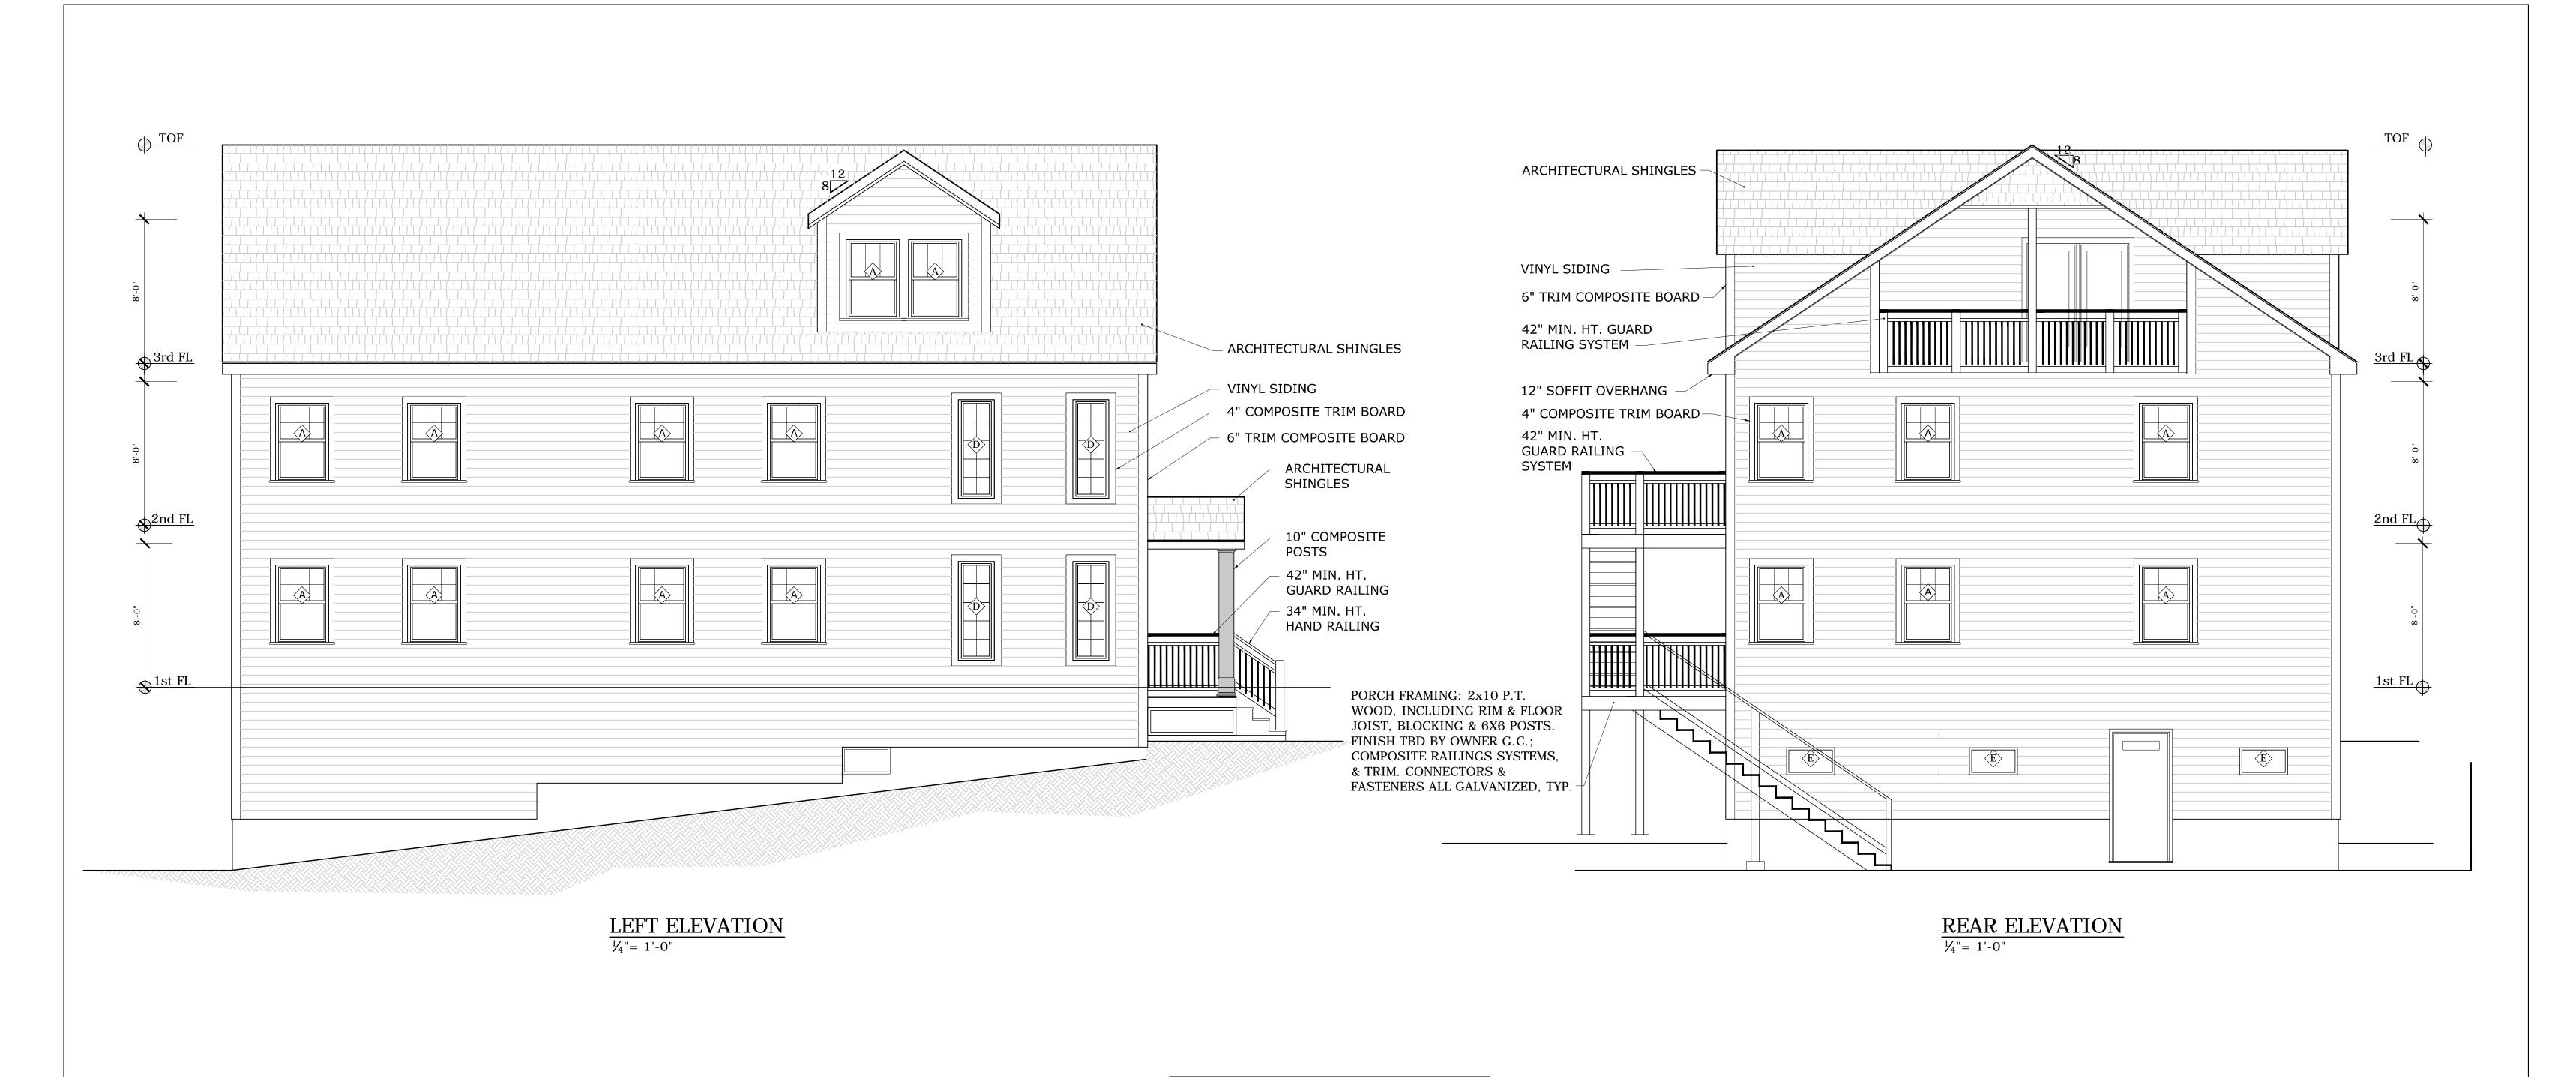



WINDOW SCHEDULE					
SYM	UNIT SIZE	QUANTITY	REMARKS		
(A)	3'-1½" x 4'-5"	27			
$\langle B \rangle$	7'-3¾" x 4'-3¼"	2	() š 6UmK]bXck		
⟨c⟩	3'-5¼" x 4'-5½"	2	@ Kitchens		
(D)	2' x 5'-11½"	4	Flanking Fire Place		
É	32" x 19"	4	Basement addition		

NOTE:
HARVEY Windows: Rated U-0.30, sizes, styles, hardware

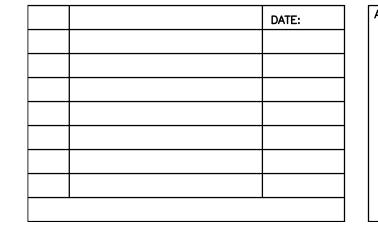



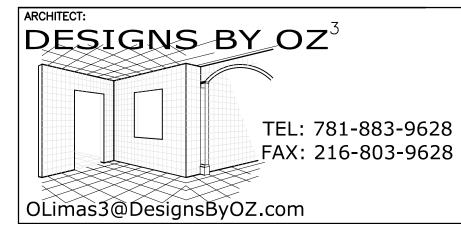

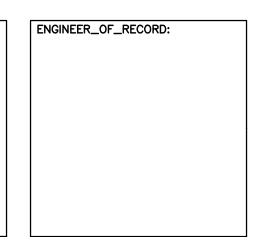

CANTERBURY STREET ADDITION 1084 - 1086 Canterbury Street Roslindale, MA 02131

Canterbury Street Addition 1084-86 Canterbury Street Roslindale, MA 02131

ARCHITECTURAL ELEVATIONS II


DATE: May 21, 2018


SCALE: As Shown


DRAWN: OL 3

CHECKED:

DRAWING NO.

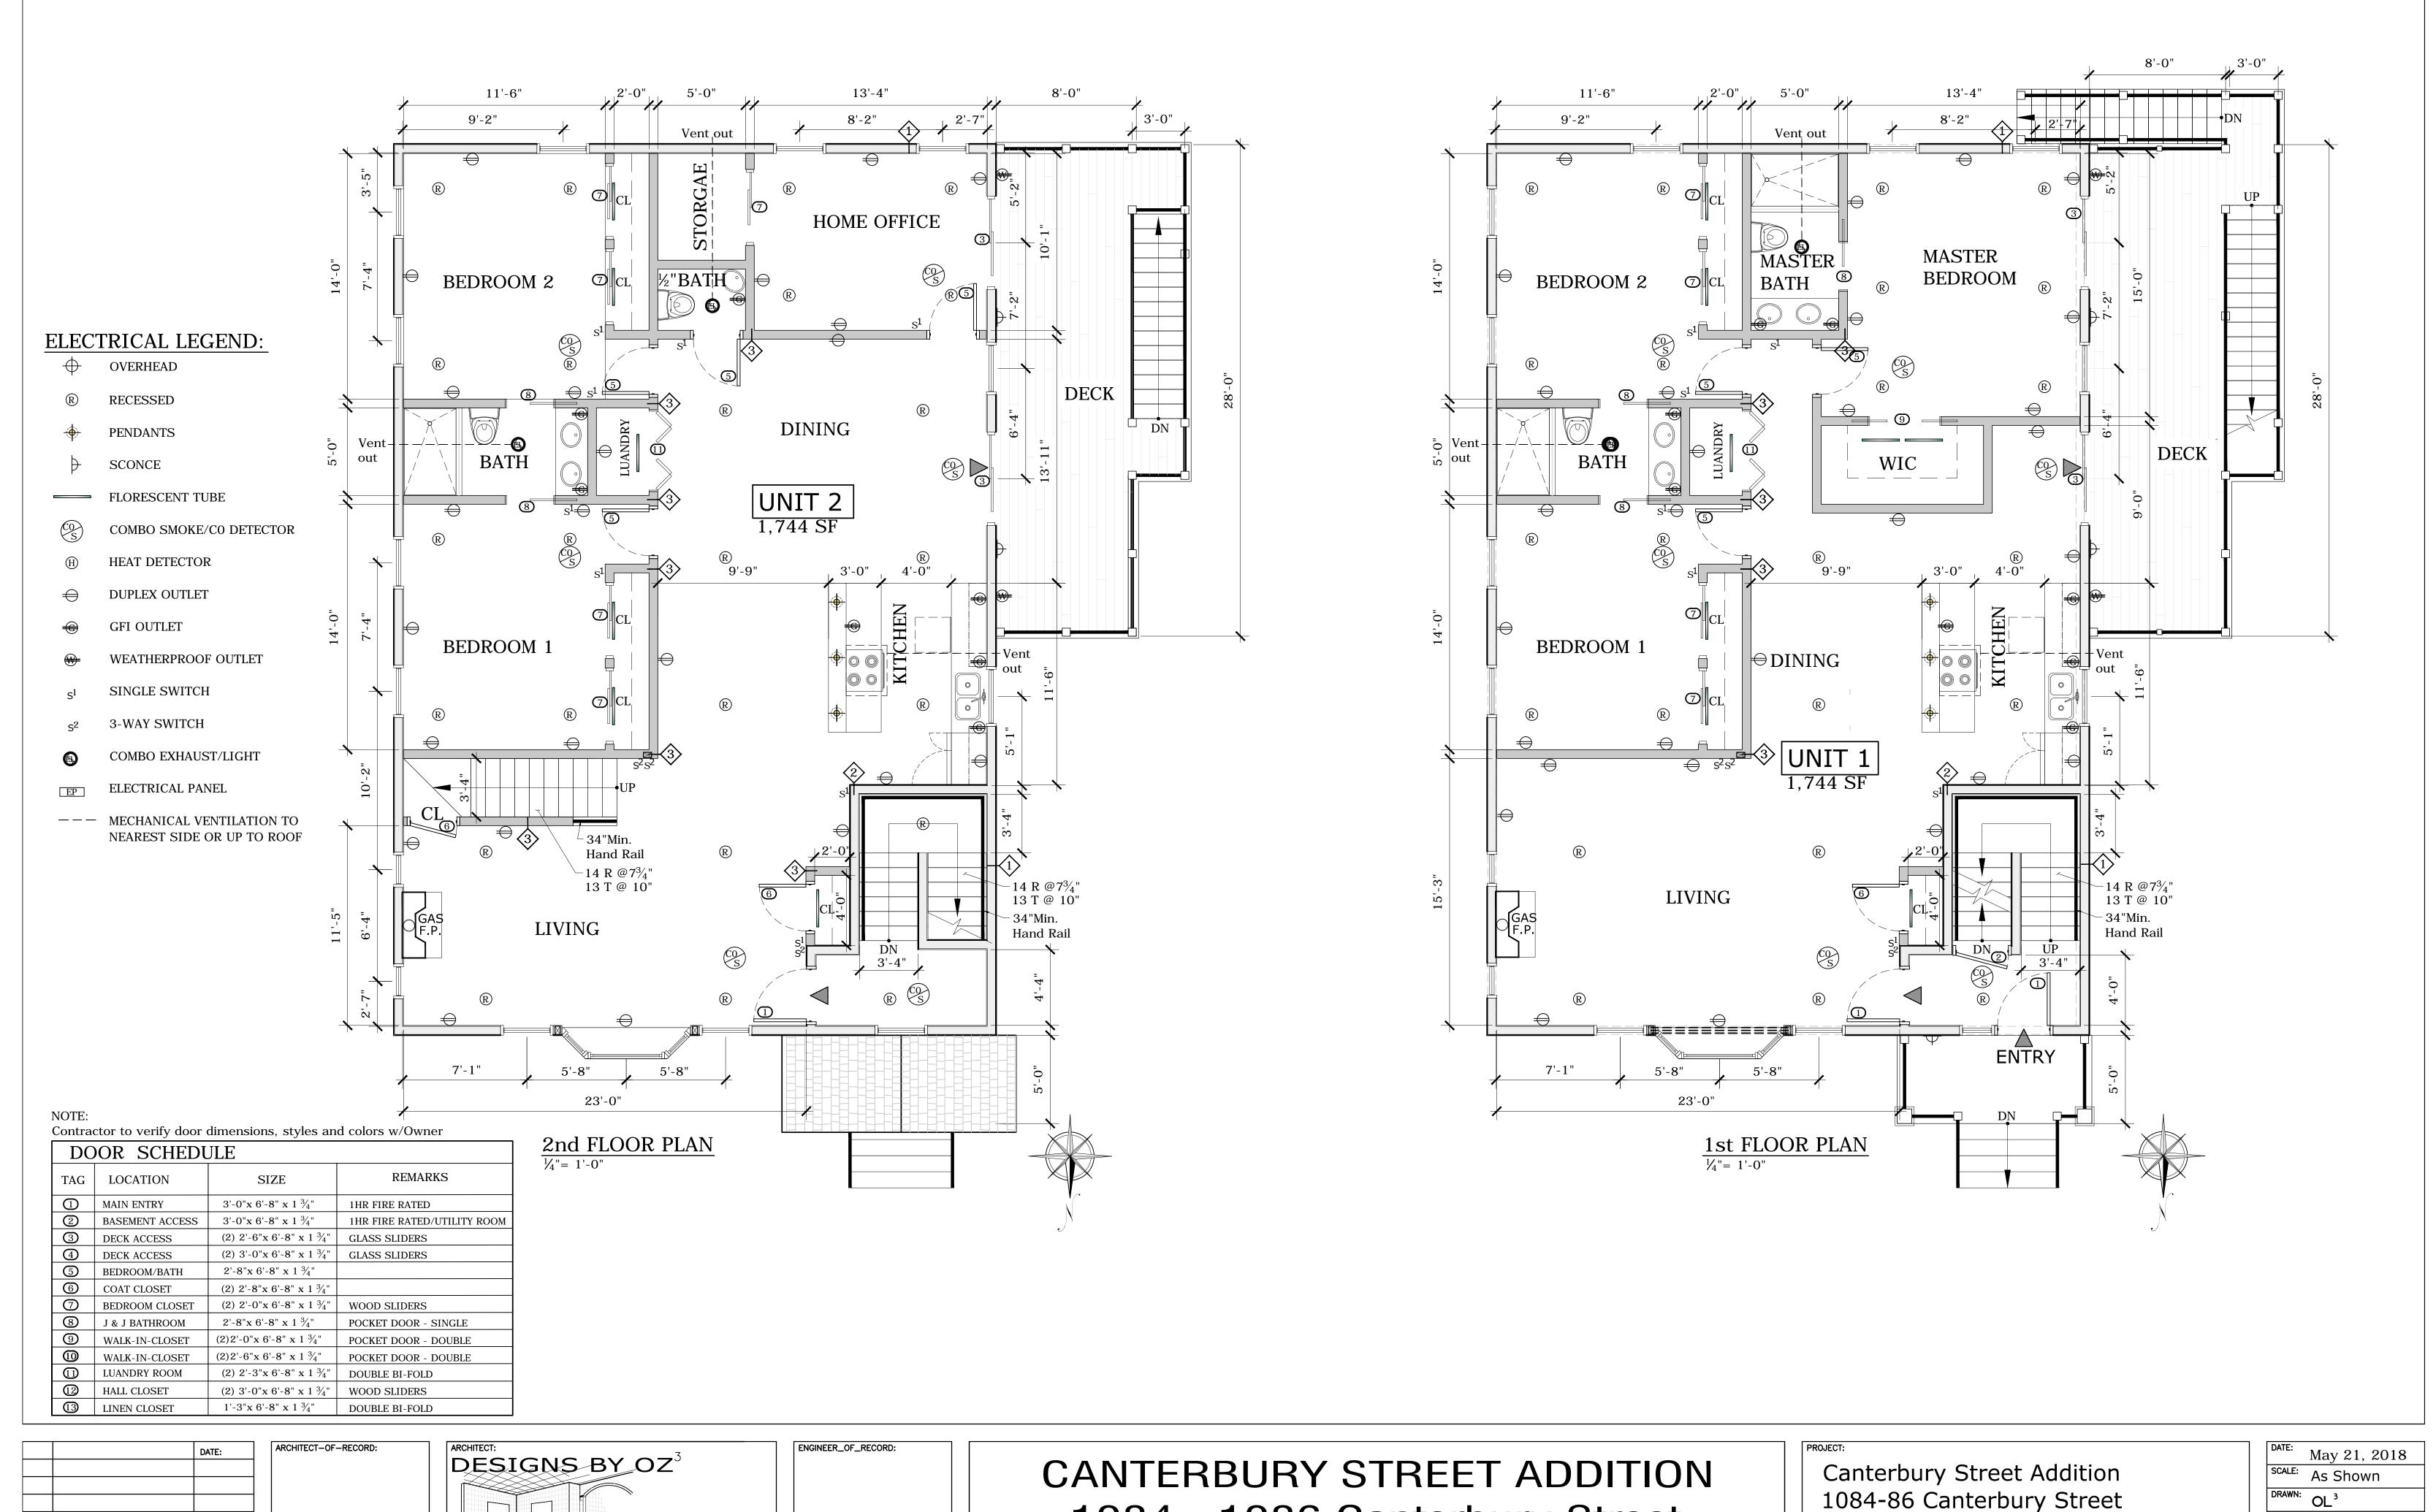

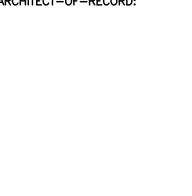


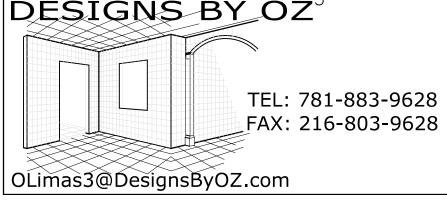



1084 - 1086 Canterbury Street Roslindale, MA 02131

1084-86 Canterbury Street Roslindale, MA 02131

CHECKED: ARCHITECTURAL FLOOR PLANS I

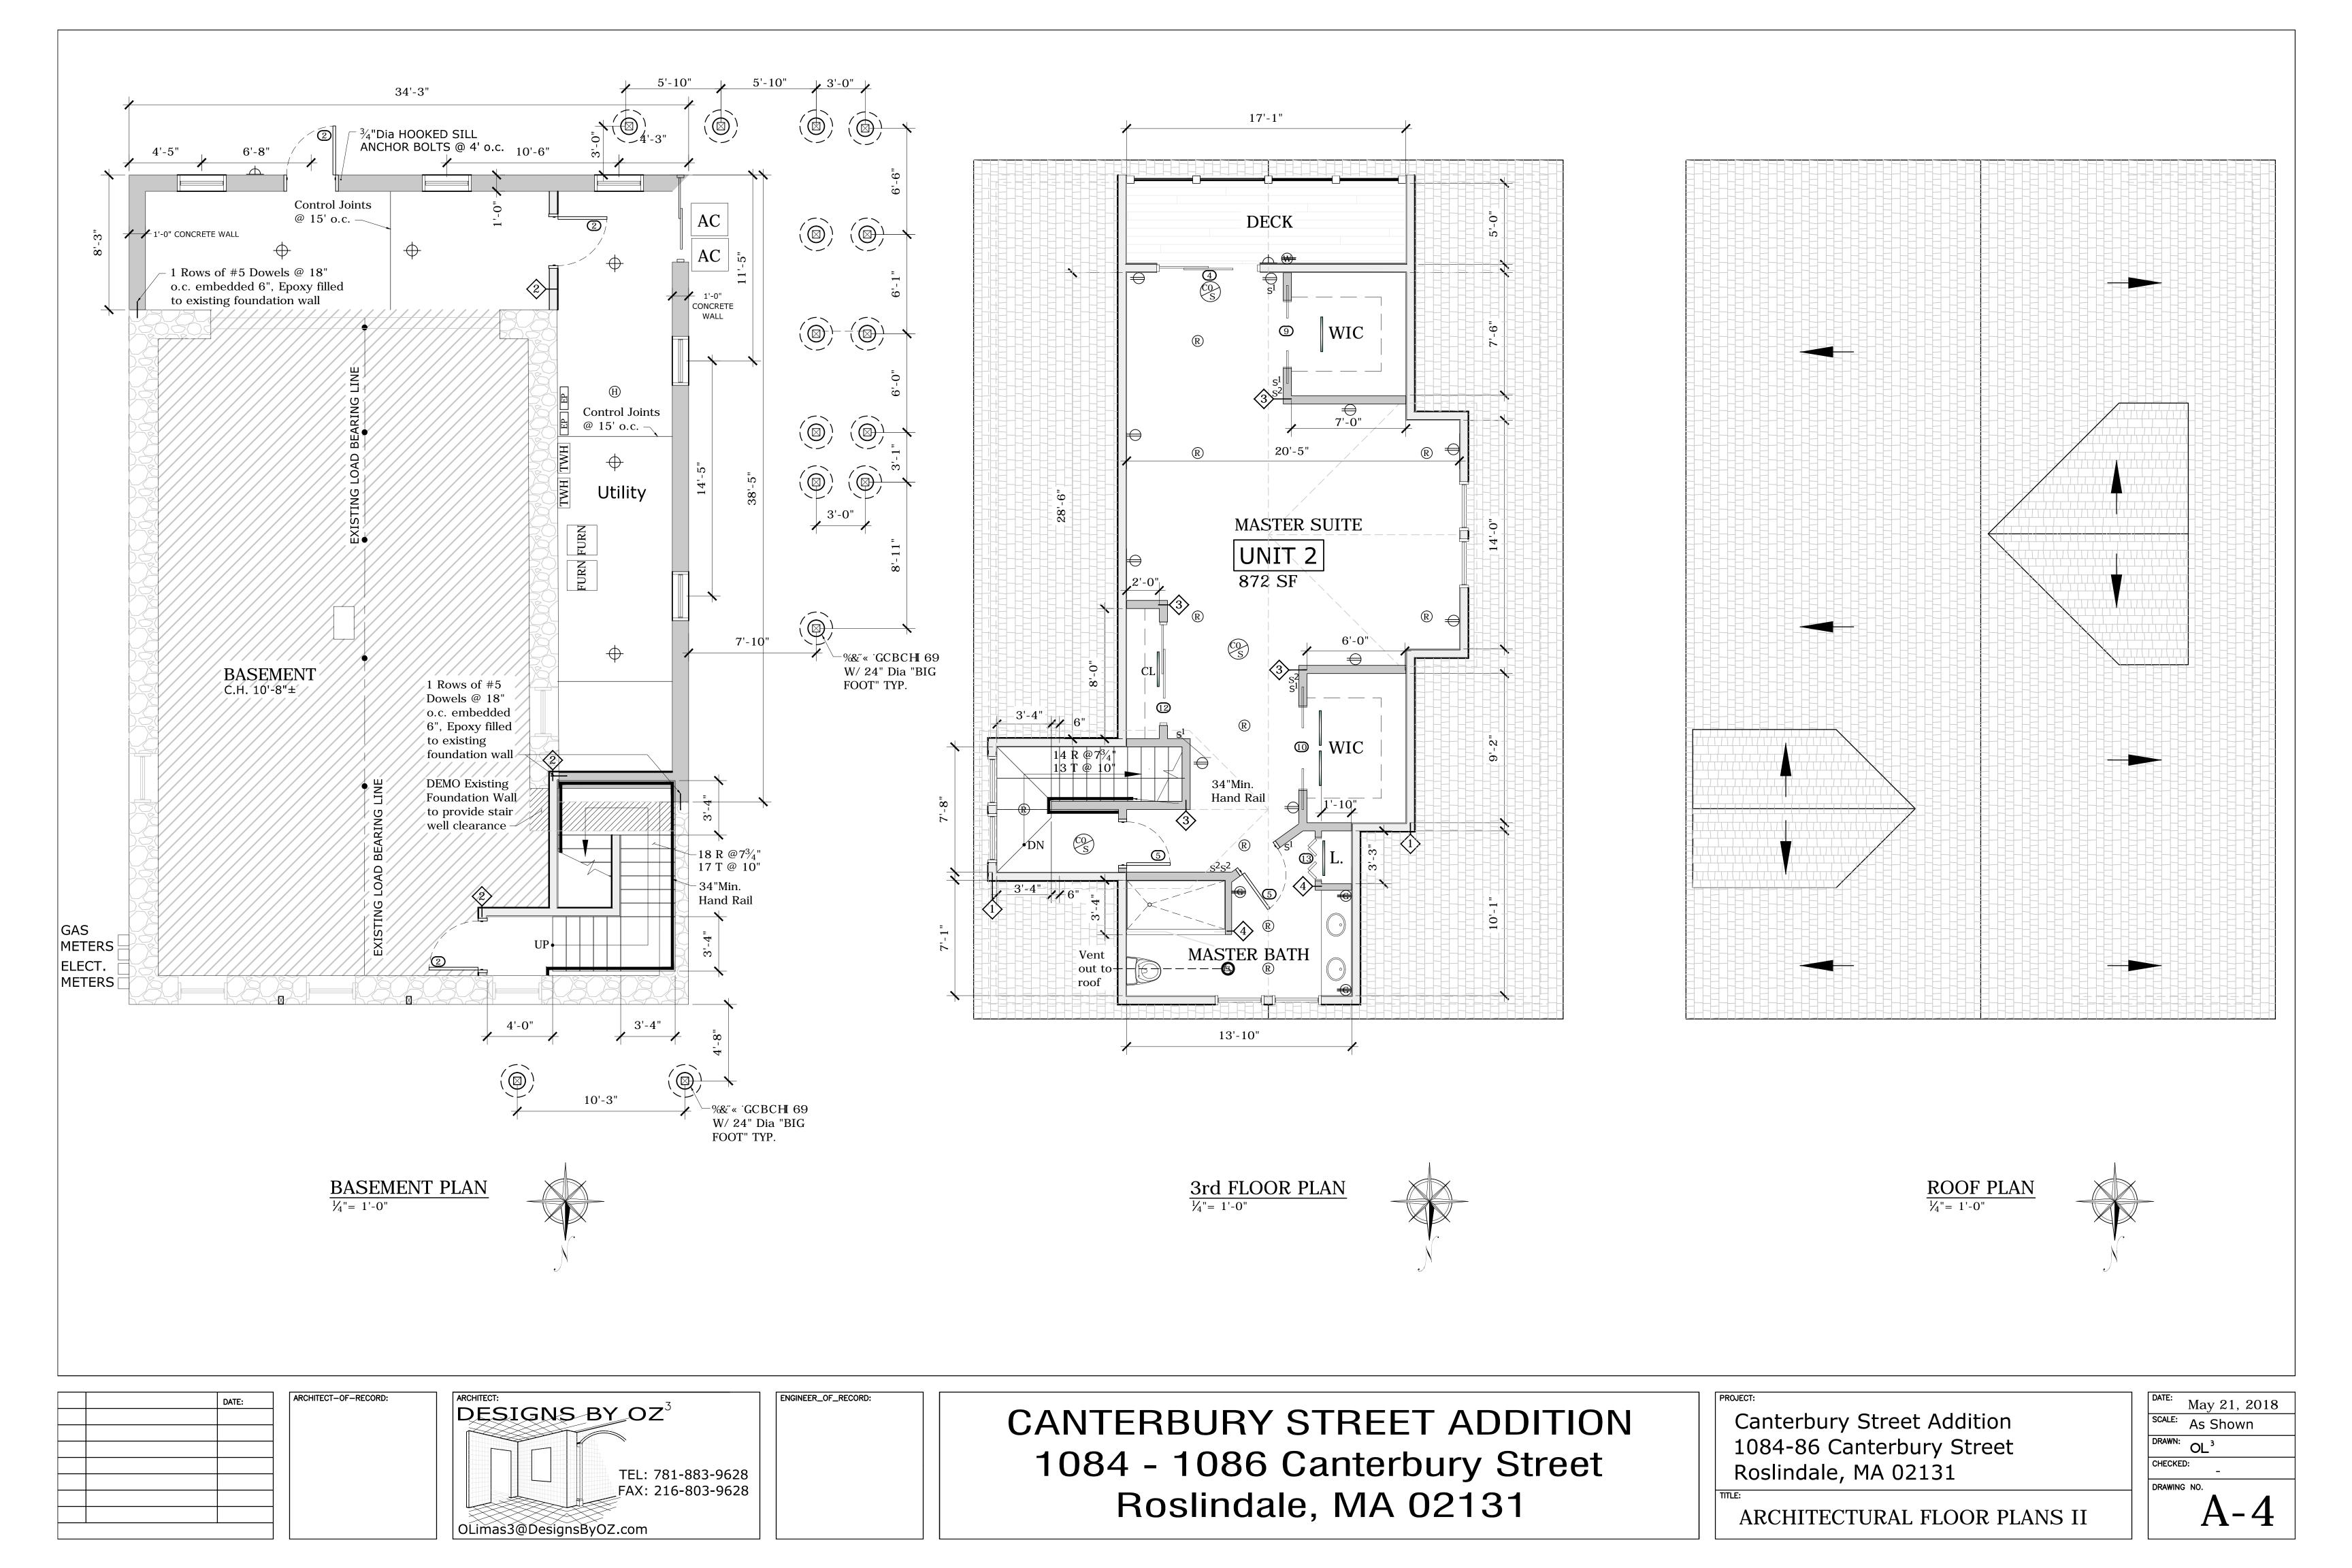

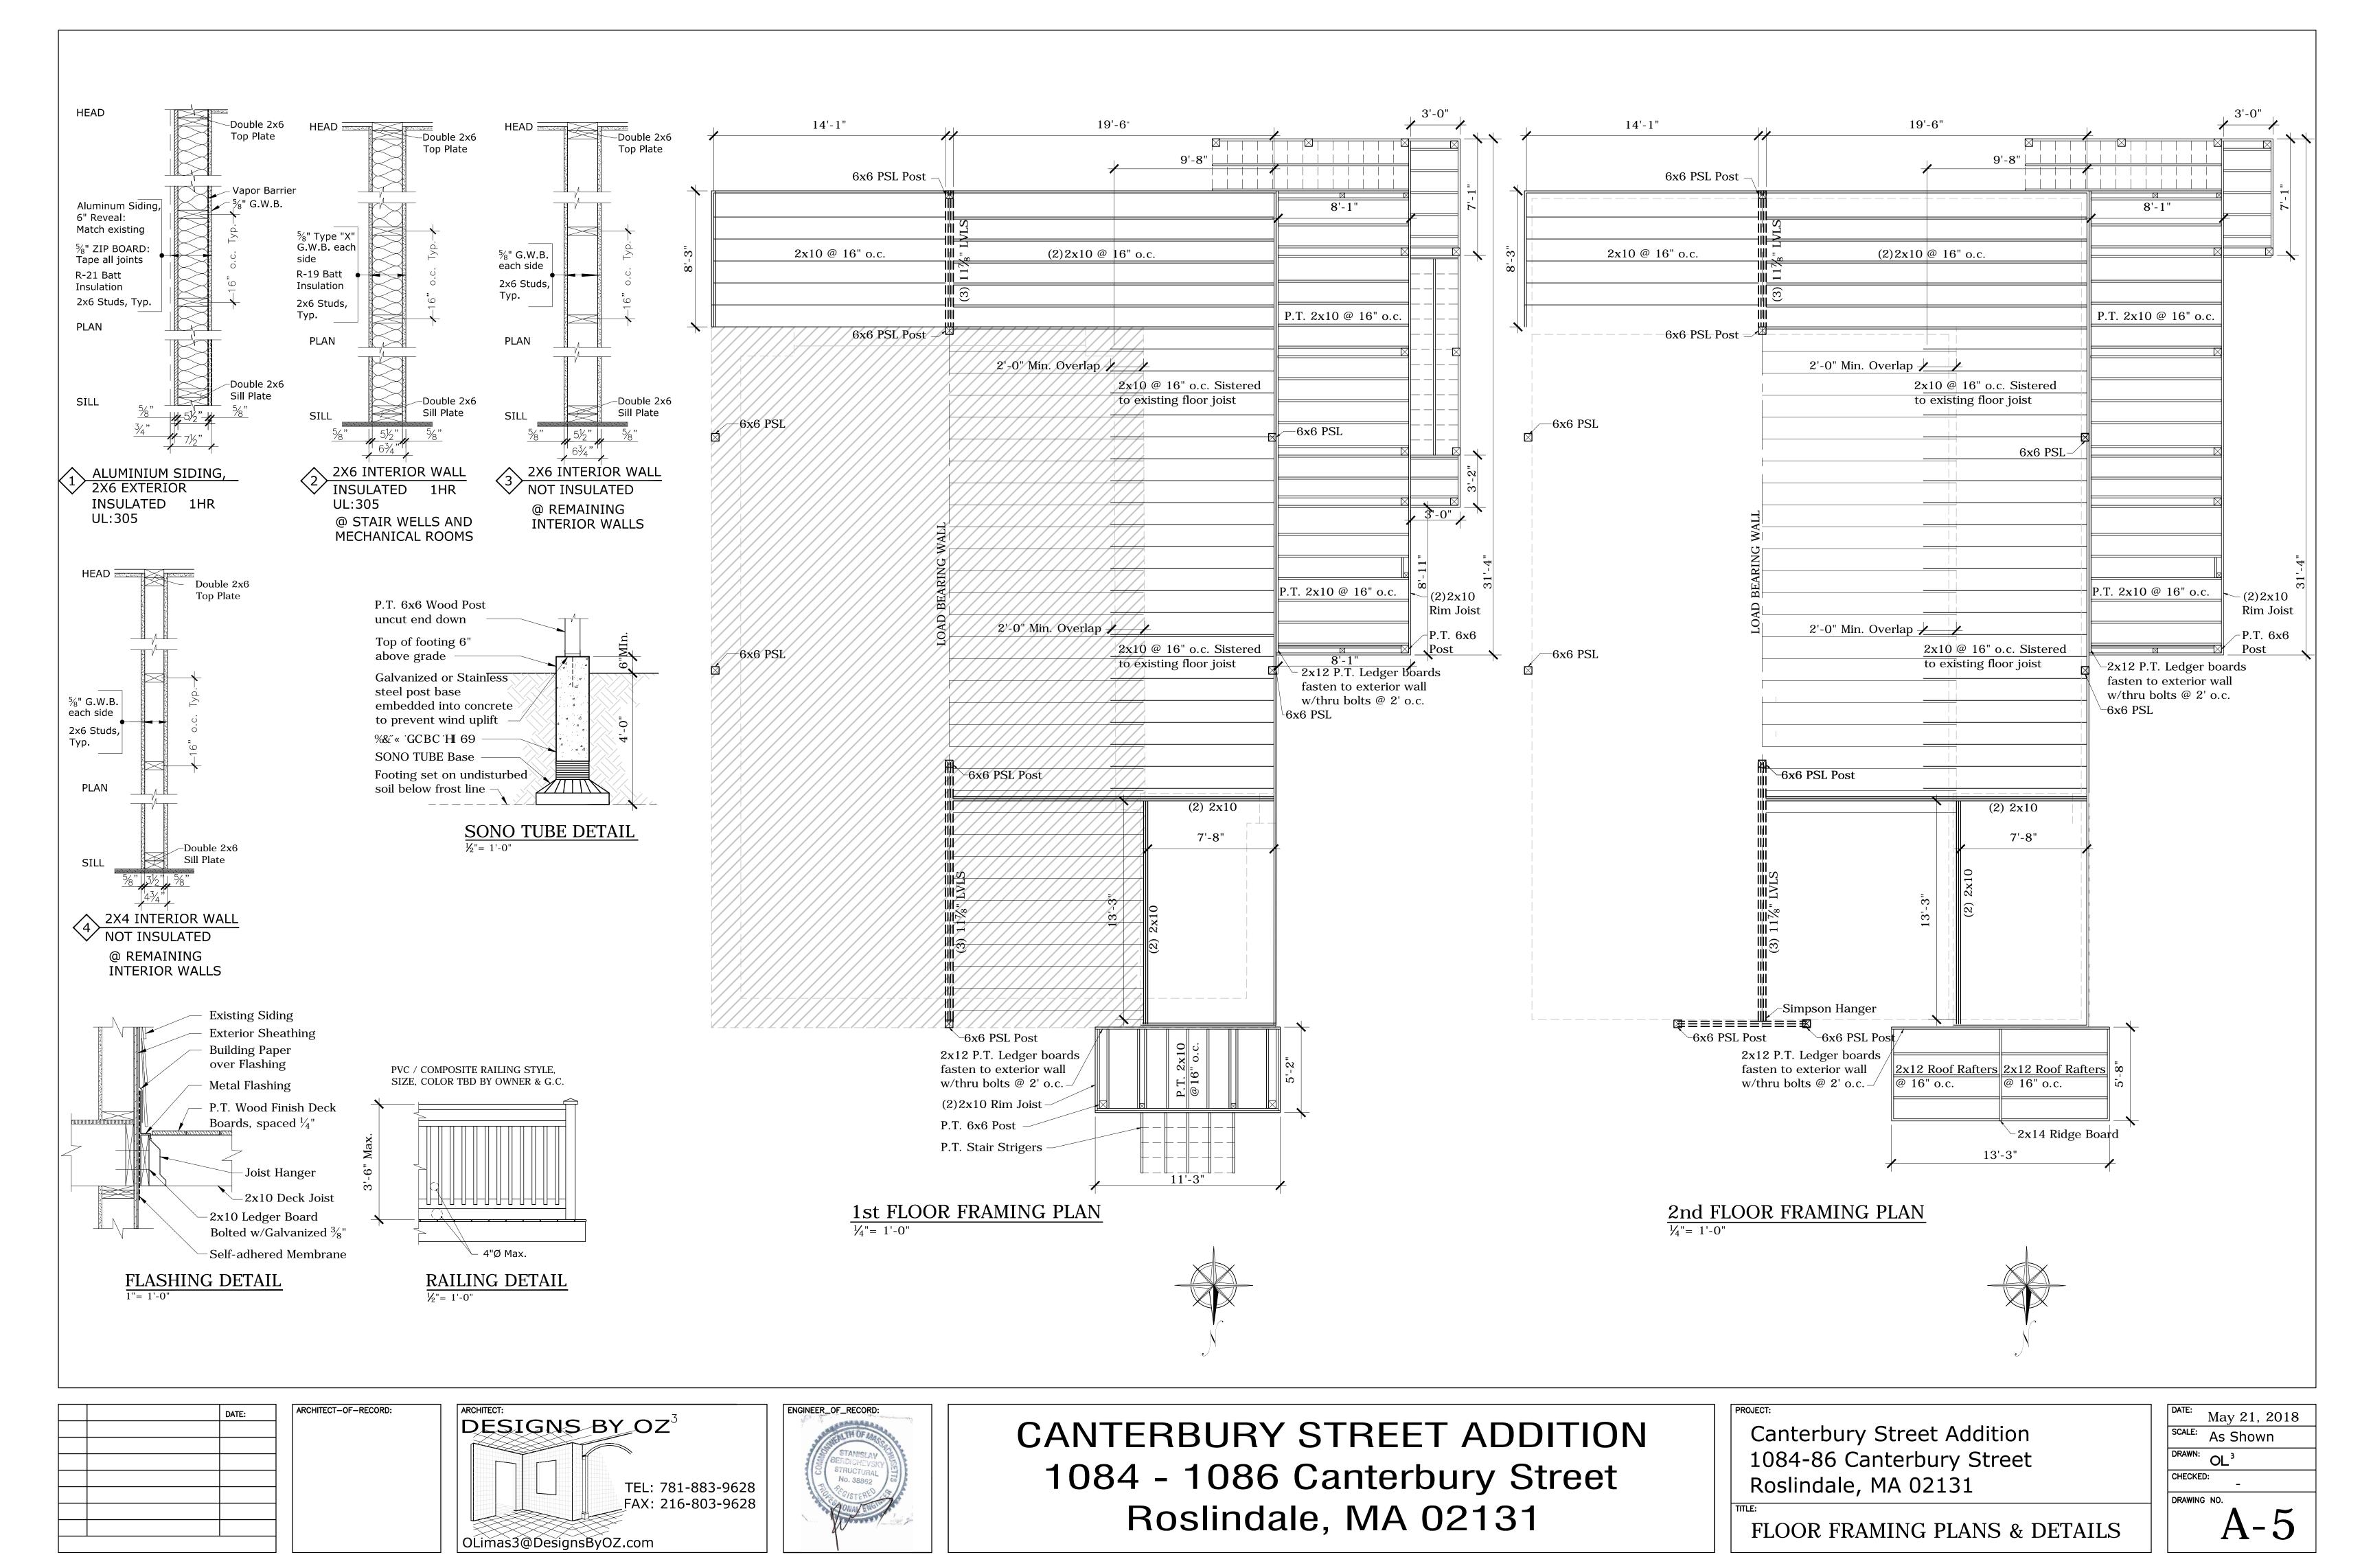

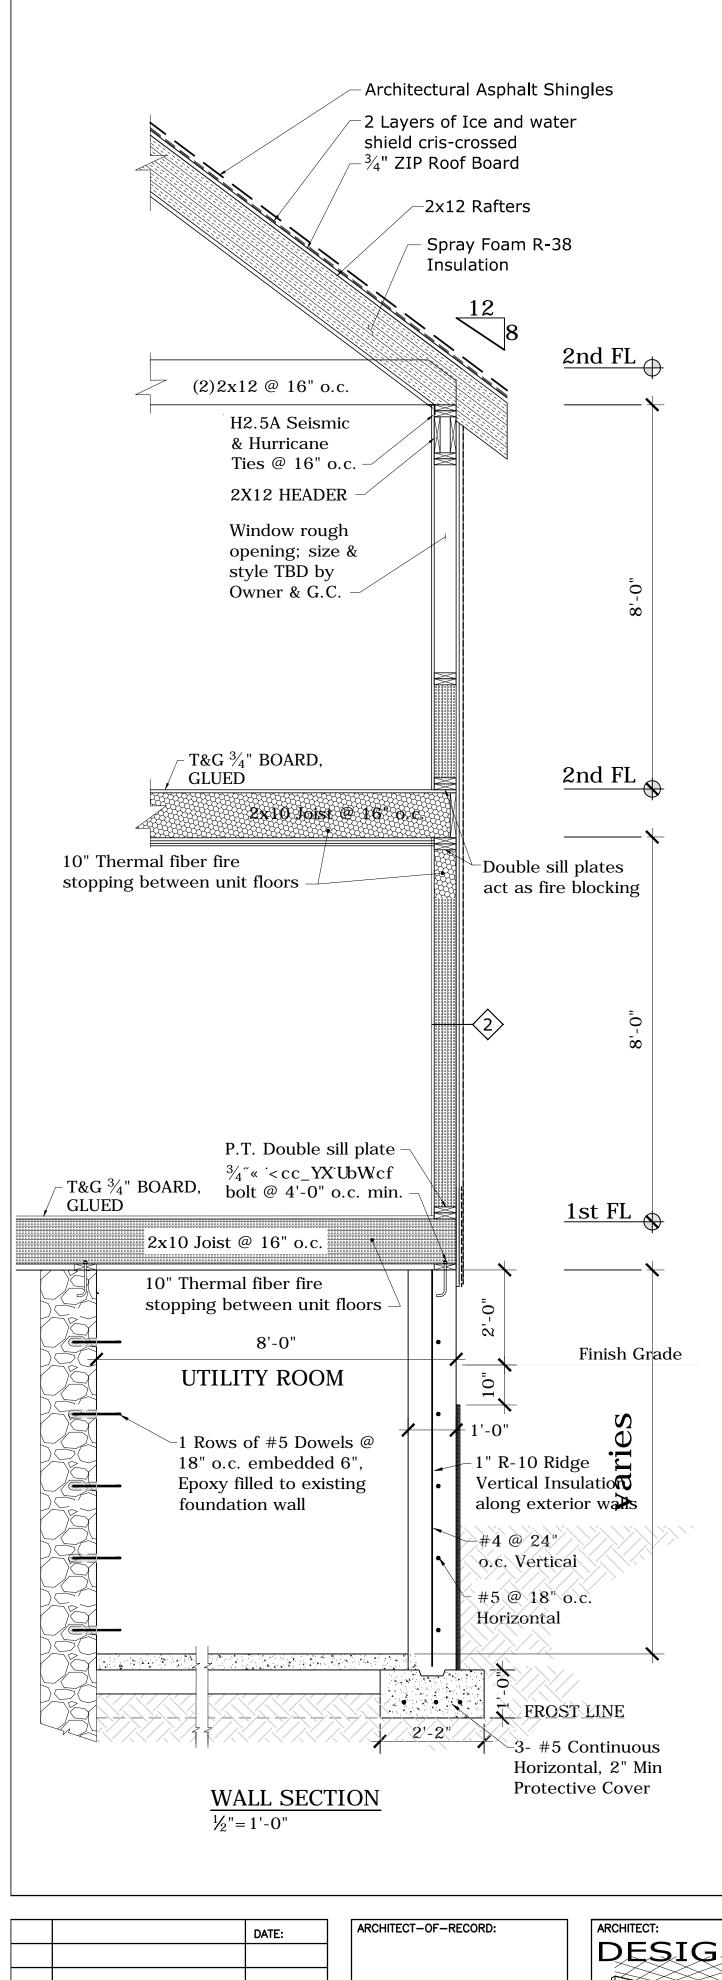


STRUCTURAL NOTES:


- 1. All work shall be performed to be in conformance with the State Building Code and General Construction practice.
- 2. Design Loads: All Design is as per the Latest Massachusetts State Building Code 9 th edition, IBC 2015.
- 3. Foundations shall be founded on well compacted soil with min. bearing capacity of 2000 psi.
- If founded on ledge, pin the foundation to the ledge with #4 dowels at 24" o.c
- 4. Bottom of the footings shall be a min. of 6x6 PSL 4ft. below finish grade, unless founded on
- 5. All concrete work shall conform to requirements for concrete & specifications (ACI 318) and Structural concrete for Buildings (ACI318).
- 6. All concrete shall have a min. of 3000 psi compressive strength at 28 days. Contractor shall submit a Design Mix for approval (if required by the owner).
- 7. Aluminum conduits shall not be embedded in concrete.
- 8. Reinforcement: Steel reinforcement shall conform to ASTM815, GR 60.uno.
- 9. Welded Wire fabric shall conform to ASTM A185.
- 10. Fabrication & placement of reinforcement shall conform to ACI Building code requirements, ACI 315 & 318.
- 11. Min. length of splice shall be 24 bar dia. but not less than Class B tension splice.
- 12. Wood framing: All wood construction shall conform to Part II of Design Specifications for Wood Construction and National design specifications for Wood construction
- 13. New timber shall have a min. allowable compressive stress of 1,000 psi & Modulus elasticity of 1,300,.000 psi.
- 14. Laminated beams shall have a min. allowable bending stress of 3100 psi & Modulus of elasticity 2,000,000 psi. PSL post Fb=2650 psi.
- 15. All Masonry work shall conform to Guidelines by National Concrete Masonry
- 16. All nominal lumber for floor & roof construction shall be SPF#2 or better
- 17. LVL plies shall be connected together per manufacturer specification for SIDE loaded assemblies
- 18. All posts and columns shall be braced at every floor level they pass through.
- 19. Apply double joists under partitions walls parallel to framing

FRAMING NOTES:

Conventional wood construction anchored to standard concrete footings. All in compliance and conforming to the regulations of the Massachusetts State Building Code, 9th Edition 780 CMR. and all amendments to the

Use appropriate stainless steel or galvanized fasteners and connectors to protect against corrosion from pressure treated wood for all framing including structural support, blocking & Seismic & Hurricane Ties. Exterior deck framing tied to exterior wall structure with posts securely fastened to

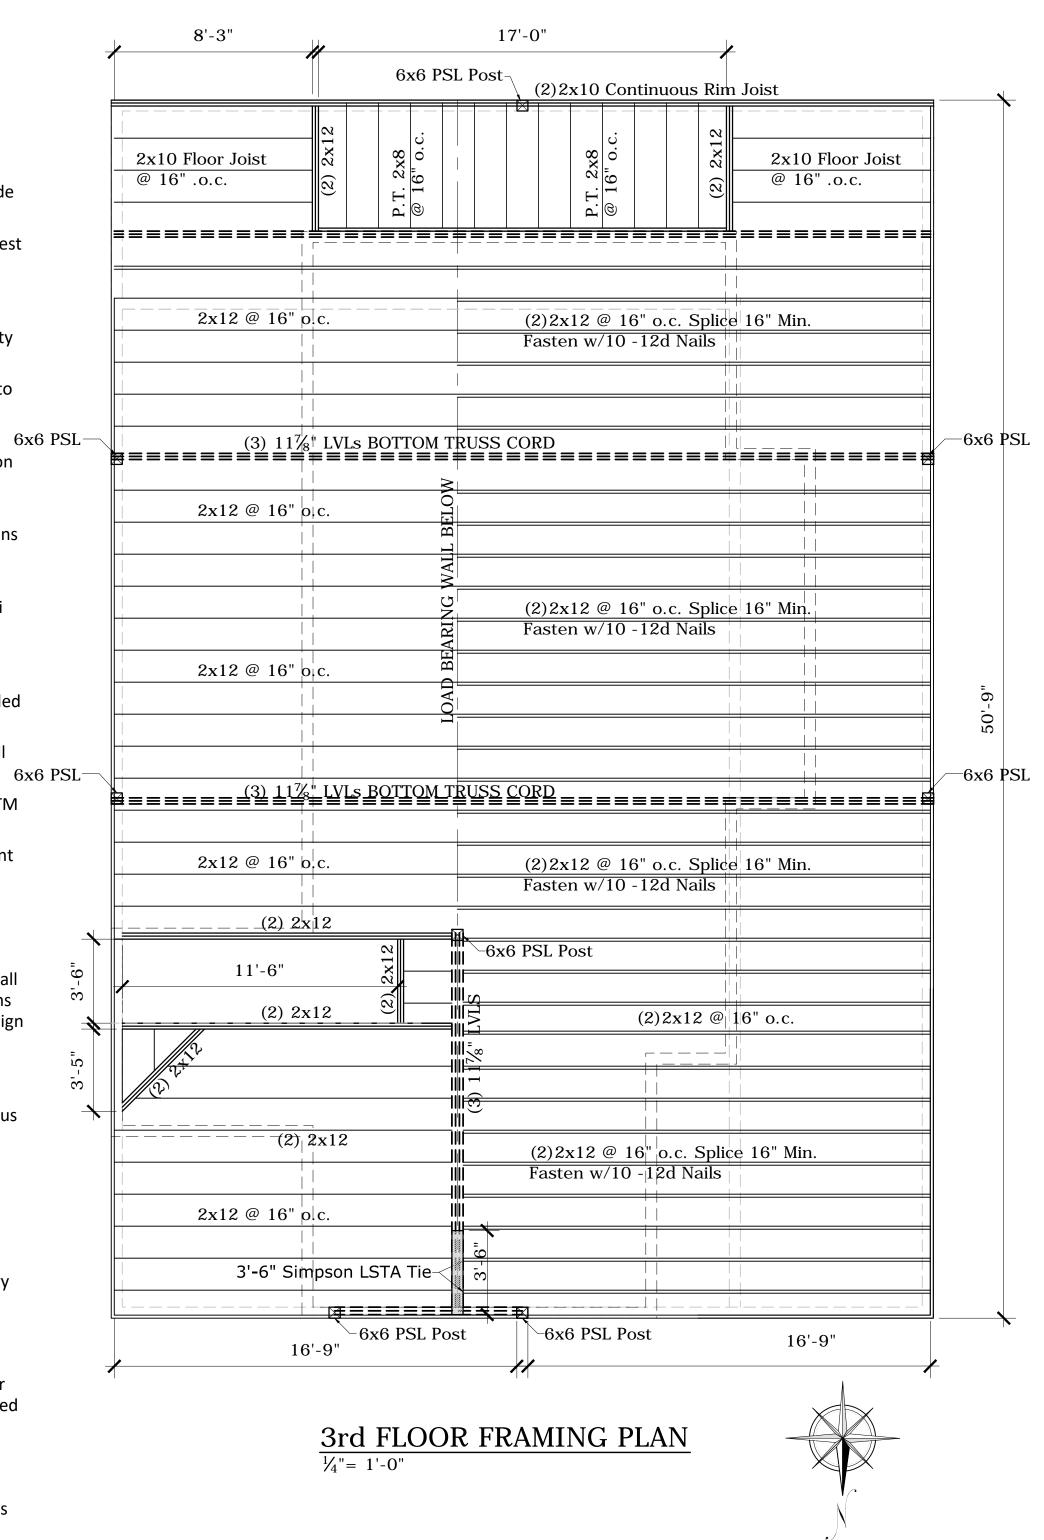

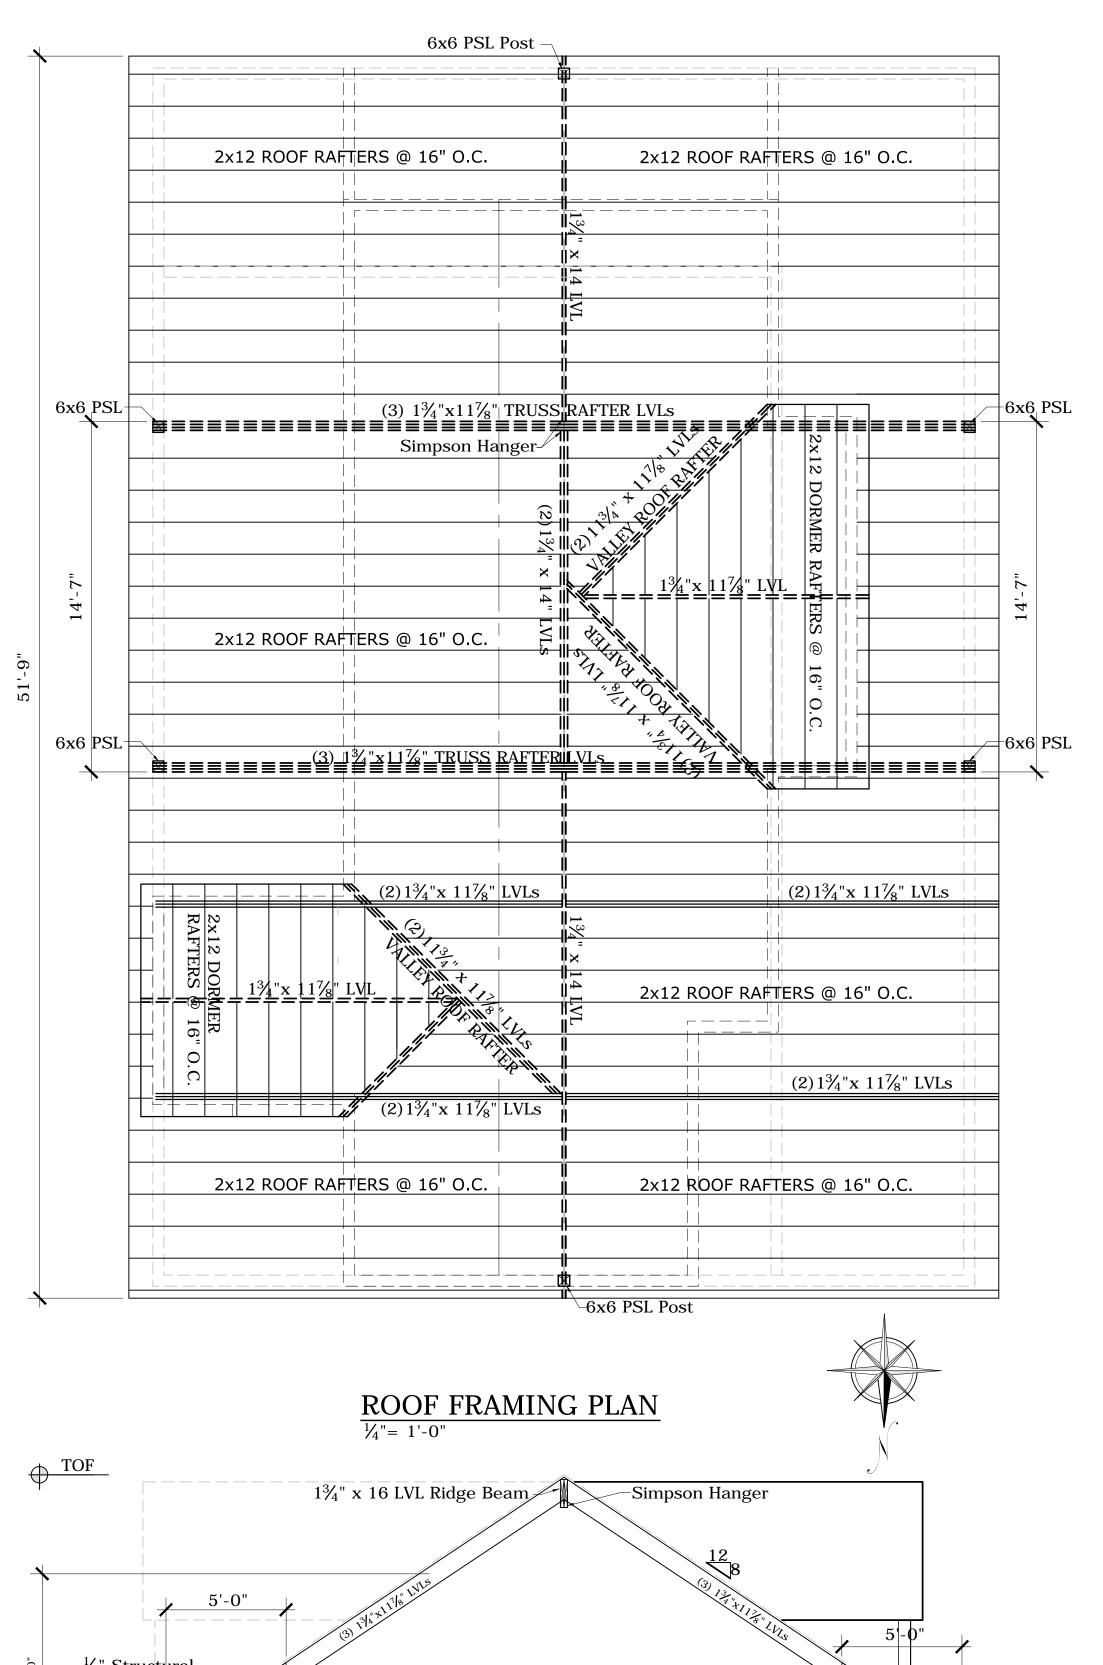



2015 International Building Codes.

resist wind lift.

" Structura Plywood, both -7.25 x 5.25 Strut -20-10d Nails @ each location, both sides 3rd FL (3) 1¾"x11%" LVLs BOTTOM TRUSS CORD -40-10d Nails @ each location, both sides 6x6 PSL "U" Simpson Hanger TRUSS DETAIL



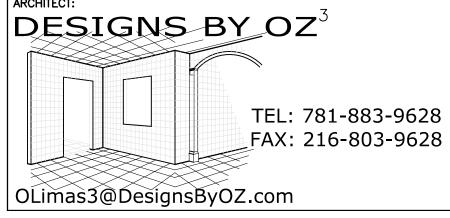

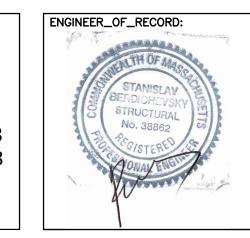

CANTERBURY STREET ADDITION 1084 - 1086 Canterbury Street Roslindale, MA 02131

Canterbury Street Addition 1084-86 Canterbury Street Roslindale, MA 02131

FRAMING PLANs & SECTION

 $\frac{1}{4}$ "= 1'-0"

May 21, 2018 As Shown DRAWN: OL³ CHECKED: DRAWING NO. A-6