

Boston Inspectional Services Department Planning and Zoning Division

1010 Massachusetts Avenue Boston, MA 02118 Telephone: (617) 635-5300

Michelle Wu Mayor

ZONING CODE REFUSAL

Marc A. Joseph Inspector of Buildings

March 17, 2023

JOHN PULGINI 10 FORBES ROAD

STE #410

BRAINTREE, MA 02184

Location: 34 OAK ST HYDE PARK, MA 02136

Ward: 18

Zoning District: Hyde Park Neighborhood

Zoning Subdistrict: NS-2

Appl. #: ERT1444728 **Date Filed:** February 28, 2023

Purpose: Construct new 15 unit residential building with 15 parking spaces at ground level on a 9747 sq. ft.

lot. Raze existing structure on separate (SF) permit.

YOUR APPLICATION REQUIRES RELIEF FROM THE BOARD OF APPEAL AS SAME WOULD BE IN VIOLATION OF THE BOSTON ZONING CODE TO WIT: CHAPTER 665, ACTS OF 1956 AS AMENDED:

Violation Violation Description Violation Comments

Art. 69 Sec.23 Neighborhood Design O.D. You need relief from the BOA for the said violations

THIS DECISION MAY BE APPEALED TO THE BOARD OF APPEAL WITHIN FORTY-FIVE (45) DAYS PURSUANT TO CHAPTER 665 OF THE ACTS OF 1956, AS AMENDED. APPLICATIONS NOT APPEALED WITHIN THAT TIME PERIOD WILL BE DEEMED ABANDONED. IF YOU HAVE INQUIRIES REGARDING THE NEIGHBORHOOD PROCESS AND PUBLIC PARTICIPATION, PLEASE CONTACT THE MAYOR'S OFFICE OF NEIGHBORHOOD SERVICES AT 617-635-3485. For more information visit boston.gov/zba-appeal.

Darell Boyd

darell.boyd@boston.gov / (61**%**)961-3235

for the Commissioner

Refusal of a permit may be appealed to the Board of Appeal within 45 days. Chapter 802, Acts of 1972, and Chapter 656, Acts of 1956, Section 19.

34 OAK STREET

BOSTON, MA 02136

FEBRUARY 17, 2023 ISSUED FOR CONSTRUCTION

ABBREVIATIONS

ABOVE FINISHED FLOOR ACOUSTIC CEILING TILE AMERICANS WITH DISABILITIES ACT APPROXIMATE ARCHITECTURAL AUDIO VISUAL BUILDING BLOCKING BOTTOM OF

CABINET CEILING HEIGHT CENTERLINE COLUMN CONTINUOUS CONCRETE MASONRY UNIT

CONTROL JOINT DIAMETER DIM. DIMENSION DRAWING existing

ACT

ADA

ARCH

BLDG

BLKG

COL.

CONT

CMU

GSM.

H OR HVAC

GWB

HM

M.O. MECH.

MEP MIN

MISC

MTL.

N.I.C.

N.T.S.

SPEC.

S.S.D.

SSTL.

STOR.

SYM.

T.O.S.

U.O.N.

V.I.F.

STRUCT.

B.O.

APPROX

ELEVATION ELECTRICAL EQUAL FLOOR DRAIN FACE OF F.O.C. F.O.F. FACE OF CONCRETE FACE OF FINISH F.O.S. FACE OF STUD

> GROUND FAULT INTERCEPTOR CIRCUIT GALVANIZED SHEET METAL GYPSUM WALL BOARD HEATING, VENTILATING, AND AIR CONDITIONING HOSE BIB HOLLOW METAL

> > MAXIMUM MASONRY OPENING MECHANICAL MECHANICAL, ELECTRICAL, PLUMBING MINIMUM

MISCELLANEOUS METAL NOT IN CONTRACT NOT TO SCALE

ON CENTER OUTSIDE DIAMETER O.D. OPNG. OPENING OPPOSITE PAINT GRADE PLYWD. PLYWOOD

PAINTED PTD. ROOF DRAIN REQ'D. REQUIRED ROUGH OPENING R.O. SCHED. SCHEDULE STAIN GRADE S.G. SIMILAR S.L.D.

SEE LANDSCAPE DRAWINGS SPECIFICATION SEE STRUCTURAL DRAWINGS STAINLESS STEEL STORAGE STRUCTURAL SYMMETRICAL TEMPERED

TONGUE AND GROOVE THICKNESS TOP OF TOP OF SLAB TUBULAR STEEL TYPICAL UNLESS OTHERWISE NOTED VERIFY IN FIELD

WITH W/O WITHOUT WOOD WATERPROOFING MEMBRANE WPM.

SYMBOLS

BUILDING SECTION DRAWING SHEET REFERENCE NUMBER WALL SECTION DRAWING SHEET

REFERENCE NUMBER

REFERENCE NUMBER DRAWING SHEET

> REFERENCE NUMBER DRAWING DRAWING SHEET

REFERENCE NUMBER **INTERIOR ELEVATION** DRAWING SHEET

REFERENCE NUMBER

EXTERIOR ELEVATION DRAWING SHEET

NORTH ARROW

WINDOW TAG

APPLIANCE TAG

revision tag

CENTER LINE

ROOM TAG

FINISH ROOM TAG

EXTERIOR WALL TYPE TAG

INTERIOR WALL TYPE TAG

DOOR TAG

101

BVS-1

TYPE X BATH AND KITCHEN TYPE TAG

SHEET LIST


A000 **COVER SHEET** <u>CIVIL</u>

EXISTING CONDITIONS PLAN MODAL CALCULATION PLAN PROPOSED PLOT PLAN

<u>ARCHITECTURAL</u> D100

DEMO PLAN A101 PROPOSED FLOOR PLANS A102 PROPOSED FLOOR PLANS A103 ROOF PLAN A201 BUILDING ELEVATIONS A301 BUILDING SECTIONS PERSPECTIVES



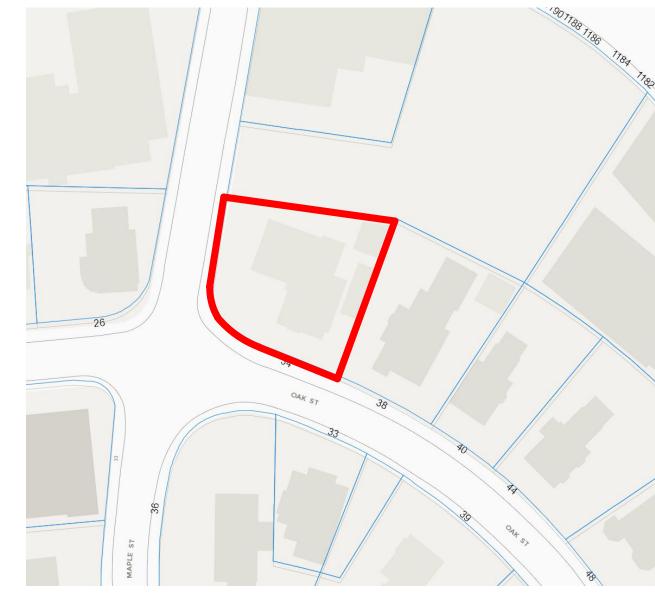

PROJECT DATA

A. DEMOLITION OF EXISTING FUNERAL HOME; ERECTION OF A NEW CONSTRUCTION 14- UNIT RESIDENTIAL BUILDING CONSISTING OF 3 STORIES OF RESIDENTIAL OVER PARKING AT GROUND LEVEL.

B. USE GROUP: RESIDENTIAL

C. CONSTRUCTION CLASSIFICATION: TYPE 5-B CONSTRUCTION

D. FULLY SPRINKLERED

ZONING REVIEW

HYDE PARK ZONING DISTRICT/ NS-2 SUB-DISTRICT

	ALLOWABLE	EXISTING	PROPOSED
LOT SIZE	NONE	9,747 S.F.	NO CHANGE
LOT WIDTH	NONE		NO CHANGE
F.A.R.	19,494 S.F. (2.0)		17,238 S.F. (1.75)
BUILDING HEIGHT	40'-0"		39'-11"
OPEN SPACE	N/A		
FRONT YARD	0'-0"*		- OAK ST: AVG = 22'-6"; CLOSEST POINT = 21'-7" - MAPLE ST: 2'-8"
SIDE YARD	0'-0"**		10'-3"
REAR YARD	10'-0"		10'-1'''
PARKING	1/UNIT (14)		14 SPACES

*69-30. 1 Conformity with Existing Building Alignment, If at any time in the same Block as a Lot required by this Article to have a minumum Front Yard there exist two or more Buildings fronting on the same side of the same Street as such Lot, instead of the minimum Front Yard deptht specified in this Article, the minimum Front Yard depth shall be in conformity with the Existing Building Alignment of the Block.

*69-30. 3 Front Wall of Building Not Parallel to Front Lot Line. If the front wall of a Building is not parallel to the Front Lot Line, but the average distance between such wall and such Lot Line is no less than the minimum Front Yard depth otherwise required by this Article, and the distance between such wall and such Lot line is at no point less than three fourths (3/4) of the minimum Front Yard depth so otherwise required, the Front Yard requirements of this Article shall be deemed to be met.

Oak Street Modal Alignment Calc (See Sheet titled Modeal Plan): 22.5'

3/4 Front Setback: .75*22.5'= **16.9'**

**TABLE E - Footnote 4.In a Neighborhood Business Subdistrict, no side yard is required except in the case of a lot with a side lot line abutting a Residential Subdistrict, which shall have side yards as if it were in such abutting district. Every side yard so required that does not abut a street line shall, along every lot line on which such yard abuts, be at a level no higher than that of the lowest window sill of the lowest room designed for human occupancy or so occupied, and relying upon natural light or natural ventilation from windows opening on such yard.

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BOSTON, MA 02118 O: 617.766.8330 www.embarcdesign.com

Diarmaid McGregor

CONSULTANTS

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REVISIONS

Revision 1

21


DRAWING INFORMATION


PROJECT #: 21004

ISSUED FOR CONSTRUCTION FEBRUARY 17, 2023

SCALE: As indicated DRAWING TITLE

DRAWING NUMBER

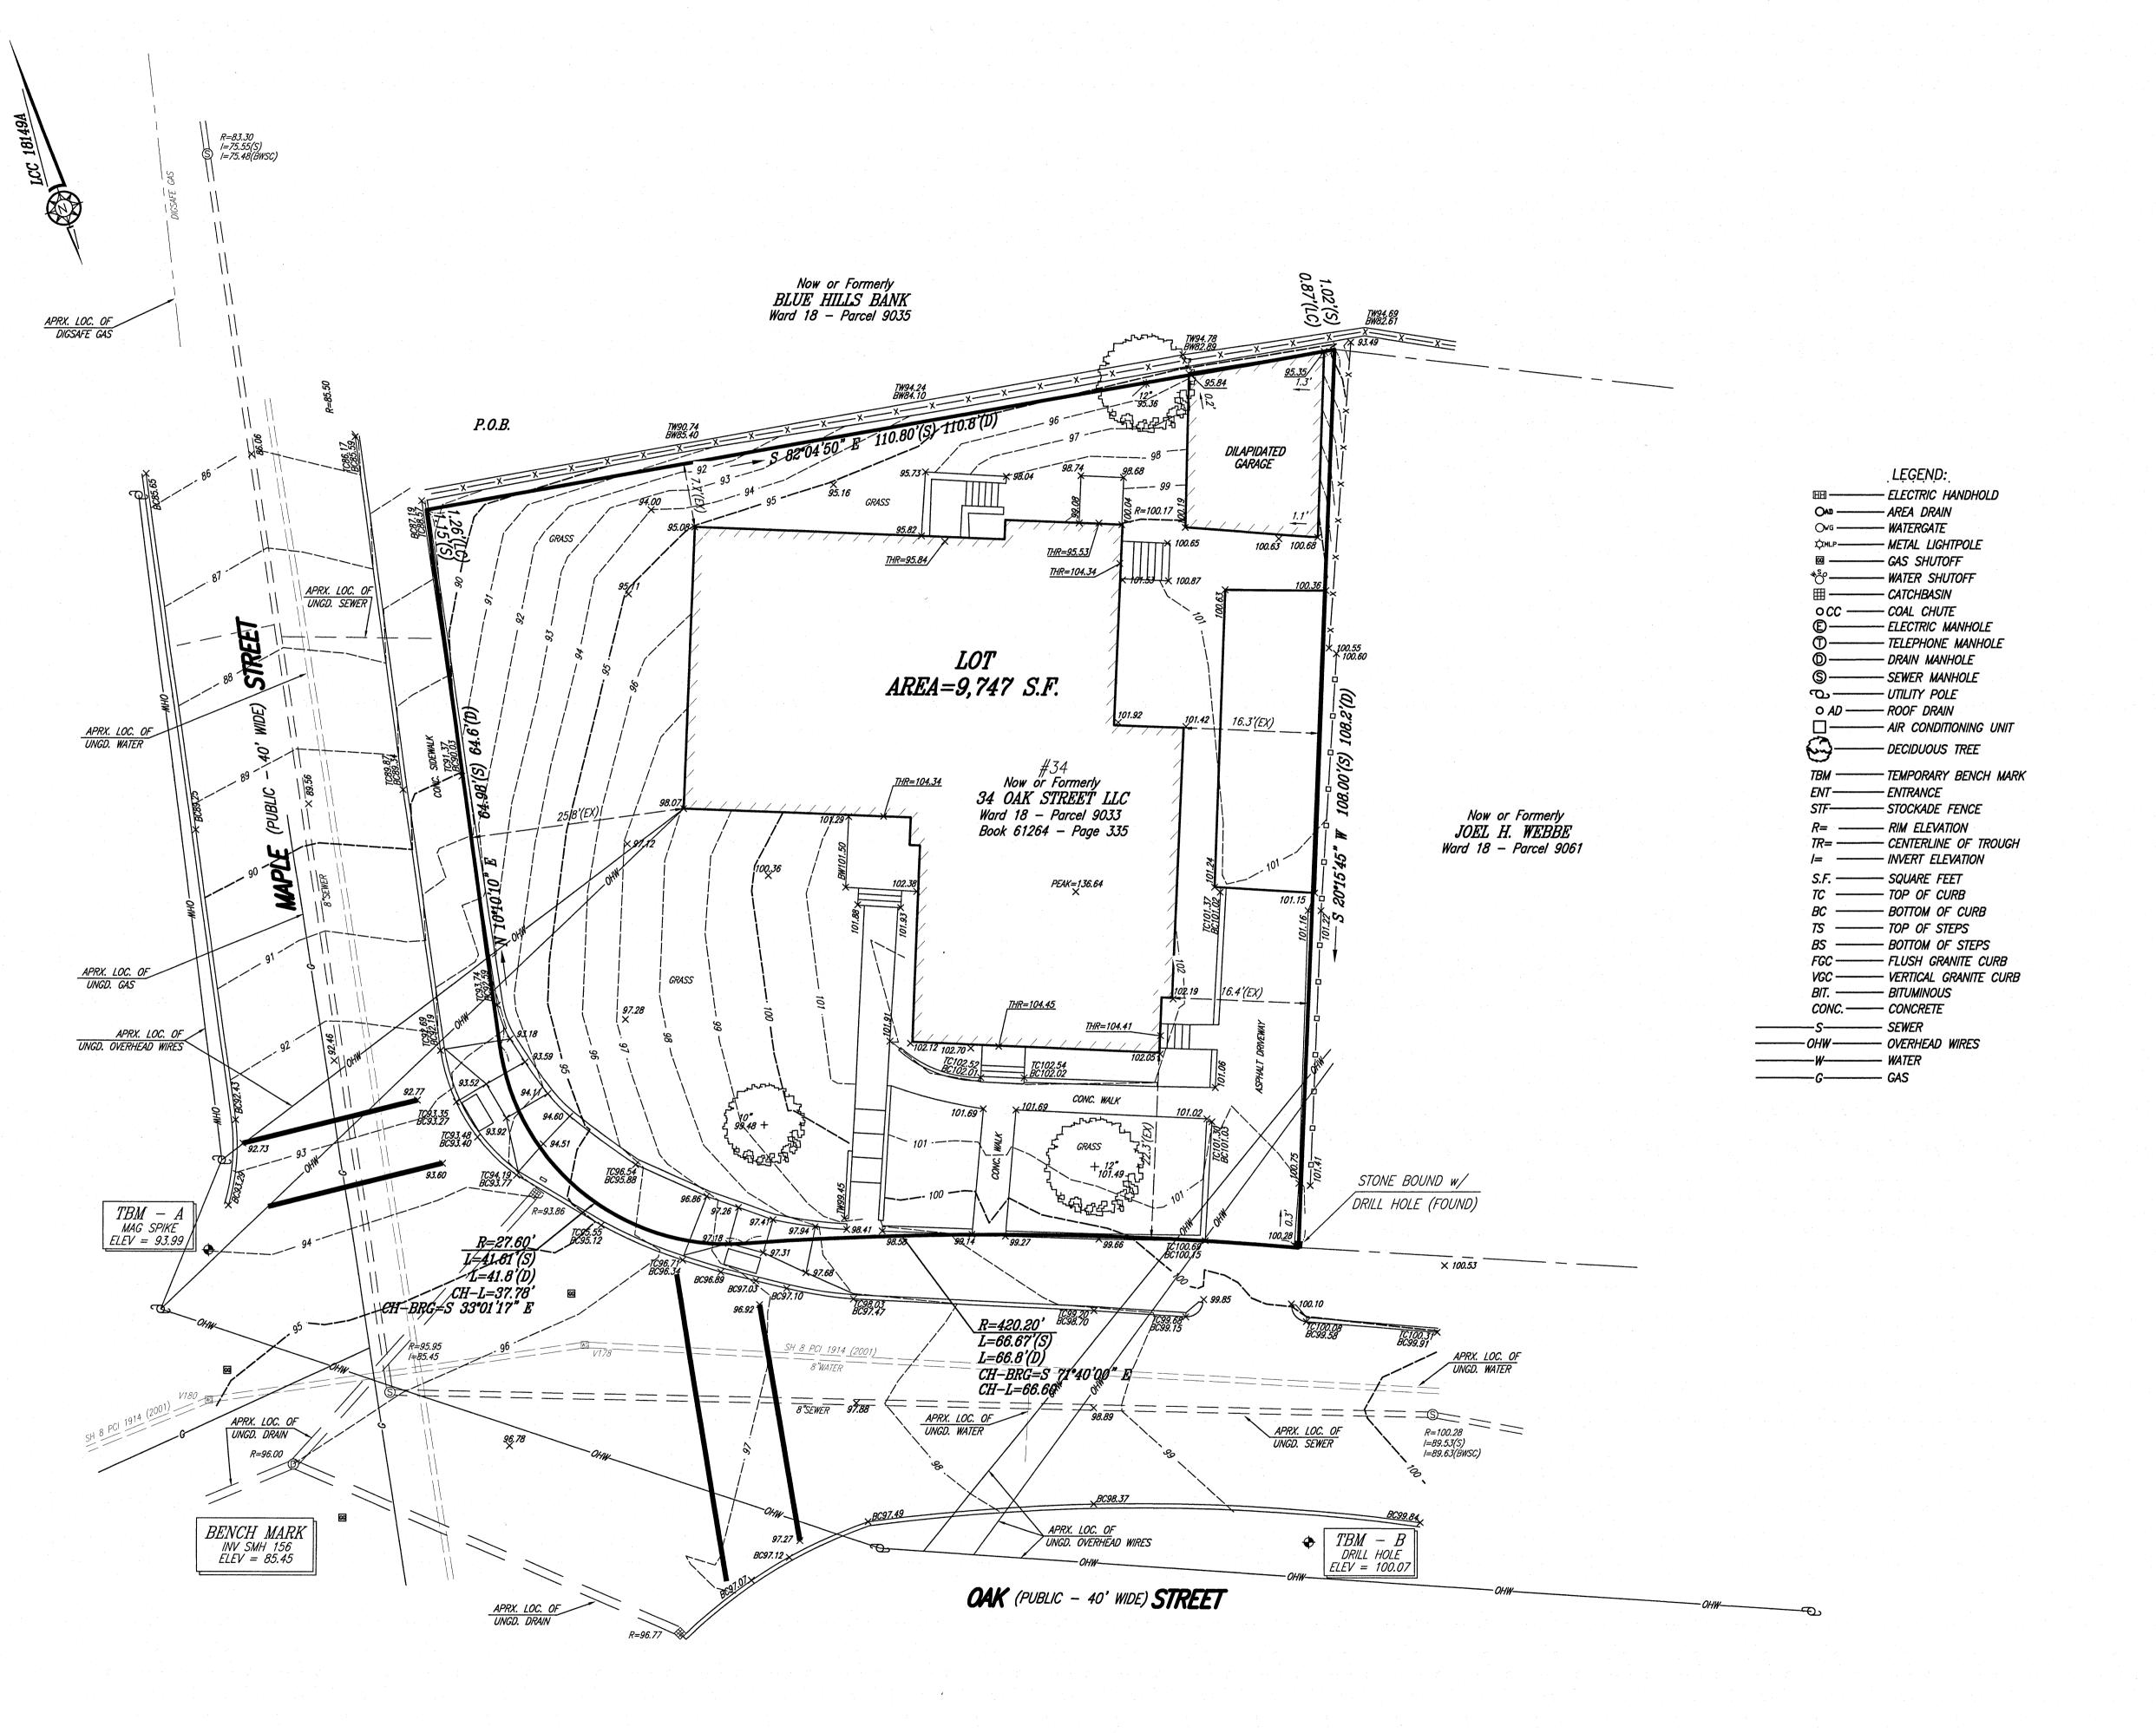

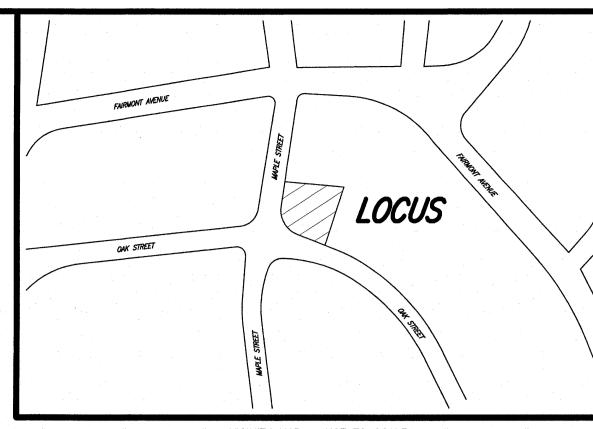

VICINITY MAP - NOT TO SCALE

NOTES:

) BENCH MARK USED INVERT OF SEWER MANHOLE NO. 156 AS SHOWN ON BOSTON WATER AND SEWER PLAN SHOWN HEREON. ELEVATION=85.45


TEMPORARY BENCH MARKS USED:

TBM—A: MAG SPIKE ON THE WESTERLY SIDE OF MAPLE STREET. ELEVATION=93.99

TBM-B: DRILL HOLE SET IN SIDEWALK ELEVATION=100.07

- 2) UNDERGROUND UTILITIES SHOWN ARE FROM FIELD OBSERVATIONS AN RECORD INFORMATION AND ARE NOT WARRANTED TO BE EXACT IT'S SIZE, LOCATION, OR PLANNING FUTURE CONNECTIONS, THE PROPER UTILIT ENGINEERING DEPTH NOR IS IT WARRANTED THAT ALL UNDERGROUN DEPARTMENT SHOULD BE CONSULTED AND THE ACTUAL LOCATION OF PIPES OR STRUCTURES ARE SHOWN. SUB-SURFACE STRUCTURES SHOULD B DETERMINED IN THE FIELD. CALL, TOLL FREE, THE DIG SAFE CALL CENTER AT 1-888-344-7233 SEVENTY TWO HOURS PRIOR TO EXCAVATION.
- 3) THIS DOCUMENT IS AN INSTRUMENT OF SERVICE OF FRAMINGHAM SURVEY CONSULTANTS ISSUED TO OUR CLIENT FOR PURPOSES RELATED DIRECTLY AND SOLELY TO FRAMINGHAM SURVEY CONSULTANTS SCOPE OF SERVICES UNDER CONTRACT TO OUR CLIENT FOR THIS PROJECT.
- 4) RECORD UNDERGROUND TELEPHONE AND CABLE WERE NOT AVAILABLE AT TIME OF SURVEY.

I HEREBY CERTIFY THAT THIS IS A TRUE PLOT PLAN BASED UPON AN ACTUAL FIELD SURVEY AND INFORMATION OF RECORD.

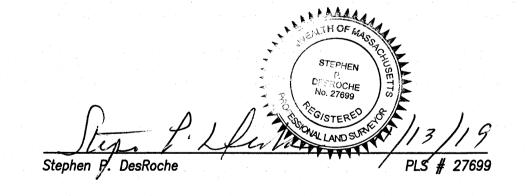



TOPOGRAPHIC PLAN 34 OAK STREET HYDE PARK, MASSACHUSETTS

FRAMINGHAM SURVEY CONSULTANTS INC. P.O. BOX 1190 FRAMINGHAM, MA 01701


 SCALE:
 1"=10'
 DRAWN BY:
 RDN
 DWG:
 4105_19


 DATE:
 JUNE 14, 2019
 CHECKED BY:
 SPD
 JOB NO:
 4105_19

 GRAPHIC SCALE (IN FEET)

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 0
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 20
 30
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IN ASSOCIATION WITH NEPONSET VALLEY SURVEY ASSOCIATES, INC.



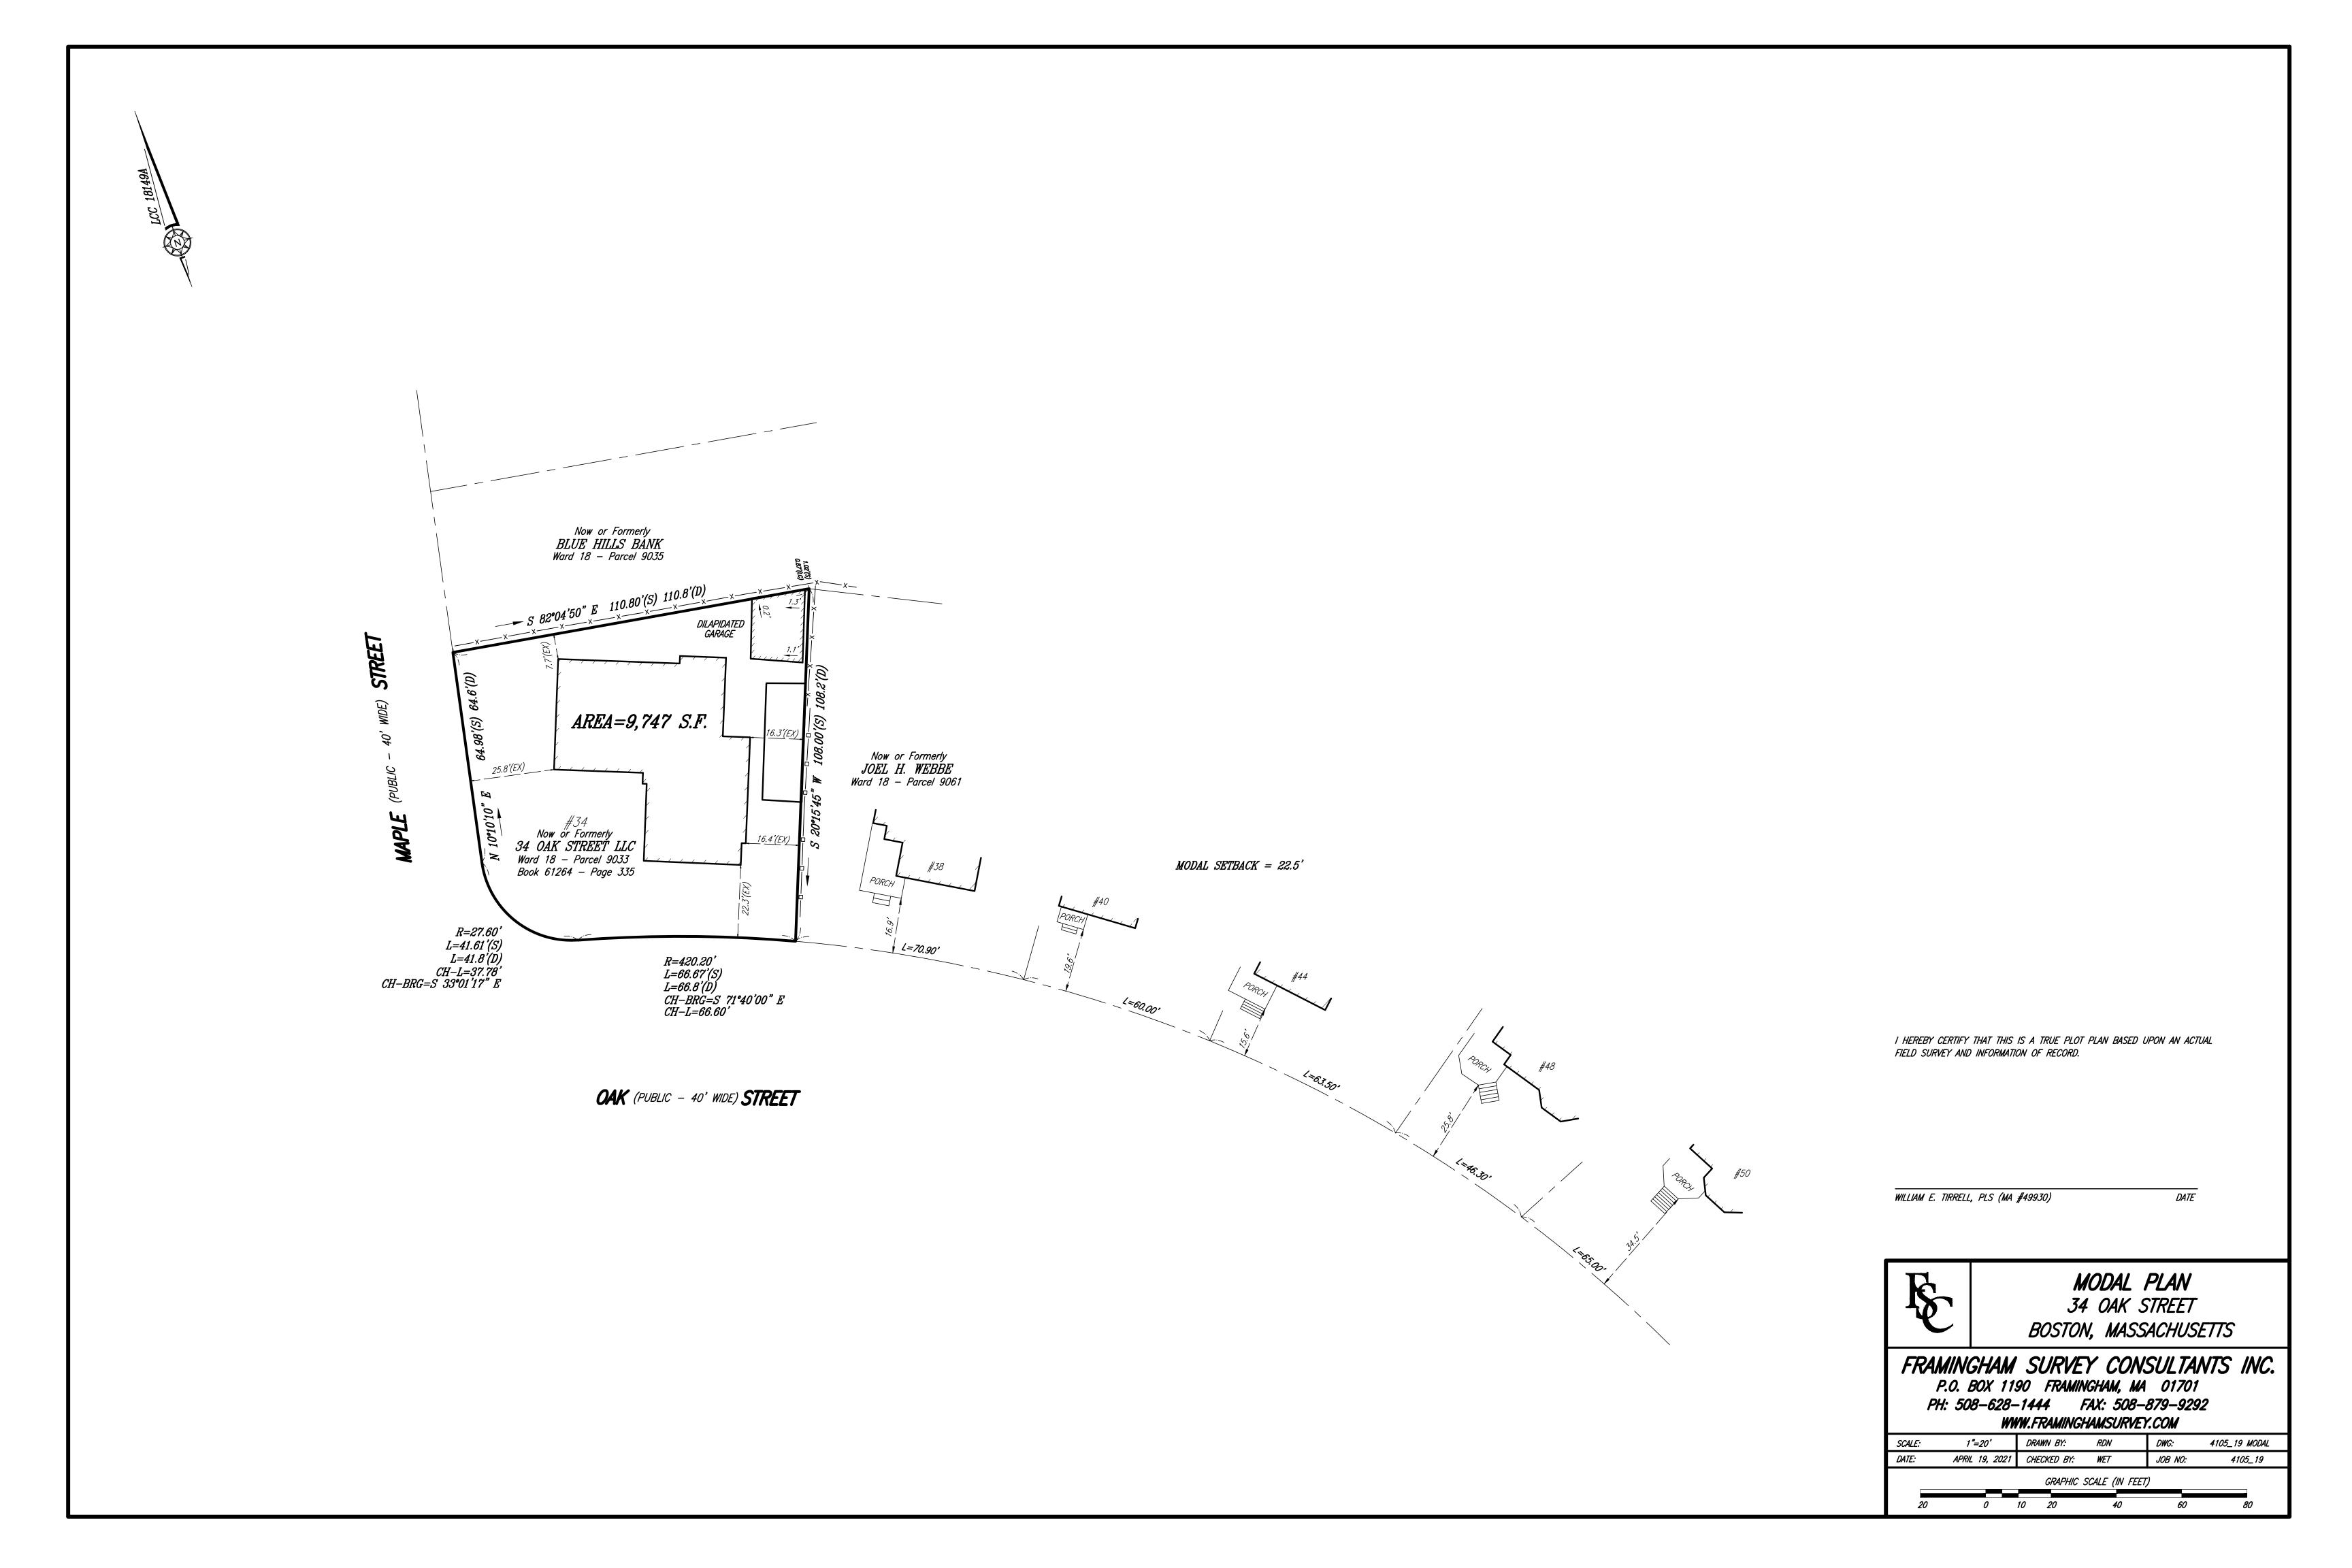

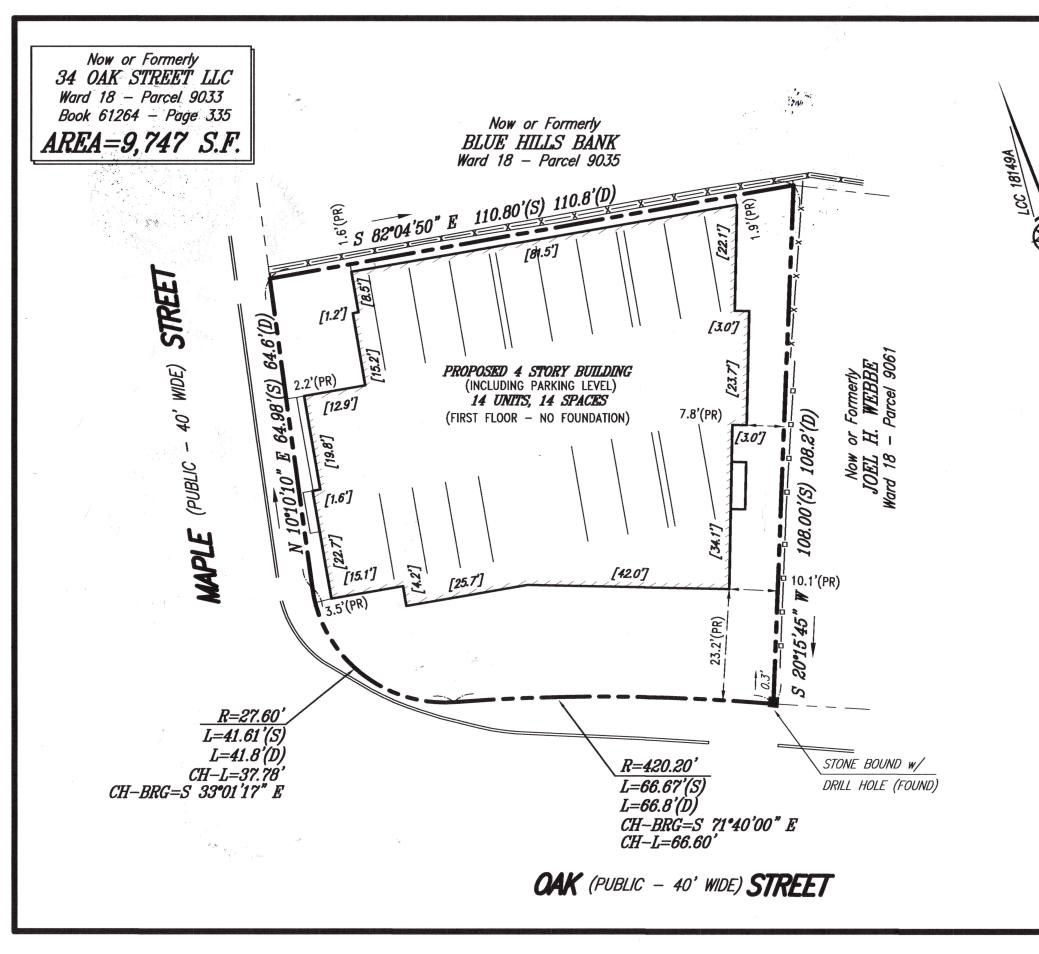LEGEND


(PR) - PROPOSED OFFSET

PROPOSED DIMENSION

SURVEY DIMENSION

- DEED DIMENSION

I CERTIFY THAT THIS PLAN IS BASED ON AN ACTUAL FIELD SURVEY, PLANS AND DEEDS OF RECORD.

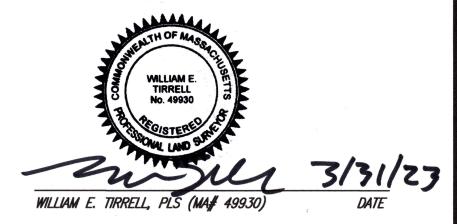




PLAN FOR PROPOSED BUILDING 34 OAK STREET

(HYDE PARK) MASSACHUSETTS

FRAMINGHAM SURVEY CONSULTANTS INC. P.O. BOX 1190 FRAMINGHAM, MA 01701 FAX: 508-879-9292 PH: 508-628-1444 WWW.FRAMINGHAMSURVEY.COM

SCALE:	1"=20"	DRAWN BY:	RDN	DWG:	4105_19 PPPFR r4			
DATE:	FEBRUARY 17, 2023	CHECKED BY:	WET	JOB NO:	4105_19			
GRAPHIC SCALE (IN FEET)								
			TO RESERVE STATES					

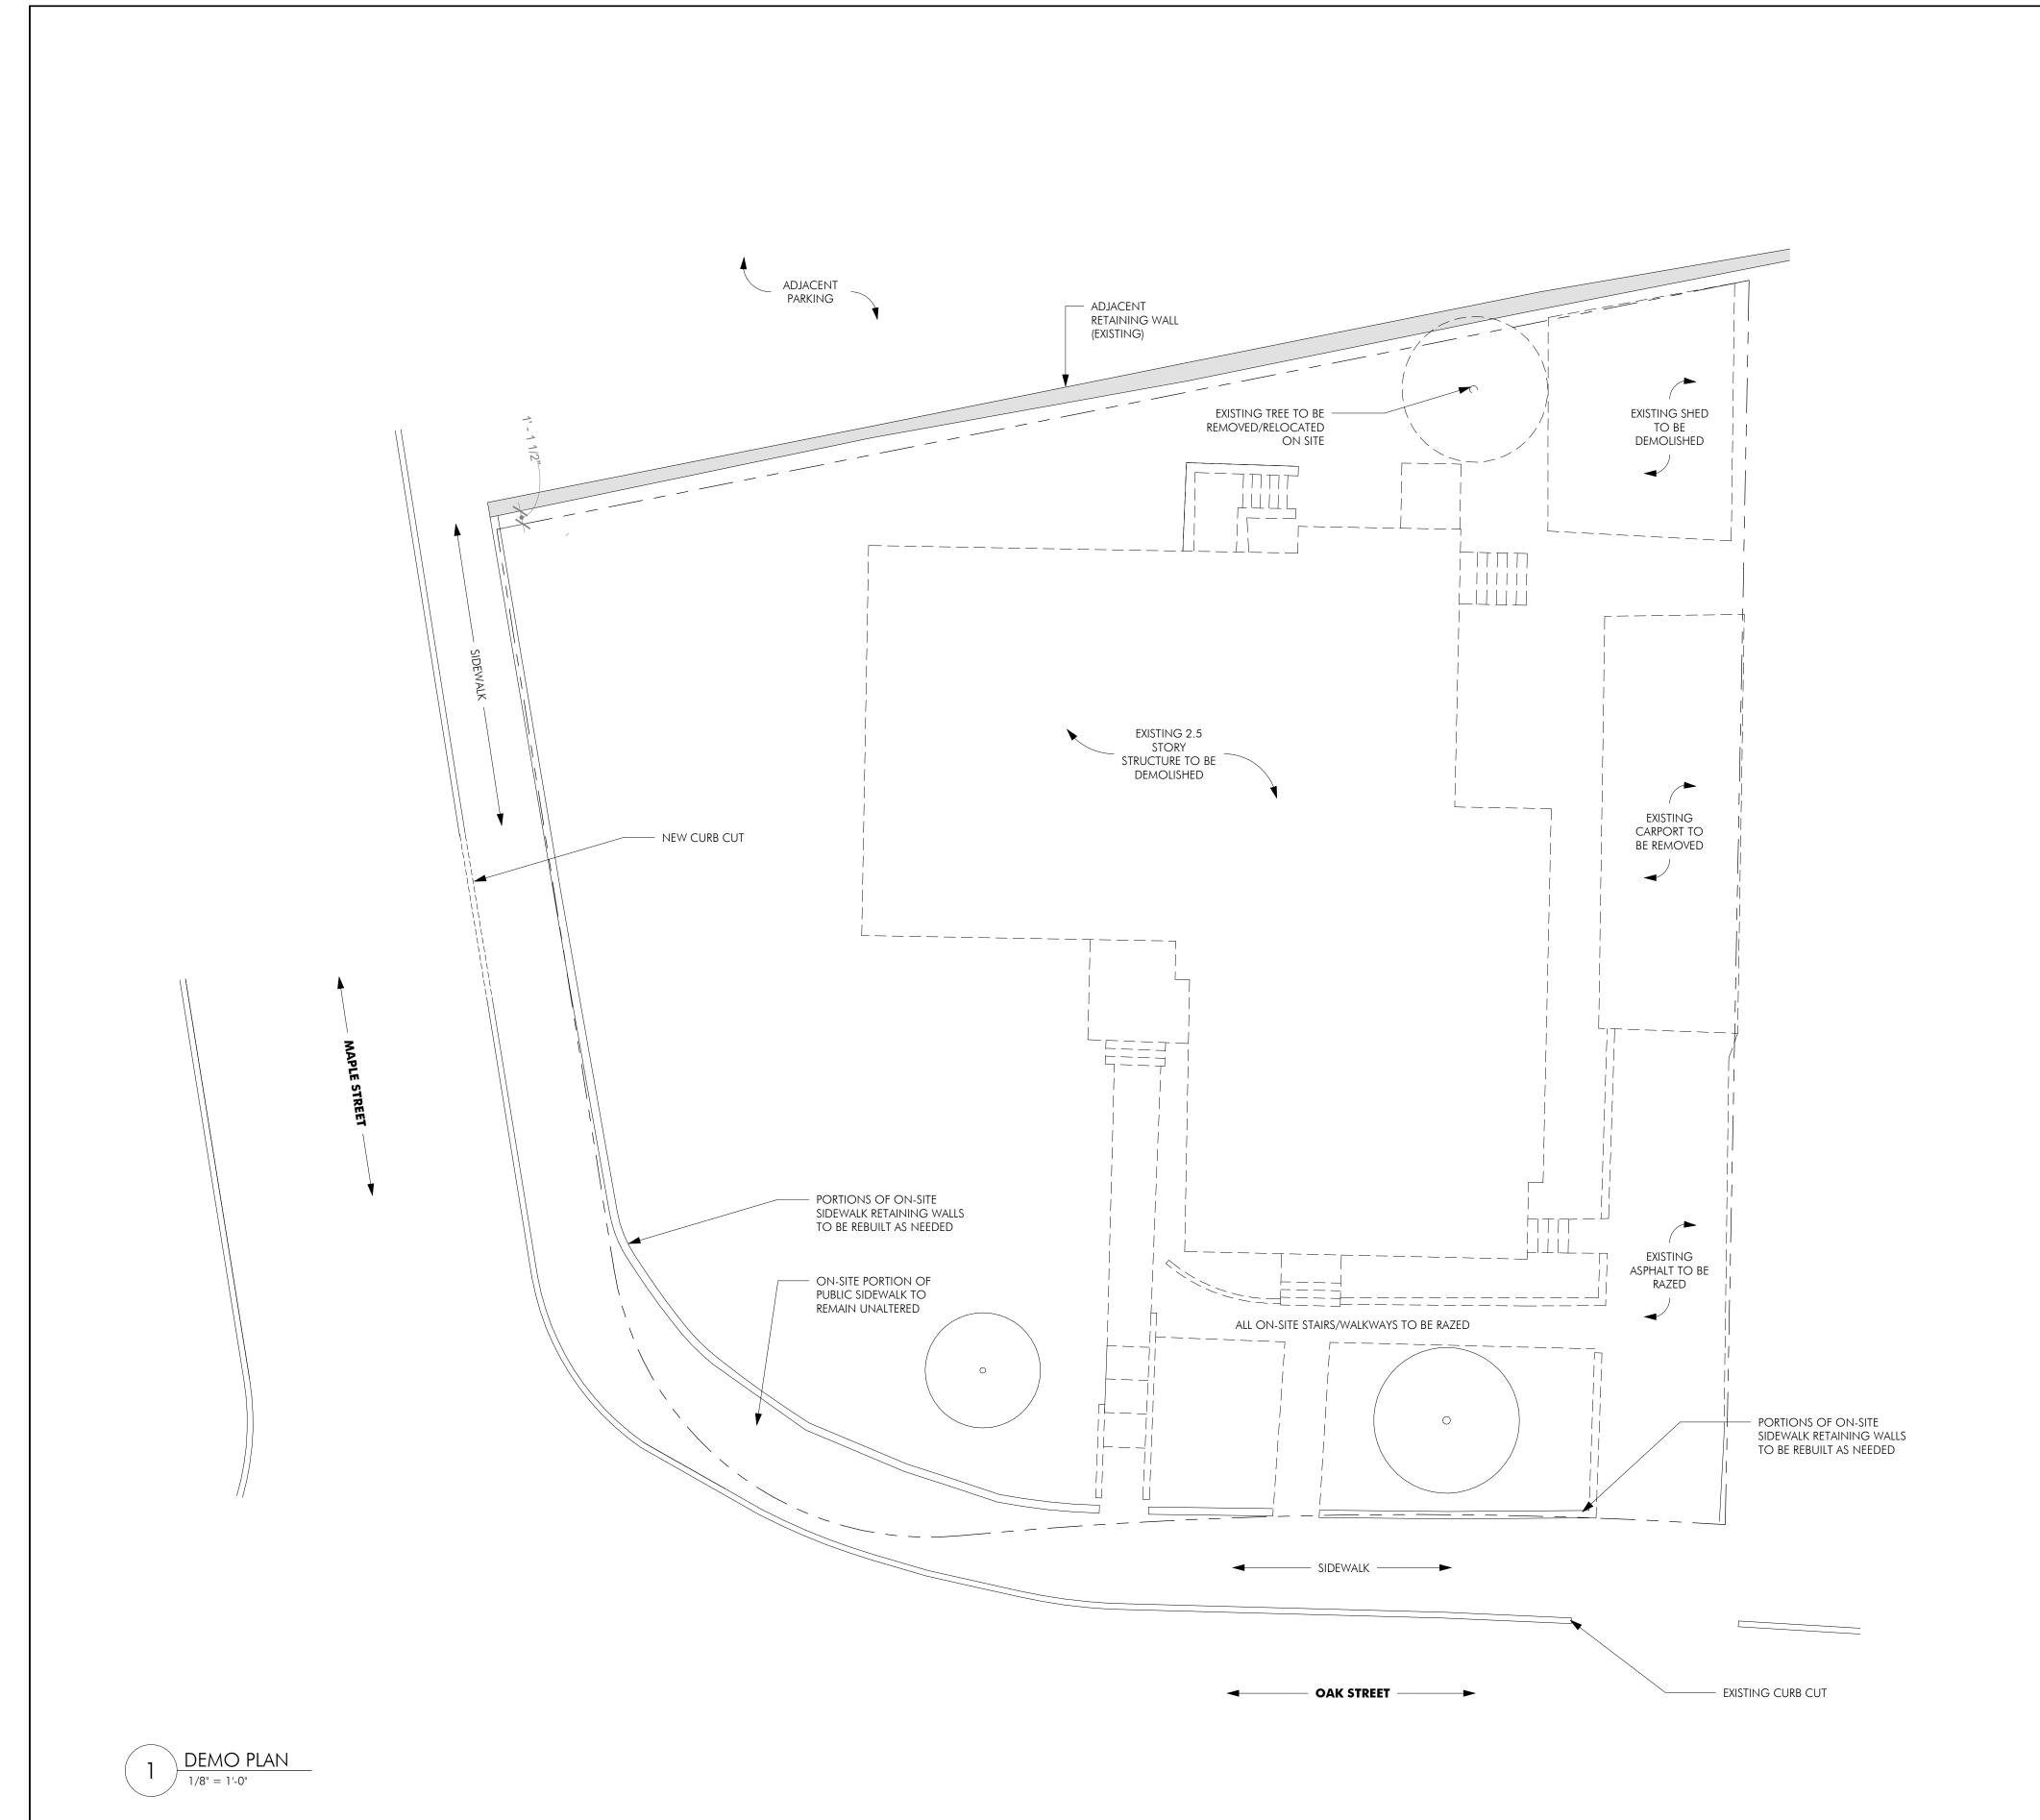

ARCHITECT
EMBARC

580 HARRISON AVE, SUITE 2W
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www.embarcdesign.com

OWNER

Diarmaid McGregor

CONSULTANTS

ONSTRUCTION

STON, MAD

REVISIONS

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 MARK
 ISSUE
 DATE

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 Revision 1
 3.27.23



DRAWING INFORMATION

ISSUE: ISSUED FOR CONSTRUCTION

DATE: FEBRUARY 17, 2023

PROJECT #: 21004

SCALE: 1/8" = 1'-0"

DRAWING TITLE
SITE DEMOLITION
PLAN

DRAWING NUMBER

D100

pyright: EMBARC INC.

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ARCHITECT EMBARC 580 HARRISON AVE, SUITE 2W BOSTON, MA 02118 O: 617.765.8000 www.embarcdesign.com

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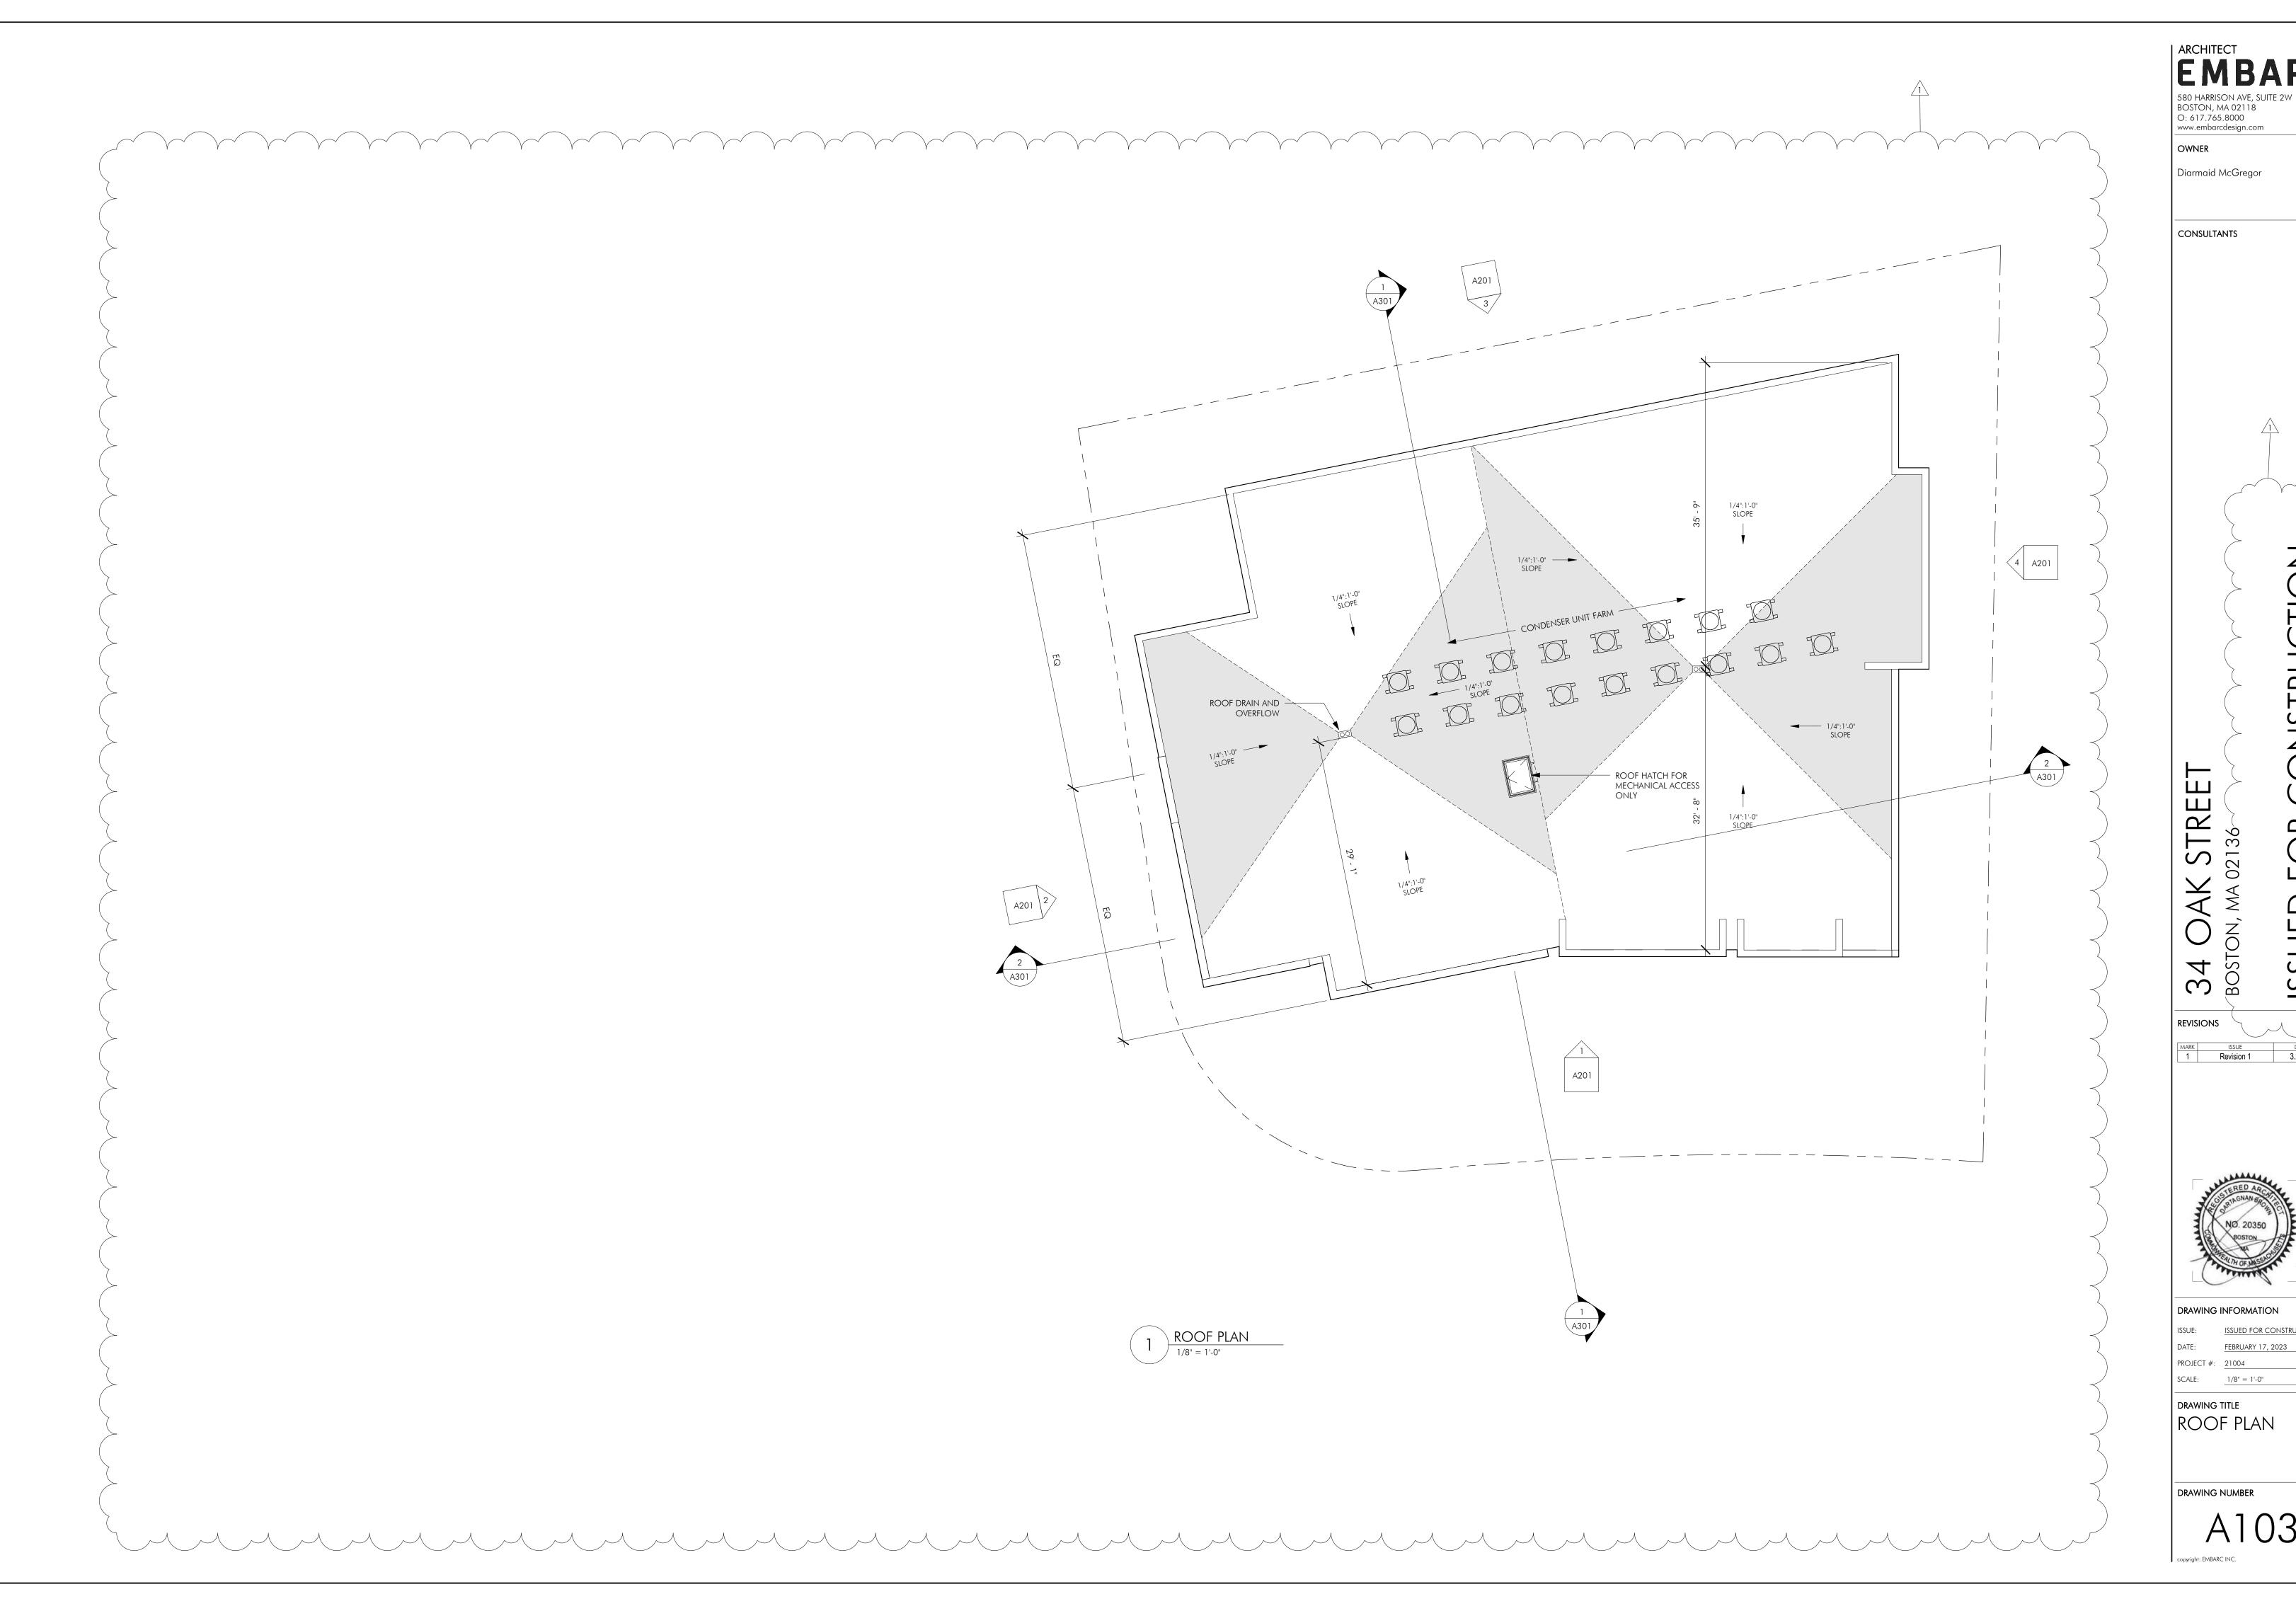
DRAWING INFORMATION

ISSUE: ISSUED FOR CONSTRUCTION

PROJECT #: 21004 1/8" = 1'-0"

DRAWING TITLE PROPOSED PLANS

DRAWING NUMBER



ARCHITECT EMBARC

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 ISSUE
 DATE

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 Revision 1
 3.27.23




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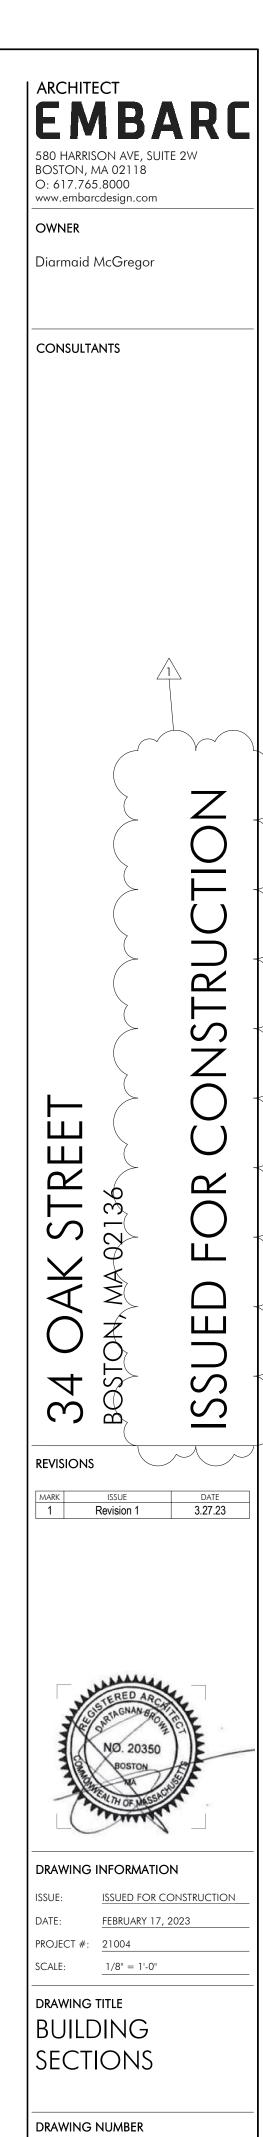
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2 LONG
1/8" = 1'-0





STREET VIEW - CORNER OF OAK AND MAPLE STREET
STREET VIEW - OAK STREET

ARCHITECT
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OWNER
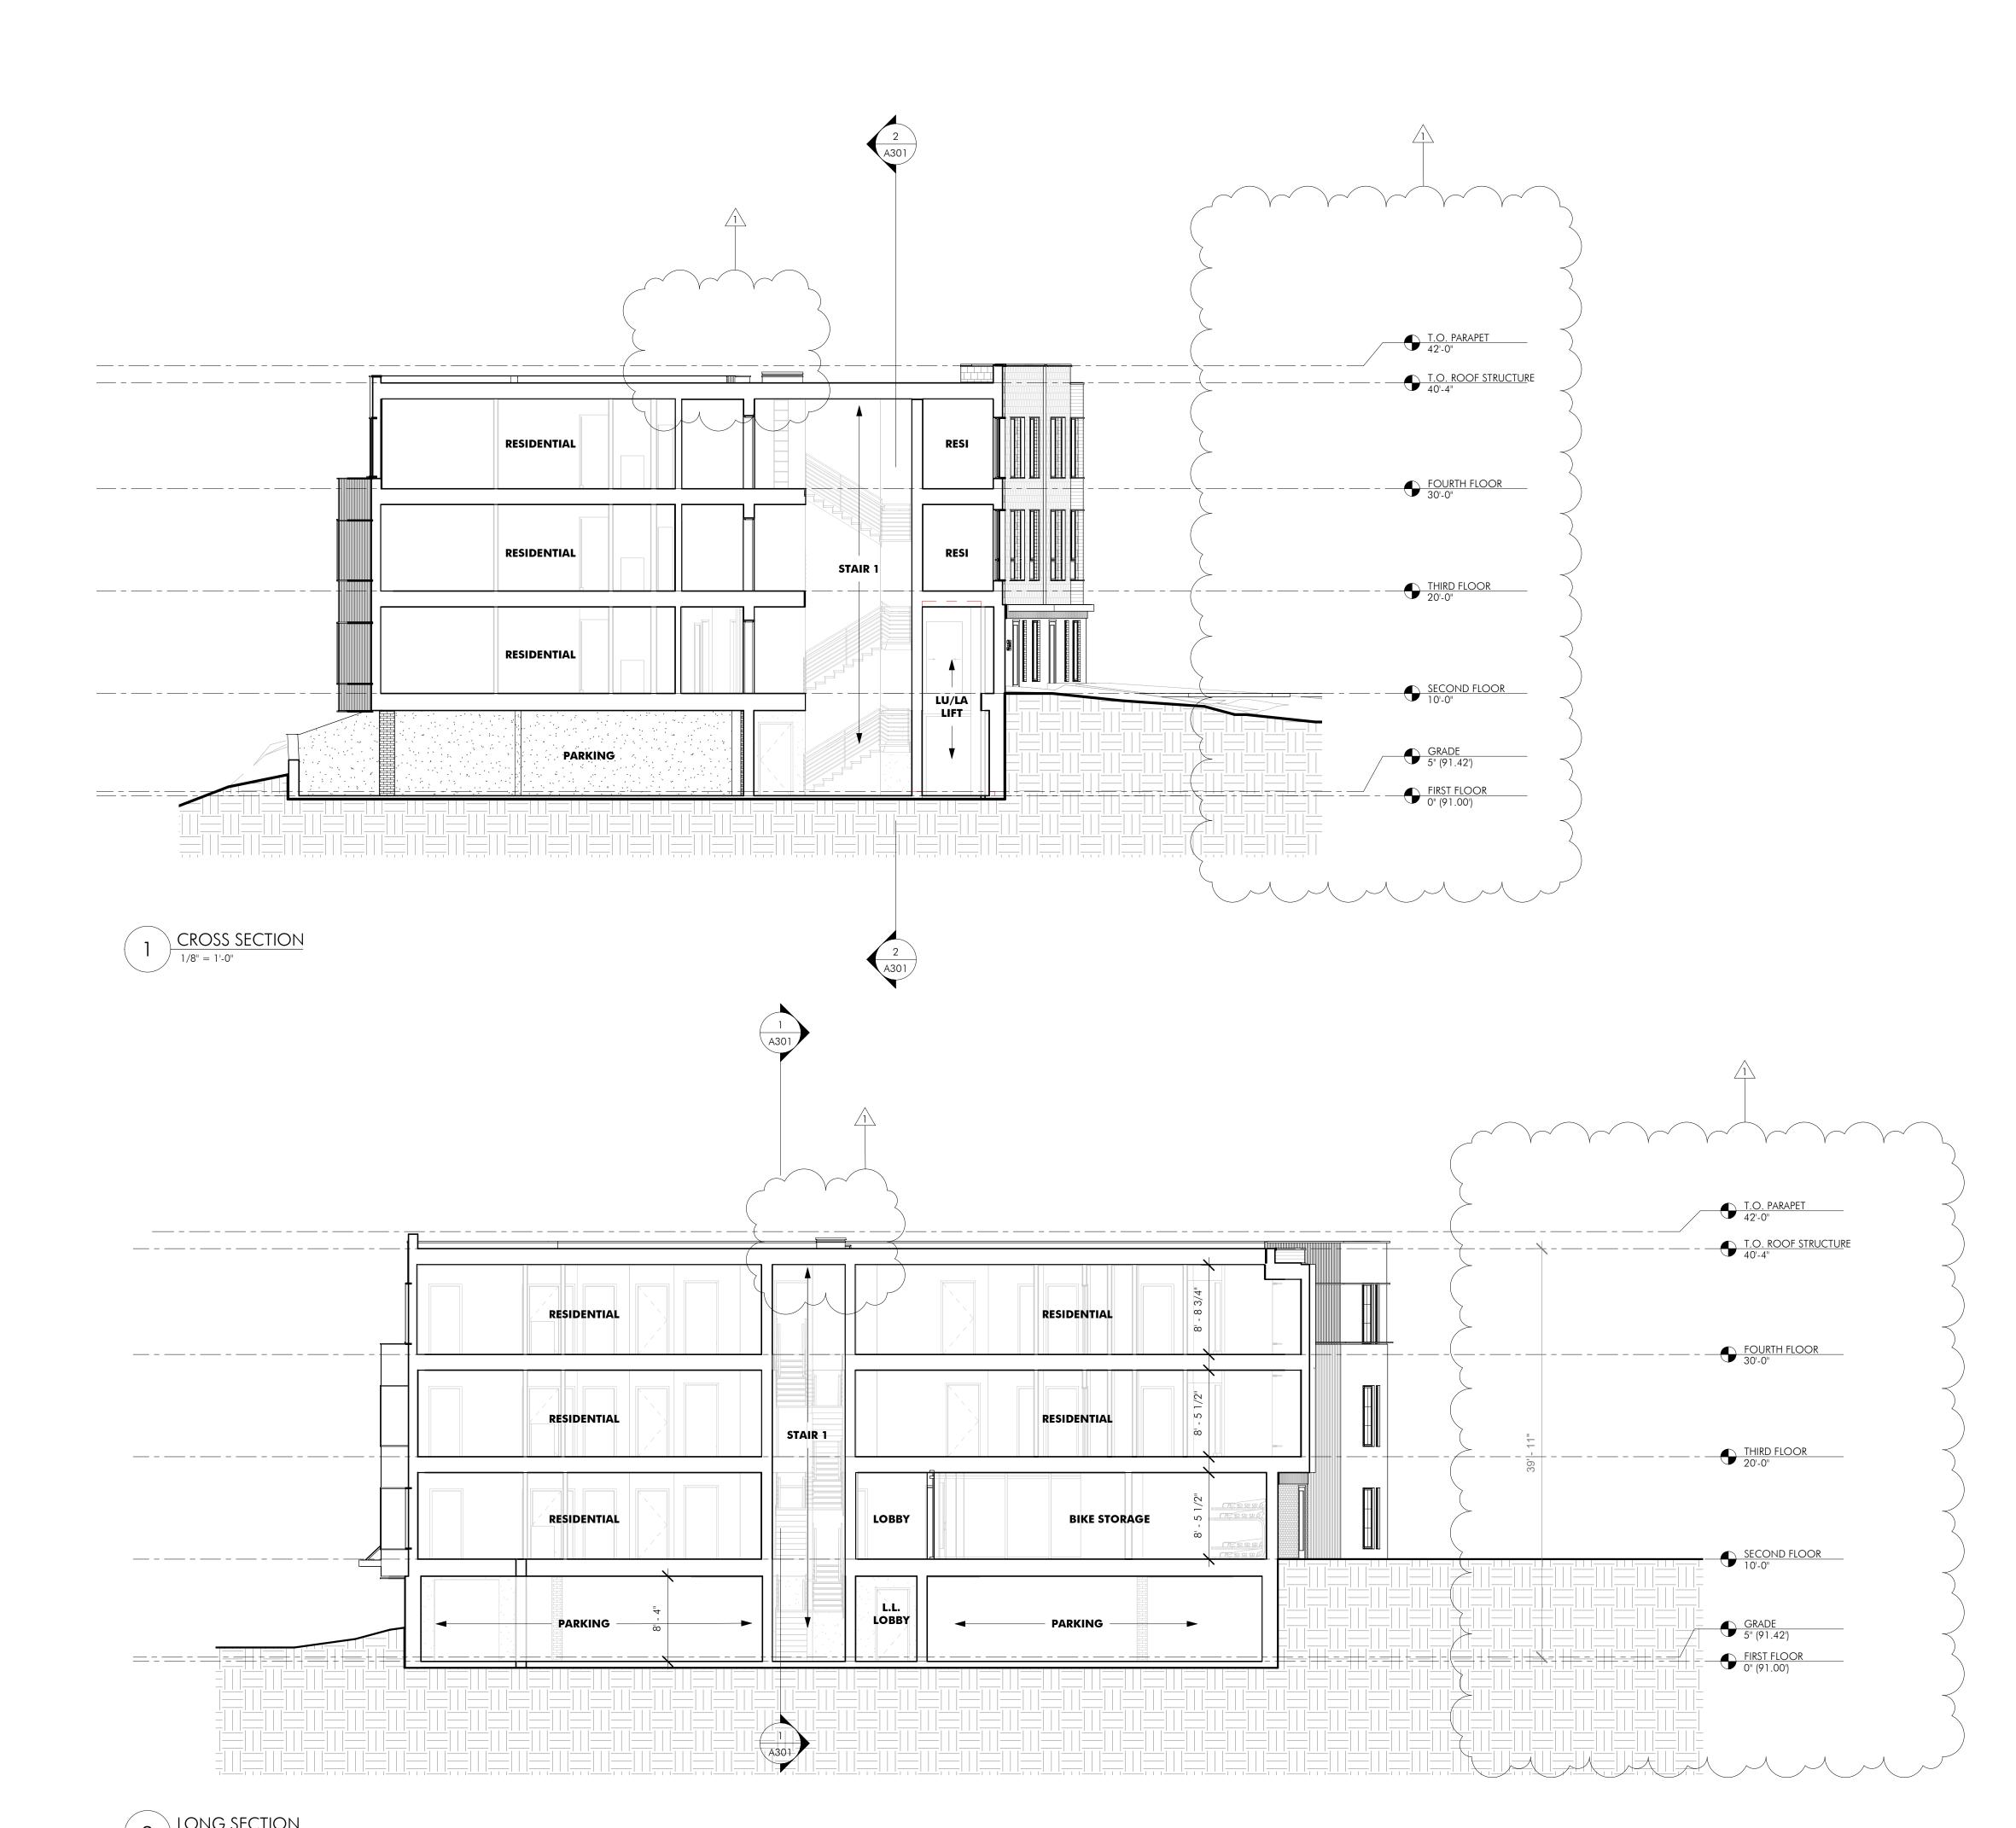
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ISSUED FOR CONSTRUCTION

MARK ISSUE DATE

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NO. 20350
BOSTON
MA

DRAWING INFORMATION

ISSUE: ISSUED FOR CONSTRUCTION

DATE: FEBRUARY 17, 2023

ROJECT #: 21004

CALE:

DRAWING TITLE

3D VIEWS

DRAWING NUMBER

A900

nt: EMBARC INC.