#### Application for Article 80 Small Project Review

### New England Heritage Homes



New England Avenue, Colonial Avenue, Mallard Avenue, and Southern Avenue, Dorchester, MA

December 9, 2015

Submitted to:
Boston Redevelopment Authority

Submitted by: Codman Square NDC

Muammar Hermanstyne, Director of Real Estate 617-825-4224 x145 muammar@csndc.com

Annie Wong Project Manager 617-825-4224 x137 annie@csndc.com

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December 9, 2015

Brian P. Golden, Director Boston Redevelopment Authority Boston City Hall, 9<sup>th</sup> floor Boston, MA 02201-1007

Attn: Phil Cohen

Re: Article 80 Small Project Review Application

New England Heritage Homes, Dorchester, MA

Dear Director Golden:

On behalf of Codman Square Neighborhood Development Corporation, I am pleased to submit the enclosed application for Article 80 Small Project Review for New England Heritage Homes.

The New England Heritage Homes (NEHH) is a proposed affordable homeownership project of 16 mixed-income feesimple units located in the Talbot Norfolk Triangle neighborhood of Codman Square in Dorchester. The proposed development is within 1/4 mile of the new Talbot Ave Station on the Fairmount Line, which provides an opportunity to achieve transit access and walkability, while creating new affordable opportunities for moderate income homebuyers in Codman Square Neighborhood Development Corporation's (CSNDC) service area. The parcels include two City-owned vacant lots and are located within Dorchester's Eco-Innovation District (EID).

CSNDC and the Codman Square community are excited about this project for many reasons, among them:

- Transit oriented development in support of the MBTA Fairmount Line Talbot Station;
- A mixture of affordable units, ranging from 80-100% area median income or below;
- Green design and construction that meets LEED standards;
- Revitalization of underutilized property;
- Affordable homeownership and asset development; and
- Construction-related local jobs and workforce diversity.

We have engaged in extensive discussions with the City of Boston's Department of Neighborhood Development (DND) concerning project design, conducted outreach with local elected and appointed officials, and also worked with neighborhood groups and businesses. These groups include the Talbot Norfolk Triangle Neighbors United and Codman Square Neighborhood Council. This project will address a vital need in the community to produce more workforce and middle income housing while revitalizing an otherwise abandoned site.

Please see the content of this application for details about the project. Please contact Project Manager Annie Wong (617-825-4224 x137 annie@csndc.com) with any questions or comments. Thank you for your consideration of this application, and Llook forward to the Article 80 process.

Sincerety

Gail Latimore President





#### Project Notification Form/Application for Small Project Review

#### **Required Information for Document Preparation**

For projects undergoing review and consideration under Article 80 of the Boston Zoning Code, applicants are requested to ensure that the following information is included in its Project Notification Form or Application for Small Project review, as the case may be:

**Applicant/Project Proponent**: "New England Heritage Homes" Codman Square Neighborhood Development Corporation d/b/a Codman Community Development, Inc.

Developer: same

Contact: Annie Wong, Project Manager

Mailing Address: 587 Washington St., Dorchester MA 02124

Phone #: 617-825-4224 x137 Email: annie@csndc.com

**Brief Project Description:** 17 affordable homeownership units in ten new buildings; all affordable, (100% AMI or below); 17 parking spaces

Anticipated Submission Date: 12/9/15

Anticipated Advertisement Date (if applicable)

Proposed Project Name: New England Heritage Homes

**Project Address:** 

- 1. 28 Mallard Avenue,
- 2. 30 Mallard Avenue,
- 3. 32 Mallard Avenue,
- 4. 34 Mallard Avenue,
- 5. 36 Mallard Avenue,
- 6. 63 Colonial Avenue,7. 68 Colonial Avenue,
- 8. 70 Colonial Avenue,
- 9. 72 Colonial Avenue,
- 10. 30 New England Avenue,
- 11. 42 New England Avenue,
- 12. 60 New England Avenue,
- 13. 70 New England Avenue,
- 14. 129 Southern Avenue,
- 15. 131 Southern Avenue,
- 16. 133 Southern Avenue,

All of the above addresses are in Dorchester, MA 02124

Assessor Parcel Numbers: 30 New England (Parcel #17-01569000), Colonial Ave (#17-01535000), Colonial Ave (Parcel #17-01536000), 63 Colonial Ave (Parcel #17-01568000), Mallard Ave (Parcel #17-01568000),

01570000), 131 Southern Ave. (Parcel #1701534000) and 133 Southern Ave. (Parcel #1701534001), Dorchester, MA 02124

Neighborhood: Dorchester

Sub-Neighborhood (if applicable)

Zoning District 3F-6000

\_\_\_\_\_

Does Project Require Modification to URA?(Y/N): NO

Inst. Master Plan (Y/N) No Planned Development Area (Y/N) No 121A (Y/N) No

Zoning Relief Required -- Zoning Board of Appeal (Y/N) Yes Boston Zoning Commission (Y/N) No

#### **Development Program**

Parcel Area (Sq. Ft.): 41,294sq. ft.

Proposed Building Area (Gross Sq. Ft.): 26,763 sq. ft.

<u>Proposed Building Height (Feet):</u> 35' (68 Colonial Avenue, 30 New England Avenue, and 133 Southern Avenue)

Number of Floors: 2

Proposed Building Height (Feet): 35' (28 Mallard Avenue, 30 Mallard Avenue, 32 Mallard Avenue, 34 Mallard Avenue, 63 Colonial Avenue, 70 Colonial Avenue, 72 Colonial Avenue, 42 New England Avenue, 60 New England Avenue, 70 New England Avenue, 129 Southern Avenue, and 131 Southern Avenue)

Number of Floors: 3

Proposed Building Height (Feet): 35' (36 Mallard Avenue) Number of Floors: 3

Ground Floor Use: Residential Upper Floor Use: Residential

Retail Sq. Ft.: N/A Office Sq. Ft.: N/A Hotel Sq. Ft.: N/A

Industrial Sq. Ft.: N/A Institutional Sq. Ft.: N/A R&D Sq. Ft. N/A

Residential Gross Sq. Ft.: 26,763 SF sq. ft. Total Units: 17 Condo: 0 Rental: 1

Market Units: 0 Affordable Units: 17 Studios: 0 1bdrms: 0 2bdrms: 1

3bdrms: 16 4bdrms: Artist Live/Work: 0 SRO N/A Elderly N/A

Total Parking Spaces: 17 Surface: 17 Structured \_\_\_\_ Below Grade \_\_

Total Development Cost (soft/hard costs): +/- \$6.9 Million Construction Cost (hard cost): +/- \$4.3 Million

#### **Public Benefits**

Number of Permanent Jobs Created (full-time equivalent): none Number of Permanent Jobs Retained (full-time equivalent): none Number of Construction Jobs Created (full-time equivalent): 25

Estimated Development Impact Project Payments (if applicable): none

Estimated Construction Start: August 2016 Estimated Construction Completion: August 2017

#### <u>Disclosure of Beneficial Interest in the Project</u>

Name	Address	Percentage Interest	
Codman Community Development, Inc	. CSNDC	@ 587 Washington St., Dorchester MA, 02124	100%

#### **Project Team**

#### **Developer / Sponsor:**

Codman Square Neighborhood Development Corporation 587 Washington Street Dorchester, MA 02124

Annie Wong, Project Manager 617-825-4224 x137 annie@csndc.com

Muammar Hermanstyne, Director of Real Estate Development 617-825-4224 x145 muammar@csndc.com

#### **Legal Counsel:**

Goulston & Storrs 400 Atlantic Avenue Boston, MA 02110-3333

#### **Architect:**

Michael Washington Architects, Inc. 891 Centre St #402 Jamaica Plain, MA 02130

Michael Washington (Principal in Charge) (617) 390-5515 <u>mwainc1@hotmail.com</u>

Jason R. Beaudoin (Project Manager) (617) 390-5515 jasonrbeaudoin@gmail.com

#### Surveyor

Antoni Szerszunowicz P.L.S. c/o AGH Engineering 166 Water Street Stoughton, MA 02072 office (781)344-2386 szerszun@comcast.net

#### **Project Description**

#### Overview

The New England Heritage Homes (NEHH) is a proposed affordable homeownership project of 17 mixed-income fee-simple units on an assembly of seven parcels of land totaling approximately 40,000 square feet. The parcels are located near the intersection of New England Avenue, Mallard Avenue, Colonial Avenue, and Southern Avenue in the Talbot Norfolk Triangle neighborhood of Codman Square in Dorchester, and are within 1/4 mile of the new Talbot Ave Station on the Fairmount Line. The parcels include two City-owned vacant lots and are located within Dorchester's Eco-Innovation District (EID). The proposed development will provide an opportunity to achieve transit access and walkability, while creating new affordable opportunities for moderate income homebuyers in Codman Square Neighborhood Development Corporation's (CSNDC) service area.

The project, developed by Codman Community Development, Inc. (a subsidiary of CSNDC), is a part of a larger effort of the Fairmount Collaborative, in which CSNDC, Dorchester Bay EDC (DBEDC), and Southwest Boston CDC (SWBCDC) have targeted development opportunities near existing and planned stops on the Fairmount commuter rail line.

#### *Highlights of the project include:*

- Transit oriented, sustainable development in support of the MBTA Fairmount Line Talbot Station (down the street from the site), and in support of the Fairmount Collaborative<sup>1</sup>;
- A mixture of affordable units, including 8 units affordable to residents earning 80% AMI or below, and 8 units affordable to residents earning 100% AMI or below;
- "Green" design and construction that meets LEED standards and compliments the work being completed in the Dorchester Eco Innovation District;
- Revitalization of underutilized property;
- Affordable homeownership and asset development; and
- Construction-related local jobs and workforce diversity.

#### **Project Location & Neighborhood Context**

As illustrated in the maps below, the site is located in the Talbot Norfolk Triangle (TNT) area of Dorchester's Codman Square and falls within Dorchester's Eco Innovation District. The TNT is bounded on the north by Talbot Avenue, on the west by New England Avenue and on the South by Norfolk Street. The neighborhood consists of a mix of 1, 2 and 3 family residential buildings midblock; multifamily housing primarily on Talbot Avenue and Norfolk Street; commercial and retail enterprises on Talbot Avenue and Norfolk Street, and scattered industrial properties. In the general vicinity of the

<sup>&</sup>lt;sup>1</sup> The Fairmount Line, running from Readville to South Station, is the only MBTA commuter rail line lying entirely within Boston city limits. For years since the 2<sup>nd</sup> World War, it has run through communities of color in Mattapan, Dorchester and Roxbury, while offering little or no service to these communities. A combination of factors (community-led demands for environmental equity; court-mandated mitigation for the Big Dig; and renewed concern for cost-effective alternatives to auto transportation) have led to binding commitments by the MBTA to upgrade the line and service, and to open four new stops in formerly underserved areas, by the close of 2011. Two of the stops lie in CSNDC's service area (Four Corners, and Talbot Avenue). In 2004, CSNDC joined with three other CDC's (Dorchester Bay, Mattapan, and South-west Boston) in the Fairmount Collaborative, to plan for and carry out the physical and social redevelopment needed to support expansion of the Line. The Collaborative has sponsored a nationally recognized planning study by Goody-Clancy (copies of which are available upon request), won several grants to support its work (from Surdna, Hyams, Boston Foundation and others), and sponsored extensive community planning around each of the new stops.

development site there are commercial/industrial uses, including several auto repair and body shops, a junk yard, and numerous restaurants and retail convenience stores.

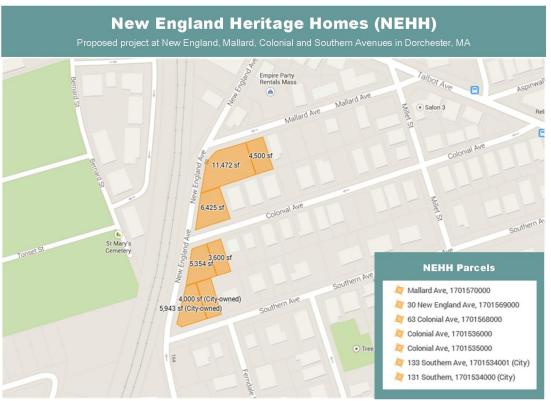


Figure 1 - NEHH Site Map



Figure 2 Map of Talbot Norfolk Triangle

#### **Site Area**

	Property Address	Parcel #	Square Feet
1.	30 New England Avenue	1701569000	11,472
2.	Colonial Avenue	1701535000	5,354
3.	Colonial Avenue	1701536000	3,600
4.	63 Colonial Avenue	1701568000	6,425
5.	Mallard Avenue	1701570000	4,500
6.	131 Southern Avenue	1701534000	4,000
7.	133 Southern Avenue	1701534001	5,943
	TOTAL:		41,294

#### Acquisition

CSNDC purchased the first five parcels of the site area in April 2015. CSNDC anticipates acquiring the last two parcels on Southern Avenue from the City of Boston through Tentative Designation in December 16, 2015.

#### **Existing Conditions**

All site parcels are vacant land. The combined square footage of the site is approximately **41,294** square feet, and the parcels are all in Dorchester's 3F-6000 zoning district.

Phase I and Phase II Environmental Site Assessments have been completed on the New England Avenue, Colonial Avenue, and Mallard Avenue parcels. The Phase II indicated a need for Limited Removal Action (LRA), which was completed in July 2015.

#### **Proposed Use**

The proposed project involves the new construction of 10 two to three story buildings, yielding 17 units of fee simple housing, one of which will be an income restricted rental unit available to the homebuyer to lease for rental income. Three of the new buildings will be constructed as unattached structures for single family homes, six will be constructed as attached duplexes (each to be sold separately as single family homes) and one will be constructed as a stacked two-family home.

Unit Type	Number of New Buildings	Number of Units	Gross Square Feet per Unit	Net Square Feet per Unit
Single family: 3BR	3	3	1566	1397
Duplexes sold as single family: 3 BR	6	12	3219	1280
Two-Family  1st Floor: 2BR	1	1	1048	850
2nd & 3rd Floor: 3BR		1	1703	1420
Totals	10	17		

#### **Design Narrative**

The design concept for New England Heritage Homes was developed to accomplish a number of very important program goals. The goals included developing the site plan, building types and units so that they would be compatible with those in the Talbot Norfolk Triangle Neighborhood, and enhance the environment, living conditions, and property values throughout the Triangle. The site design concept also attempt to create and finalize the neighborhood edge at the end to Mallard Avenue, Colonial Avenue and Southern Avenue at New England Avenue.

The site concept design uses the placement of four types of fee simple houses, including single family, attached single family, and stacked and flat two family houses to complete the urban design character of the neighborhood, at New England Avenue. The development will have address and front doors on all the streets. The landscape treatment along the length of the project at New England Avenue will serve as a connector between Norfolk Street and Talbot Avenue. The plan encourages use and circulation along New England Avenue and will assist in spurring activity and redevelopment at both ends of the street.

The four proposed unit types address the compatibility issues of size, shape, scale, architectural character and elements in the neighborhood. They are single and two family structures, 2 and three stories high with sloped roofs, individual entrances with front and rear facing yard areas, and parking. The structure have poured concrete foundations with wood frame construction, asphalt shingle roofing and hardi plank siding.

The Architectural elements include bay windows, entry porches with canopies, wood clad double hung windows and picket fencing.

The material products and components proposed were selected for their energy conservation characteristics, durability and aesthetic quality.

The type of structures, materials and components provided are consistent with the existing character of the housing in the neighborhood. The consistence of height, scale, size and architectural character and elements will create continuity and enhance the character of the environment, help maintain neighborhood property values and support current and future marketability.

The buildings are designed to stretch code requirements. Following are the special feature included in the design and construction:

#### **Foundations:**

The structures have 10" reinforced poured concrete foundation wall sitting on 10" x 24" continuous concrete footing. Four inch slabs on grade are used in basements. Dampproofing will be provided on the exterior foundation wall and 3" R-20 foam insulation will be provided at the interior of the foundation walls.  $3\frac{1}{2}$ " 100 PSI R-20 expanded polystyrene insulation will be installed under the basement slabs.

#### Exterior Wood Frame Wall Construction:

Wall construction will provide a single 2" x 6" wood stud wall with the standard interior finish wall material and a layer of exterior sheathing covered by a 3" hunter insulation panel with sheathing board applied and final exterior siding. The 5½" of insulation in the stud cavity will provide a minimum R-21 and a 2" Hunter Insulation panel will provide an additional R-10 to the exterior wall construction for a total R-30. Construction provides for Tyvek, zip, or other building wrap system plus exterior siding.

#### **Wood Frame Roof Construction:**

The project provides for two situations for the wood frame roof construction.

The First Situation: the first situation provided for is when habitable space is not present above the Attic floor framing joist and under the sloped roof. When habitable space is not provided between the attic joist and the roof rafter, the insulation will all be installed at the attic joist level in two perpendicular layers. One layer being installed between the ceiling joist and one layer being installed perpendicular to the joist direction, combining for a total of 15" minimum thickness and a R=50 rating.

<u>The Second Situation:</u> the second situation provides for a condition when there is habitable space in the attic. In this case, the insulation is provided at the sloped roof framing in a construction component made up of the rafter framing and plywood sheathing and R-50 netted cellulose, fiberglass batt, or low density foam insulation between the rafter.

Other building components used to help achieve energy efficiency are listed below:

<u>Windows:</u> Double hung, double glazed, U-30 windows are specified for the project to further minimize energy consumption.

<u>Solar Ready Roof Systems:</u> The buildings are all designed as solar ready. All components needed for installation of solar panel will be included in the base design. A disconnect switch and all necessary conduit from roof to basement will be included.

Landscaping will be provided to enhance each home and the adjacent community. The design and construction for the New England Heritage Homes project will make use of all currently available technology to ensure energy efficiency.

#### **Green Design / LEED**

NEHH represents the latest effort by CSNDC to produce "green" sustainable real estate developments. The project will also compliment the sustainability work already underway in the Eco Innovation District. The project will conform to LEED and City of Boston green standards. Since the project is within the boundaries of the Dorchester Eco Innovation District, we also hope to be able to raise energy and resource use standards on some or all of these homes while still producing quality, affordable homeownership opportunities for local residents.

#### **Proposed For Sale Units**

The proposed unit mix includes 8 units affordable to residents earning 80% AMI or below, and 8 units affordable to residents earning 100% AMI or below.

Proposed For Sale Units					
Unit Type	80% AN	<b>/</b> 11	100% AM	ll .	
				Sales	
	Number of Units	Sales Price	Number of Units	Price	Total
Unattached Single Family: 3BR	2	\$275,000	1	\$330,000	3
Attached Single Family: 3 BR	6	\$275,000	6	\$330,000	12
2 Family: 3BR and 2 BR units	-	-	1	\$415,000	1
Totals	8		8		16

#### **Funding and Financing**


CSNDC has received acquisition and predevelopment financing from the Local Initiatives Support Corporation and The City of Boston's Department of Neighborhood Development (through the Fairmount Corridor Acquisition Loan Fund "FCALF"). CSNDC has also been awarded grant awards from MassDevelopment's Brownfields Site Assessment Grant, and the Massachusetts Pathway to Zero Grant program. In addition, the project proponent is in the process of applying for \$1.67MM of City of Boston funding.

#### **Permitting & Zoning**

Initial NEHH drawing sets were submitted to Boston ISD on January 23, 2015. The most recent ISD rejection letters were issued on May 7, 2015. Amended drawing sets were submitted on December 8, 2015 and we expect that ISD will issue rejection letters within 30 days to address zoning violations. An application to the Zoning Board of Appeal is now being prepared.

NEHH is subject to Boston Redevelopment Authority Article 80 Small Project Review. An introductory meeting with BRA was held on Wednesday, December 9, 2015. An application was submitted to the BRA on December 9, 2015.

#### **Zoning Map**

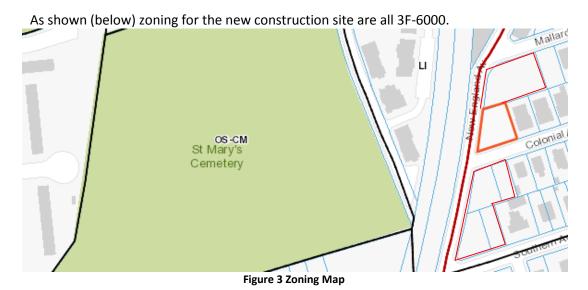

#### Marketing and Lease Up

CSNDC has commissioned a market study which has concluded that the project is appropriate for the site, that there is significant demand for it, and that market absorption will be satisfactory. CSNDC has a successful history with affordable homeownership projects, including our Franklin Field and Norwell Whitfield Homes projects. More recently, CSNDC has completed the renovation and successful sale of four multi-family homes through the Neighborhood Stabilization Program.

#### **Community and Elected Official Support**

CSNDC has engaged in extensive discussions with neighborhood groups and businesses, including the Talbot Norfolk Triangle Neighbors United and Codman Square Neighborhood Council. We have also been working in partnership with the City of Boston's Department of Neighborhood Development (DND) concerning project design, and conducted outreach with local elected and appointed officials.

#### Construction

Construction is projected to begin in August 2016 and will follow a 12 month schedule. Projected completion is August 2017.

#### **Project Team**

- Sponsor / Developer: CSNDC
- Architect: Michael Washington Architects, Inc.
- Green Design: Conservation Services Group
- Environmental Engineering: McPhail Associates, LLC
- Project Attorney: Goulston and Storrs
- Zoning Attorney: McKenzie and Associates
- Marketing and Sale: Robert Nichols, Boston Trust Realty Group

#### **Public Benefits: Affordable Housing and Job Creation**

New England Heritage Homes will provide a range of community benefits, including:

- <u>Homeownership & Neighborhood Stabilization</u> Dorchester has seen an influx of new residents and rising real estate costs in recent years because of its proximity to public transportation and access to downtown Boston. NEHH addresses a significant need in the community to provide homeownership opportunities that will help stabilize the neighborhood through community asset building.
- New Construction All of the units will be new construction and built to at least LEED Silver certification.
- Affordable Housing As Dorchester prices continue to rise there is a strong need to keep longtime residents, and new families from being out priced. NEHH consists entirely of affordable units and strongly aligns with the affordability goals outlined in the Mayor Walsh's "Housing a Changing City 2030" housing plan.
- <u>Transit Oriented Development</u> NEHH is within walking distance to public transportation, which will encourage less need for vehicular travel.
- <u>Job Creation</u> NEHH will also be an agent for economic development by providing approximately 30-40 construction jobs over a 12 month construction period.
- Revitalization Of Site The project will revitalize abandoned and vacant lots and provide new infrastructure and landscaping.

#### **Traffic, Parking and Access**


The current design calls for 17 parking spaces. The ratio of 1 space per unit should be sufficient, especially considering the sites proximity to the Fairmount Line's Talbot train station. We do not anticipate a significant traffic impact and accordingly we have not commissioned a traffic study at this time.

Pedestrians will have ease of access to the site and the construction plan will include rehabilitation of the City of Boston sidewalks along the entire perimeter of the site, per Boston Public Works requirements.

NEHH will also have access to a range of public transportation options. The MBTA #22 bus line (.1 miles from the site, with frequent service) provides access to the Red Line Ashmont Station and the Orange Line Jackson Square Station. The site is within 1 mile of Shawmut Station as well. Additionally, the Talbot Avenue Stop on the Fairmount commuter line is currently open.

Map and Photos

1) Locus Map Showing parcels

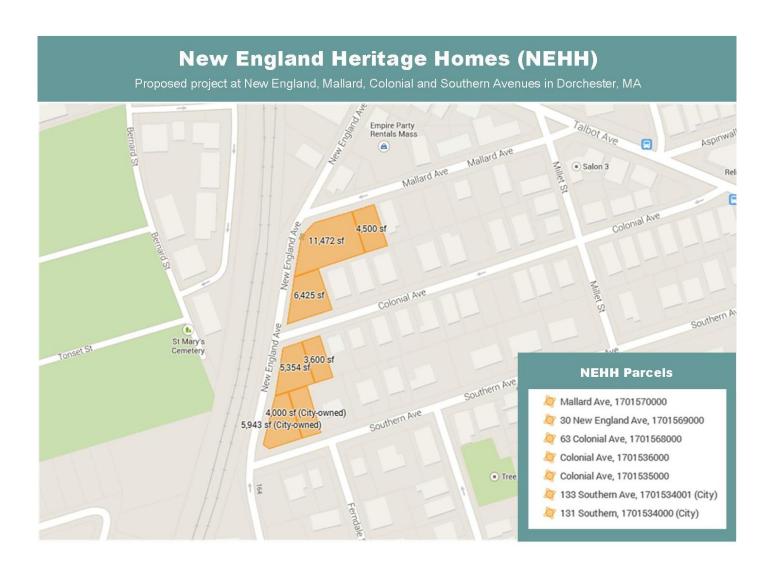

#### 2) Site Photos

#### a) View from New England Avenue onto Mallard Avenue



#### b) View from Colonial Avenue onto Mallard Avenue



#### c) View from New England Avenue



#### d) View from Colonial Avenue onto New England Avenue



#### e) View of Colonial Avenue parcel facing south



#### f) View of New England Avenue from Southern Avenue



#### g) View of Southern Avenue Parcels



#### **Zoning Analysis**

Note: This analysis is based on drawings submitted to Boston ISD on December 8, 2015. Sponsor anticipates that the ISD will issue rejection letters and plans to file appeals with the Boston Zoning Board of Appeal.

129 SOUTHERN AVENUE		
ZONING INFORMATION		
ZONING: 3F 6000 WARD 14	DEGLUDED	ACTUAL
1 Family ATTACHED	REQUIRED 6,000 SF FOR 2 UNITS + 2500 PER ADDT'L	ACTUAL
MIN. LOT SIZE:	UNIT	1,708 SF
MIN. LOT WIDTH:	40 FT	27.41' FT
MIN. LOT FRONTAGE:	40 FT	27.41' FT
MAX. F.A.R:	0.4	0.94
MAX. BLDG. HEIGHT:	2 ½ STORY 35	35FT
MIN. OPEN SPACE:	750 SF PER UNIT	1,087 SF
MIN. FRONT YARD DEPTH:	15 FT/MOD.	15.3 FT
MIN. SIDE YARD DEPTH:	10FT	10.9 FT
MIN. REAR YARD DEPTH:	20FT	10.1 FT
MIN. PARKING:	1/UNIT	1

70 NEW ENGLAND AVENUE		
ZONING INFORMATION		
ZONING: 3F 6000 WARD 14		
1 Family ATTACHED	REQUIRED	ACTUAL
	6,000 SF FOR 2 UNITS + 2500 PER ADDT'L	2,343 SF
MIN. LOT SIZE:	UNIT	
MIN. LOT WIDTH:	40 FT	34.27 FT
MIN. LOT FRONTAGE:	40 FT	34.27 FT
MAX. F.A.R:	0.4	0.68
MAX. BLDG. HEIGHT:	2 ½ STORY 35	35FT
MIN. OPEN SPACE:	750 SF PER UNIT	958 SF
MIN. FRONT YARD DEPTH:	15 FT/MOD.	16.4 FT
MIN. SIDE YARD DEPTH:	10FT	10.1 FT
MIN. REAR YARD DEPTH:	20FT	19.9 FT
MIN. PARKING:	1/UNIT	1

63 COLONIAI AVENUE ( BUILDING E)		
ZONING INFORMATION		
ZONING: 3F 6000		
WARD 14		
1 Family ATTACHED	REQUIRED	ACTUAL
	6,000 SF FOR 2 UNITS	2305 SF
	+ 2500 PER ADDT'L	
MIN. LOT SIZE:	UNIT	
MIN. LOT WIDTH:	40 FT	29.67 FT
MIN. LOT FRONTAGE:	40 FT	29.67 FT
MAX. F.A.R:	0.4	0.67
MAX. BLDG. HEIGHT:	2 ½ STORY 35	35 FT
MIN. OPEN SPACE:	750 SF PER UNIT	1733 SF
MIN. FRONT YARD DEPTH:	15 FT/MOD.	8 FT
		22.1 FT
	10FT	18.1 FT
MIN. SIDE YARD DEPTH:	10 FT	
MIN. REAR YARD DEPTH:	20FT	N/A
MIN. PARKING:	1/UNIT	1

42 NEW ENGLAND AVENUE ( BUILDING E)		
ZONING INFORMATION		
ZONING: 3F 6000 WARD 14		
1 Family ATTACHED	REQUIRED	ACTUAL
	6,000 SF FOR 2 UNITS + 2500 PER ADDT'L	2067
MIN. LOT SIZE:	UNIT	
MIN. LOT WIDTH:	40 FT	33.77
MIN. LOT FRONTAGE:	40 FT	33.77
MAX. F.A.R:	0.4	0.69
MAX. BLDG. HEIGHT:	2 ½ STORY 35	35 FT
MIN. OPEN SPACE:	750 SF PER UNIT	1568
MIN. FRONT YARD DEPTH:	15 FT/MOD.	11.9
MIN. SIDE YARD DEPTH:	10 FT	13.8
MIN. REAR YARD DEPTH:	20FT	22.1
MIN. PARKING:	1/UNIT	1

30 NEW ENGLAND AVENUE		
ZONING INFORMATION		
ZONING: 3F 6000 WARD 14		
1 Family ATTACHED	REQUIRED	ACTUAL
MIN LOT SIZE.	6,000 SF FOR 2 UNITS + 2500 PER ADDT'L	2686
MIN. LOT SIZE:	UNIT	FF C1
MIN. LOT WIDTH:	40 FT	55.61
MIN. LOT FRONTAGE:	40 FT	55.61
MAX. F.A.R:	0.4	0.58
MAX. BLDG. HEIGHT:	2 ½ STORY 35	35 FT
MIN. OPEN SPACE:	750 SF PER UNIT	1924
MIN. FRONT YARD DEPTH:	15 FT/MOD.	6.8
	10FT	10.9
MIN. SIDE YARD DEPTH:	10 FT	15.1
MIN. REAR YARD DEPTH:	20FT	14.3
MIN. PARKING:	1/UNIT	1

72 COLONIAL AVENUE		
ZONING INFORMATION		
ZONING: 3F 6000		
WARD 14		
1 Family ATTACHED	REQUIRED	ACTUAL
	6,000 SF FOR 2 UNITS	2067
	+ 2500 PER ADDT'L	
MIN. LOT SIZE:	UNIT	
MIN. LOT WIDTH:	40 FT	8.81
MIN. LOT FRONTAGE:	40 FT	8.81
MAX. F.A.R:	0.4	0.77
MAX. BLDG. HEIGHT:	2 ½ STORY 35	35 FT
MIN. OPEN SPACE:	750 SF PER UNIT	1495
MIN. FRONT YARD DEPTH:	15 FT/MOD.	25.5
	10FT	8.8
MIN. SIDE YARD DEPTH:	10 FT	
MIN. REAR YARD DEPTH:	20FT	19.9
MIN. PARKING:	1/UNIT	1

70 COLONIAL AVENUE		
ZONING INFORMATION		
ZONING: 3F 6000 WARD 14		
1 Family ATTACHED	REQUIRED	ACTUAL
MINI LOT SIZE.	6,000 SF FOR 2 UNITS + 2500 PER ADDT'L	2387
MIN. LOT SIZE:	UNIT	26.52
MIN. LOT WIDTH:	40 FT	
MIN. LOT FRONTAGE:	40 FT	26.52
MAX. F.A.R:	0.4	0.67
MAX. BLDG. HEIGHT:	2 ½ STORY 35	35 FT
MIN. OPEN SPACE:	750 SF PER UNIT	1747
MIN. FRONT YARD DEPTH:	15 FT/MOD.	25.5
	10FT	10
MIN. SIDE YARD DEPTH:	10 FT	
MIN. REAR YARD DEPTH:	20FT	27.6
MIN. PARKING:	1/UNIT	1

131 SOUTHERN AVENUE		
ZONING INFORMATION		
ZONING: 3F 6000 WARD 14		
1 Family ATTACHED	REQUIRED	ACTUAL
	6,000 SF FOR 2 UNITS + 2500 PER ADDT'L	
MIN. LOT SIZE:	UNIT	1715
MIN. LOT WIDTH:	40 FT	27.52
MIN. LOT FRONTAGE:	40 FT	27.52
MAX. F.A.R:	0.4	0.94
MAX. BLDG. HEIGHT:	2 ½ STORY 35	35FT
MIN. OPEN SPACE:	750 SF PER UNIT	1106
MIN. FRONT YARD DEPTH:	15 FT/MOD.	15.3
MIN. SIDE YARD DEPTH:	10FT	11
MIN. REAR YARD DEPTH:	20FT	10.1 FT
MIN. PARKING:	1/UNIT	1

133 SOUTHERN AVENUE		
ZONING INFORMATION		
ZONING: 3F 6000		
WARD 14		
1 Family ATTACHED	REQUIRED	ACTUAL
	6,000 SF FOR 2 UNITS	3303
	+ 2500 PER ADDT'L	
MIN. LOT SIZE:	UNIT	
MIN. LOT WIDTH:	40 FT	57.17
MIN. LOT FRONTAGE:	40 FT	57.17
MAX. F.A.R:	0.4	0.47
MAX. BLDG. HEIGHT:	2 ½ STORY 35	35 FT
MIN. OPEN SPACE:	750 SF PER UNIT	2591
MIN. FRONT YARD DEPTH:	15 FT/MOD.	15.3
	10FT	11.8
MIN. SIDE YARD DEPTH:	10 FT	8
MIN. REAR YARD DEPTH:	20FT	11.8
MIN. PARKING:	1/UNIT	1

131 SOUTHERN AVENUE		
ZONING INFORMATION		
ZONING: 3F 6000 WARD 14		
1 Family ATTACHED	REQUIRED	ACTUAL
	6,000 SF FOR 2 UNITS + 2500 PER ADDT'L	
MIN. LOT SIZE:	UNIT	1749
MIN. LOT WIDTH:	40 FT	33.05
MIN. LOT FRONTAGE:	40 FT	33.05
MAX. F.A.R:	0.4	0.91
MAX. BLDG. HEIGHT:	2 ½ STORY 35	35FT
MIN. OPEN SPACE:	750 SF PER UNIT	1026
MIN. FRONT YARD DEPTH:	15 FT/MOD.	13
MIN. SIDE YARD DEPTH:	10FT	10.1
MIN. REAR YARD DEPTH:	20FT	9.1
MIN. PARKING:	1/UNIT	1

68 COLONIAL AVENUE		
ZONING INFORMATION		
ZONING: 3F 6000 WARD 14		
1 Family ATTACHED	REQUIRED	ACTUAL
	6,000 SF FOR 2 UNITS + 2500 PER ADDT'L	3555
MIN. LOT SIZE:	UNIT	
MIN. LOT WIDTH:	40 FT	39.5
MIN. LOT FRONTAGE:	40 FT	39.5
MAX. F.A.R:	0.4	0.44
MAX. BLDG. HEIGHT:	2 ½ STORY 35	35 FT
MIN. OPEN SPACE:	750 SF PER UNIT	2793
MIN. FRONT YARD DEPTH:	15 FT/MOD.	15
	10FT	3
MIN. SIDE YARD DEPTH:	10 FT	12
MIN. REAR YARD DEPTH:	20FT	42.6
MIN. PARKING:	1/UNIT	1

36 MALLARD AVENUE		
ZONING INFORMATION		
ZONING: 3F 6000 WARD 14		
1 Family ATTACHED	REQUIRED	ACTUAL
MIN. LOT SIZE:	6,000 SF FOR 2 UNITS + 2500 PER ADDT'L UNIT	3555
MIN. LOT WIDTH:	40 FT	40
MIN. LOT FRONTAGE:	40 FT	40
MAX. F.A.R:	0.4	0.49
MAX. BLDG. HEIGHT:	2 ½ STORY 35	35 FT
MIN. OPEN SPACE:	750 SF PER UNIT	4498
MIN. FRONT YARD DEPTH:	15 FT/MOD.	17.5
	10FT	13.5
MIN. SIDE YARD DEPTH:	10 FT	11.5
MIN. REAR YARD DEPTH:	20FT	27
MIN. PARKING:	1/UNIT	1


34 MALLARD AVENUE		
ZONING INFORMATION		
ZONING: 3F 6000 WARD 14		
1 Family ATTACHED	REQUIRED	ACTUAL
	6,000 SF FOR 2 UNITS + 2500 PER ADDT'L	2390
MIN. LOT SIZE:	UNIT	
MIN. LOT WIDTH:	40 FT	26.55
MIN. LOT FRONTAGE:	40 FT	26.55
MAX. F.A.R:	0.4	0.67
MAX. BLDG. HEIGHT:	2 ½ STORY 35	35 FT
MIN. OPEN SPACE:	750 SF PER UNIT	1769
MIN. FRONT YARD DEPTH:	15 FT/MOD.	16.8
	10FT	10
MIN. SIDE YARD DEPTH:	10 FT	
MIN. REAR YARD DEPTH:	20FT	36.3
MIN. PARKING:	1/UNIT	1

32 MALLARD AVENUE		
ZONING INFORMATION		
ZONING: 3F 6000 WARD 14		
1 Family ATTACHED	REQUIRED	ACTUAL
	6,000 SF FOR 2 UNITS + 2500 PER ADDT'L	
MIN. LOT SIZE:	UNIT	2429
MIN. LOT WIDTH:	40 FT	26.99
MIN. LOT FRONTAGE:	40 FT	26.99
MAX. F.A.R:	0.4	0.66
MAX. BLDG. HEIGHT:	2 ½ STORY 35	35FT
MIN. OPEN SPACE:	750 SF PER UNIT	1820
MIN. FRONT YARD DEPTH:	15 FT/MOD.	16.8
MIN. SIDE YARD DEPTH:	10FT	10.5
MIN. REAR YARD DEPTH:	20FT	36.3
MIN. PARKING:	1/UNIT	1

30 MALLARD AVENUE		
ZONING INFORMATION		
ZONING: 3F 6000 WARD 14		
1 Family ATTACHED	REQUIRED	ACTUAL
	6,000 SF FOR 2 UNITS + 2500 PER ADDT'L	2390
MIN. LOT SIZE:	UNIT	
MIN. LOT WIDTH:	40 FT	26.55
MIN. LOT FRONTAGE:	40 FT	26.55
MAX. F.A.R:	0.4	0.67
MAX. BLDG. HEIGHT:	2 ½ STORY 35	35 FT
MIN. OPEN SPACE:	750 SF PER UNIT	1769
MIN. FRONT YARD DEPTH:	15 FT/MOD.	16.8
	10FT	10
MIN. SIDE YARD DEPTH:	10 FT	
MIN. REAR YARD DEPTH:	20FT	36.3
MIN. PARKING:	1/UNIT	1

28 MALLARD AVENUE		
ZONING INFORMATION		
ZONING: 3F 6000		
WARD 14		
1 Family ATTACHED	REQUIRED	ACTUAL
	6,000 SF FOR 2 UNITS	2390
	+ 2500 PER ADDT'L	
MIN. LOT SIZE:	UNIT	
MIN. LOT WIDTH:	40 FT	26.55
MIN. LOT FRONTAGE:	40 FT	26.55
MAX. F.A.R:	0.4	0.67
MAX. BLDG. HEIGHT:	2 ½ STORY 35	35 FT
MIN. OPEN SPACE:	750 SF PER UNIT	1769
MIN. FRONT YARD DEPTH:	15 FT/MOD.	16.8
	10FT	10
MIN. SIDE YARD DEPTH:	10 FT	
MIN. REAR YARD DEPTH:	20FT	36.3
MIN. PARKING:	1/UNIT	1

Appendix A: Architectural Drawings

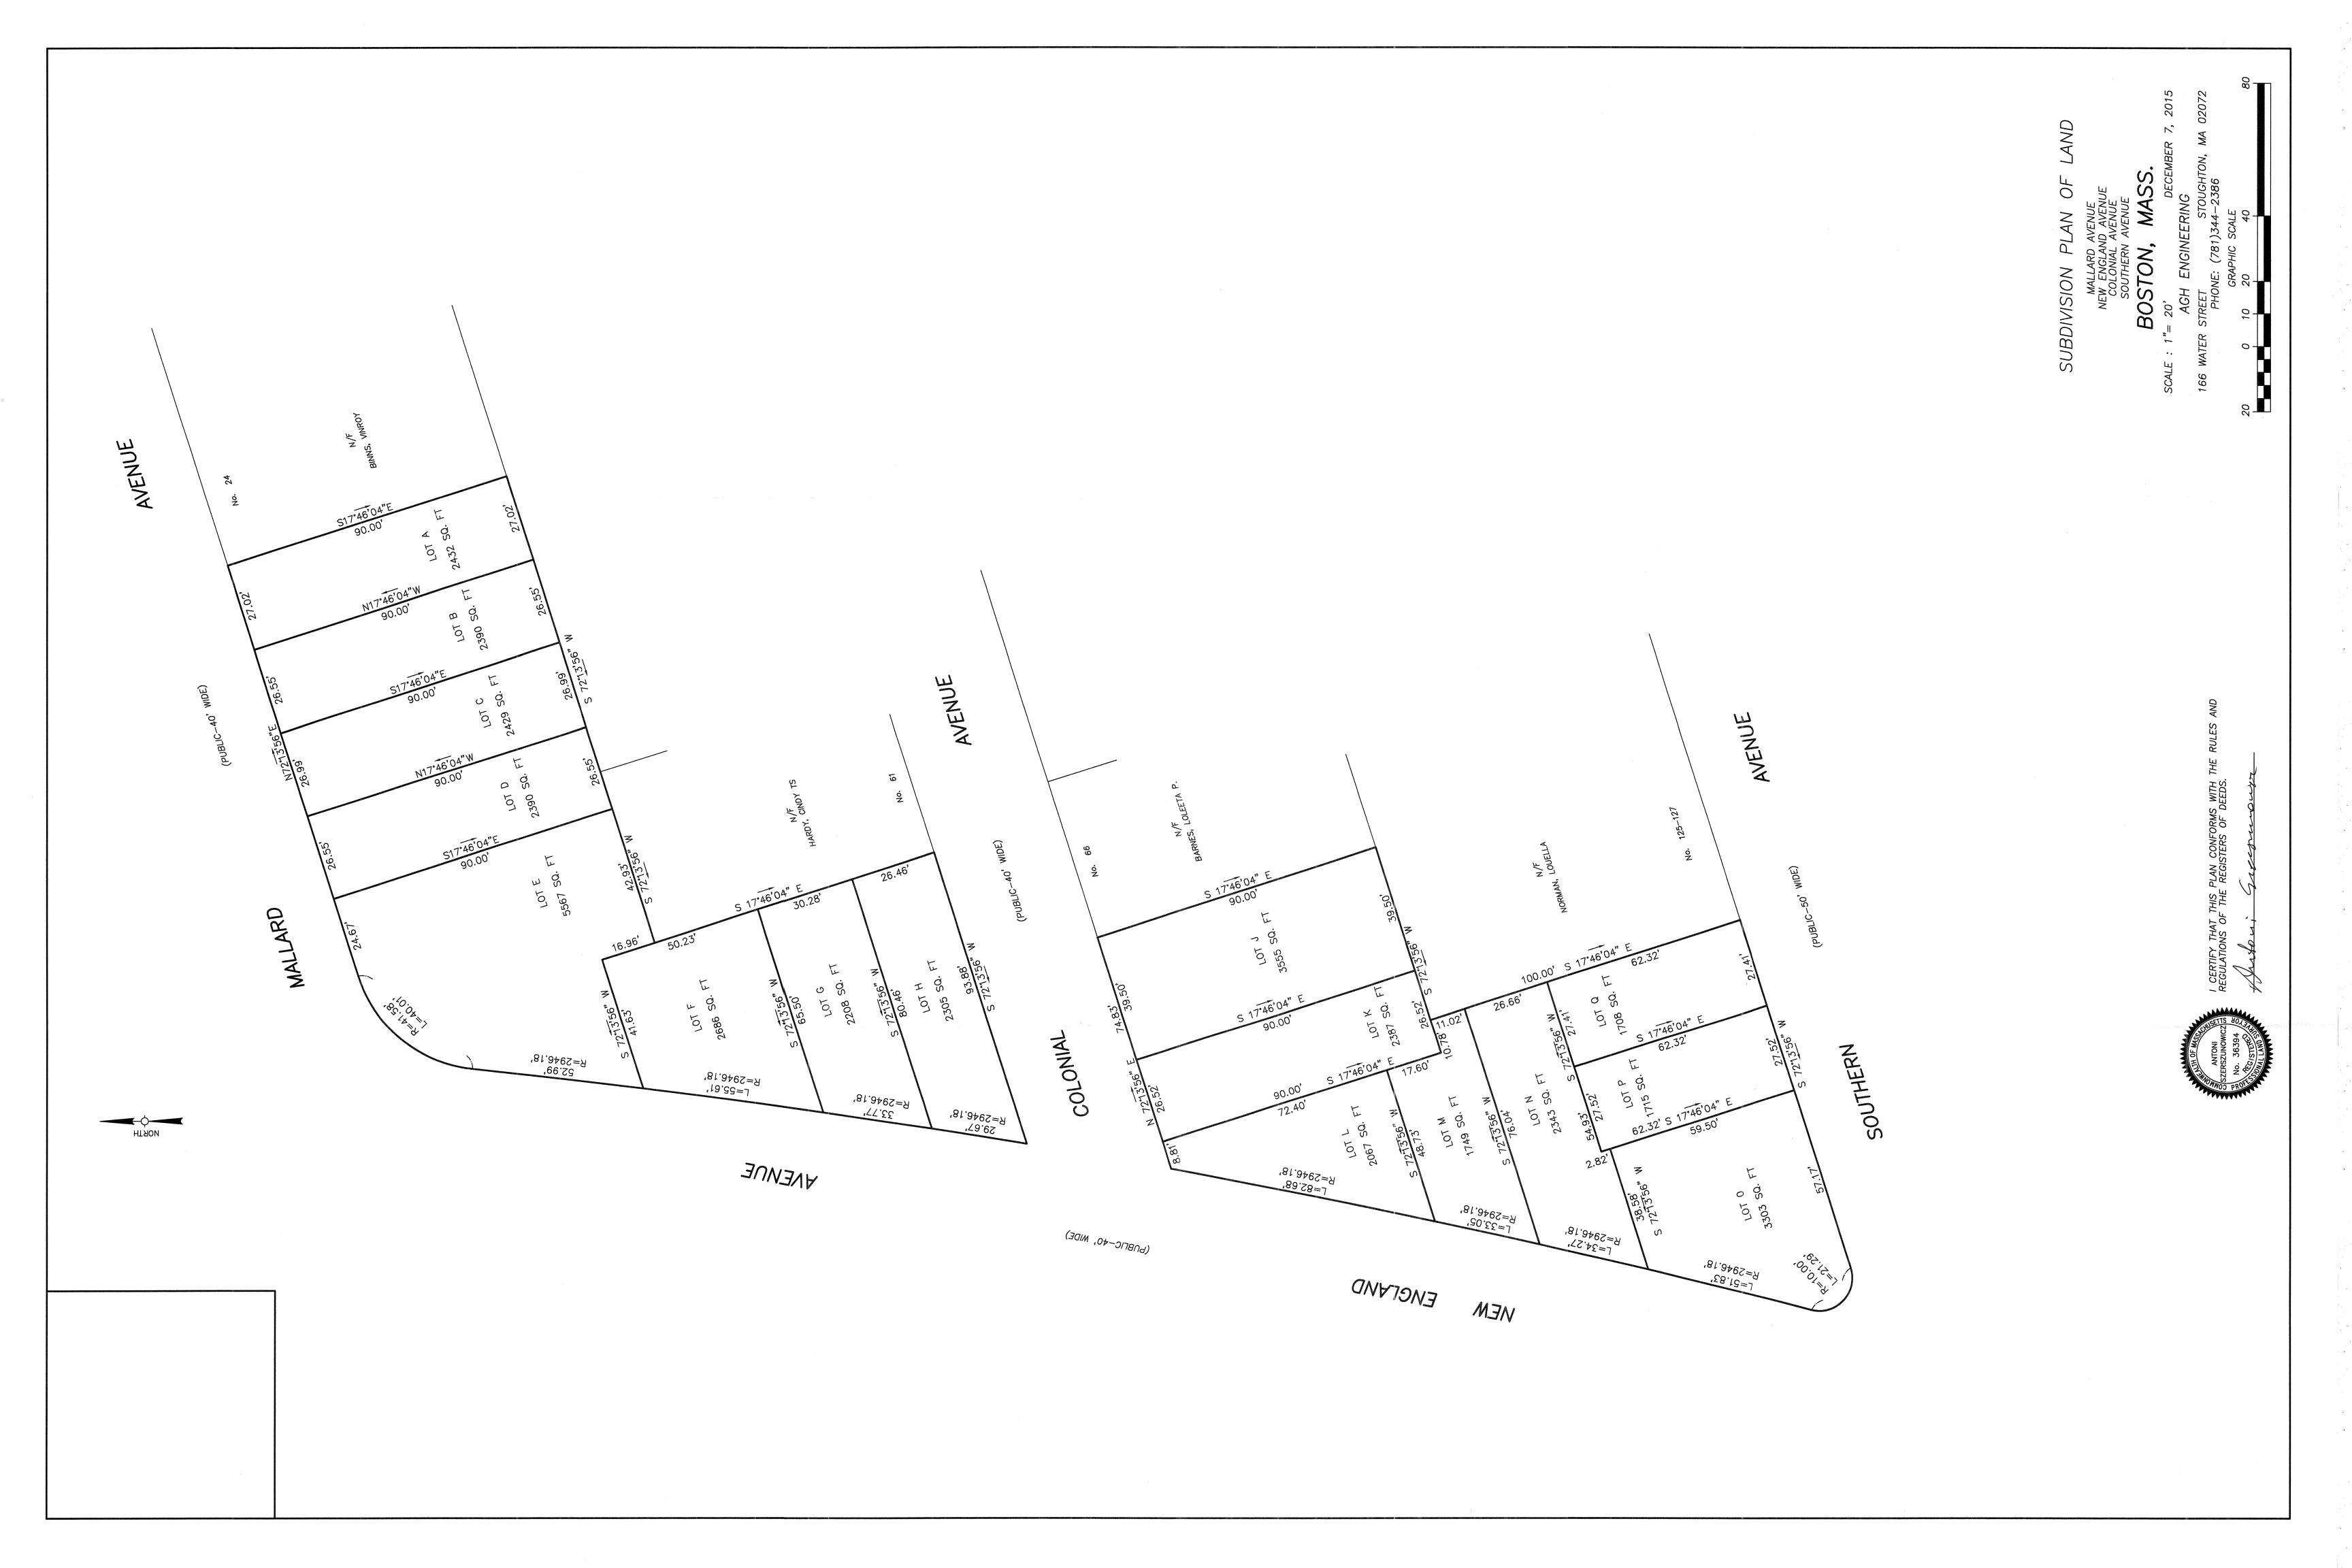





## 133 SOUTHERN AVENUE ( BUILDING A)

## "NEW ENGLAND HERITAGE HOMES" AFFORDABLE HOMEOWNERSHIP DEVELOPMENT

PREPARED FOR:

## CODMAN SQUARE NEIGHBORHOOD DEVELOPMENT CORPORATION


587 WASHINGTON STREET DORCHESTER, MA 02124

PREPARED BY:

MICHEAL WASHINGTON ARCHITECTS, INC.

891 CENTRE ST. JAMAICA PLAIN, MA 02130 TEL: (617) 390-5515

EMAIL: mwainc1@hotmail.com

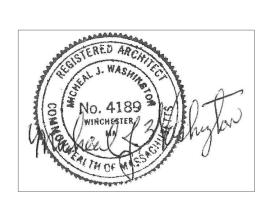

I. ALL DRAWINGS WILL BE UPDATED AND MODIFIED 2. ALL GENERAL DRAWINGS TO BE UPDATED INCLUDING REMOVAL OF HUNTER PANELS AND DOWNGRADING R VALUES TO CURRENT CODE. 3. WINDOW REQUIREMENTS TO BE DETERMINED LATER.

NOTES:

I. ALL WORK AND PERMITS AND APPROVALS WILL BE OBTAINED BY THE TRADE AND COORDINATED BY THE GENERAL CONTRACTOR AND THE OWNER. ALL WORK SHALL COMPLY WITH ALL PROVISIONS OF THE MASSACHUSETTS STATE BUILDING CODE, CURRENT EDITION, AND LOCAL CITY AND TOWN PROVISIONS.

2. ALL CONSTRUCTION IS TO COMPLY WITH THE MASSACHUSETTS STATE BUILDING CODE, EIGHTH EDITION AND WITH ALL SUPPLEMENTS, AMENDMENTS, AND OTHER APPLICABLE CODES AND REGULATIONS.

3. ALL ROOF INSULATION SHALL BE R-49; ALL WALLS SHALL BE R-21 AND IN COMPLIANCE WITH THE IECC REQUIREMENTS.ALLFIRST FLOOR AREAS R-30, IN COMPLIANCE WITH IBC REQUIREMENTS.

4. CONTRACTOR IS TO VERIFY ALL DIMENSION IN THE FIELD, NOTIFY ARCHITECT IF THERE ARE ANY VARIATIONS.

### 133 SOUTHERN AVENUE ( BUILDING A)

DRAWING NAME

WALL SECTIONS WALL SECTIONS

KICTHEN PLANS & ELEVATIONS BATH PLANS & ELEVATIONS

WINDOWS & DOORS SCHEDULE

GENERAL TYPICAL DETAILS GENERAL TYPICAL DETAILS

FINISH SCHEDULE & PARTITION TYPES

GENERAL DRAWINGS

#### LIST OF DRAWINGS

ARCHITECTURAL INDEX OF DRAWINGS ARCHITECTURAL INDEX OF DRAWINGS DRAWING NAME

BASEMENT & FIRST FLOOR PLAN

EXTERIOR ELEVATIONS EXTERIOR ELEVATIONS

FOUNDATION & FIRST FRAMING PLAN SECOND & ATTIC FRAMING PLAN

ROOF FRAMING PLAN

#### 133 SOUTHERN AVENUE

ZONING INFORMATION		
ZONING: 3F-6000 WARD 14 SINGLE FAMILY	REQUIRED	ACTUAL
LOT SIZE:	6000 SF FOR 2 UNITS + 2500 PER ADDT'L UNIT	3,303 SF
LOT WIDTH:	40 FT	57.17' FT
LOT FRONTAGE:	40 FT	57.17' FT
F.A.R:	0.4	0.47
BLDG. HEIGHT:	2 1/2 STORY 35	35 FT
OPEN SPACE:	750 SF PER UNIT	2,591 SQ. FT.
FRONT YARD DEPTH:	15FT/MOD.	15.3 FT
SIDE YARD DEPTH:	10 FT 10 FT	11.8 FT 8 FT
REAR YARD DEPTH:	20 FT	11.8 FT
PARKING:	1/UNIT	1



MICHEAL WASHINGTON ARCHITECT, INC. DATE: 12/06/15

30 NEW ENGLAND AVENUE (BUILDING A)

## "NEW ENGLAND HERITAGE HOMES" AFFORDABLE HOMEOWNERSHIP DEVELOPMENT

PREPARED FOR:

## CODMAN SQUARE NEIGHBORHOOD DEVELOPMENT CORPORATION


587 WASHINGTON STREET DORCHESTER, MA 02124

PREPARED BY:

MICHEAL WASHINGTON ARCHITECTS, INC.

891 CENTRE ST. JAMAICA PLAIN, MA 02130 TEL: (617) 390-5515

EMAIL: mwainc1@hotmail.com

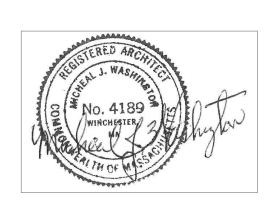

I. ALL DRAWINGS WILL BE UPDATED AND MODIFIED 2. ALL GENERAL DRAWINGS TO BE UPDATED INCLUDING REMOVAL OF HUNTER PANELS AND DOWNGRADING R VALUES TO CURRENT CODE. 3. WINDOW REQUIREMENTS TO BE DETERMINED LATER.

NOTES:

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4. CONTRACTOR IS TO VERIFY ALL DIMENSION IN THE FIELD, NOTIFY ARCHITECT IF THERE ARE ANY VARIATIONS.

### 30 NEW ENGLAND AVENUE (BUILDING A)

#### LIST OF DRAWINGS


ARCHITECTURAL INDEX OF DRAWINGS ARCHITECTURAL INDEX OF DRAWINGS DRAWING NAME DRAWING NAME KICTHEN PLANS & ELEVATIONS TITLE SHEET BATH PLANS & ELEVATIONS MINDOMS & DOORS SCHEDULE EXISTING CONDITIONS FINISH SCHEDULE & PARTITION TYPES WALL SECTIONS WALL SECTIONS BASEMENT & FIRST FLOOR PLAN GENERAL TYPICAL DETAILS SECOND & ROOF FLOOR PLANS GENERAL TYPICAL DETAILS EXTERIOR ELEVATIONS EXTERIOR ELEVATIONS

FOUNDATION & FIRST FRAMING PLAN SECOND & ATTIC FRAMING PLAN ROOF FRAMING PLAN

FIRST & SECOND FLOOR PLAN

#### 30 NEW ENGLAND AVENUE

ZONING INFORMATION		
ZONING: 3F-6000 WARD 14 SINGLE FAMILY	REQUIRED	ACTUAL
LOT SIZE:	6000 SF FOR 2 UNITS + 2500 PER ADDT'L UNIT	2,686 SF
LOT WIDTH:	40 FT	55.61' FT
LOT FRONTAGE:	40 FT	55.61' FT
F.A.R:	0.4	0.58
BLDG. HEIGHT:	2 1/2 STORY 35	35 FT
OPEN SPACE:	750 SF PER UNIT	1,924 SQ. FT.
FRONT YARD DEPTH:	15FT/MOD.	6.8 FT
SIDE YARD DEPTH:	10 FT	10.9 FT 15.1 FT
	10 FT	15.1 11
REAR YARD DEPTH:	20 FT	14.3 FT
PARKING:	1/UNIT	1

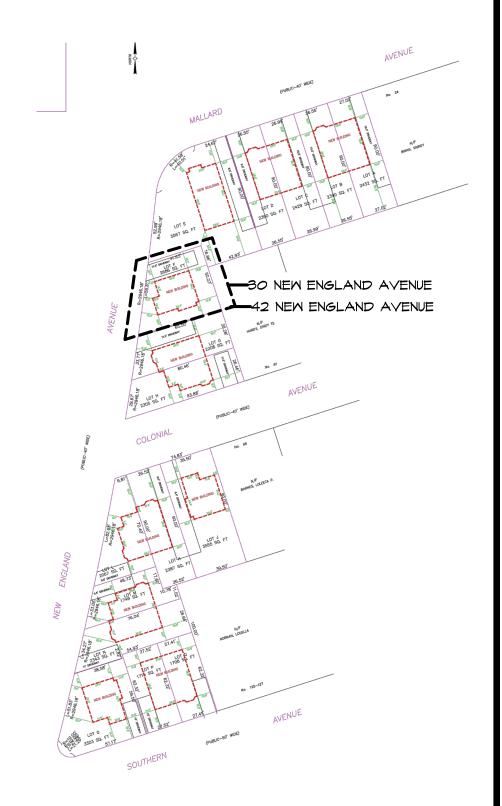

MICHEAL WASHINGTON ARCHITECT. INC. DATE: 12/06/15

68 COLONIAL AVENUE (BUILDING A)

# "NEW ENGLAND HERITAGE HOMES" AFFORDABLE HOMEOWNERSHIP DEVELOPMENT

PREPARED FOR:

## CODMAN SQUARE NEIGHBORHOOD DEVELOPMENT CORPORATION

587 WASHINGTON STREET DORCHESTER, MA 02124

PREPARED BY:


MICHEAL WASHINGTON ARCHITECTS, INC.

891 CENTRE ST.

JAMAICA PLAIN, MA 02130

TEL: (617) 390-5515

EMAIL: mwainc1@hotmail.com

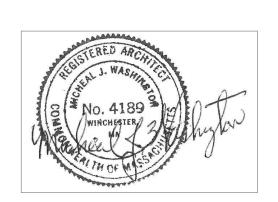

I. ALL DRAWINGS WILL BE UPDATED AND MODIFIED

2. ALL GENERAL DRAWINGS TO BE UPDATED
INCLUDING REMOVAL OF HUNTER PANELS AND
DOWNGRADING R VALUES TO CURRENT CODE.

3. WINDOW REQUIREMENTS TO BE DETERMINED LATER.

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3. ALL ROOF INSULATION SHALL BE R-49; ALL WALLS SHALL BE R-21 AND IN COMPLIANCE WITH THE IECC REQUIREMENTS.ALLFIRST FLOOR AREAS R-30, IN COMPLIANCE WITH IBC REQUIREMENTS.

4. CONTRACTOR IS TO VERIFY ALL DIMENSION IN THE FIELD, NOTIFY ARCHITECT IF THERE ARE ANY VARIATIONS.

## 68 COLONIAL AVENUE (BUILDING A)

#### LIST OF DRAWINGS

ARCHITECTURAL INDEX OF DRAWINGS ARCHITECTURAL INDEX OF DRAWINGS DRAWING NAME DRAWING NAME KICTHEN PLANS & ELEVATIONS TITLE SHEET BATH PLANS & ELEVATIONS WINDOWS & DOORS SCHEDULE FINISH SCHEDULE & PARTITION TYPES WALL SECTIONS MALL SECTIONS BASEMENT & FIRST FLOOR PLAN GENERAL TYPICAL DETAILS GENERAL TYPICAL DETAILS EXTERIOR ELEVATIONS EXTERIOR ELEVATIONS


ELECTRICAL A UNIT
E-I.O BASEMENT
E-I.I FIRST & SECOND FLOOR PLAN

#### 68 COLONIAL AVENUE


ZONING INFORMATION		
ZONING: 3F-6000 WARD 14	REQUIRED	ACTUAL
LOT SIZE:	6000 SF FOR 2 UNITS + 2500 PER ADDT'L UNIT	3,555 SF
LOT WIDTH:	40 FT	39.50' FT
LOT FRONTAGE:	40 FT	39.50' FT
F.A.R:	0.4	0.44
BLDG. HEIGHT:	2 1/2 STORY 35	35 FT
OPEN SPACE:	750 SF PER UNIT	2,793 SQ. FT.
FRONT YARD DEPTH:	15FT/MOD.	15.0 FT
SIDE YARD DEPTH:	10 FT	3.0 FT
	10 FT	12.0 FT
REAR YARD DEPTH:	20 FT	42.6 FT
PARKING:	1/UNIT	1

FOUNDATION & FIRST FRAMING PLAN SECOND & ATTIC FRAMING PLAN

ROOF FRAMING PLAN

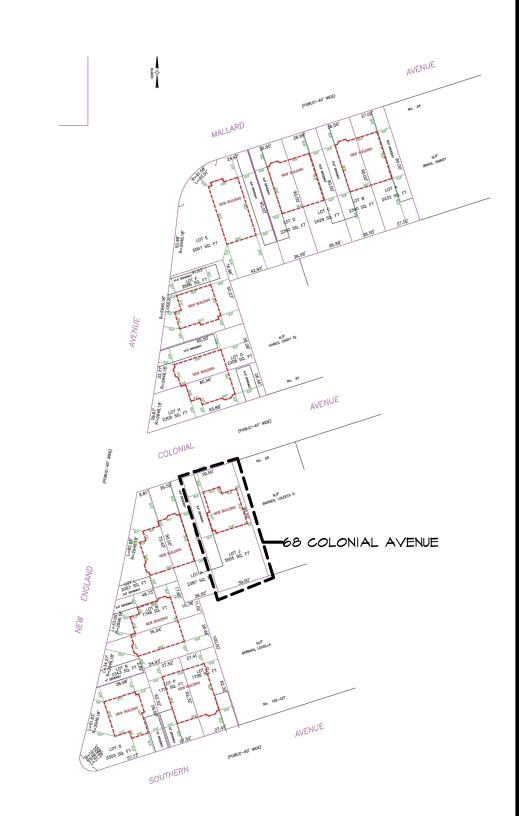

MICHEAL WASHINGTON ARCHITECT, INC. DATE: 12/06/15

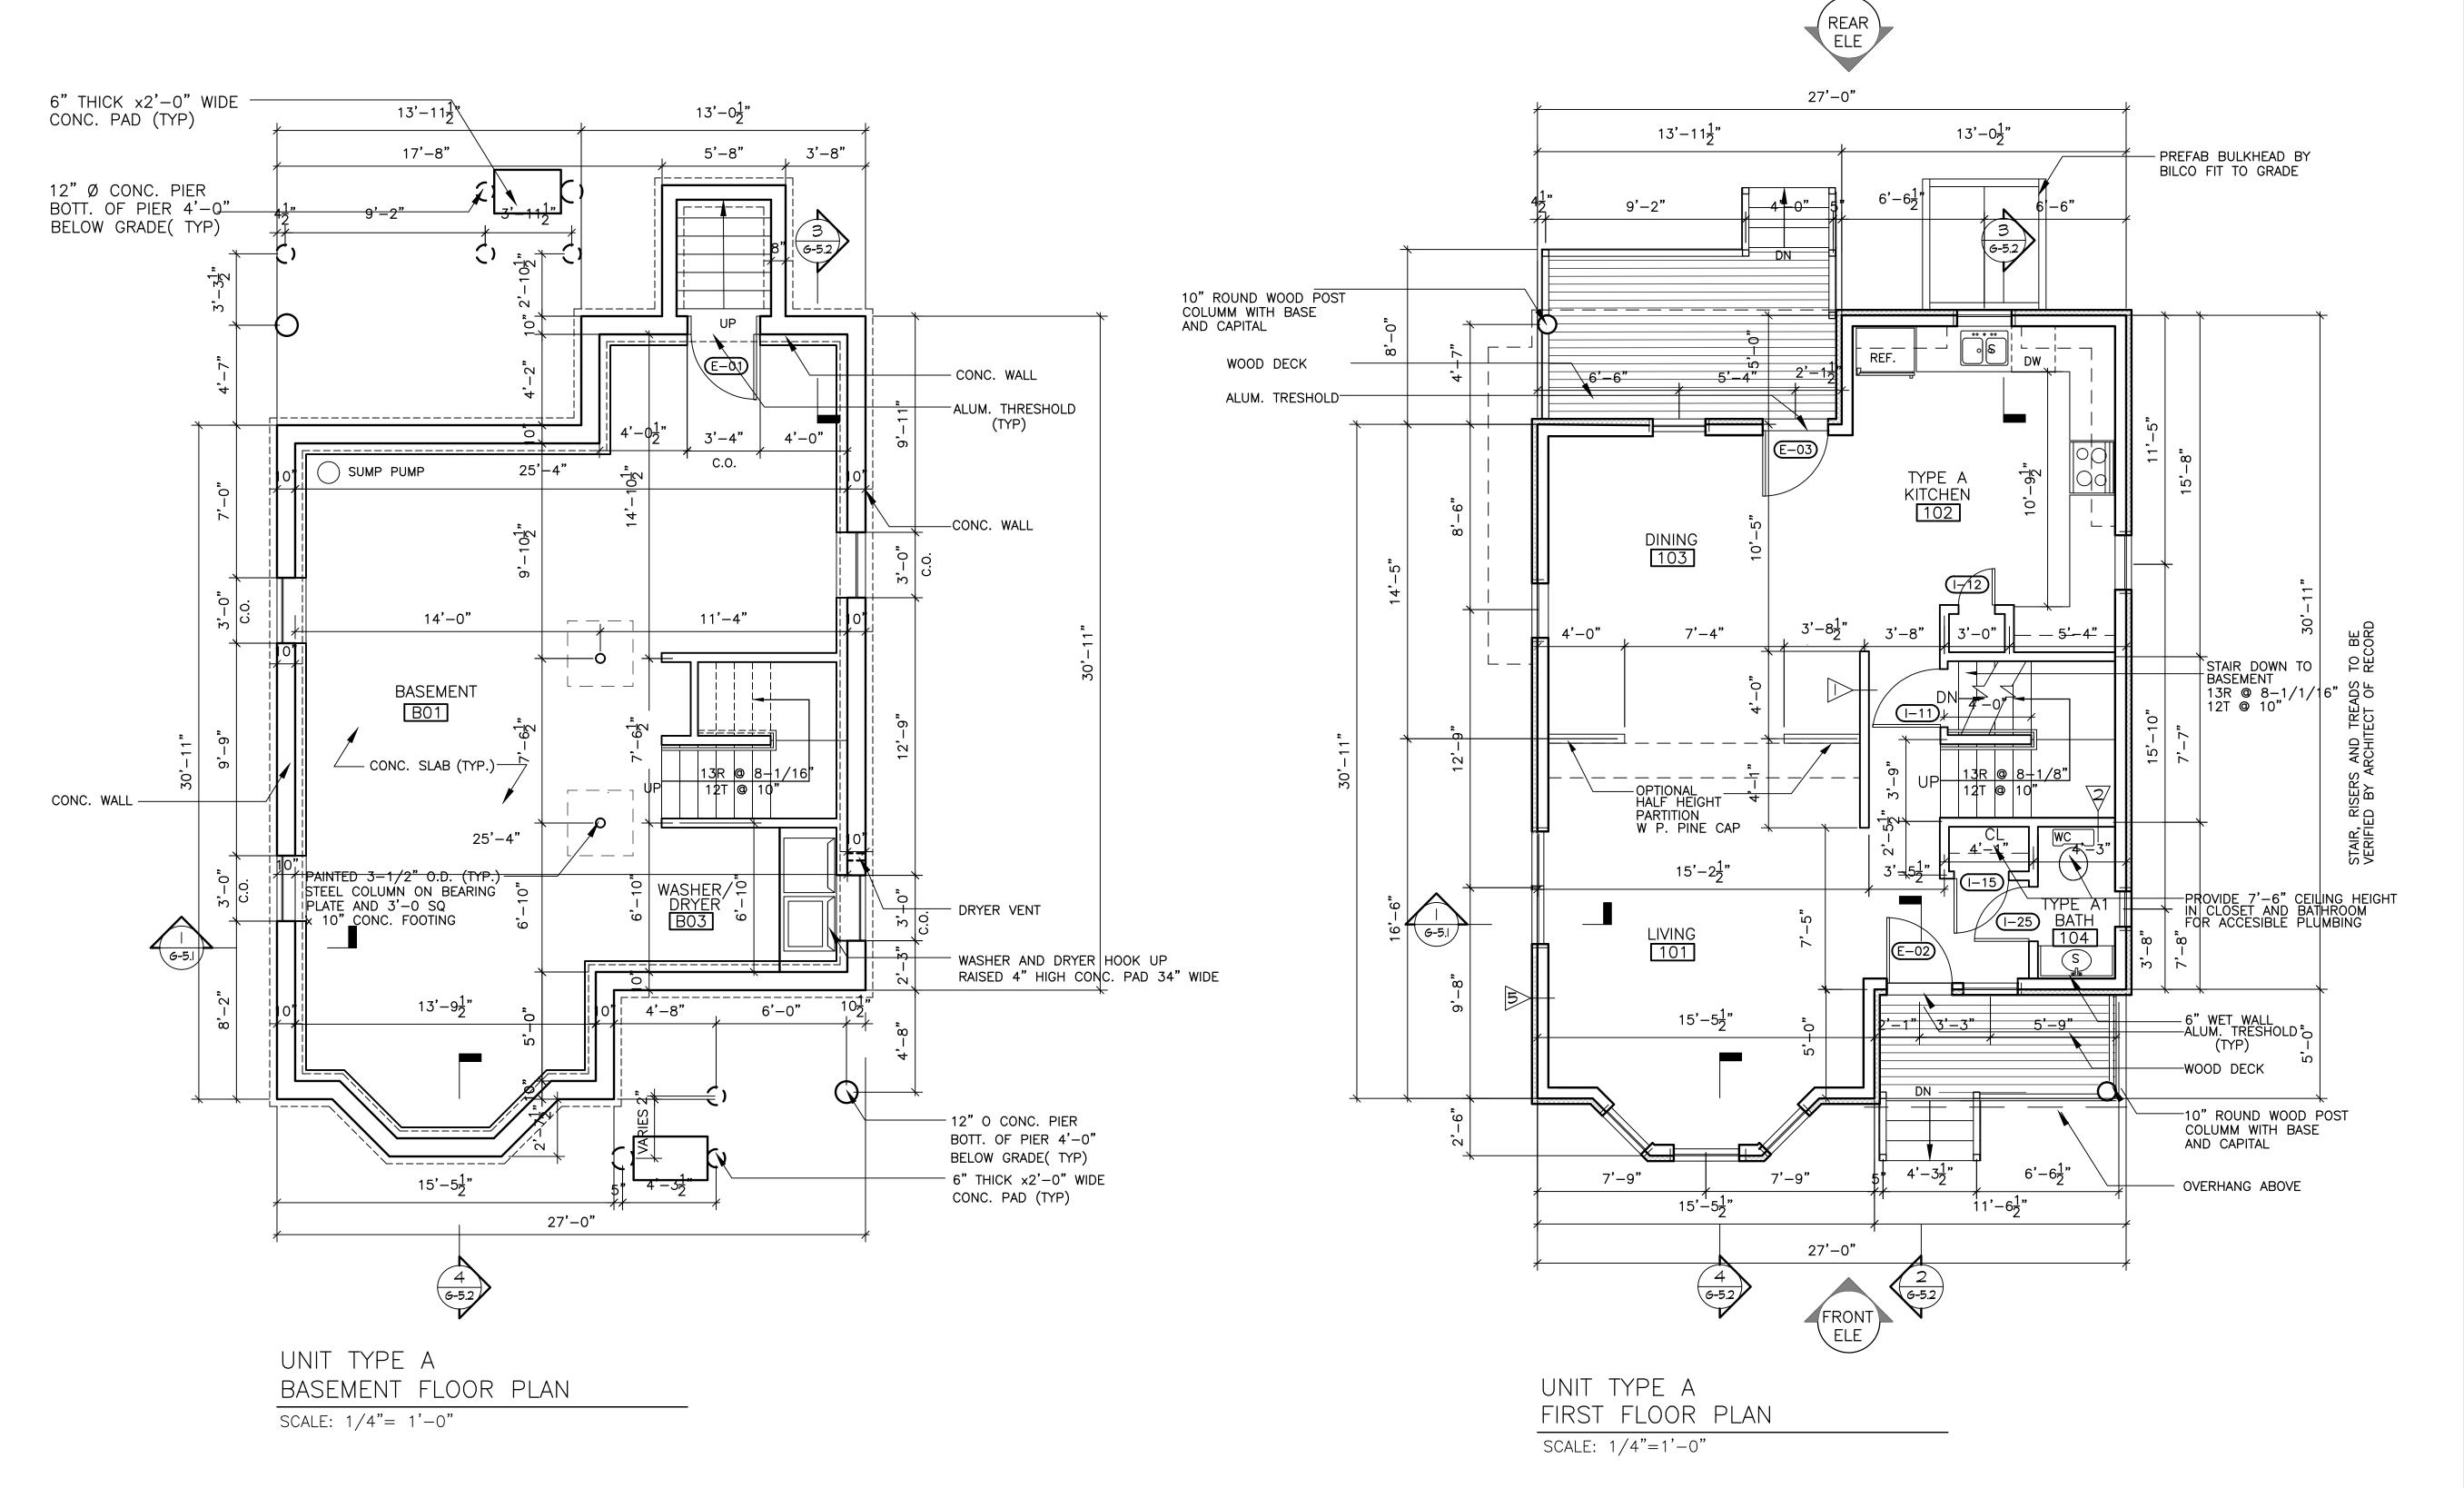

# Micheal Washington Architects Inc.

891 Centre Street Jamaica Plain, MA 02130

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PROJECT

### NEW ENGLAND HERITAGE HOMES

DORCHESTER, MASSACHUSETTS

DEVELOPE

# CODMAN SQUARE NEIGHBORHOOD DEVELOPMENT CORPORATION

DORCHESTER, MASSACHUSETTS


NOTES

I. SEE 6-4 FOR PARTITION TYPES.

> 2. SEE GA-I FOR ENLARGED KITCHEN PLANS AND ELEVATIONS.

3. DIMENSIONS ARE TO EXTERIOR FACE OF EXTERIOR STUD WALL AND EXTERIOR FACE OF FOUNDATION WALL.

4. DIMENSIONS ARE TO CENTERLINE OF STUDS ON INTERIOR WALLS UNLESS OTHERWISE NOTED.

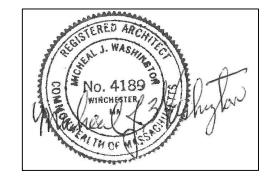

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SHEET TITLE

TYPE A- SINGLE FAMILY
BASEMENT & FIRST
FIRST PLANS


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DATE: 12/01/201

FILE: NEHH.dwg


**A-A.1** 

DRAWING NO.

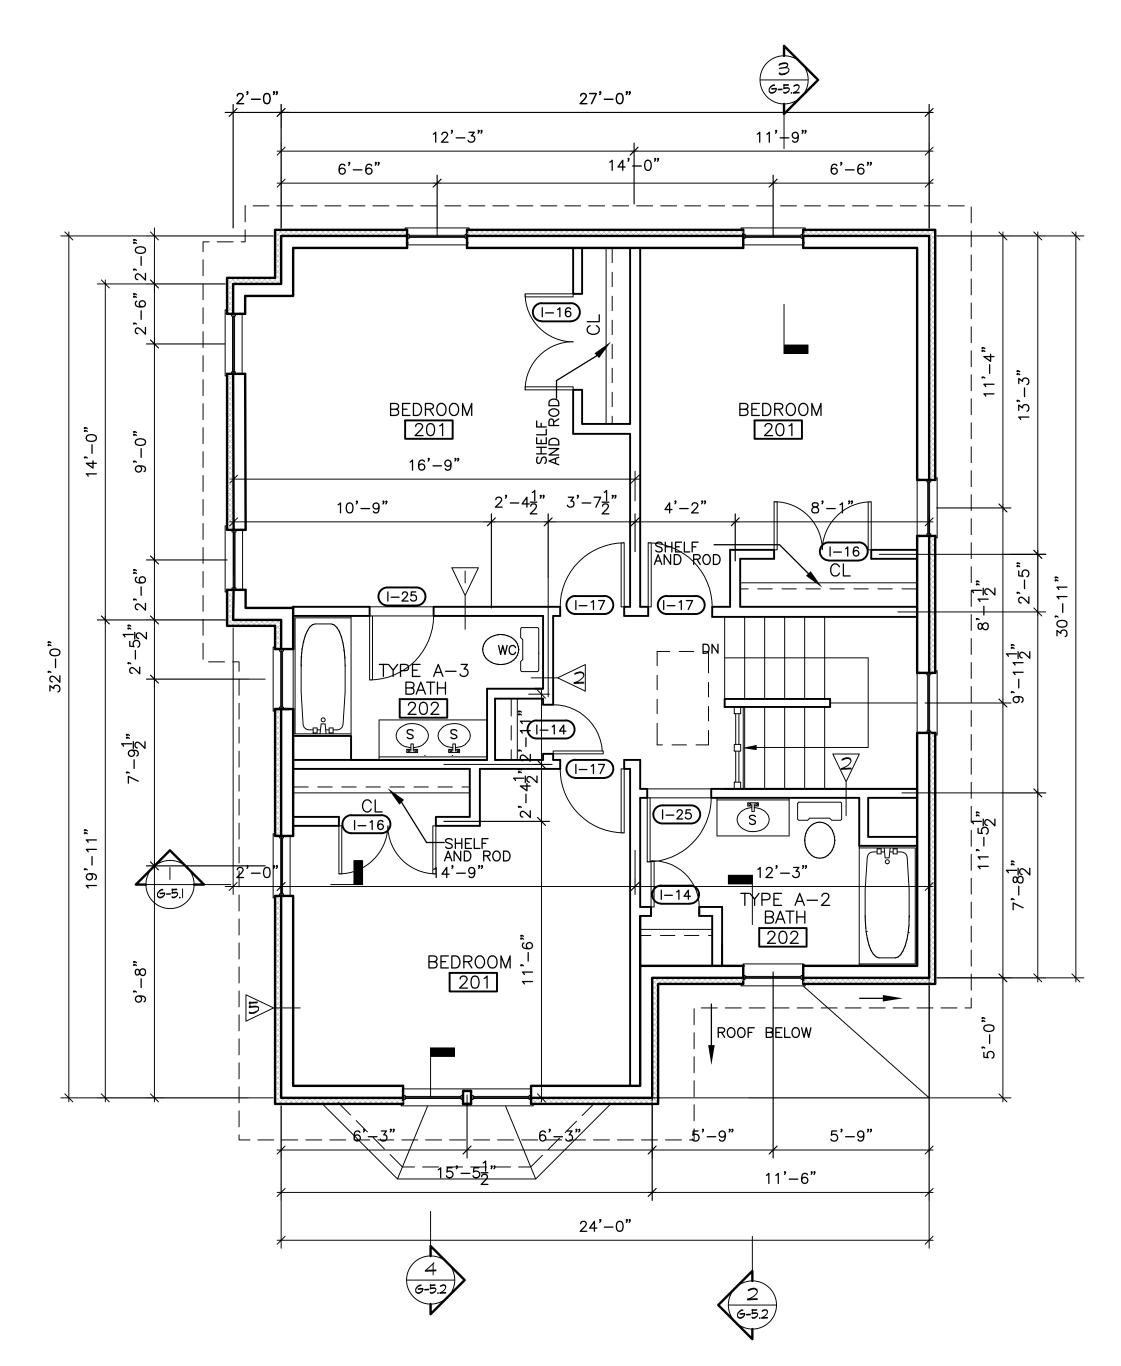

SECOND FLOOR PLAN

SCALE: 1/4"=1'-0"

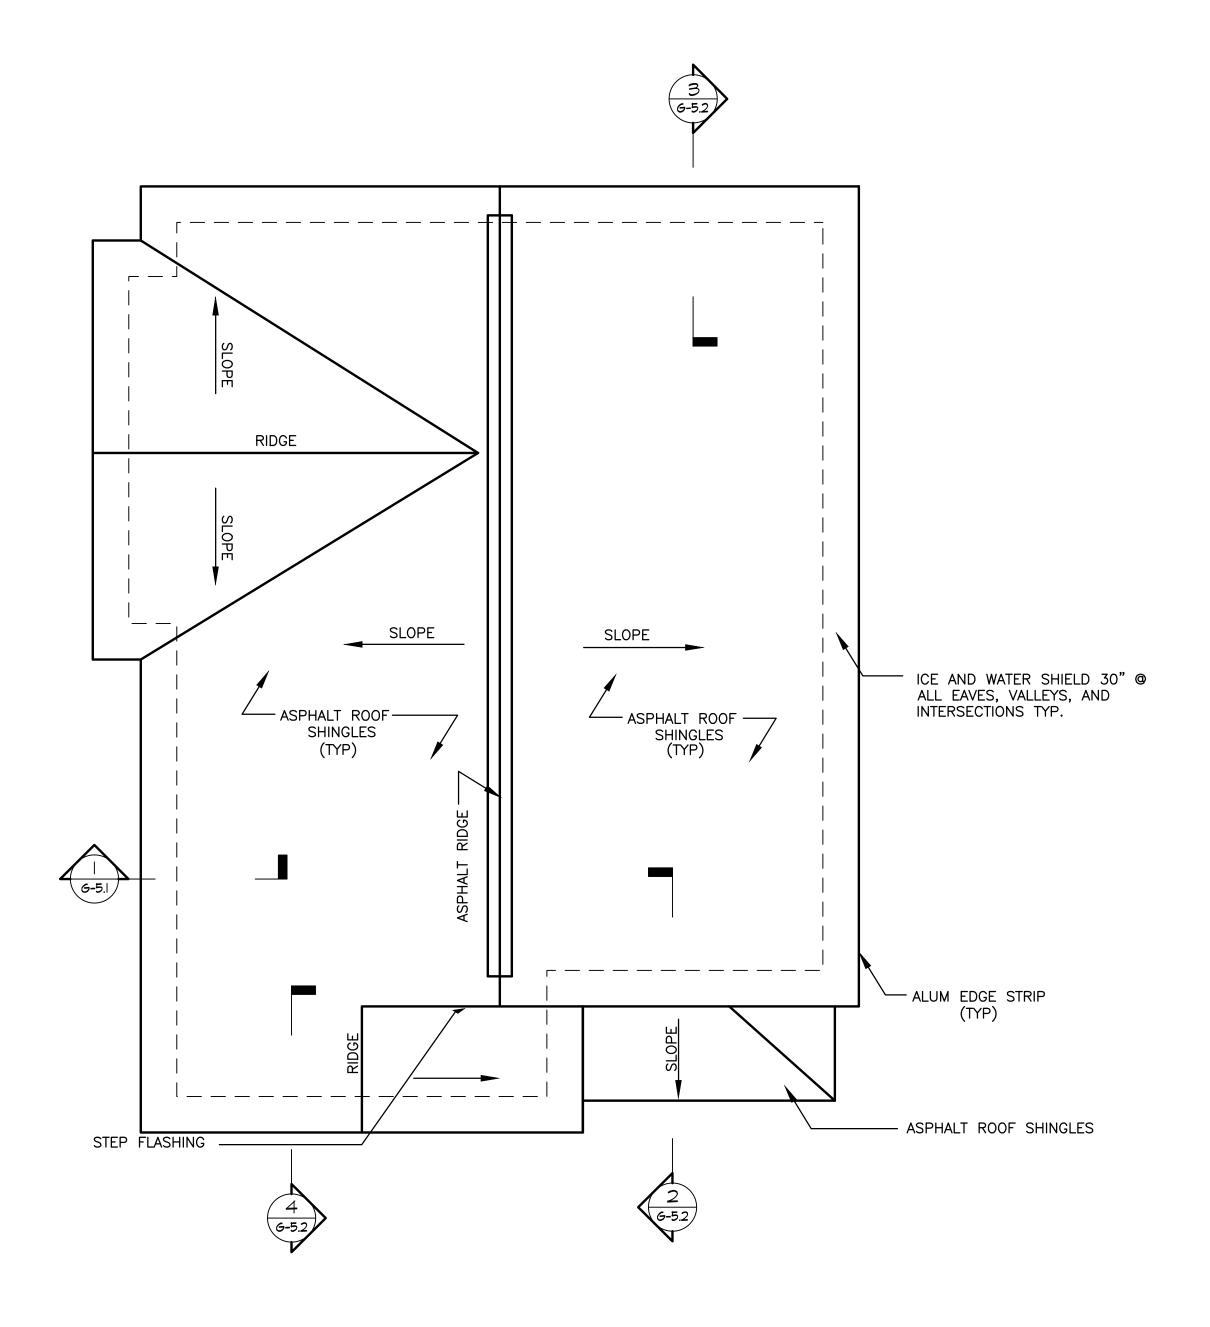

UNIT TYPE A
ROOF PLAN

SCALE: 1/4"=1'-0"

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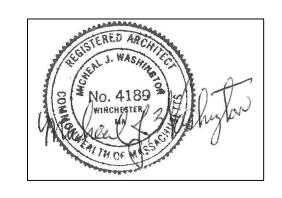
#### NEW ENGLAND HERITAGE HOMES

DORCHESTER, MASSACHUSETTS

DEVELOPE

## CODMAN SQUARE NEIGHBORHOOD DEVELOPMENT CORPORATION

DORCHESTER, MASSACHUSETTS



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SHEET TITLE

TYPE A- SINGLE FAMILY 2ND FLOOR & ROOF PLANS

SEE SITE ON COVER PAGE FOR ADDRESS AND UNIT LOCATION

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**A-A.2** 

#### NOTES:

1. N/A

#### 2. CAULKING

A. CAULK AND SEAL ALL JOINTS IN EXTERIOR CONSTRUCTION.

B. CAULK AND SEAL ALL JOINTS
BETWEEN PERIMETER OF EXTERIOR
DOOR FRAMES, WINDOWS FRAMES,
VENTS, LOUVERS, AND OTHER ITEMS
OCCURRING IN OPENINGS IN EXTERIOR
WALLS, AND THE SURROUNDING
CONSTRUCTION.

C. CAULK AND SEAL ALL INTERIOR PERIMETER JOINTS AT DOORS FRAMES, WINDOWS FRAMES, VENTS, LOUVERS, AND OTHER WALL OPENINGS.

D. PROVIDE ALL OTHER EXT. AND INT. SEALING CALLED FOR, OR REASONABLY INFERRED FROM DRAWINGS, AND AS REQUIRED TO PROVIDE WEATHERTIGHT CONDITIONS IN EXTERIOR ASSEMBLIES.

E. COMPLY WITH ALL REQUIREMENTS BY ALL MANUFACTURES/AND PRODUCTS AND GOOD ENGINEERING PRACTICE.


#### 3. SEE GA-6 FOR TYPICAL DETAILS.

4. COORDINATE EXTERIOR FINISH WORK WITH PLUMBING, HVAC AND ELECTRICAL PENETRATIONS.

5. ALL WALL CAPS TO BE ANODIZED ALUMINUM COLOR TO MATCH EXTERIOR.

6. EXPOSED METAL FLASHING COLOR TO MATCH ADJACENT SERVICES.

7. COORDINATE NUMBER OF EXT. STAIR TREADS AND RISERS TO MATCH GRADES AT EACH LOCATION.

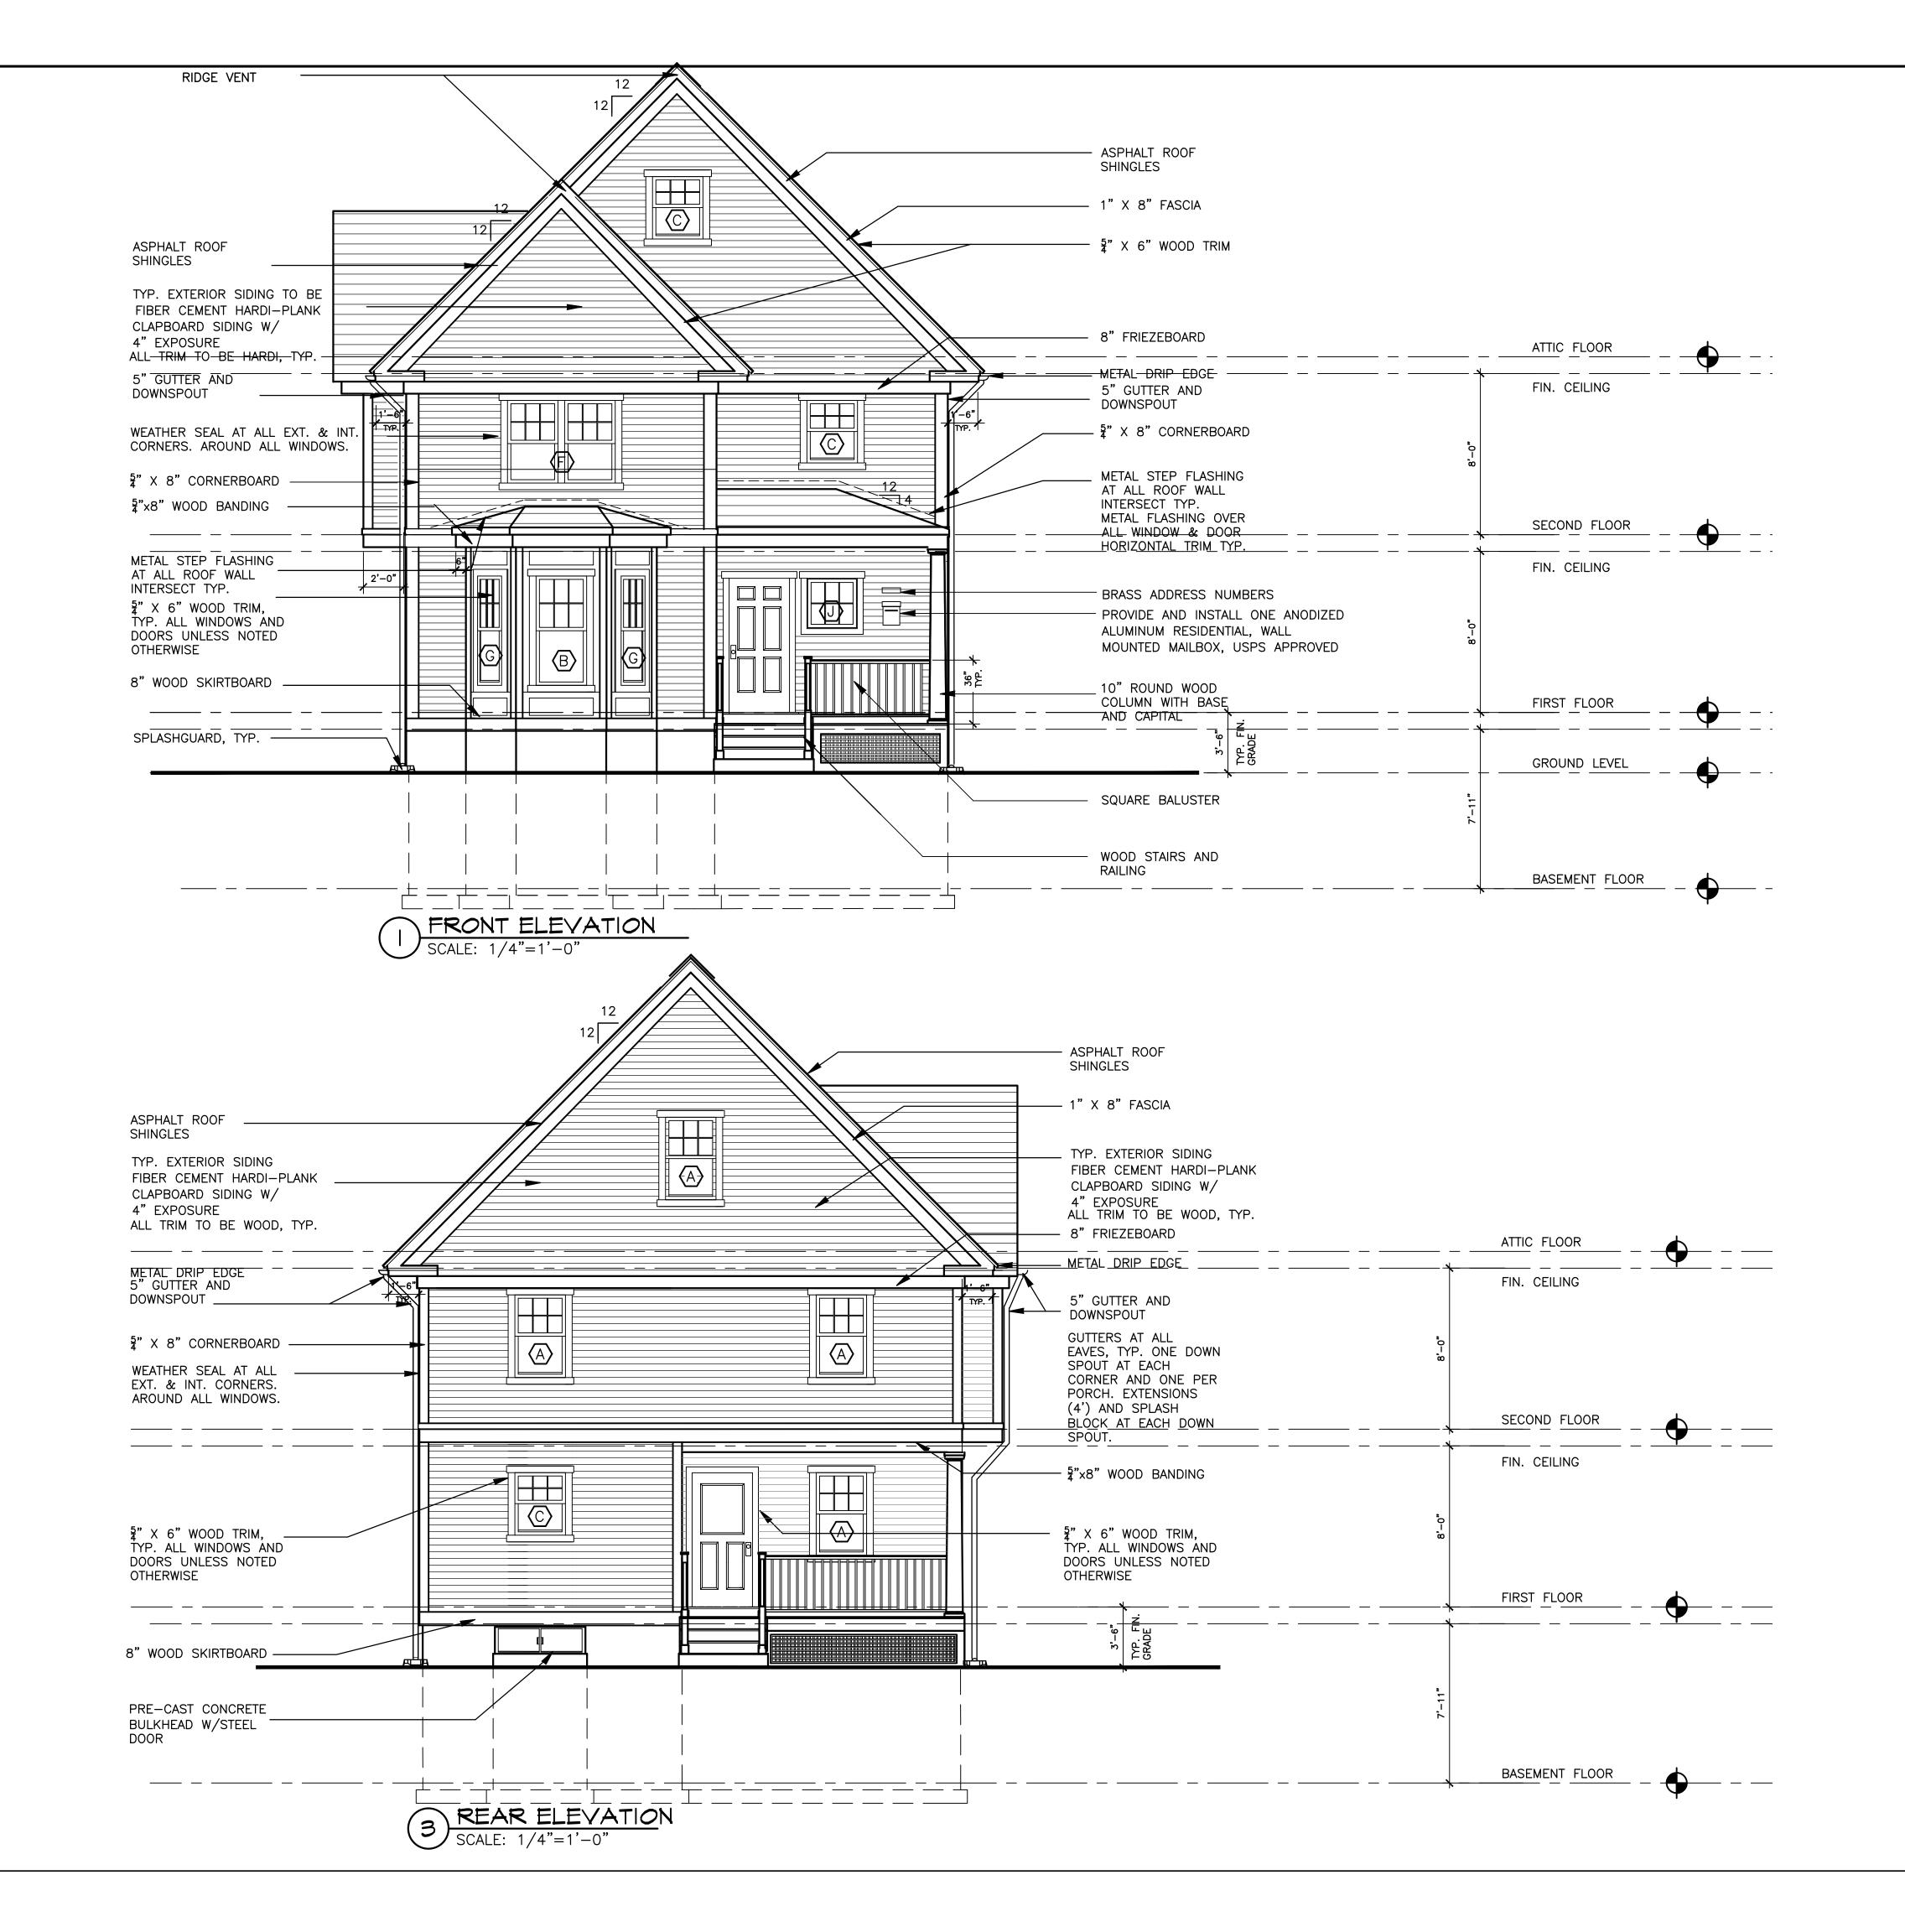

## Micheal Washington Architects Inc.

891 Centre Street Jamaica Plain, MA 02130

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PROJECT


#### NEW ENGLAND HERITAGE HOMES

DORCHESTER, MASSACHUSETTS

DEVELOPER

## CODMAN SQUARE NEIGHBORHOOD DEVELOPMENT CORPORATION

DORCHESTER, MASSACHUSETTS

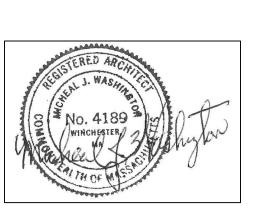

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SHEET TITLE


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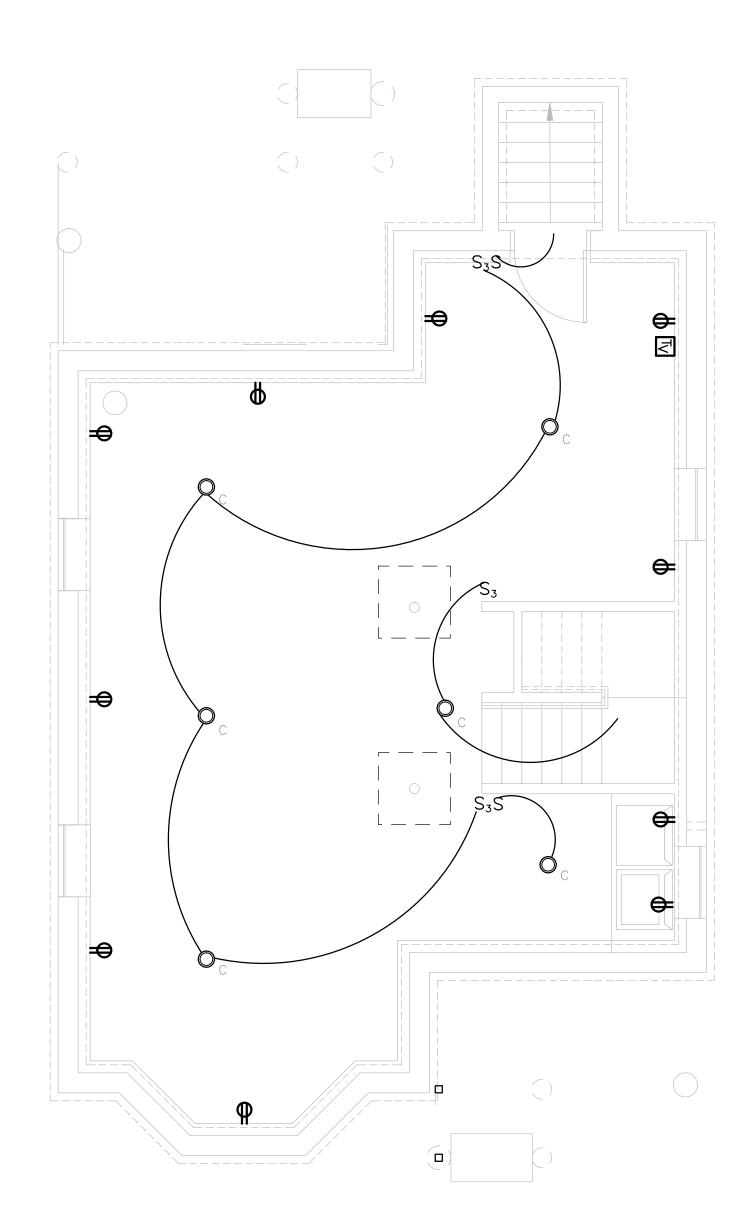
SEE SITE ON COVER PAGE FOR ADDRESS AND UNIT LOCATION

DATE: 12/01/2015

DRAWN BY:

CHECKED BY: MW FILE: NEHH.dwg **A-A.3** 



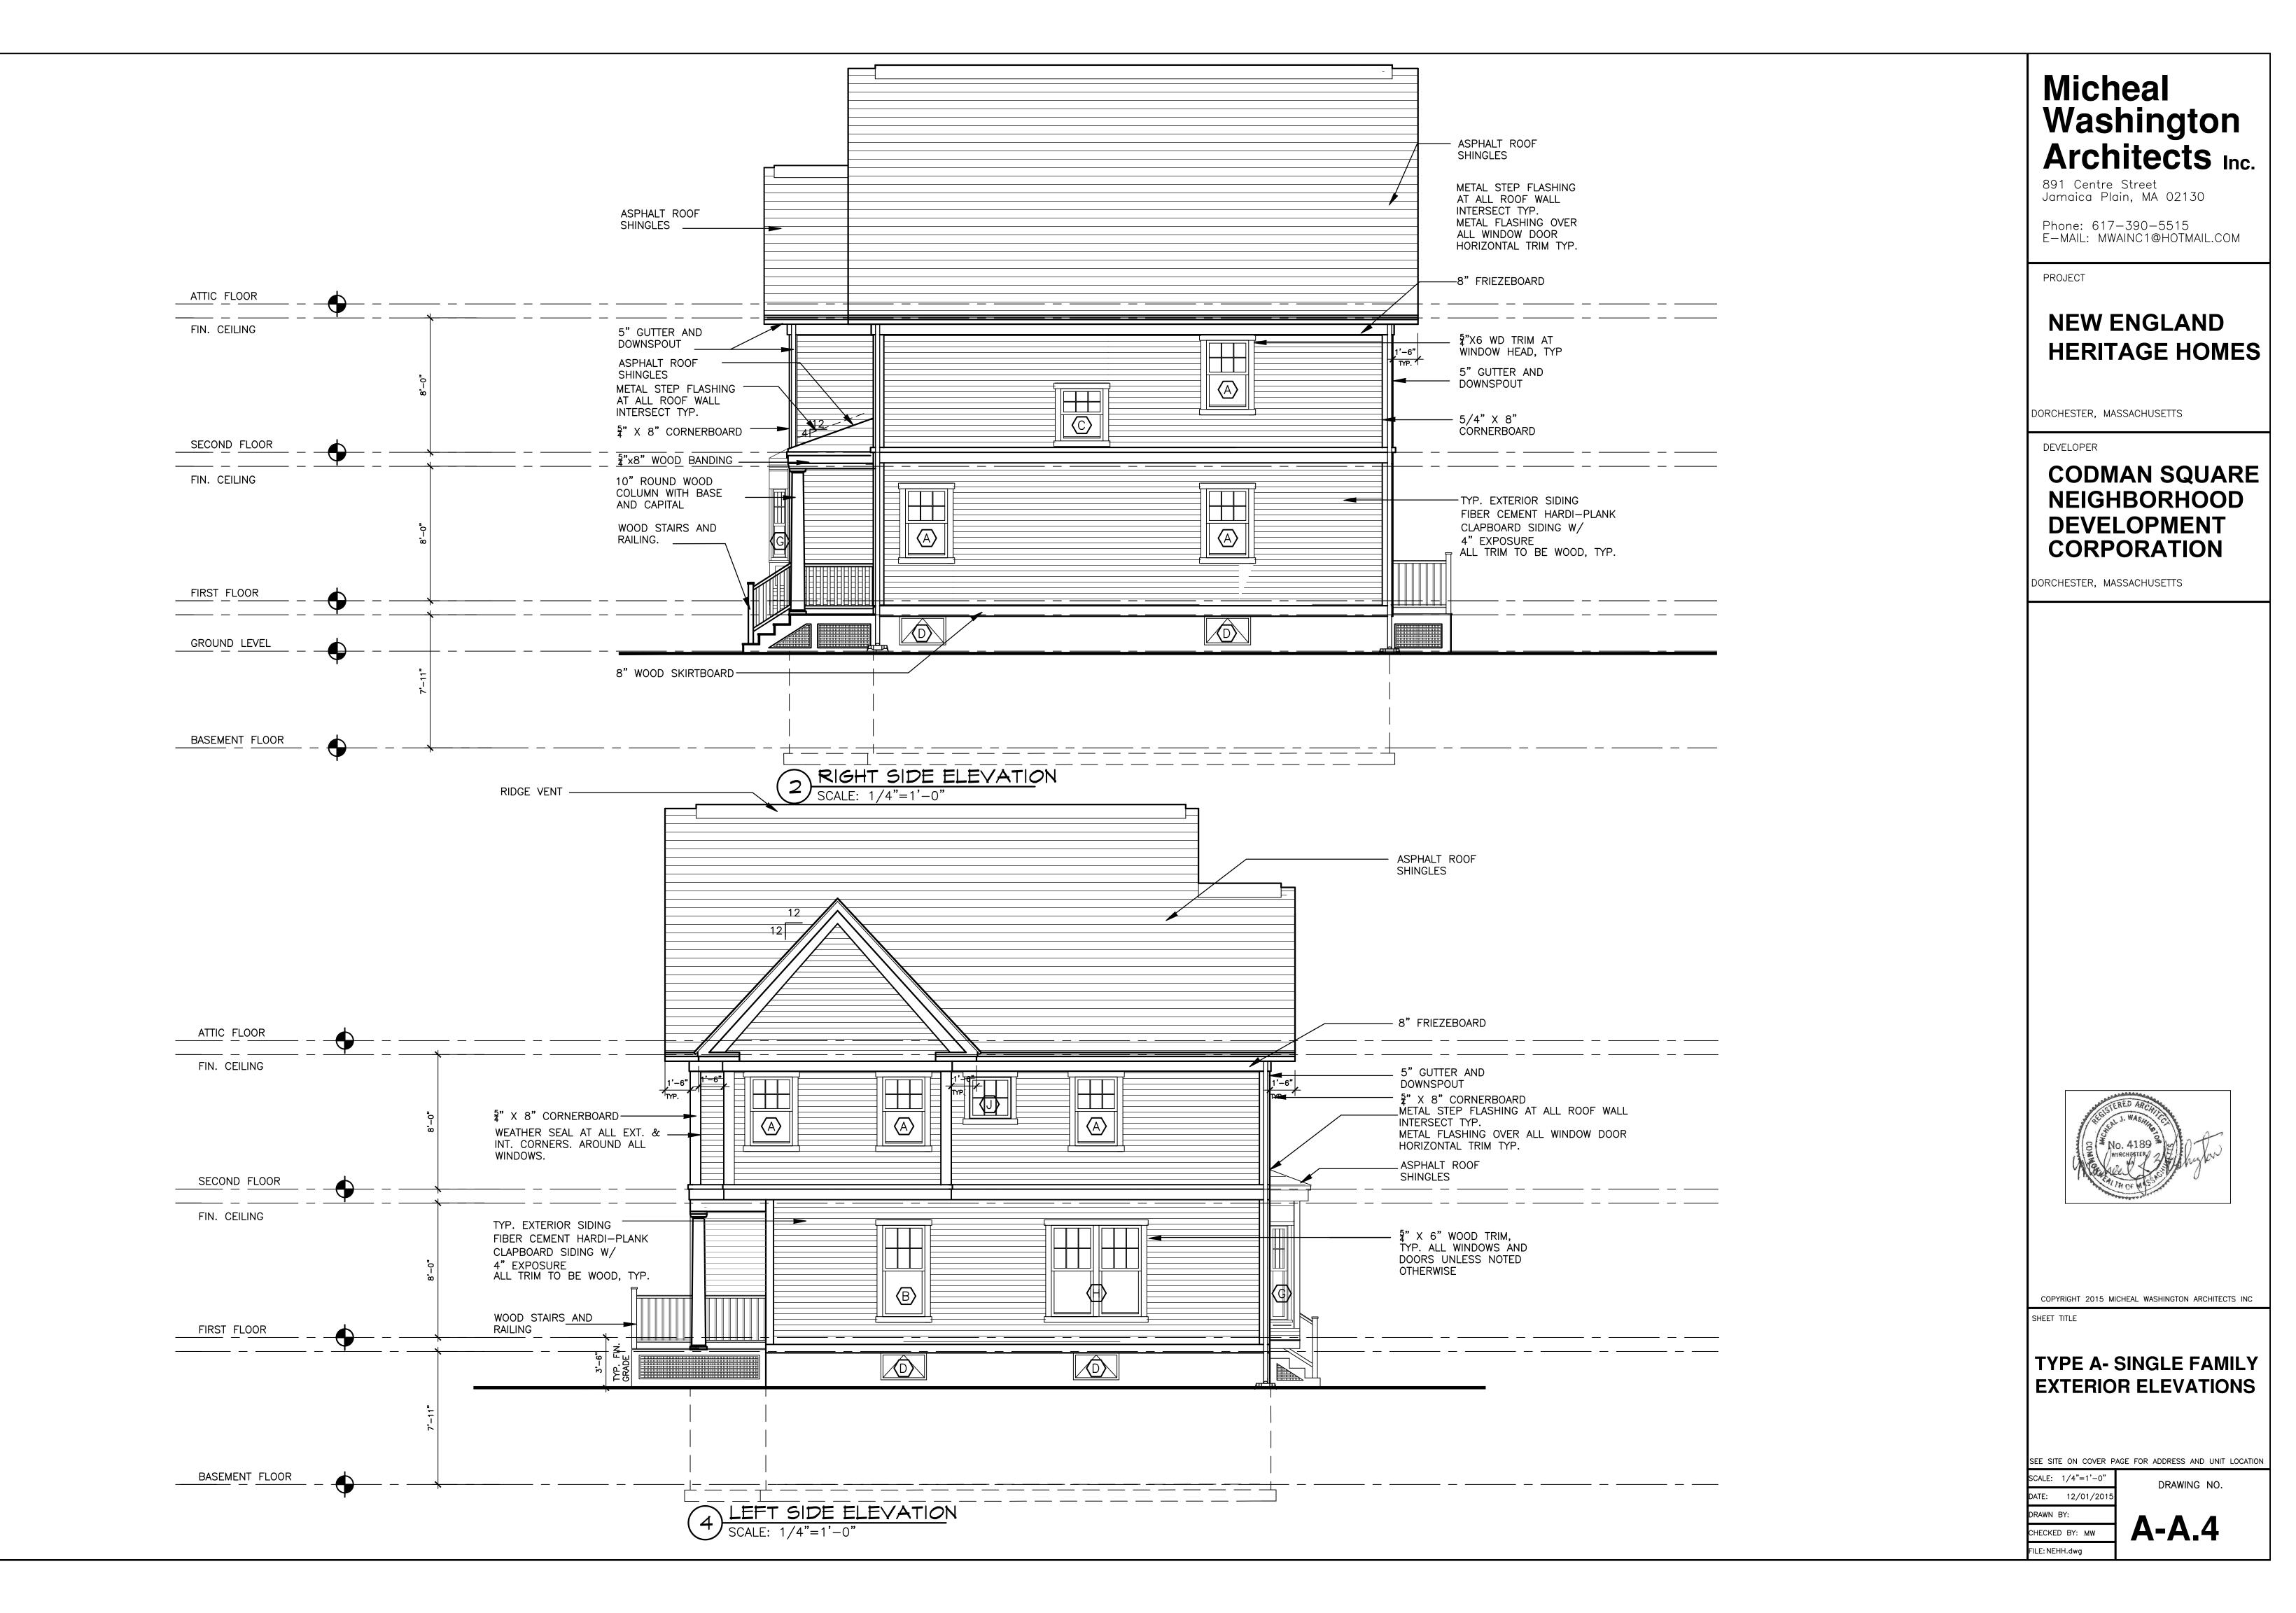

BASEMENT ELECTRICAL PLAN

SCALE: 1/4"=1'-0"

ELECT	RICAL SYMBOLS
0	CEILING MOUNTED LIGHT FIXTURE.
<u> </u>	WALL MOUNTED LIGHT FIXTURE.
	2'X2' OR 2'X4' FLUORESCENT LIGHT FIXTURE.
	1'x4' FLUORESCENT WALL/CEILING MOUNTED LIGHT FIXTURE.
S	SINGLE POLE LIGHT SWITCH
S₃ S <sub>D</sub>	THREE-WAY LIGHT SWITCHES
	DIMMER SWITCH MINIMUM 1000W OR AS REQUIRED PER CIRCUIT  DUPLEX RECEPTACLE, 120V,18" AFF.
⊕ ⊕ GFI	
$\bigoplus^{GFI}$	DUPLEX RECEPTACLE WITH GROUND FAULT INTERRUPTER 8" ABOVE COUNTER TO Q
•	DUPLEX RECEPTACLE, 120V,18" AFF., ONE OUTLET SWITCHED
	120V DOUBLE DUPLEX CONVENIENCE RECEPTACLE
	DUPLEX RECEPTACLE ABOVE COUNTER, 8" ABOVE COUNTER TO Q.
▼	TELEPHONE JACK COMPLETE W/JACK AND COVER, WALL MOUNTED @ 4'-0" A.F.F)
	MOTOR
\$	SYSTEM TYPE SMOKE DETECTOR - DBEC
	DUCT SMOKE DETECTOR W/REMOTE TEST SWITCH - DBEC
<u> </u>	HEAT DETECTOR - DBEC
	FIRE ALARM AUDIO/VISUAL UNIT. MTD. @ 6'-8" AFF - DBEC
H	FIRE ALARM MINI HORN — DBEC
<b>(</b>	JUNCTION BOX - DBEC
	LIGHTING & POWER PANEL, RECESSED - DBEC
FACP	FIRE ALARM CONTROL PANEL - DBEC
ANN	FIRE ALARM ANNUNCIATOR — DBEC
TV	CABLE
DBEC - D	PESIGN AND INSTALLED BY ELECTRICAL CONTRACTOR
1	

ROGRESS ROGRESS	CATALOG NUMBER P2851-09	VOLT	LAMP	DESCRIPTION
	P2851-09			
	P2851-09			
ROGRESS	1 2001 00	120	(2)23WCFL MINI-TWIST	KITCHEN
	P3688-09	120	(1)13 CFL MINI-TWIST	ENTRANCE/LIVING RM/ HALLWAY & STAIR
ROGRESS	P6163-09WB	120	(4)50W MR16	DINING ROOM
ROGRESS	P3408-09	120	(1)13 CFL MINI-TWIST	CLOSET LIGHT
ROGRESS	P3688-09	120	(1)13 CFL MINI-TWIST	BEDROOM LIGHT
OGRESS	P3223-09WB	120	(3)60W HALOGEN G9	BATHROOM VANITY ABOVE SINK
ROGRESS	P3410-09	120	(2)13 CFL MINI-TWIST	BATHROOM CEILING LIGHT
ROGRESS	P6017-84	120	(2)18W CFL	EXTERIOR CEILING MOUNTED
ROGRESS	P5749-84	120	(1)18W CFL	EXTERIOR WALL MOUNTED
ROGRESS	P3688-09	120	(1)13 CFL MINI-TWIST	BASEMENT LIGHT
ROGRESS	P2501-04			CEILING FAN
2 (C	OGRESS OGRESS OGRESS OGRESS OGRESS OGRESS	OGRESS         P3408-09           OGRESS         P3688-09           OGRESS         P3223-09WB           OGRESS         P3410-09           OGRESS         P6017-84           OGRESS         P5749-84           OGRESS         P3688-09	OGRESS       P3408-09       120         OGRESS       P3688-09       120         OGRESS       P3223-09WB       120         OGRESS       P3410-09       120         OGRESS       P6017-84       120         OGRESS       P5749-84       120         OGRESS       P3688-09       120	OGRESS         P3408-09         120         (1)13 CFL MINI-TWIST           OGRESS         P3688-09         120         (1)13 CFL MINI-TWIST           OGRESS         P3223-09WB         120         (3)60W HALOGEN G9           OGRESS         P3410-09         120         (2)13 CFL MINI-TWIST           OGRESS         P6017-84         120         (2)18W CFL           OGRESS         P5749-84         120         (1)18W CFL           OGRESS         P3688-09         120         (1)13 CFL MINI-TWIST

HEATING/COOLING SYSTEM:	<ol> <li>Fajitsu, mitshubishi, or equal mini split heat pump system</li> <li>Compressor sized</li> <li>4 Heads.</li> <li>No ducts shall be installed</li> <li>HSPF of 12 or greater</li> <li>SEER of 20 or greater</li> </ol>
HOT WATER SYSTEM:	Gas domestic hot water system — instantaneous gas dhw system EF of .95 or higher or If gas is not available use Electric heat pump water heater Locate Unit as Desired.
ERV SYSTEM:	Provide energy recovery system (ERV) by Panasonic FVO4VE1, Venmar or equivalent Capable of meeting ventilation code 50—80 CFM that meets the 2012 IECC standards for efficacy
PASSIVE RADON SYSTEM:	Provide a radon resistant construction techniques including a passive system which from the perforated pipe under the slab, up through slab and house, terminating above the roof with an electrical outlet in the of for installing a fan, making it an active system, if there is a high reading measured.  ASTM E1465 Practice for Radon Control Options
TO BE SOLAR PV READY:	Install Conduit from roof to area in basement In basement room for a solar meter, an inverter and a switch box On exterior of basement room following the local electric company guidelines, an accessible safety off switch box
PLUMBING:	Water Sense (EPA) for all interior plumbing devices; Showerhead Toilet Lavatory Faucet
APPLIANCES:	Use Energy Star Appliances Use Electric Range and exhaust range to exterior

# Micheal Washington Architects Inc.

891 Centre Street Jamaica Plain, MA 02130

Phone: 617-390-5515 E-MAIL: MWAINC1@HOTMAIL.COM

PROJECT


#### NEW ENGLAND HERITAGE HOMES

DORCHESTER, MASSACHUSETTS

DEVELOPER

## CODMAN SQUARE NEIGHBORHOOD DEVELOPMENT CORPORATION

DORCHESTER, MASSACHUSETTS

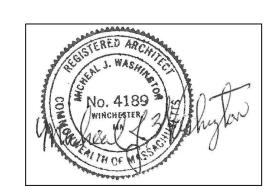

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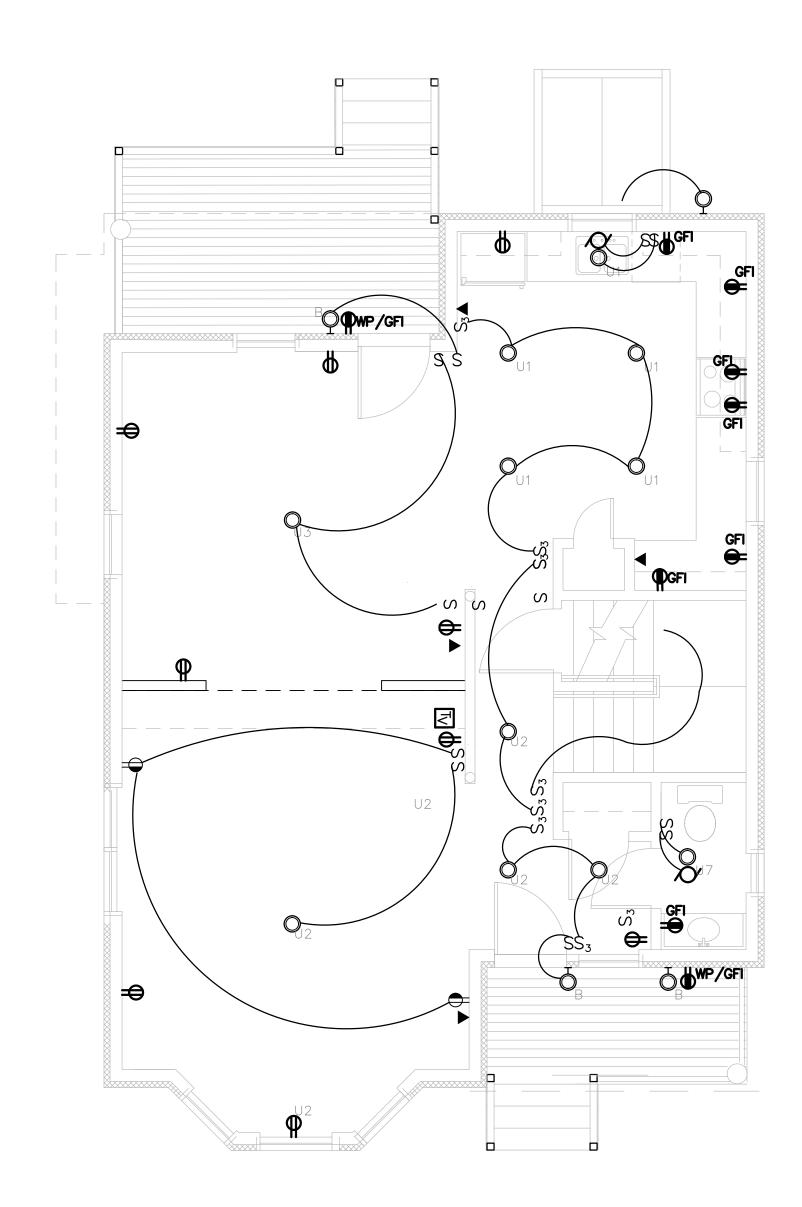
SHEET TITLE

TYPE A- SINGLE FAMILY
BASEMENT
ELECTRICAL PLAN
SCHEDULES AND
MECHANICAL NOTE

SEE SITE ON COVER PAGE FOR ADDRESS AND UNIT LOCATION


ALE: 1/4"=1'-0"
TE: 12/01/2015

**E-A.1** 



1ST FLOOR ELECTRICAL PLAN

SCALE: 1/4"=1'-0"

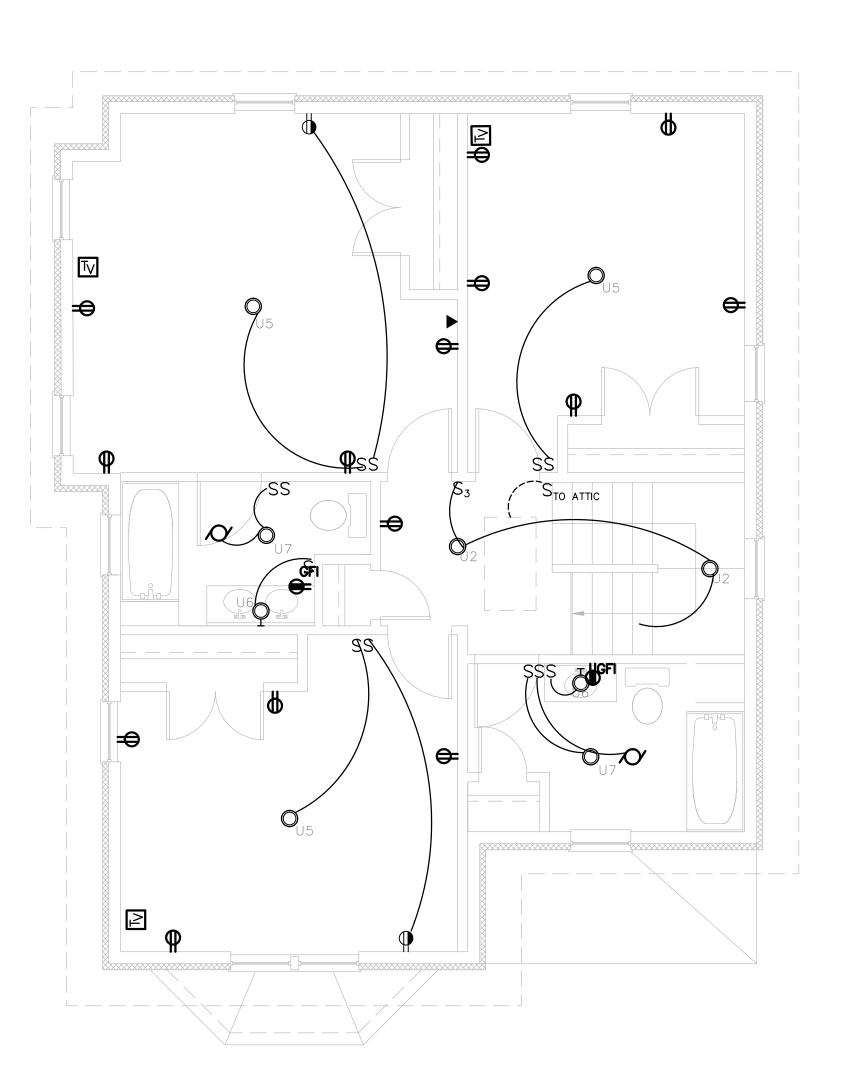

2ND FLOOR ELECTRICAL PLAN

SCALE: 1/4"=1'-0"

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PROJECT


#### NEW ENGLAND HERITAGE HOMES

DORCHESTER, MASSACHUSETTS

DEVELOPE

## CODMAN SQUARE NEIGHBORHOOD DEVELOPMENT CORPORATION

DORCHESTER, MASSACHUSETTS

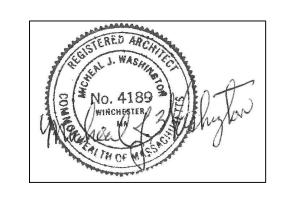

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SHEET


TYPE A- SINGLE FAMILY
1ST & 2ND FLOOR
ELECTRICAL PLANS

SEE SITE ON COVER PAGE FOR ADDRESS AND UNIT LOCATION


SCALE: 1/4"=1'-0" DATE: 12/01/201

DRAWING NO.

E-A.2

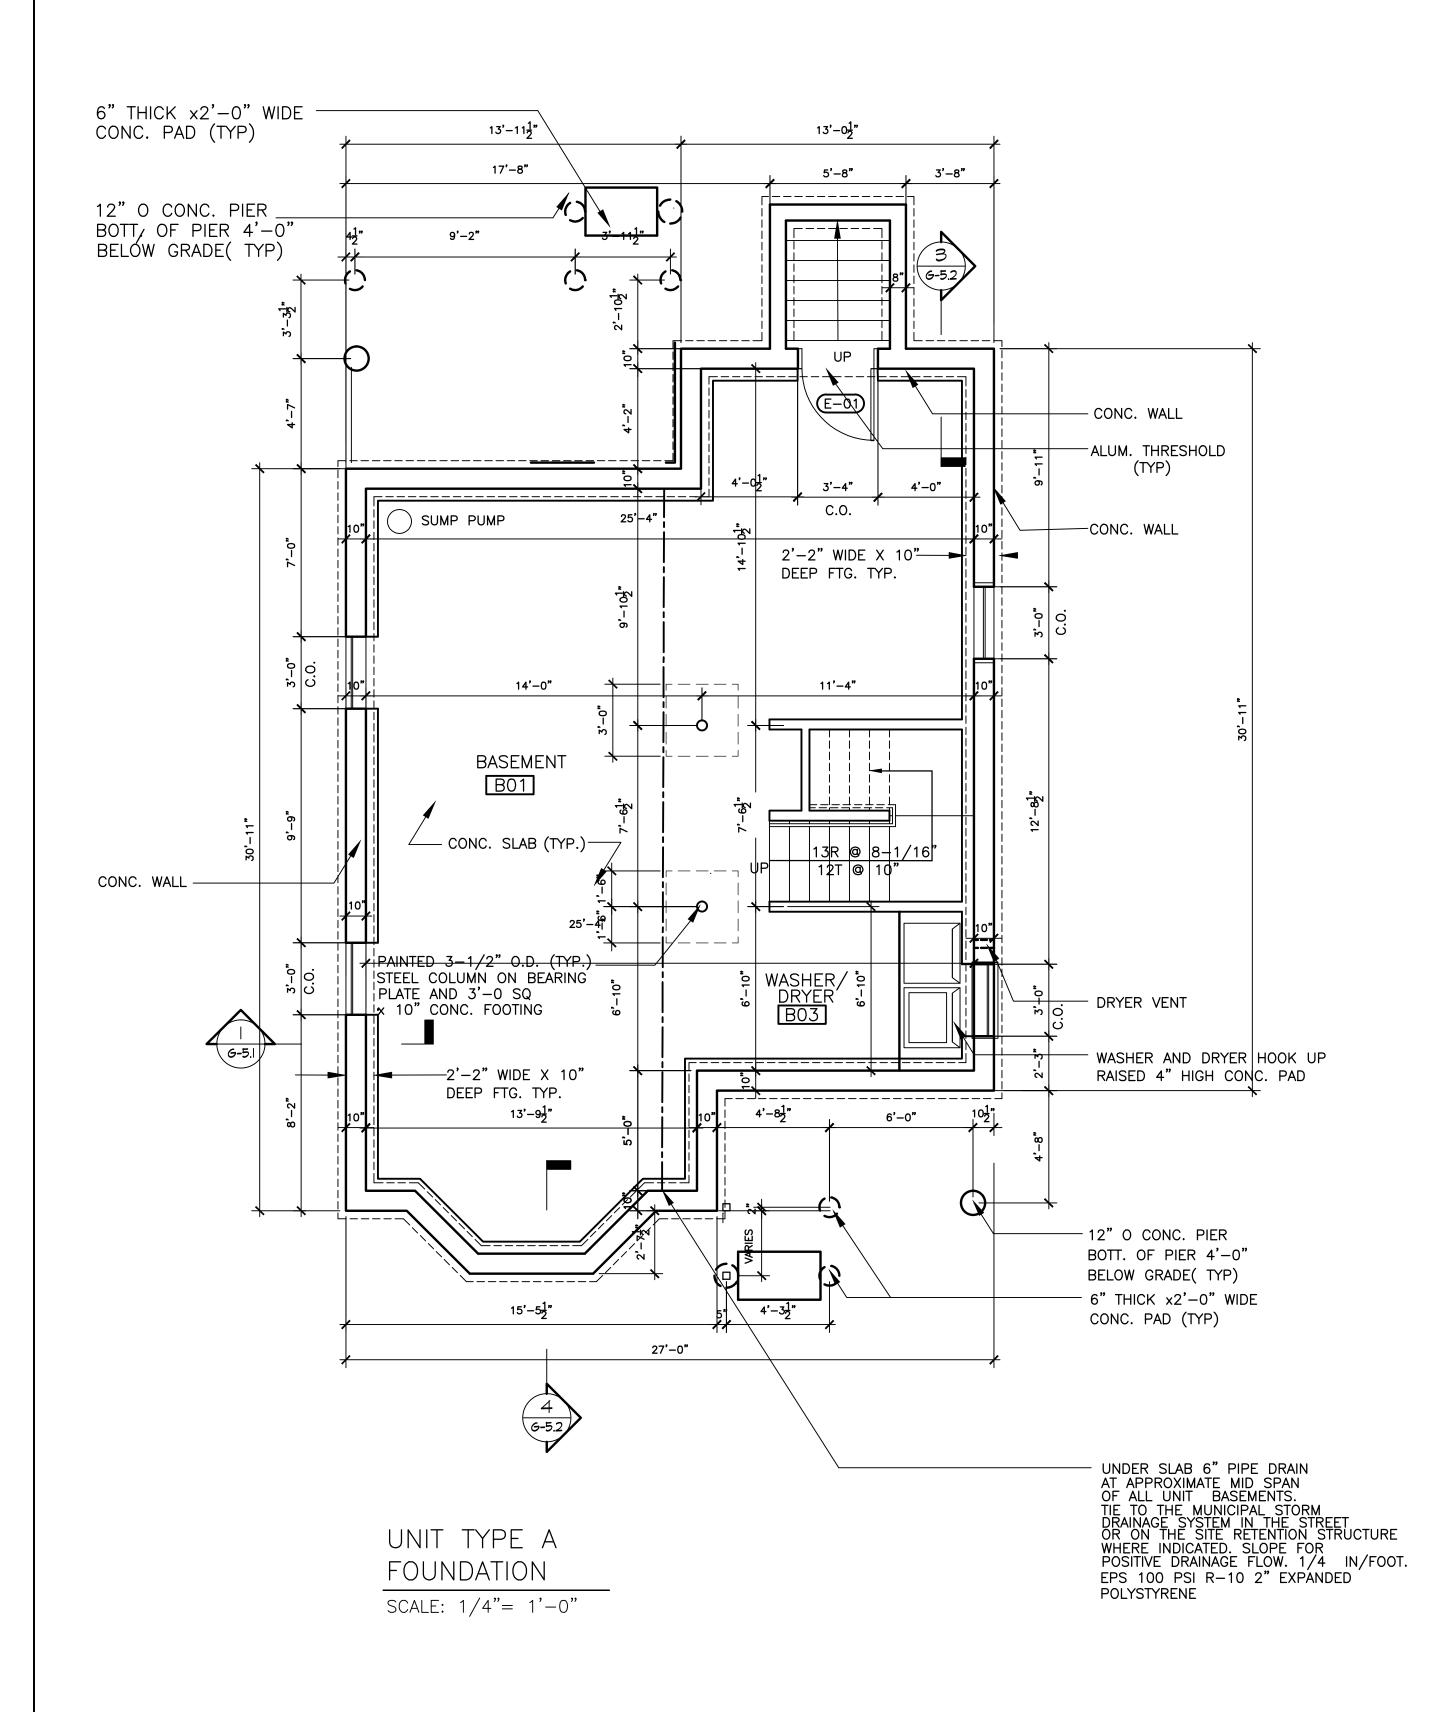

NOTE:
AT BUILDING CORNERS & AT ALL EXTERIOR DOOR OPENING
PROVIDE DOUBLE 2"x6" STUD IN SHEAR WALLS WITH SIMPSON
HOLDOWN HDAHD22 CAST IN CONCRETE WALL & SCREW TO

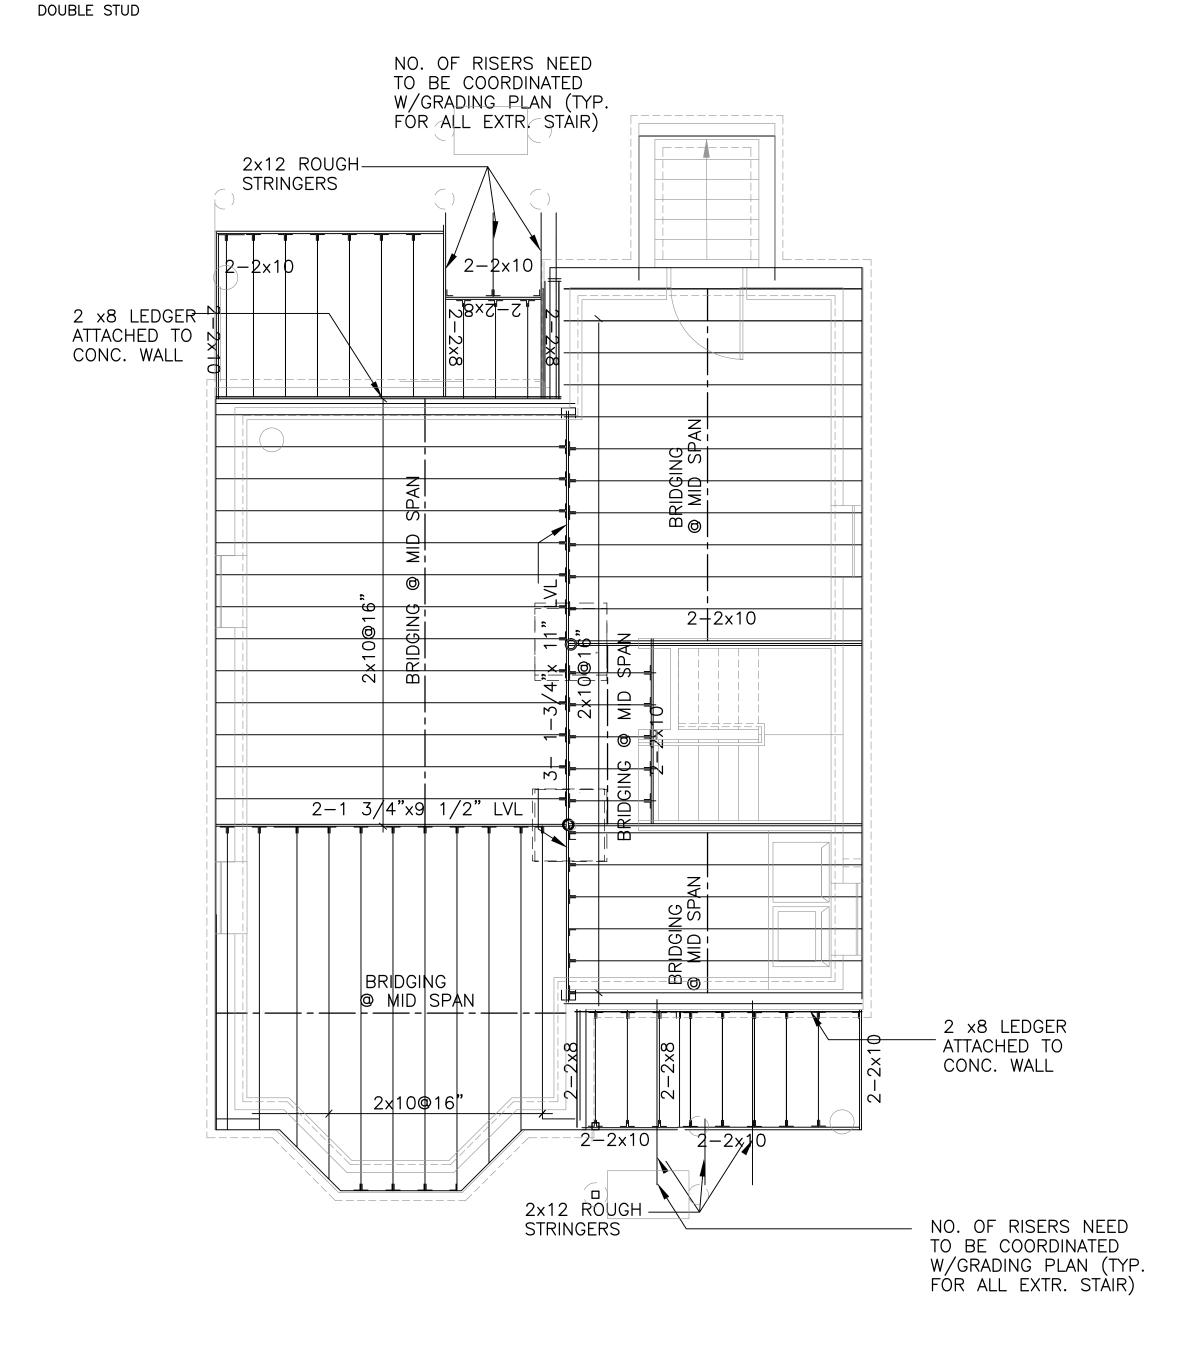

#### 1ST FLOOR FRAMING PLAN

SCALE: 1/4"=1'-0"

G.C. SHALL INSTALL ALL REQUIRED FLU STOPPINGS AND BLOCKINGS ACCORDING TO CURRENT EDITION OF MASSACHUSETTS STATE BUILDING CODE

# Micheal Washington Architects Inc.

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PROJECT

#### NEW ENGLAND HERITAGE HOMES

DORCHESTER, MASSACHUSETTS


DEVELOPE

## CODMAN SQUARE NEIGHBORHOOD DEVELOPMENT CORPORATION

DORCHESTER, MASSACHUSETTS

NOTE

1. ALL FRAMING AND STRUCTURAL DESIGN MEMBER, SIZES AND ELEMENTS TO BE CONFIRMED BY FINAL ARCHITECT AND ENGINEER OF RECORD.

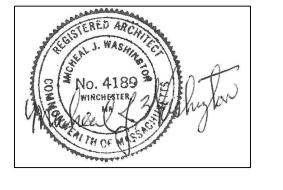

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SHEET TITLE

TYPE A- SINGLE FAMILY
FOUNDATION &
1ST FLOOR
FRAMING PLAN

SEE SITE ON COVER PAGE FOR ADDRESS AND UNIT LOCATION


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DATE: 12/01/201!


CHECKED BY: MW

FILE: NEHH.dwg

S-A.1

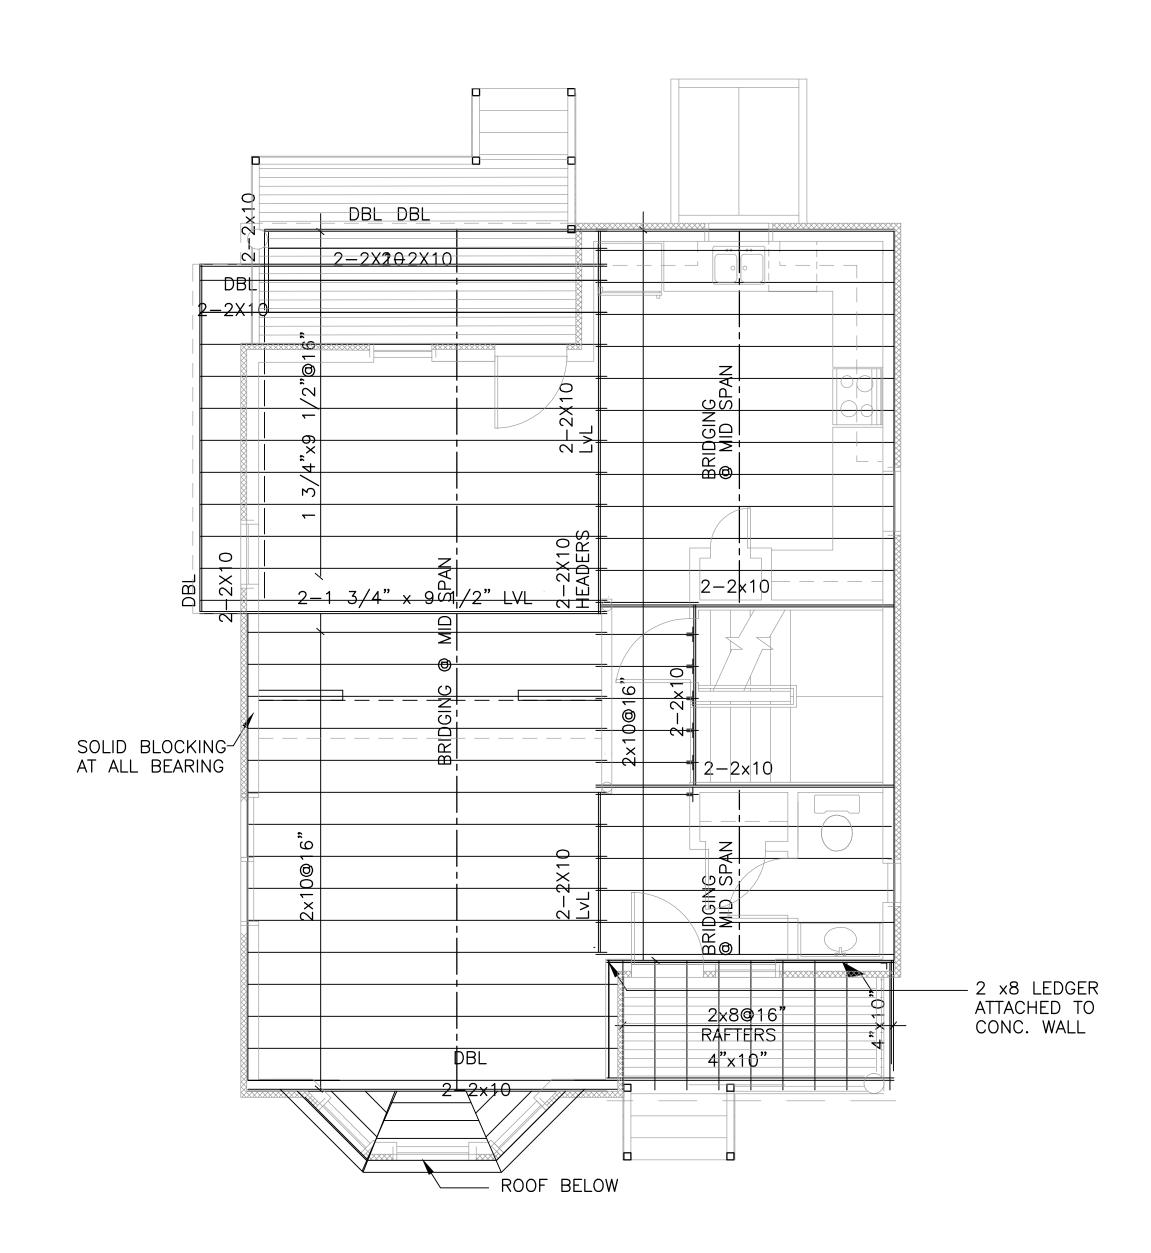

2ND FLOOR FRAMING PLAN
SCALE: 1/4"=1'-0"

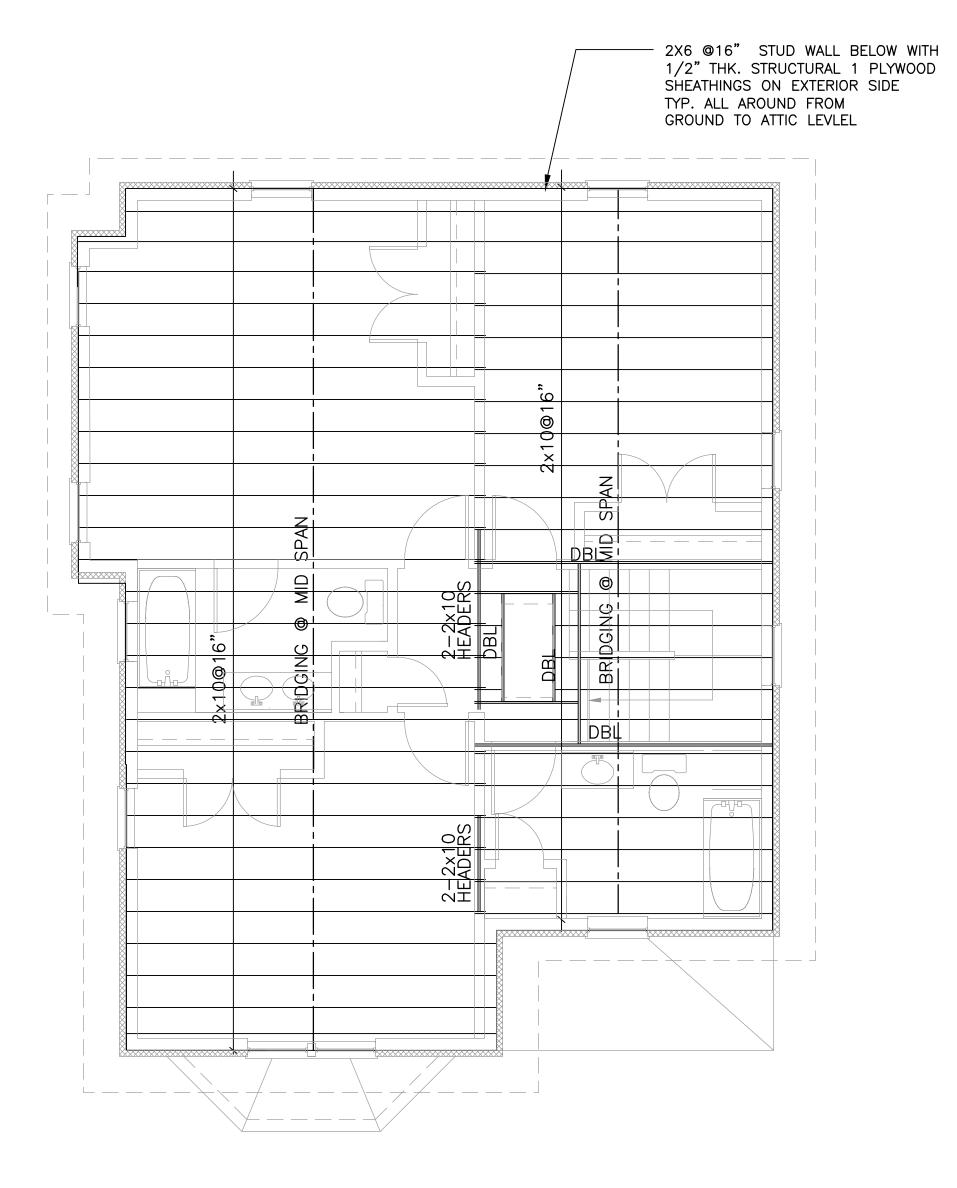

ATTIC FRAMING PLAN

SCALE: 1/4"=1'-0"

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PROJECT


#### NEW ENGLAND HERITAGE HOMES

DORCHESTER, MASSACHUSETTS

DEVELOPE

# CODMAN SQUARE NEIGHBORHOOD DEVELOPMENT CORPORATION

DORCHESTER, MASSACHUSETTS

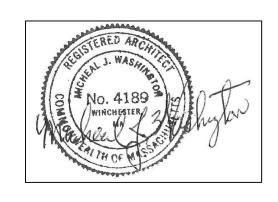

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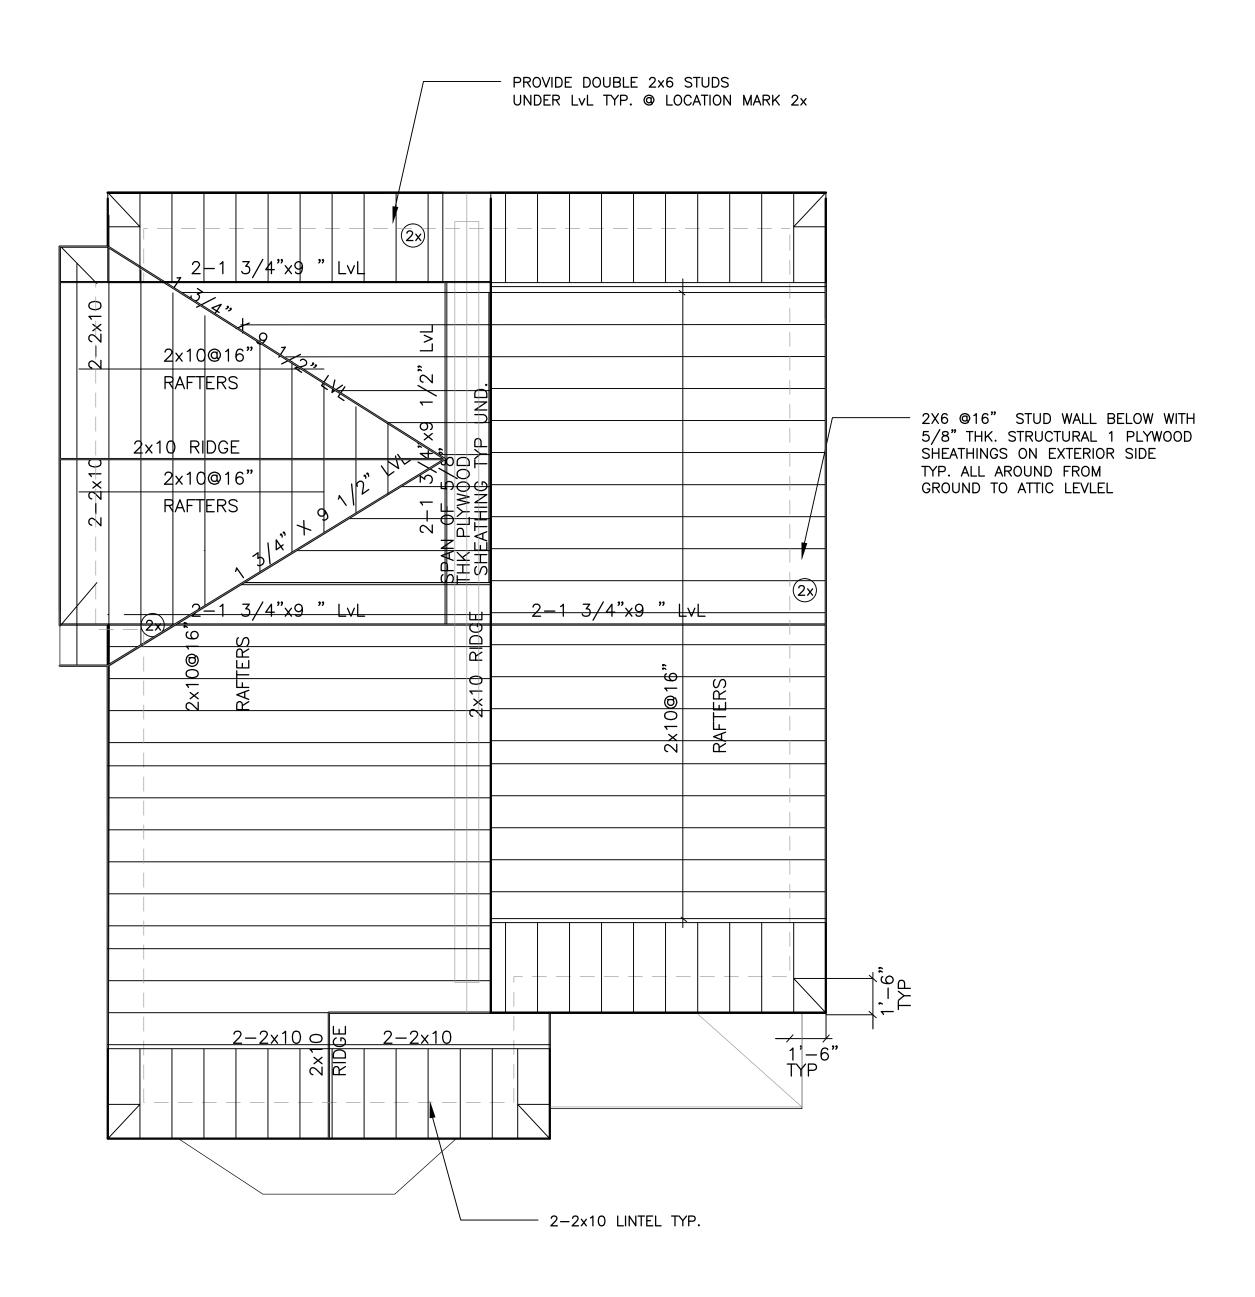
SHEET TITLE

TYPE A- SINGLE FAMILY 2ND & ATTIC FLOOR FRAMING PLANS

SEE SITE ON COVER PAGE FOR ADDRESS AND UNIT LOCATION

SCALE: 1/4"=1'-0" DATE: 12/01/2015 DRAWING NO.

**S-A.2** 



ROOF FRAMING PLAN
SCALE: 1/4"=1'-0"

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PROJECT


#### NEW ENGLAND HERITAGE HOMES

DORCHESTER, MASSACHUSETTS

DEVELOPER

## CODMAN SQUARE NEIGHBORHOOD DEVELOPMENT CORPORATION

DORCHESTER, MASSACHUSETTS

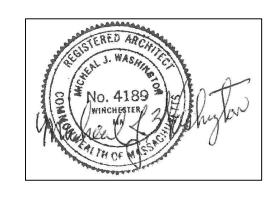

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SHEET TITLE

TYPE A- SINGLE FAMILY ROOF FRAMING PLAN

SEE SITE ON COVER PAGE FOR ADDRESS AND UNIT LOCATION

DATE: 1/4"=1'-0"

DRAWING NO.

DRAWN BY:

CHECKED BY: MW

FILE: NEHH.dwg

70 NEW ENGLAND AVENUE ( BUILDING E)

# "NEW ENGLAND HERITAGE HOMES" AFFORDABLE HOMEOWNERSHIP DEVELOPMENT

PREPARED FOR:

## CODMAN SQUARE NEIGHBORHOOD DEVELOPMENT CORPORATION

587 WASHINGTON STREET DORCHESTER, MA 02124

PREPARED BY:


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I. ALL DRAWINGS WILL BE UPDATED AND MODIFIED

2. ALL GENERAL DRAWINGS TO BE UPDATED
INCLUDING REMOVAL OF HUNTER PANELS AND
DOWNGRADING R VALUES TO CURRENT CODE.

3. WINDOW REQUIREMENTS TO BE DETERMINED LATER.

NOTES:

I. ALL WORK AND PERMITS AND APPROVALS WILL BE OBTAINED BY THE TRADE AND COORDINATED BY THE GENERAL CONTRACTOR AND THE OWNER. ALL WORK SHALL COMPLY WITH ALL PROVISIONS OF THE MASSACHUSETTS STATE BUILDING CODE, CURRENT EDITION, AND LOCAL CITY AND TOWN PROVISIONS.

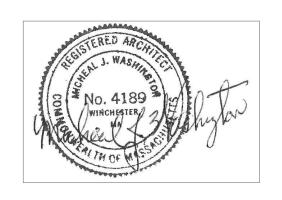2. ALL CONSTRUCTION IS TO COMPLY WITH THE MASSACHUSETTS STATE BUILDING CODE, EIGHTH EDITION AND WITH ALL SUPPLEMENTS, AMENDMENTS, AND OTHER APPLICABLE CODES AND REGULATIONS.

3. ALL ROOF INSULATION SHALL BE R-49; ALL WALLS SHALL BE R-21 AND IN COMPLIANCE WITH THE IECC REQUIREMENTS.ALLFIRST FLOOR AREAS R-30, IN COMPLIANCE WITH IBC REQUIREMENTS.

4. CONTRACTOR IS TO VERIFY ALL DIMENSION IN THE FIELD, NOTIFY ARCHITECT IF THERE ARE ANY VARIATIONS.

## 70 NEW ENGLAND AVENUE ( BUILDING E)


#### LIST OF DRAWINGS

#### ARCHITECTURAL INDEX OF DRAWINGS ARCHITECTURAL INDEX OF DRAWINGS DRAWING NAME DRAWING NAME KICTHEN PLANS & ELEVATIONS TITLE SHEET BATH PLANS & ELEVATIONS WINDOWS & DOORS SCHEDULE FINISH SCHEDULE & PARTITION TYPES BUILDING PLOT PLAN MALL SECTIONS WALL SECTIONS BASEMENT & FIRST FLOOR PLAN GENERAL TYPICAL DETAILS SECOND & THIRD FLOOR PLANS GENERAL TYPICAL DETAILS ROOF FLOOR PLAN

#### 70 NEW ENGLAND AVENUE

EXTERIOR ELEVATIONS EXTERIOR ELEVATIONS

70 NEW ENGLAND AVENUE		
ZONING INFORMATION		
ZONING: 3F-6000 WARD 14 1 FAMILY ATTACHED	REQUIRED	ACTUAL
MIN. LOT SIZE:	6000 SF FOR 2 UNITS + 2500 PER ADDT'L UNIT	2,343 SF
MIN. LOT WIDTH:	40 FT	34.27 FT
MIN. LOT FRONTAGE:	40 FT	34.27 FT
MAX. F.A.R:	0.4	0.68
MAX. BLDG. HEIGHT:	2 1/2 STORY 35	35 FT
MIN. OPEN SPACE:	750 SF PER UNIT	958 SQ. FT.
MIN. FRONT YARD DEPTH:	15FT/MOD.	16.4 FT
MIN. SIDE YARD DEPTH:	10 FT	10.1 FT
MIN. REAR YARD DEPTH:	20 FT	19.9 FT
MIN. PARKING:	1/UNIT	1

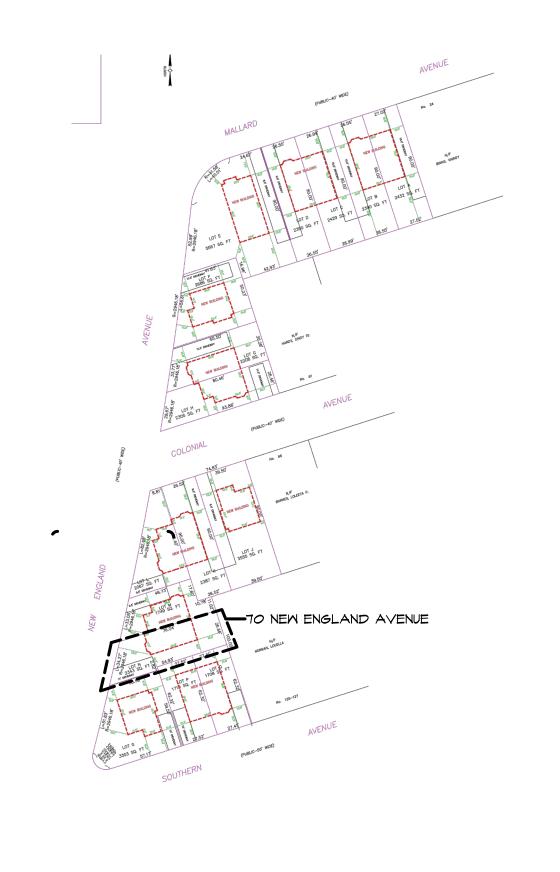

## 60 NEW ENGLAND AVENUE ( BUILDING E) "NEW ENGLAND HERITAGE HOMES" AFFORDABLE HOMEOWNERSHIP DEVELOPMENT

PREPARED FOR:

## CODMAN SQUARE NEIGHBORHOOD DEVELOPMENT CORPORATION


587 WASHINGTON STREET DORCHESTER, MA 02124

PREPARED BY:

MICHEAL WASHINGTON ARCHITECTS, INC.

891 CENTRE ST. JAMAICA PLAIN, MA 02130 TEL: (617) 390-5515

EMAIL: mwainc1@hotmail.com

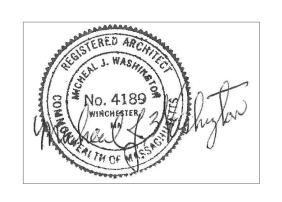

I. ALL DRAWINGS WILL BE UPDATED AND MODIFIED 2. ALL GENERAL DRAWINGS TO BE UPDATED INCLUDING REMOVAL OF HUNTER PANELS AND DOWNGRADING R VALUES TO CURRENT CODE. 3. WINDOW REQUIREMENTS TO BE DETERMINED LATER.

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4. CONTRACTOR IS TO VERIFY ALL DIMENSION IN THE FIELD, NOTIFY ARCHITECT IF THERE ARE ANY VARIATIONS.

## 60 NEW ENGLAND AVENUE ( BUILDING E)

#### LIST OF DRAWINGS

ARCHITECTURAL INDEX OF DRAWINGS ARCHITECTURAL INDEX OF DRAWINGS DRAWING NAME DRAWING NAME KICTHEN PLANS & ELEVATIONS TITLE SHEET BATH PLANS & ELEVATIONS WINDOWS & DOORS SCHEDULE FINISH SCHEDULE & PARTITION TYPES BUILDING PLOT PLAN WALL SECTIONS WALL SECTIONS BASEMENT & FIRST FLOOR PLAN GENERAL TYPICAL DETAILS GENERAL TYPICAL DETAILS ROOF FLOOR PLAN

#### 60 NEW ENGLAND AVENUE

EXTERIOR ELEVATIONS EXTERIOR ELEVATIONS

60 NEW ENGLAND AVENUE		
ZONING INFORMATION		
ZONING: 3F-6000 WARD 14 1 FAMILY ATTACHED	REQUIRED	ACTUAL
LOT SIZE:	6000 SF FOR 2 UNITS + 2500 PER ADDT'L UNIT	1,749 SF
LOT WIDTH:	40 FT	33.05 FT
LOT FRONTAGE:	40 FT	33.05 FT
F.A.R:	0.4	0.91
BLDG. HEIGHT:	2 1/2 STORY 35	35 FT
OPEN SPACE:	750 SF PER UNIT	1026 SQ. FT.
FRONT YARD DEPTH:	15FT/MOD.	13.0 FT
SIDE YARD DEPTH:	10 FT	10.1 FT
REAR YARD DEPTH:	20 FT	9.1 FT
PARKING:	1/UNIT	1



## 63 COLONIAL AVENUE (BUILDING E)

# "NEW ENGLAND HERITAGE HOMES" AFFORDABLE HOMEOWNERSHIP DEVELOPMENT

PREPARED FOR:

## CODMAN SQUARE NEIGHBORHOOD DEVELOPMENT CORPORATION

587 WASHINGTON STREET DORCHESTER, MA 02124

PREPARED BY:


MICHEAL WASHINGTON ARCHITECTS, INC.

891 CENTRE ST.

JAMAICA PLAIN, MA 02130

TEL: (617) 390-5515

EMAIL: mwainc1@hotmail.com

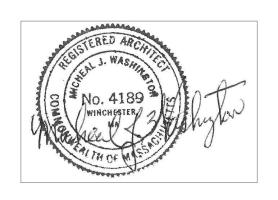

I. ALL DRAWINGS WILL BE UPDATED AND MODIFIED

2. ALL GENERAL DRAWINGS TO BE UPDATED
INCLUDING REMOVAL OF HUNTER PANELS AND
DOWNGRADING R VALUES TO CURRENT CODE.

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- 4. CONTRACTOR IS TO VERIFY ALL DIMENSION IN THE FIELD, NOTIFY ARCHITECT IF THERE ARE ANY VARIATIONS.

## 63 COLONIAL AVENUE ( BUILDING E)

#### LIST OF DRAWINGS

ARCHITECT	URAL INDEX OF DRAWINGS	ARCHITECT	URAL INDEX OF DRAWINGS
NUMBER	DRAMING NAME	NUMBER	DRAWING NAME
		GENERAL I	DRAMINGS
T-I	TITLE SHEET	<b>6-</b> 1	KICTHEN PLANS & ELEVATIONS
		<b>6-2</b> .l	BATH PLANS & ELEVATIONS
		<i>6-</i> 3	MINDOMS & DOORS SCHEDULE
C-I	EXISTING CONDITIONS	6-4	FINISH SCHEDULE & PARTITION TYPE
BPP	BUILDING PLOT PLAN	<i>G-</i> 5.1	WALL SECTIONS
		G-5.2	WALL SECTIONS
RCHITECTL	RAL E UNIT		
E.I	BASEMENT & FIRST FLOOR PLAN	G-6.I	GENERAL TYPICAL DETAILS
-E.2	SECOND & THIRD FLOOR PLAN	G-6.2	GENERAL TYPICAL DETAILS
E.3	ROOF FLOOR PLANS		
-E.4	EXTERIOR ELEVATIONS		
√-E.5	EXTERIOR ELEVATIONS		
TRUCTURAL	. E UNIT		
- <b>E</b> .I	FOUNDATION & FIRST FRAMING PLAN		
-E.2	SECOND & ATTIC FRAMING PLAN		
6-E.3	ROOF FRAMING PLAN		

#### 63 COLONIAL AVENUE ( BUILDING E

63 COLONIAL AVENUE ( E	BUILDING E)	
ZONING INFORMATION		
ZONING: 3F-6000 WARD 14 1 FAMILY ATTACHED	REQUIRED	ACTUAL
MIN. LOT SIZE:	6000 SF FOR 2 UNITS + 2500 PER ADDT'L UNIT	2,305 SF
MIN. LOT WIDTH:	40 FT	29.67 FT
MIN. LOT FRONTAGE:	40 FT	29.67 FT
MAX. F.A.R:	0.4	0.67
MAX. BLDG. HEIGHT:	2 1/2 STORY 35	35 FT
MIN. OPEN SPACE:	750 SF PER UNIT	1733 SQ. FT.
MIN. FRONT YARD DEPTH:	15FT/MOD.	8.0 FT
MIN. SIDE YARD DEPTH:	10 FT 10 FT	22.1 FT 18.1 FT
MIN. REAR YARD DEPTH:	20 FT	N/A
MIN. PARKING:	1/UNIT	1



# "NEW ENGLAND HERITAGE HOMES" AFFORDABLE HOMEOWNERSHIP DEVELOPMENT

PREPARED FOR:

## CODMAN SQUARE NEIGHBORHOOD DEVELOPMENT CORPORATION

587 WASHINGTON STREET DORCHESTER, MA 02124

PREPARED BY:


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I. ALL DRAWINGS WILL BE UPDATED AND MODIFIED 2. ALL GENERAL DRAWINGS TO BE UPDATED INCLUDING REMOVAL OF HUNTER PANELS AND DOWNGRADING R VALUES TO CURRENT CODE. 3. WINDOW REQUIREMENTS TO BE DETERMINED LATER.

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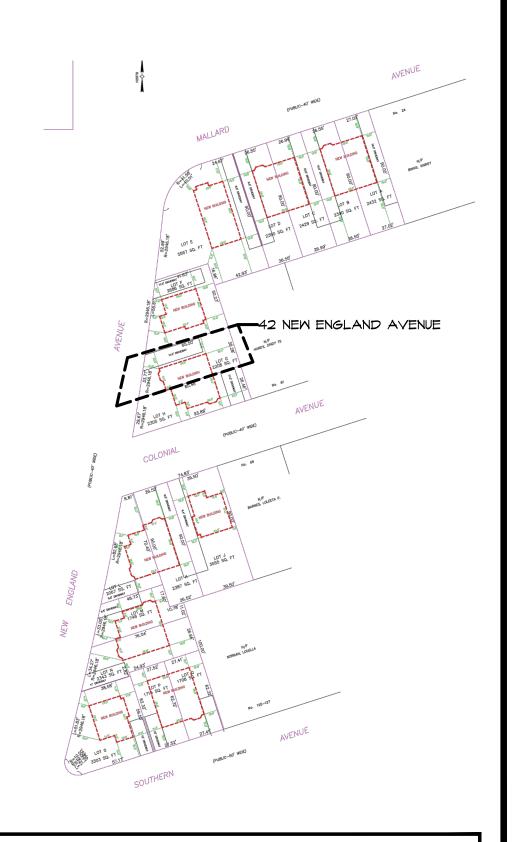
## 42 NEW ENGLAND AVENUE ( BUILDING E)

#### LIST OF DRAWINGS

G-2.I BATH PLANS & ELEVATIONS  G-3 WINDOWS & DOORS SCHEDULE	ARCHITEC'	TURAL INDEX OF DRAWINGS	ARCHITECT	TURAL INDEX OF DRAWINGS
T-I TITLE SHEET  G-I KICTHEN PLANS & ELEVATION  G-2.I BATH PLANS & ELEVATIONS  G-3 WINDOWS & DOORS SCHEDULE  G-4 FINISH SCHEDULE & PARTITION  G-5.I WALL SECTIONS  G-5.2 WALL SECTIONS  ARCHITECTURAL E UNIT  A-E.I BASEMENT & FIRST FLOOR PLAN  A-E.2 SECOND & THIRD FLOOR PLAN  G-6.1 GENERAL TYPICAL DETAILS  G-6.2 GENERAL TYPICAL DETAILS  G-6.3 WINDOWS & DOORS SCHEDULE  G-7.1 WALL SECTIONS  G-5.1 WALL SECTIONS  G-5.2 WALL SECTIONS  G-6.1 GENERAL TYPICAL DETAILS  G-6.2 GENERAL TYPICAL DETAILS  G-6.2 SECOND & THIRD FLOOR PLAN  G-6.2 SECOND & THIRD FLOOR PLAN  G-6.2 SECOND & THIRD FLOOR PLAN  G-6.2 SECOND &	NUMBER	DRAWING NAME	NUMBER	DRAWING NAME
G-2.I BATH PLANS & ELEVATIONS  G-2.I BATH PLANS & ELEVATIONS  G-3 WINDOWS & DOORS SCHEDULE  G-4 FINISH SCHEDULE & PARTITIONS  G-5.I WALL SECTIONS  G-5.2 WALL SECTIONS  ARCHITECTURAL E UNIT  A-E.I BASEMENT & FIRST FLOOR PLAN  A-E.2 SECOND & THIRD FLOOR PLAN  G-6.1 GENERAL TYPICAL DETAILS  G-6.2 GENERAL TYPICAL DETAILS  G-6.2 GENERAL TYPICAL DETAILS  G-6.2 GENERAL TYPICAL DETAILS  G-6.2 GENERAL TYPICAL DETAILS  G-6.3 WINDOWS & DOORS SCHEDULE  G-5.1 WALL SECTIONS  G-5.2 WALL SECTIONS  G-5.2 WALL SECTIONS  G-6.1 GENERAL TYPICAL DETAILS  GENERAL TYPICAL DETAILS  GENERAL TYPICAL DETAILS  G-6.2 GENERAL TYPICAL DETAILS  G-6.3 WINDOWS & DOORS SCHEDULE  G-5.1 GENERAL TYPICAL DETAILS  G-6.2 GENERAL TYPICAL DETAILS			GENERAL I	ORAMINGS
C-I EXISTING CONDITIONS BPP BUILDING PLOT PLAN  ARCHITECTURAL E UNIT A-E.I BASEMENT & FIRST FLOOR PLAN A-E.2 SECOND & THIRD FLOOR PLAN A-E.3 ROOF FLOOR PLANS A-E.4 EXTERIOR ELEVATIONS A-E.5 EXTERIOR ELEVATIONS BTRUCTURAL E UNIT C-E.I FOUNDATION & FIRST FRAMING PLAN C-S.2 SECOND & ATTIC FRAMING PLAN C-E.2 SECOND & ATTIC FRAMING PLAN C-E.2 SECOND & ATTIC FRAMING PLAN C-E.2 SECOND & ATTIC FRAMING PLAN	T-I	TITLE SHEET	<i>G</i> -I	KICTHEN PLANS & ELEVATIONS
C-I EXISTING CONDITIONS BPP BUILDING PLOT PLAN G-5.1 WALL SECTIONS G-5.2 WALL SECTIONS ARCHITECTURAL E UNIT A-E.I BASEMENT & FIRST FLOOR PLAN G-6.1 GENERAL TYPICAL DETAILS A-E.2 SECOND & THIRD FLOOR PLAN G-6.2 GENERAL TYPICAL DETAILS A-E.3 ROOF FLOOR PLANS A-E.4 EXTERIOR ELEVATIONS A-E.5 EXTERIOR ELEVATIONS BTRUCTURAL E UNIT G-E.I FOUNDATION & FIRST FRAMING PLAN G-6.2 SECOND & ATTIC FRAMING PLAN			G-2.I	BATH PLANS & ELEVATIONS
BPP BUILDING PLOT PLAN  G-5.1  WALL SECTIONS  G-5.2  WALL SECTIONS  ARCHITECTURAL E UNIT  A-E.I BASEMENT & FIRST FLOOR PLAN  A-E.2 SECOND & THIRD FLOOR PLAN  G-6.1 GENERAL TYPICAL DETAILS  G-6.2 GENERAL TYPICAL DETAILS  G-6.2 GENERAL TYPICAL DETAILS  G-6.2 GENERAL TYPICAL DETAILS  A-E.3 ROOF FLOOR PLANS  A-E.4 EXTERIOR ELEVATIONS  A-E.5 EXTERIOR ELEVATIONS  G-6.1 GENERAL TYPICAL DETAILS  G-6.2 SECOND & ATTIC FRAMING PLAN  G-6.3 GENERAL TYPICAL DETAILS  G-6.4 EXTERIOR ELEVATIONS  G-6.5 EXTERIOR ELEVATIONS  G-6.5 EXTERIOR ELEVATIONS  G-6.6 EXTERIOR ELEVATIONS  G-6.7 GENERAL TYPICAL DETAILS  G-6.8 GENERAL TYPICAL DETAILS  G-6.9 GENERAL TYPICAL DETAILS  G-6.1 GENERAL TYPICAL DETAILS  G-6.2 GENERAL TYPICAL DETAILS  G-6.3 GENERAL TYPICAL DETAILS  G-6.4 EXTERIOR ELEVATIONS  G-6.5 EXTERIOR ELEVATIONS  G-6.2 GENERAL TYPICAL DETAILS  G			6-3	MINDOMS & DOORS SCHEDULE
ARCHITECTURAL E UNIT  A-E.I BASEMENT & FIRST FLOOR PLAN  A-E.2 SECOND & THIRD FLOOR PLAN  A-E.3 ROOF FLOOR PLANS  A-E.4 EXTERIOR ELEVATIONS  A-E.5 EXTERIOR ELEVATIONS  BTRUCTURAL E UNIT  B-E.I FOUNDATION & FIRST FRAMING PLAN  B-E.2 SECOND & ATTIC FRAMING PLAN			6-4	FINISH SCHEDULE & PARTITION
ARCHITECTURAL E UNIT A-E.I BASEMENT & FIRST FLOOR PLAN G-6.I GENERAL TYPICAL DETAILS A-E.2 SECOND & THIRD FLOOR PLAN G-6.2 GENERAL TYPICAL DETAILS A-E.3 ROOF FLOOR PLANS A-E.4 EXTERIOR ELEVATIONS A-E.5 EXTERIOR ELEVATIONS BTRUCTURAL E UNIT B-E.I FOUNDATION & FIRST FRAMING PLAN B-E.2 SECOND & ATTIC FRAMING PLAN	BPP	BUILDING PLOT PLAN	<i>6-</i> 5.I	MALL SECTIONS
A-E.I BASEMENT & FIRST FLOOR PLAN G-6.I GENERAL TYPICAL DETAILS A-E.2 SECOND & THIRD FLOOR PLAN G-6.2 GENERAL TYPICAL DETAILS A-E.3 ROOF FLOOR PLANS A-E.4 EXTERIOR ELEVATIONS A-E.5 EXTERIOR ELEVATIONS BITRUCTURAL E UNIT B-E.I FOUNDATION & FIRST FRAMING PLAN B-E.2 SECOND & ATTIC FRAMING PLAN			G-5.2	MALL SECTIONS
A-E.2 SECOND & THIRD FLOOR PLAN  A-E.3 ROOF FLOOR PLANS  A-E.4 EXTERIOR ELEVATIONS  A-E.5 EXTERIOR ELEVATIONS  STRUCTURAL E UNIT  6-E.1 FOUNDATION & FIRST FRAMING PLAN  6-E.2 SECOND & ATTIC FRAMING PLAN	ARCHITECT	URAL E UNIT		
A-E.3 ROOF FLOOR PLANS A-E.4 EXTERIOR ELEVATIONS A-E.5 EXTERIOR ELEVATIONS BITRUCTURAL E UNIT B-E.I FOUNDATION & FIRST FRAMING PLAN B-E.2 SECOND & ATTIC FRAMING PLAN	<b>4-</b> E.I	BASEMENT & FIRST FLOOR PLAN	G-6.I	
A-E.4 EXTERIOR ELEVATIONS A-E.5 EXTERIOR ELEVATIONS BTRUCTURAL E UNIT B-E.I FOUNDATION & FIRST FRAMING PLAN B-E.2 SECOND & ATTIC FRAMING PLAN	4-E.2	SECOND & THIRD FLOOR PLAN	G-6.2	GENERAL TYPICAL DETAILS
A-E.5 EXTERIOR ELEVATIONS  STRUCTURAL E UNIT  S-E.I FOUNDATION & FIRST FRAMING PLAN  S-E.2 SECOND & ATTIC FRAMING PLAN	A-E.3	ROOF FLOOR PLANS		
STRUCTURAL E UNIT 5-E.I FOUNDATION & FIRST FRAMING PLAN 5-E.2 SECOND & ATTIC FRAMING PLAN	4-E.4	EXTERIOR ELEVATIONS		
5-E.I FOUNDATION & FIRST FRAMING PLAN 5-E.2 SECOND & ATTIC FRAMING PLAN	A-E.5	EXTERIOR ELEVATIONS		
5-E.2 SECOND & ATTIC FRAMING PLAN	STRUCTURA	L E UNIT		
	3-E.I	FOUNDATION & FIRST FRAMING PLAN		
5-E.3 ROOF FRAMING PLAN	5-E.2	SECOND & ATTIC FRAMING PLAN		
	5-E.3	ROOF FRAMING PLAN		
	E-E.I	BASEMENT ELECTRICAL FLOOR PLAN		

#### 42 NEW ENGLAND AVENUE ( BUILDING E

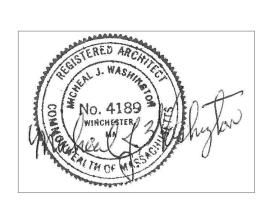REQUIRED	ACTUAL
6000 SF FOR 2 UNITS + 2500 PER ADDT'L UNIT	2,067 SF
40 FT	33.77 FT
40 FT	33.77 FT
0.4	0.69
2 1/2 STORY 35	35 FT
750 SF PER UNIT	1568 SQ. FT.
15FT/MOD.	11.9 FT
10 FT	13.8 FT
20 FT	22.1 FT
1/UNIT	1
	6000 SF FOR 2 UNITS + 2500 PER ADDT'L UNIT  40 FT  40 FT  0.4  2 1/2 STORY 35  750 SF PER UNIT  15FT/MOD.  10 FT  20 FT



## 72 COLONIAL AVENUE (BUILDING E)

## "NEW ENGLAND HERITAGE HOMES" AFFORDABLE HOMEOWNERSHIP DEVELOPMENT

PREPARED FOR:

## CODMAN SQUARE NEIGHBORHOOD DEVELOPMENT CORPORATION


587 WASHINGTON STREET DORCHESTER, MA 02124

PREPARED BY:

MICHEAL WASHINGTON ARCHITECTS, INC.

891 CENTRE ST. JAMAICA PLAIN, MA 02130 TEL: (617) 390-5515

EMAIL: mwainc1@hotmail.com

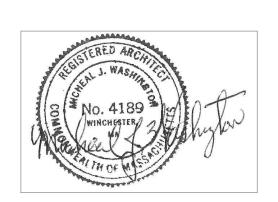

I. ALL DRAWINGS WILL BE UPDATED AND MODIFIED 2. ALL GENERAL DRAWINGS TO BE UPDATED INCLUDING REMOVAL OF HUNTER PANELS AND DOWNGRADING R VALUES TO CURRENT CODE. 3. WINDOW REQUIREMENTS TO BE DETERMINED LATER.

NOTES:

I. ALL WORK AND PERMITS AND APPROVALS WILL BE OBTAINED BY THE TRADE AND COORDINATED BY THE GENERAL CONTRACTOR AND THE OWNER. ALL WORK SHALL COMPLY WITH ALL PROVISIONS OF THE MASSACHUSETTS STATE BUILDING CODE, CURRENT EDITION, AND LOCAL CITY AND TOWN PROVISIONS.

- 2. ALL CONSTRUCTION IS TO COMPLY WITH THE MASSACHUSETTS STATE BUILDING CODE, EIGHTH EDITION AND WITH ALL SUPPLEMENTS, AMENDMENTS, AND OTHER APPLICABLE CODES AND REGULATIONS.
- 3. ALL ROOF INSULATION SHALL BE R-49; ALL WALLS SHALL BE R-21 AND IN COMPLIANCE WITH THE IECC REQUIREMENTS.ALLFIRST FLOOR AREAS R-30, IN COMPLIANCE WITH IBC REQUIREMENTS.
- 4. CONTRACTOR IS TO VERIFY ALL DIMENSION IN THE FIELD, NOTIFY ARCHITECT IF THERE ARE ANY VARIATIONS.

## 72 COLONIAL AVENUE ( BUILDING E)


#### LIST OF DRAWINGS

ARCHITECTURAL INDEX OF DRAWINGS ARCHITECTURAL INDEX OF DRAWINGS DRAWING NAME DRAWING NAME GENERAL DRAWINGS KICTHEN PLANS & ELEVATIONS TITLE SHEET BATH PLANS & ELEVATIONS WINDOWS & DOORS SCHEDULE FINISH SCHEDULE & PARTITION TYPES MALL SECTIONS WALL SECTIONS BASEMENT & FIRST FLOOR PLAN GENERAL TYPICAL DETAILS GENERAL TYPICAL DETAILS SECOND & THIRD FLOOR PLAN ROOF FLOOR PLANS EXTERIOR ELEVATIONS EXTERIOR ELEVATIONS FOUNDATION & FIRST FRAMING PLAN SECOND & ATTIC FRAMING PLAN ROOF FRAMING PLAN BASEMENT ELECTRICAL FLOOR PLAN

72 COLONIAL AVENUE		
ZONING INFORMATION		
ZONING: 3F-6000 WARD 14 1 FAMILY ATTACHED	REQUIRED	ACTUAL
MIN. LOT SIZE:	6000 SF FOR 2 UNITS + 2500 PER ADDT'L UNIT	2,067 SF
MIN. LOT WIDTH:	40 FT	8.81 FT
MIN. LOT FRONTAGE:	40 FT	8.81 FT
MAX. F.A.R:	0.4	0.77
MAX. BLDG. HEIGHT:	2 1/2 STORY 35	35 FT
MIN. OPEN SPACE:	750 SF PER UNIT	1495 SQ. FT.
MIN. FRONT YARD DEPTH:	15FT/MOD.	25.5 FT
MIN. SIDE YARD DEPTH:	10 FT 10 FT	8.8 FT
MIN. REAR YARD DEPTH:	20 FT	19.9 FT
MIN. PARKING:	1/UNIT	1

FIRST & SECOND ELECTRICAL FLOOR PLAN

THIRD ELECTRICAL FLOOR PLAN

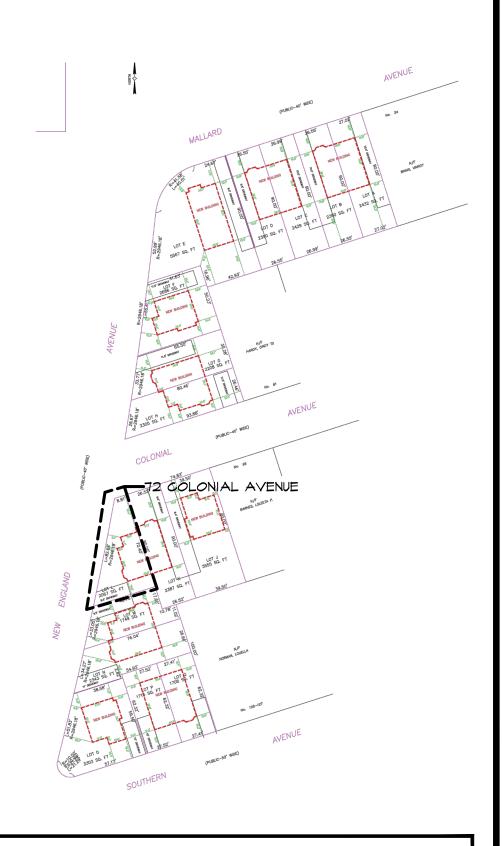

## 70 COLONIAL AVENUE (BUILDING E) "NEW ENGLAND HERITAGE HOMES" AFFORDABLE HOMEOWNERSHIP DEVELOPMENT

PREPARED FOR:

## CODMAN SQUARE NEIGHBORHOOD DEVELOPMENT CORPORATION


587 WASHINGTON STREET DORCHESTER, MA 02124

PREPARED BY:

MICHEAL WASHINGTON ARCHITECTS, INC.

891 CENTRE ST. JAMAICA PLAIN, MA 02130 TEL: (617) 390-5515

EMAIL: mwainc1@hotmail.com

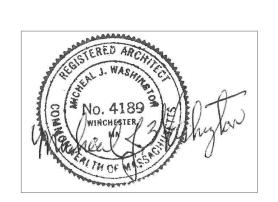

I. ALL DRAWINGS WILL BE UPDATED AND MODIFIED 2. ALL GENERAL DRAWINGS TO BE UPDATED INCLUDING REMOVAL OF HUNTER PANELS AND DOWNGRADING R VALUES TO CURRENT CODE. 3. WINDOW REQUIREMENTS TO BE DETERMINED LATER.

NOTES:

I. ALL WORK AND PERMITS AND APPROVALS WILL BE OBTAINED BY THE TRADE AND COORDINATED BY THE GENERAL CONTRACTOR AND THE OWNER. ALL WORK SHALL COMPLY WITH ALL PROVISIONS OF THE MASSACHUSETTS STATE BUILDING CODE, CURRENT EDITION, AND LOCAL CITY AND TOWN PROVISIONS.

2. ALL CONSTRUCTION IS TO COMPLY WITH THE MASSACHUSETTS STATE BUILDING CODE, EIGHTH EDITION AND WITH ALL SUPPLEMENTS, AMENDMENTS, AND OTHER APPLICABLE CODES AND REGULATIONS.

3. ALL ROOF INSULATION SHALL BE R-49; ALL WALLS SHALL BE R-21 AND IN COMPLIANCE WITH THE IECC REQUIREMENTS.ALLFIRST FLOOR AREAS R-30, IN COMPLIANCE WITH IBC REQUIREMENTS.

4. CONTRACTOR IS TO VERIFY ALL DIMENSION IN THE FIELD, NOTIFY ARCHITECT IF THERE ARE ANY VARIATIONS.

#### 70 COLONIAL AVENUE ( BUILDING E)


#### LIST OF DRAWINGS


ARCHITEC	TURAL INDEX OF DRAWINGS	ARCHITECT	URAL INDEX OF DRAWINGS
NUMBER	DRAMING NAME	NUMBER	DRAWING NAME
		GENERAL I	ORAMINGS
T-I	TITLE SHEET	<b>G-</b> I	KICTHEN PLANS & ELEVATION
		<b>6-2</b> .l	BATH PLANS & ELEVATIONS
		<i>6</i> -3	WINDOWS & DOORS SCHEDI
C-I	EXISTING CONDITIONS	6-4	FINISH SCHEDULE & PARTIT
BPP	BUILDING PLOT PLAN	<i>G-</i> 5.I	MALL SECTIONS
		<i>G</i> -5.2	MALL SECTIONS
ARCHITECT	TURAL E UNIT		
A-E.I	BASEMENT & FIRST FLOOR PLAN	G-6.I	GENERAL TYPICAL DETAILS
A-E.2	SECOND & THIRD FLOOR PLAN	G-6.2	GENERAL TYPICAL DETAILS
A-E.3	ROOF FLOOR PLANS		
A-E.4	EXTERIOR ELEVATIONS		
A-E.5	EXTERIOR ELEVATIONS		
STRUCTURA	L E UNIT		
9-E.I	FOUNDATION & FIRST FRAMING PLAN		
5-E.2	SECOND & ATTIC FRAMING PLAN		
5-E.3	ROOF FRAMING PLAN		

#### 70 COLONIAL AVENUE

70 00E0M/NE 7WEMOE		
ZONING INFORMATION		
ZONING: 3F-6000 WARD 14 1 FAMILY ATTACHED	REQUIRED	ACTUAL
LOT SIZE:	6000 SF FOR 2 UNITS + 2500 PER ADDT'L UNIT	2,387 SF
LOT WIDTH:	40 FT	26.52 FT
LOT FRONTAGE:	40 FT	26.52 FT
F.A.R:	0.4	0.67
BLDG. HEIGHT:	2 1/2 STORY 35	35 FT
OPEN SPACE:	750 SF PER UNIT	1747 SQ. FT.
FRONT YARD DEPTH:	15FT/MOD.	25.5 FT
SIDE YARD DEPTH:	10 FT 10 FT	10 FT
REAR YARD DEPTH:	20 FT	27.6 FT
PARKING:	1/UNIT	1



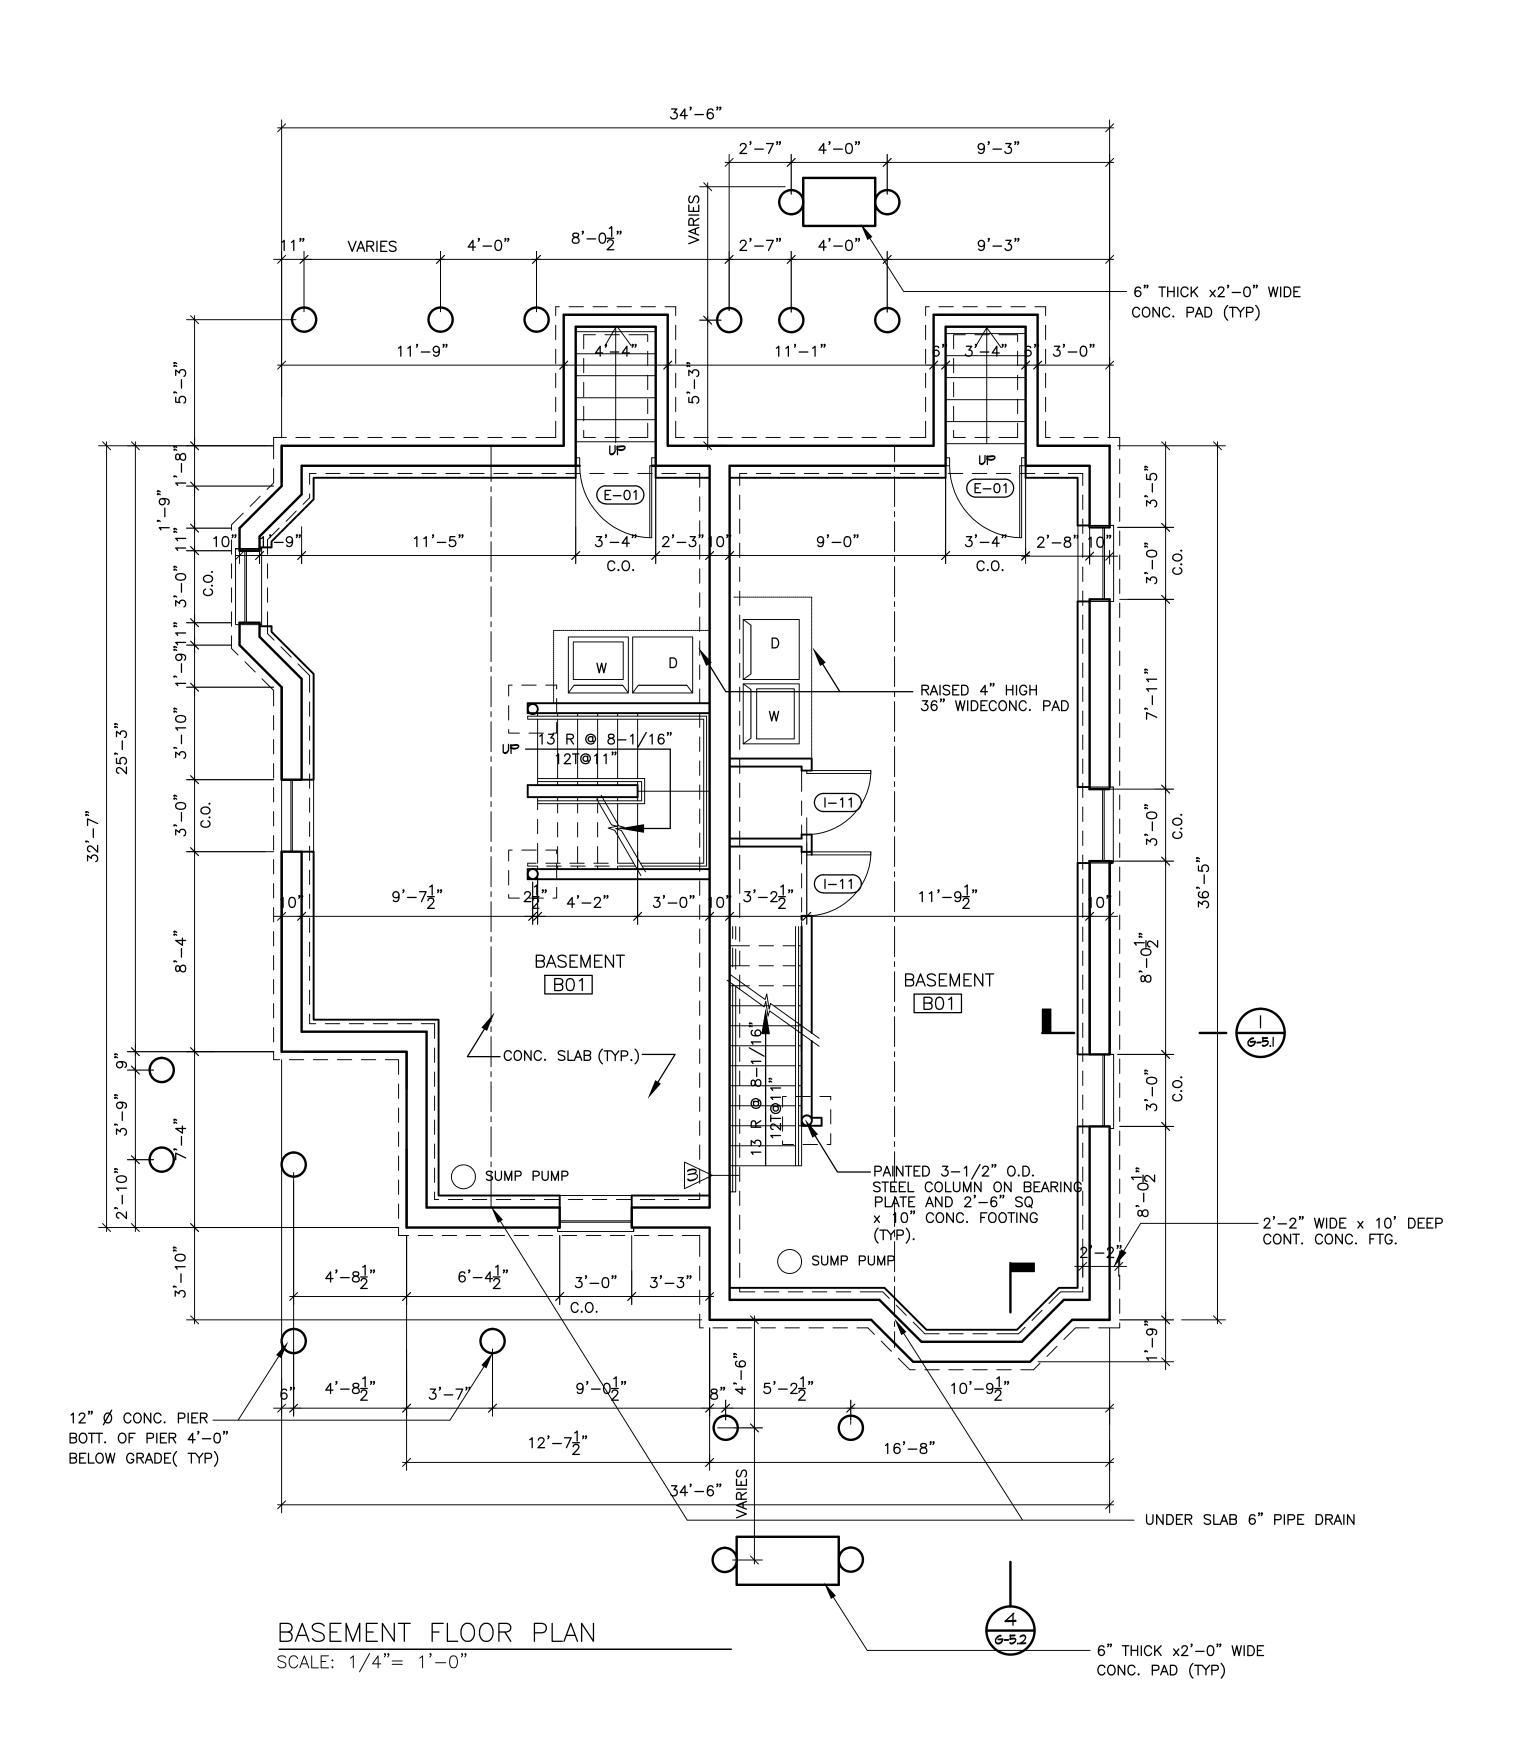

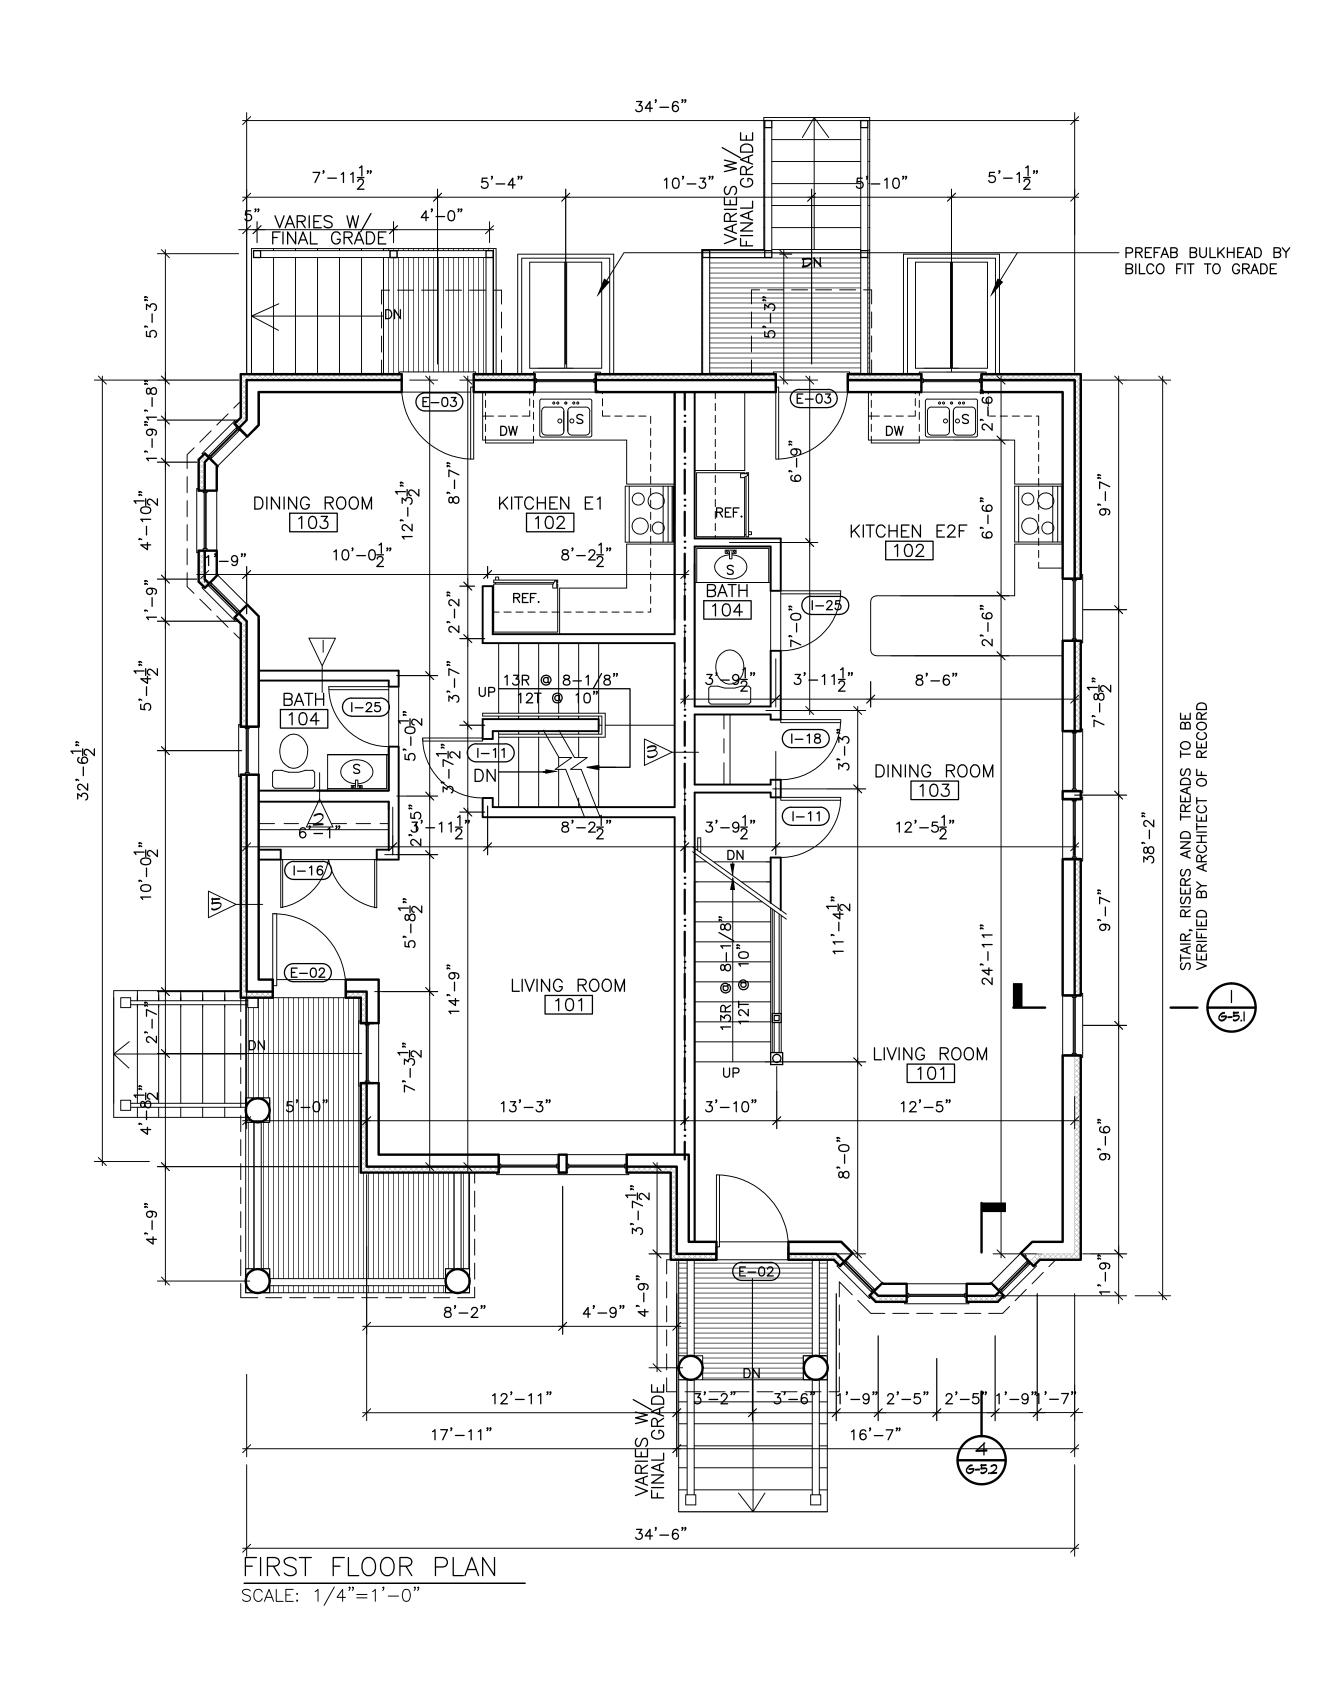

# Micheal Washington Architects Inc.

891 Centre Street Jamaica Plain, MA 02130

Phone: 617-390-5515 E-MAIL: MWAINC1@HOTMAIL.COM

PROJECT

#### NEW ENGLAND HERITAGE HOMES

DORCHESTER, MASSACHUSETTS

DEVELOPER

## CODMAN SQUARE NEIGHBORHOOD DEVELOPMENT CORPORATION

DORCHESTER, MASSACHUSETTS

LEGEND:

TWO HOUR RATED PARTITION

ONE HOUR RATED PARTITION


NOTES

I. SEE G-4 FOR PARTITION TYPES.

2. SEE GA-I FOR ENLARGED KITCHEN PLANS AND ELEVATIONS.

3. DIMENSIONS ARE TO EXTERIOR FACE OF EXTERIOR STUD WALL AND EXTERIOR FACE OF FOUNDATION WALL.

4. DIMENSIONS ARE TO CENTERLINE OF STUDS ON INTERIOR WALLS UNLESS OTHERWISE NOTED.

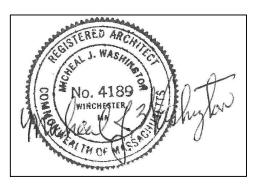

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SHEET TITLE

## TYPE E- CORNER DUPLEX BASEMENT & FIRST FLOOR PLAN

SEE SITE ON COVER PAGE FOR ADDRESS AND UNIT LOCATION


LE: 1/4"=1'-0" E: 12/01/2015

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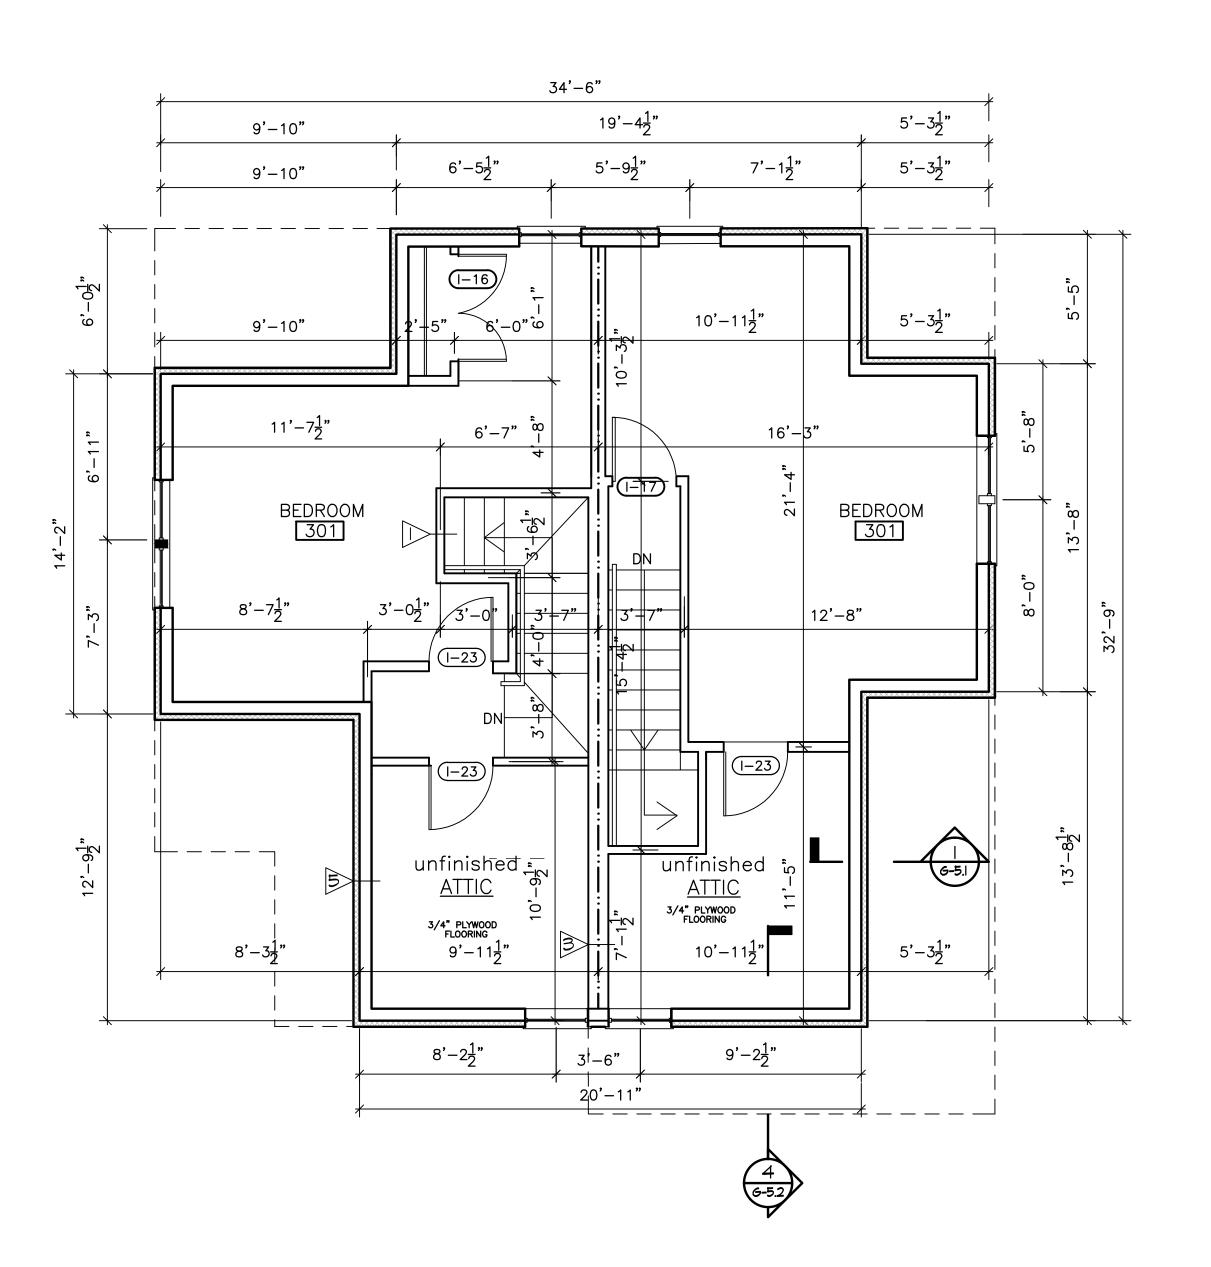
DRAWN BY:

CHECKED BY: MW

**A-E.1** 

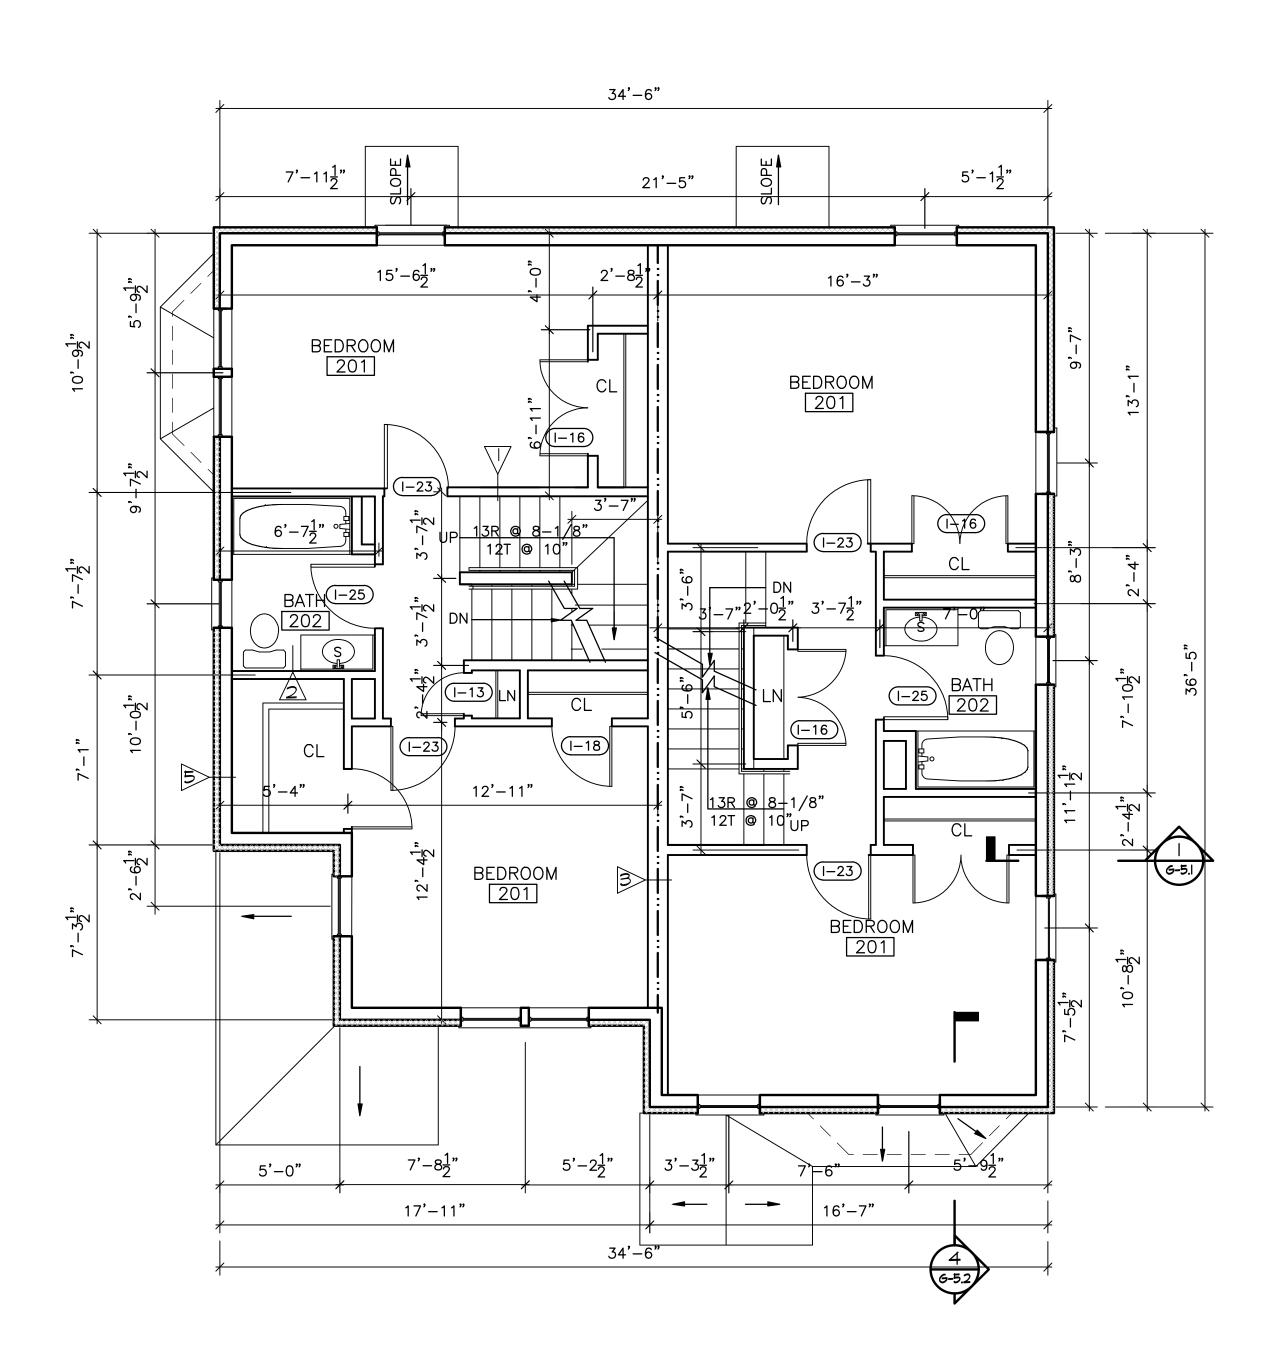

SECOND FLOOR PLAN
SCALE: 1/4"=1'-0"



THIRD FLOOR PLAN

SCALE: 1/4"= 1'-0"

## Micheal Washington Architects Inc.

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PROJECT

#### NEW ENGLAND HERITAGE HOMES

DORCHESTER, MASSACHUSETTS

DEVELOPE

## CODMAN SQUARE NEIGHBORHOOD DEVELOPMENT CORPORATION

DORCHESTER, MASSACHUSETTS

LEGEND:

TWO HOUR RATED PARTITION

ONE HOUR RATED PARTITION

NOTES

I. SEE 6-4 FOR PARTITION TYPES.

2. SEE GA-I FOR ENLARGED KITCHEN PLANS AND ELEVATIONS.

3. DIMENSIONS ARE TO EXTERIOR FACE OF EXTERIOR STUD WALL AND EXTERIOR FACE OF FOUNDATION WALL.

4. DIMENSIONS ARE TO CENTERLINE OF STUDS ON INTERIOR WALLS UNLESS OTHERWISE NOTED.



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SHEET TITLE

## TYPE E- CORNER DUPLEX SECOND & THIRD FLOOR PLAN

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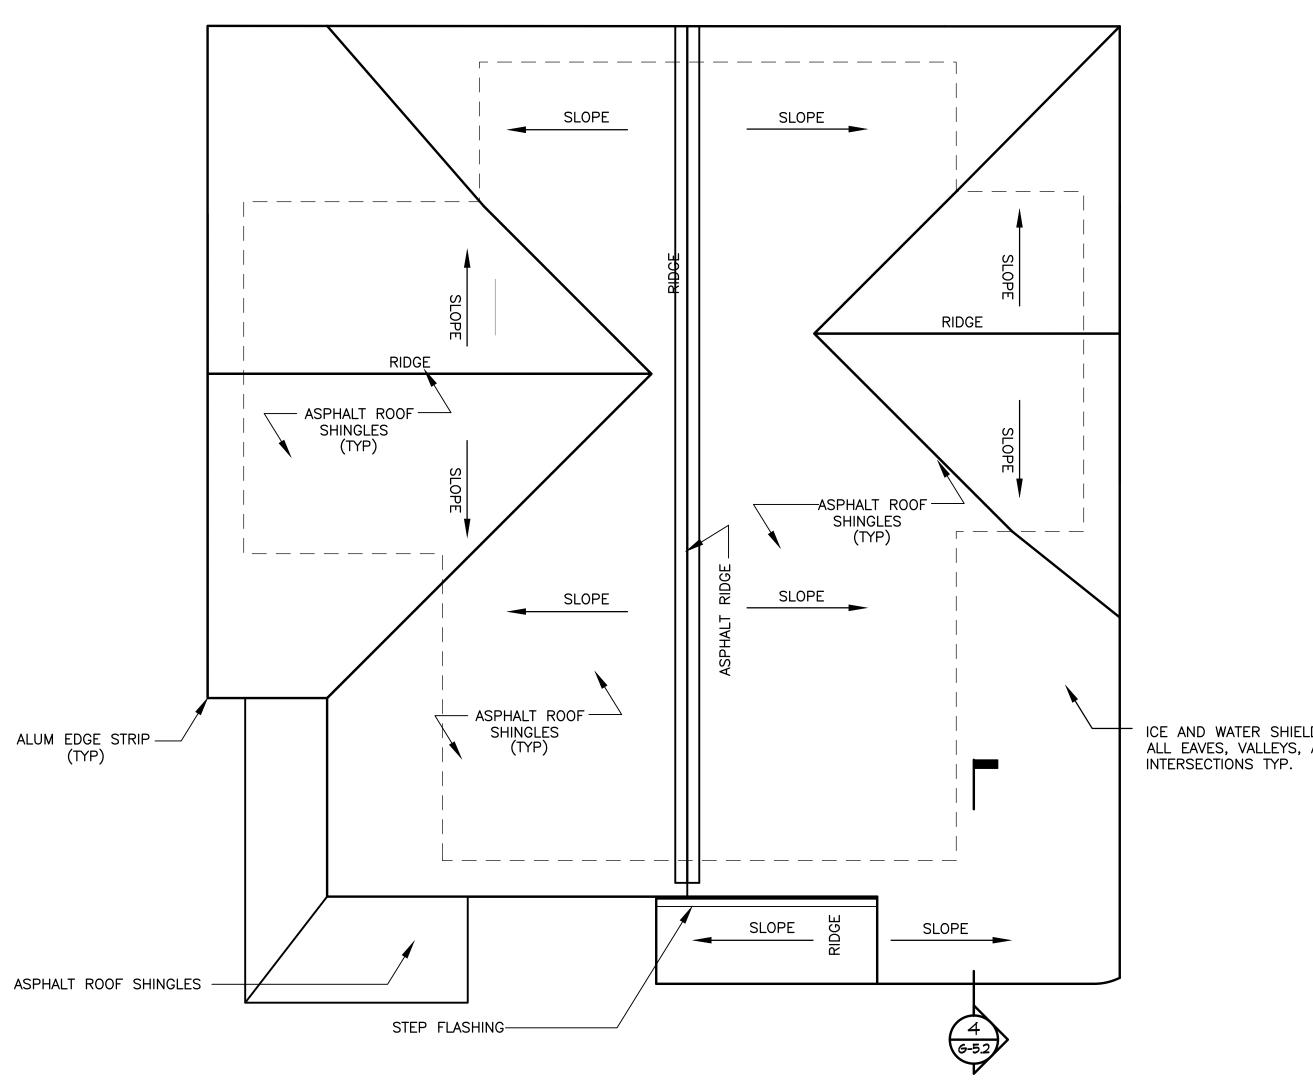
SCALE: 1/4"=1'-0

OATE: 12/01/201

FILE: NEHH.dwg

12/01/2015 BY:

**A-E.2** 



ICE AND WATER SHIELD 30" @ ALL EAVES, VALLEYS, AND INTERSECTIONS TYP.

ROOF PLAN
SCALE: 1/4"=1'-0"

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PROJECT

#### **NEW ENGLAND HERITAGE HOMES**

DORCHESTER, MASSACHUSETTS

#### **CODMAN SQUARE NEIGHBORHOOD DEVELOPMENT** CORPORATION

DORCHESTER, MASSACHUSETTS

LEGEND:

TWO HOUR RATED PARTITION


ONE HOUR RATED PARTITION

I. SEE G-4 FOR PARTITION TYPES.

2. SEE GA-I FOR ENLARGED KITCHEN PLANS AND ELEVATIONS.

3. DIMENSIONS ARE TO EXTERIOR FACE OF EXTERIOR STUD WALL AND EXTERIOR FACE OF FOUNDATION WALL.

4. DIMENSIONS ARE TO CENTERLINE OF STUDS ON INTERIOR WALLS UNLESS OTHERWISE NOTED.

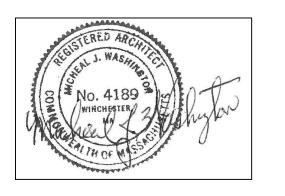

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SHEET TITLE

## **TYPE E- CORNER DUPLEX**


**ROOF PLAN** 


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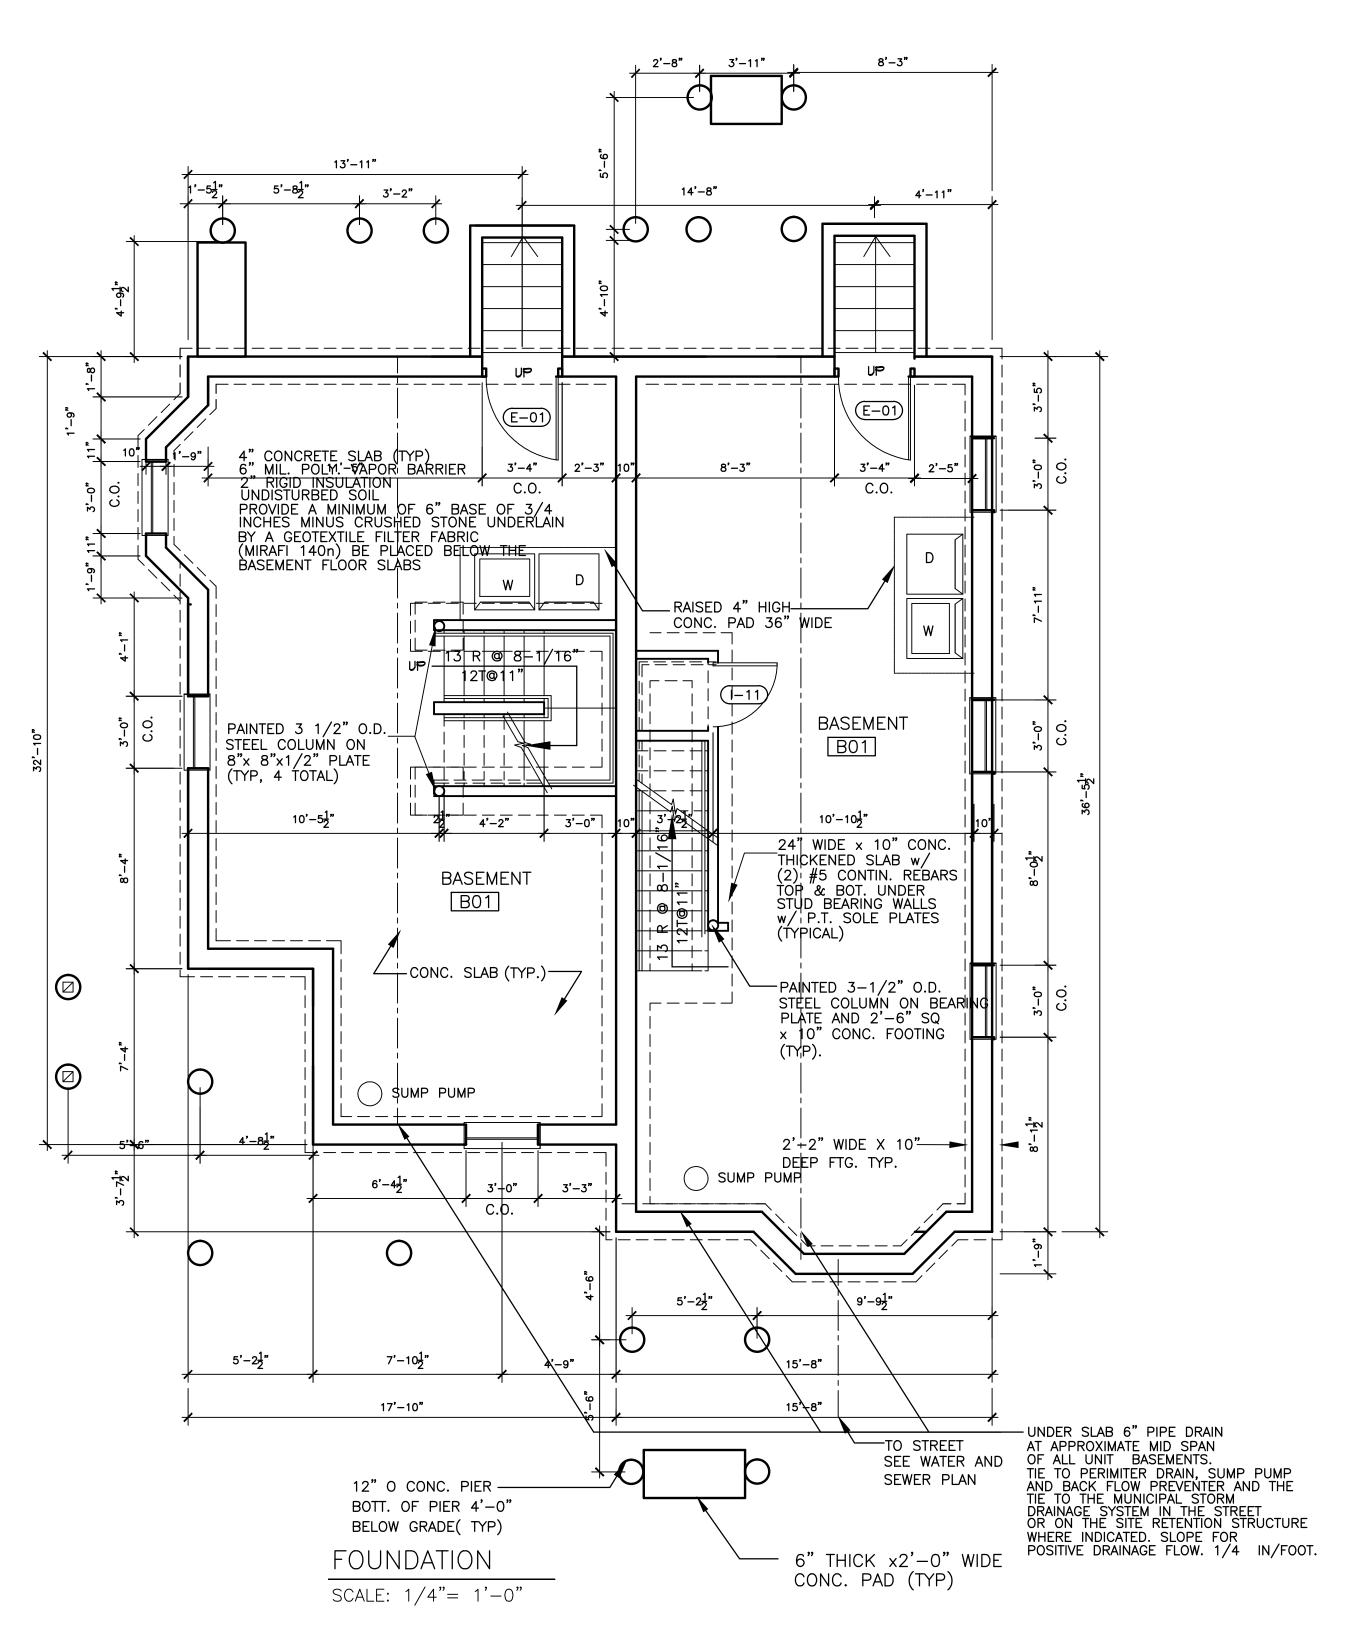
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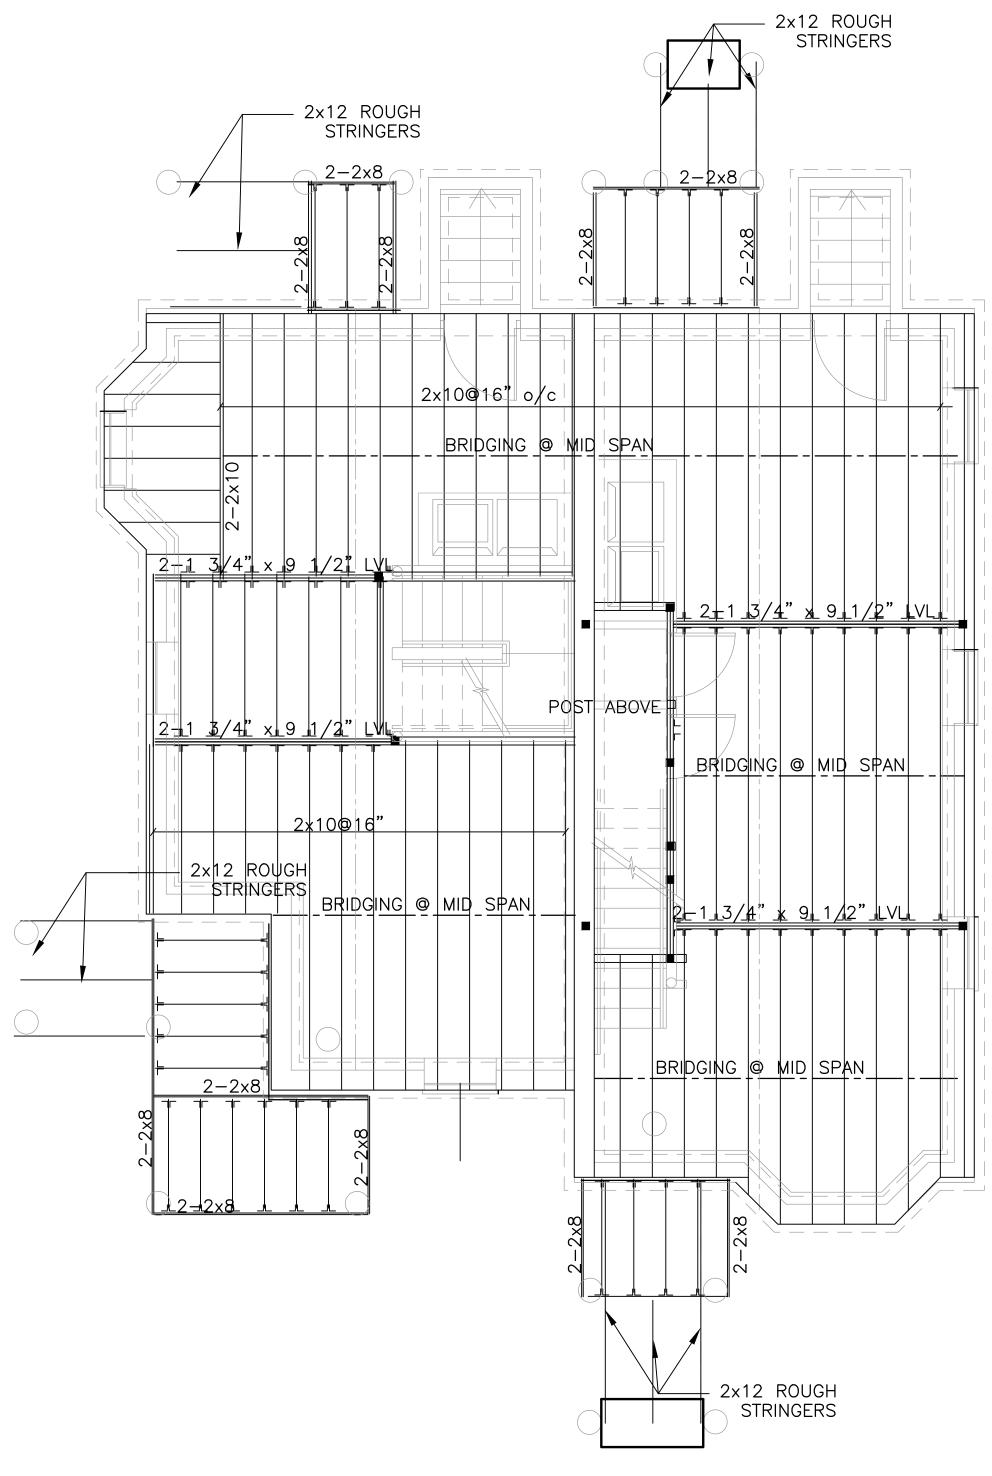
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#### 1ST FLOOR FRAMING PLAN

SCALE: 1/4"=1'-0"

G.C. SHALL INSTALL ALL REQUIRED FLU STOPPINGS

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PROJECT
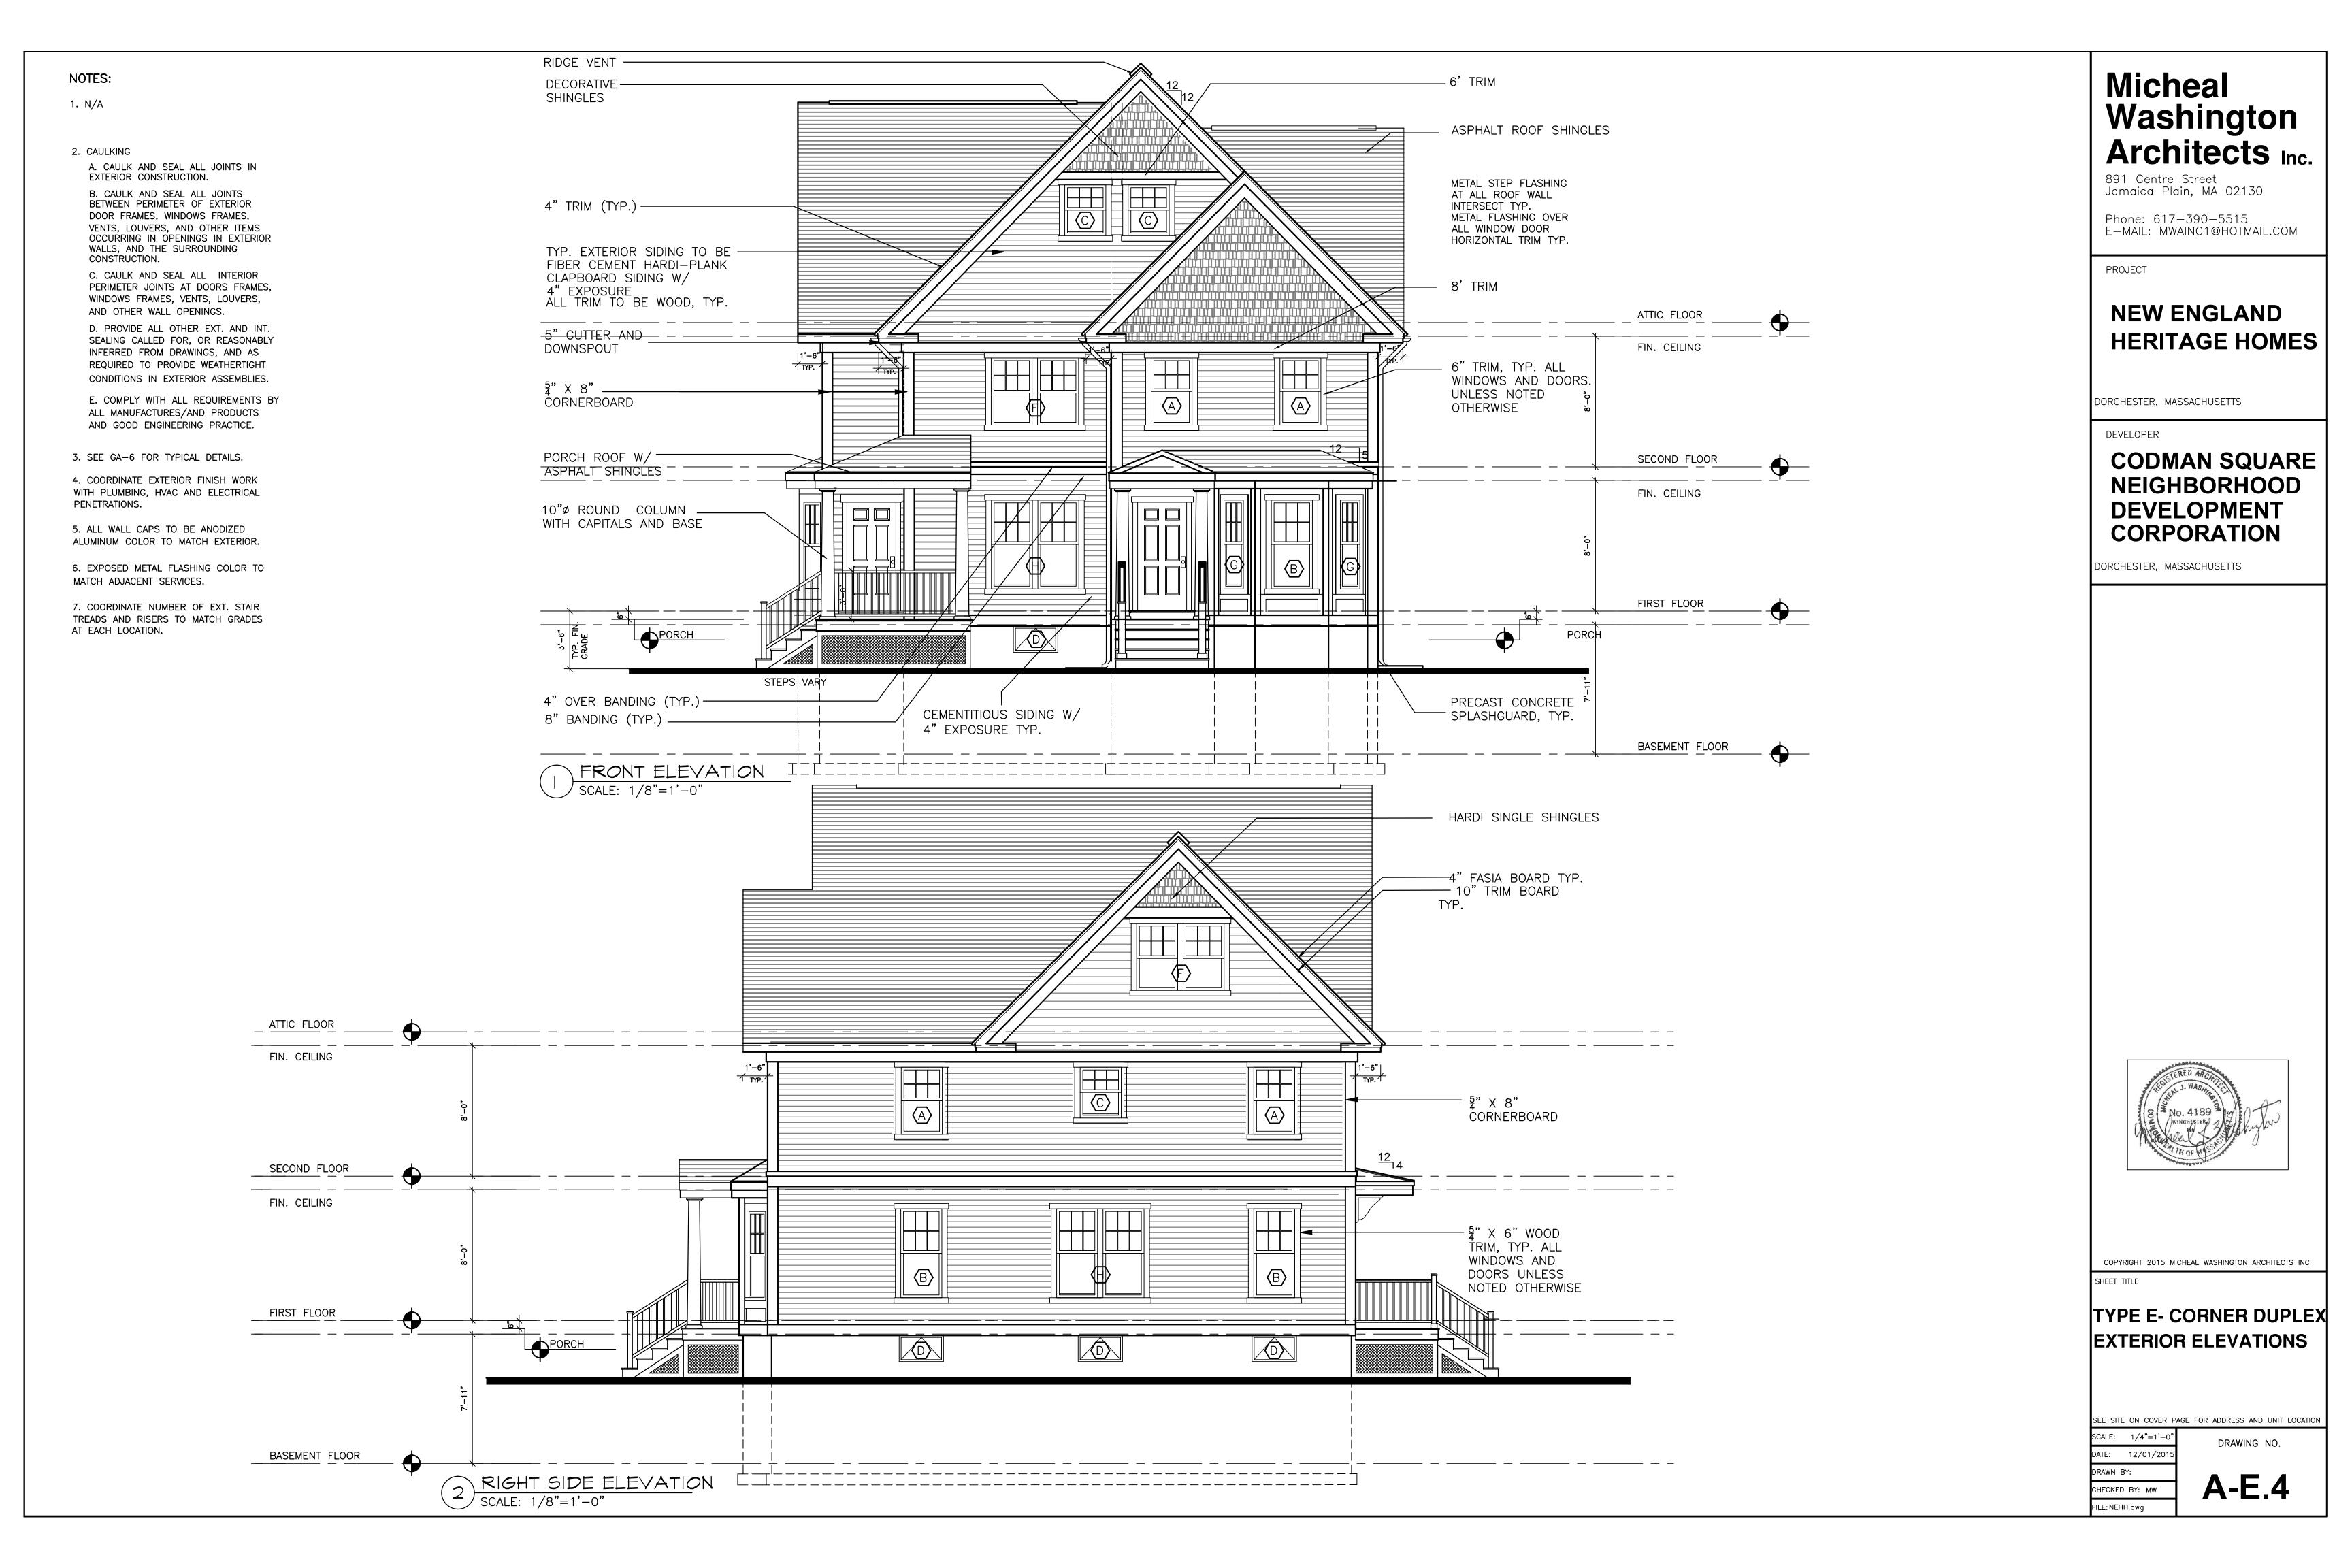
#### NEW ENGLAND HERITAGE HOMES

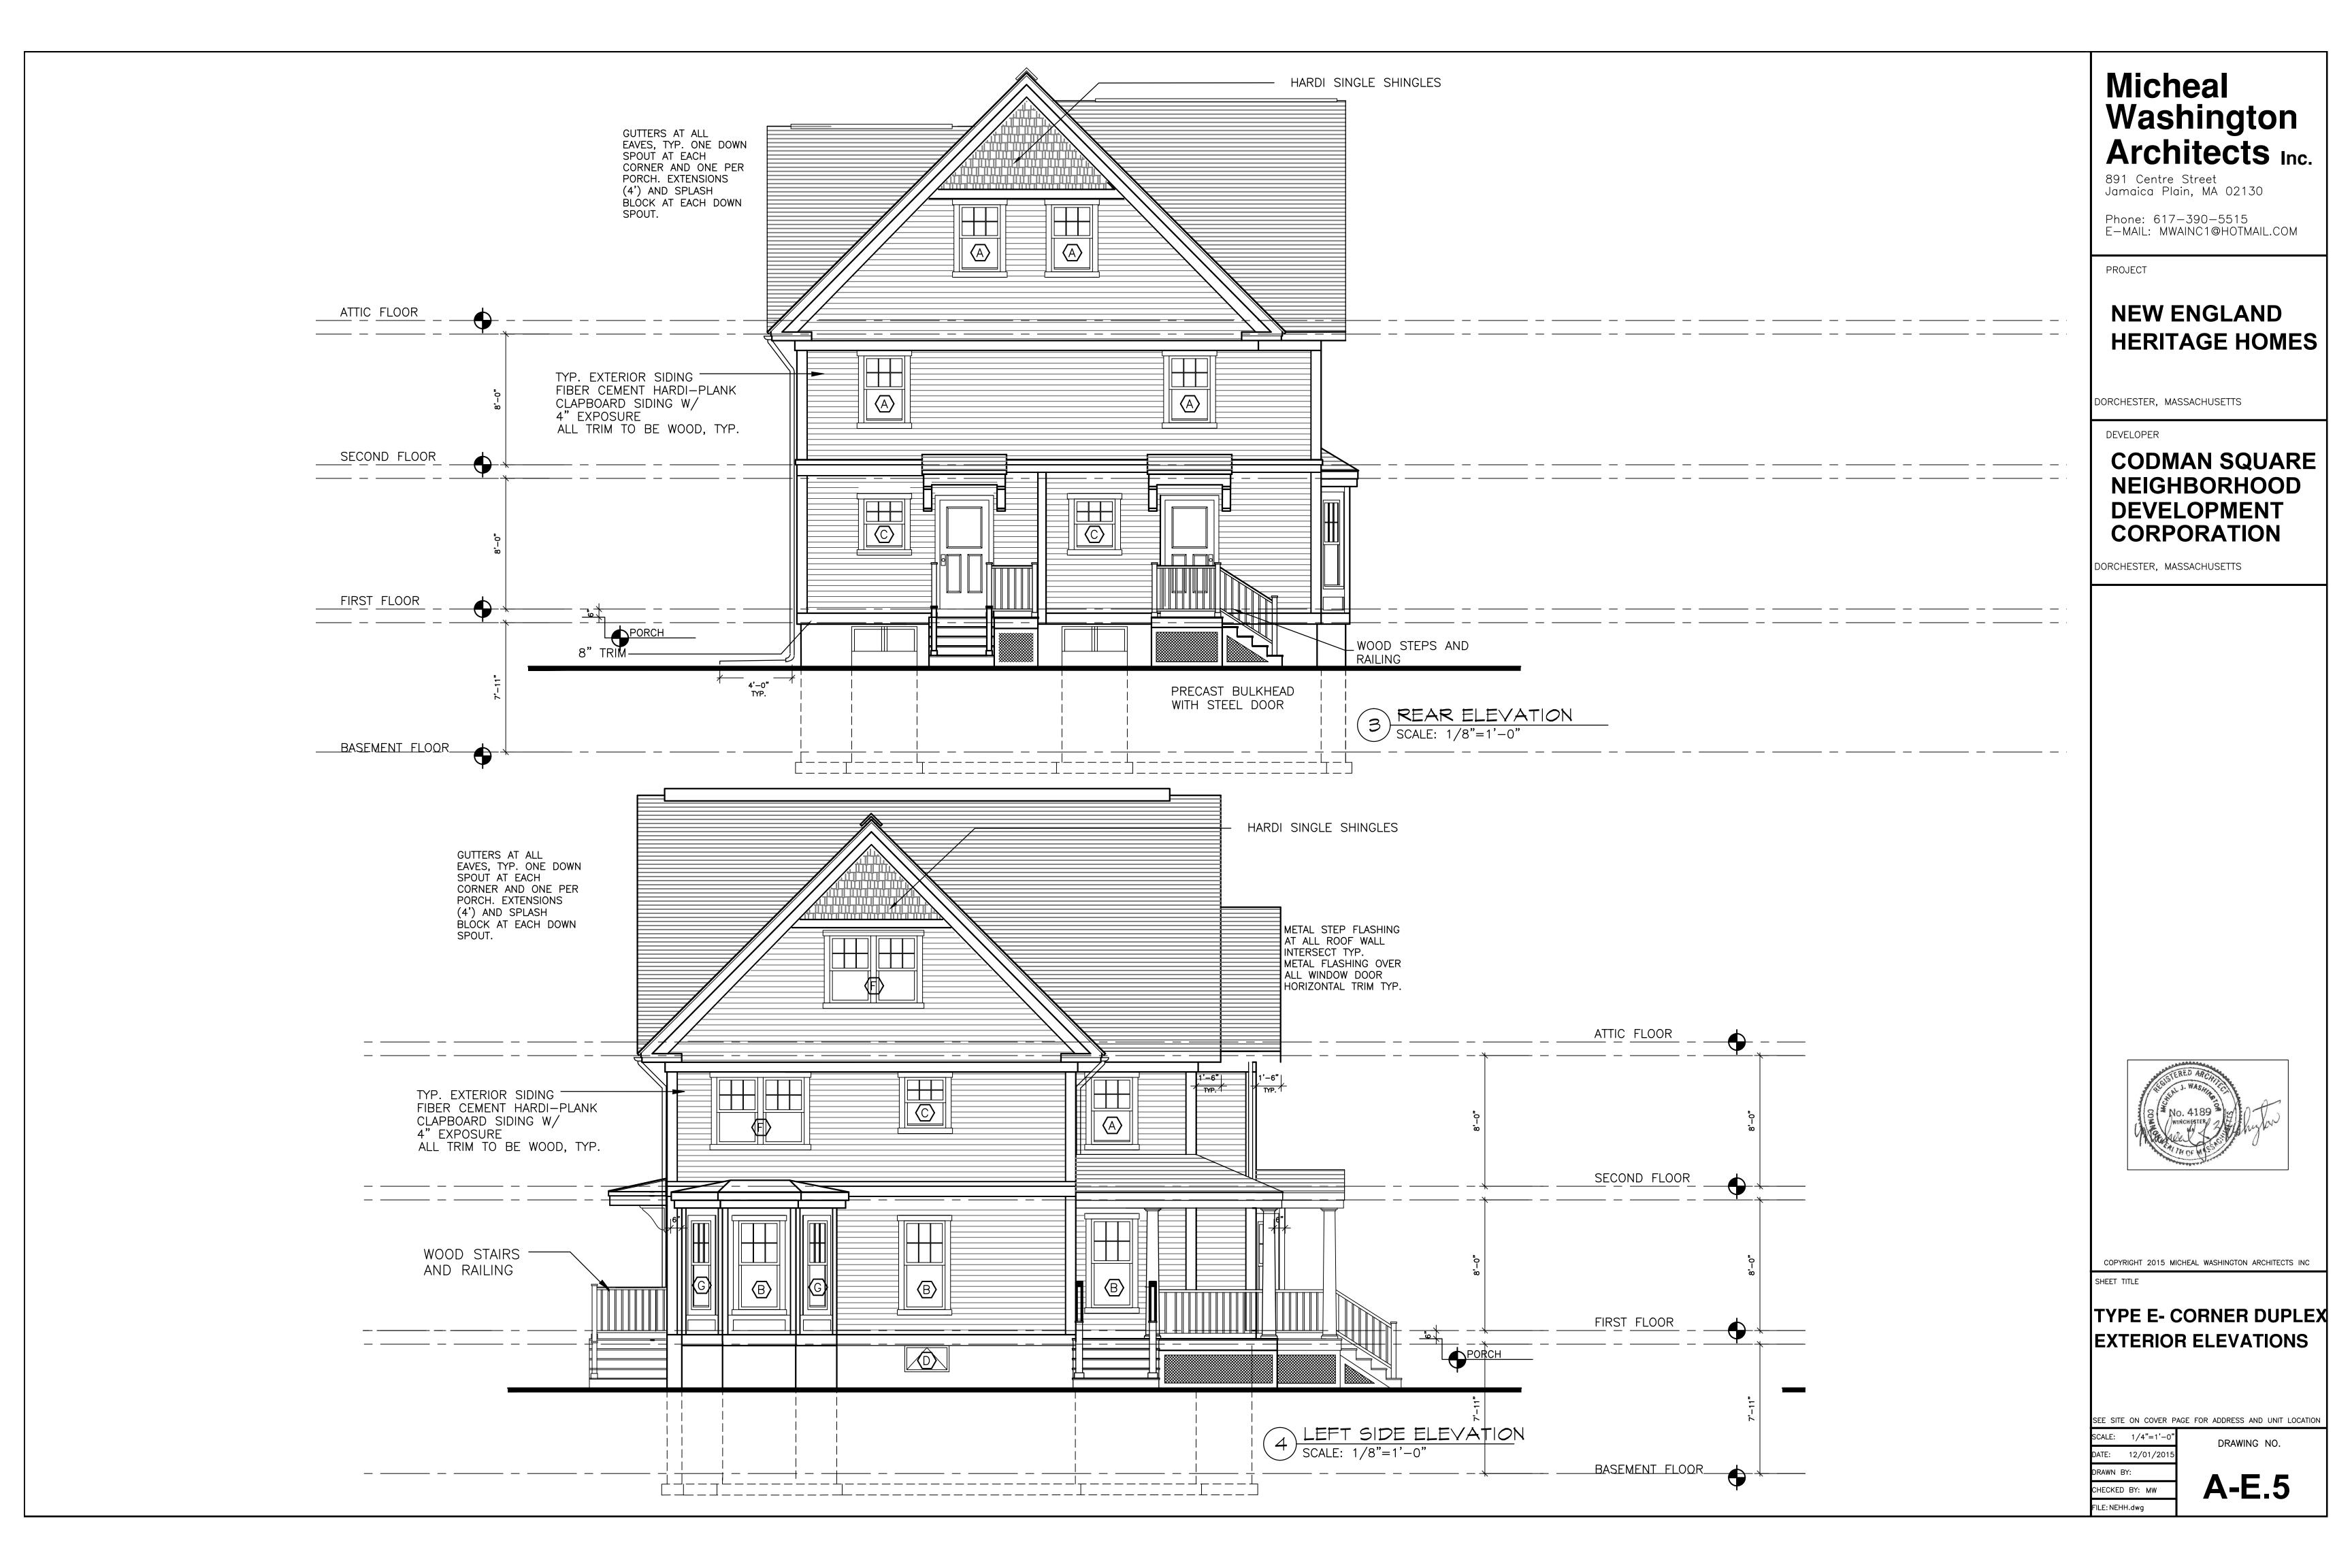DORCHESTER, MASSACHUSETTS


DEVELOPE

## CODMAN SQUARE NEIGHBORHOOD DEVELOPMENT CORPORATION

DORCHESTER, MASSACHUSETTS

NOT

1. ALL FRAMING AND STRUCTURAL DESIGN MEMBER, SIZES AND ELEMENTS TO BE CONFIRMED BY FINAL ARCHITECT AND ENGINEER OF RECORD.

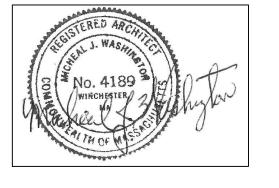

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SHEET TITLE


## FOUNDATION & 1ST FLOOR FRAMING PLAN


SEE SITE ON COVER PAGE FOR ADDRESS AND UNIT LOCATION

SCALE: 1/4"=1'-0"

DATE: 12/01/2015

CHECKED BY: MW FILE: NEHH.dwg S-E.1

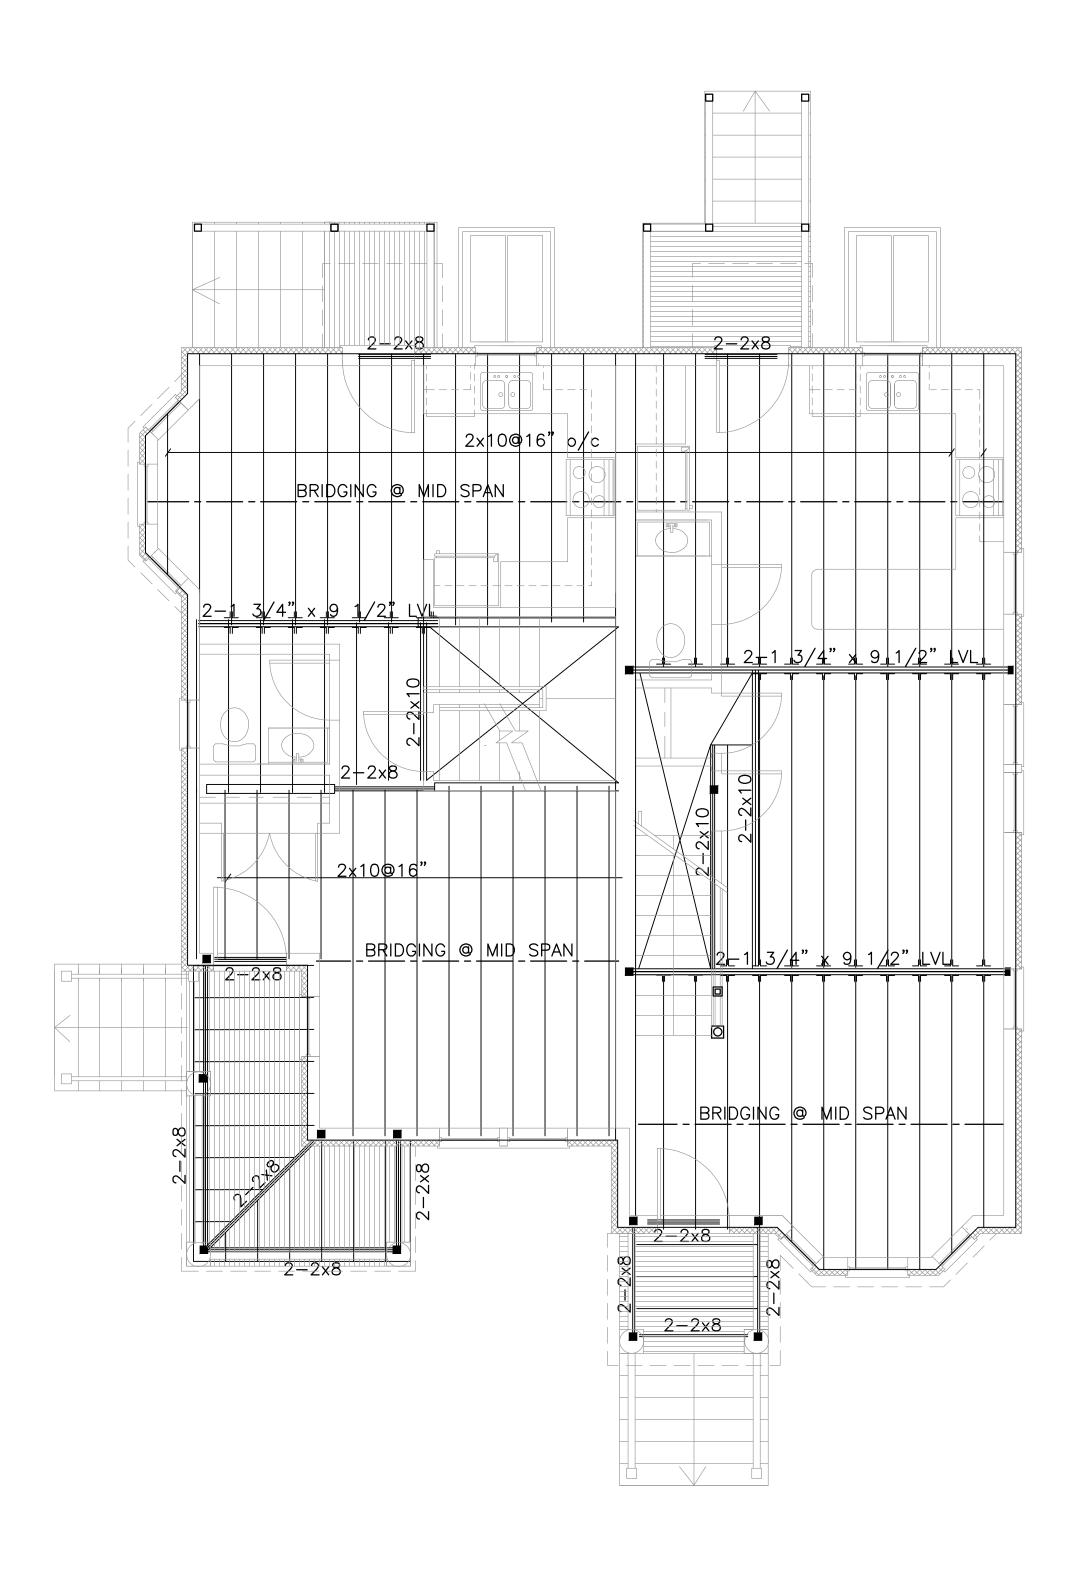

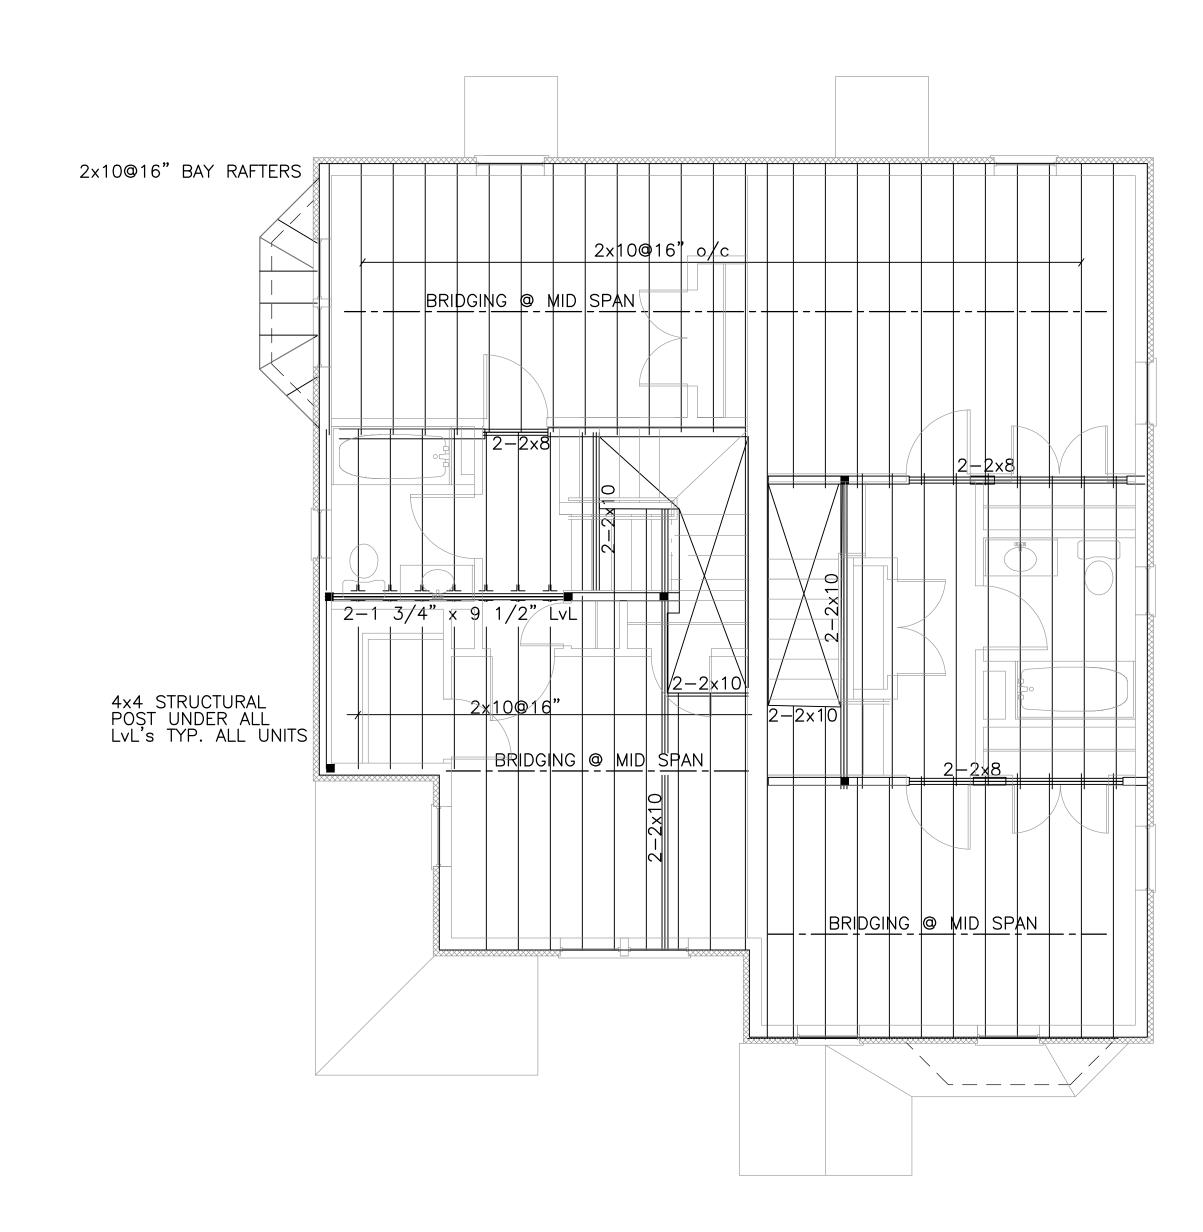

2ND FLOOR FRAMING PLAN

SCALE: 1/4"=1'-0"

ATTIC FRAMING PLAN

SCALE: 1/4"=1'-0"

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PROJECT


#### NEW ENGLAND HERITAGE HOMES

DORCHESTER, MASSACHUSETTS

DEVELOPER

## CODMAN SQUARE NEIGHBORHOOD DEVELOPMENT CORPORATION

DORCHESTER, MASSACHUSETTS

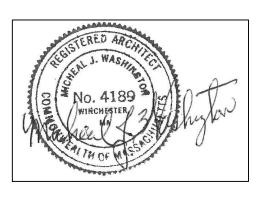

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SHEET TITLE


2ND & ATTIC FLOOR FRAMING PLANS

SEE SITE ON COVER PAGE FOR ADDRESS AND UNIT LOCATION

SCALE: 1/4"=1'-0" DATE: 12/01/201

DRAWING NO.

**S-E.2** 

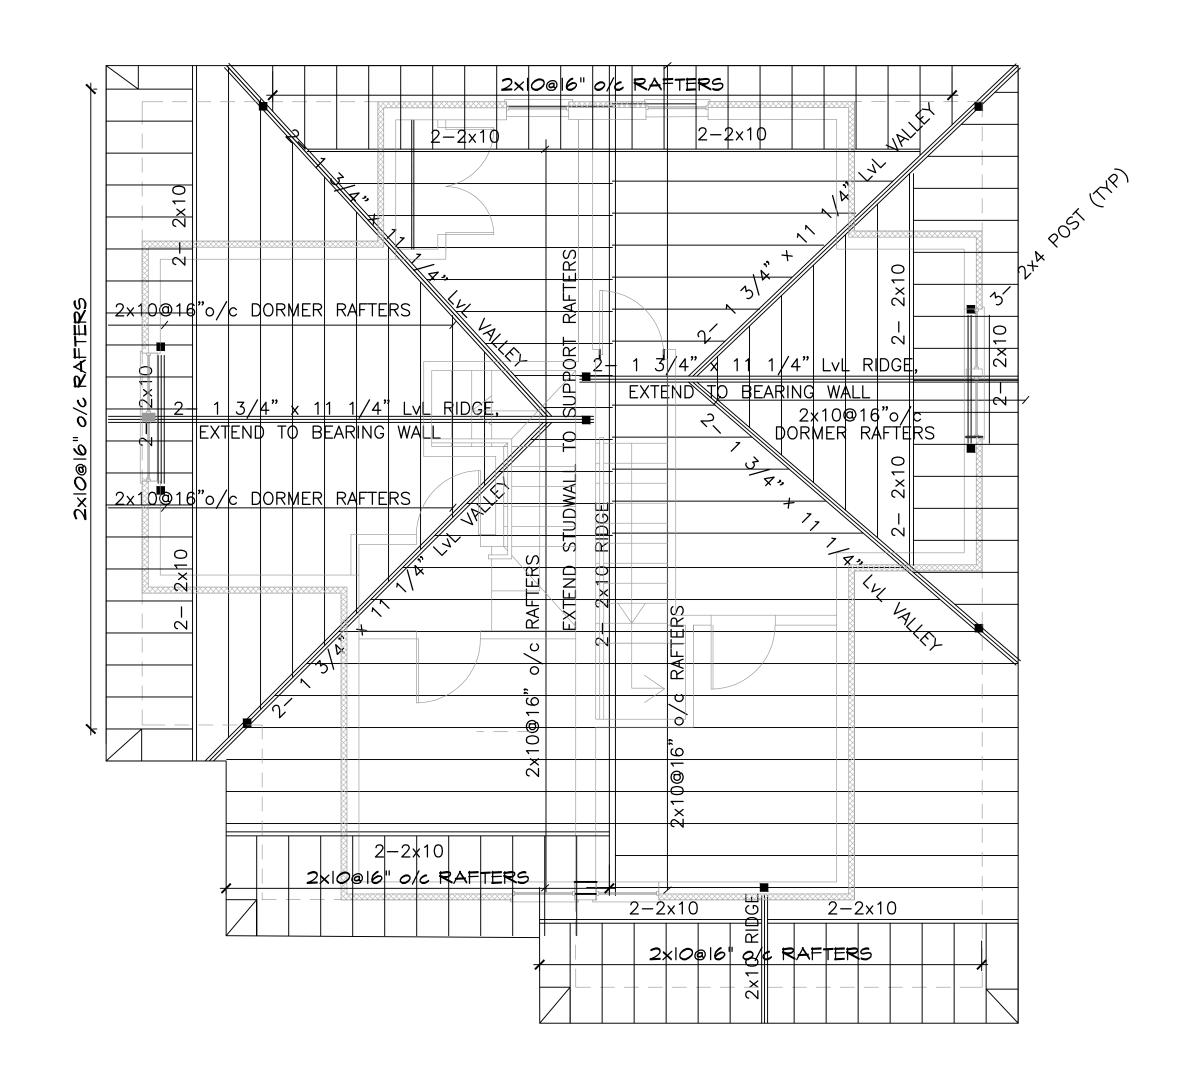

ROOF FRAMING PLAN
SCALE: 1/4"=1'-0"

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PROJECT


#### NEW ENGLAND HERITAGE HOMES

DORCHESTER, MASSACHUSETTS

DEVELOPER

## CODMAN SQUARE NEIGHBORHOOD DEVELOPMENT CORPORATION

DORCHESTER, MASSACHUSETTS

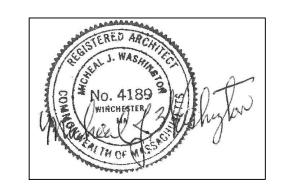

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SHEET TIT


#### ROOF FRAMING PLAN

SEE SITE ON COVER PAGE FOR ADDRESS AND UNIT LOCATION

ALE: 1/4"=1'-0" TE: 12/01/2015

DRAWING NO.

**S-E.3** 

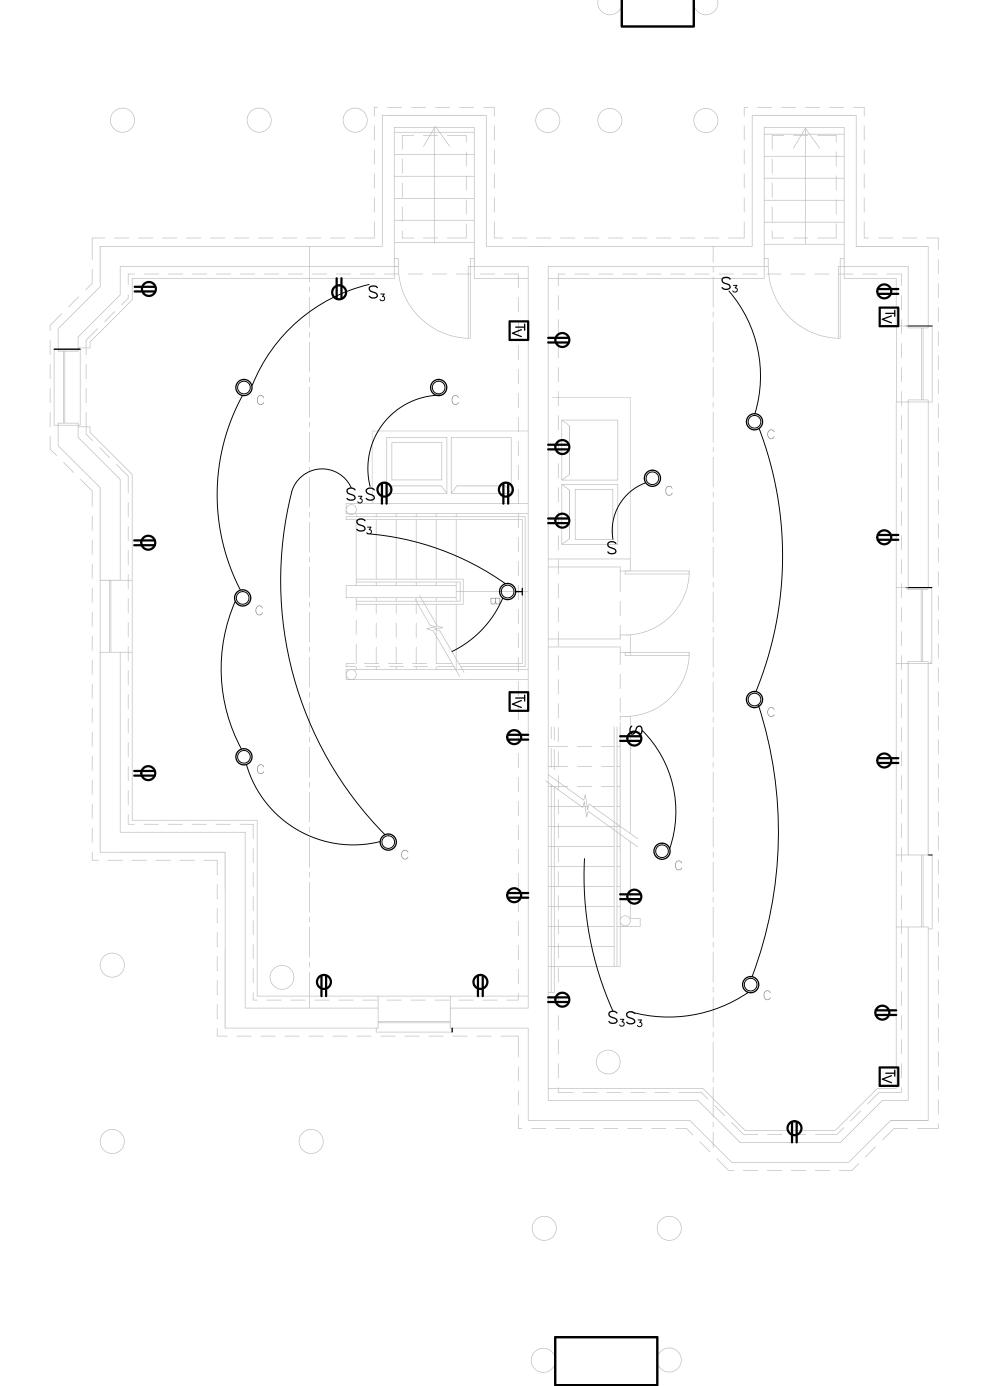

BASEMENT ELECTRICAL PLAN

SCALE: 1/4"=1'-0"

DUPLEX RECEPTACLE, 120V,18" AFF., ONE OUTLET SWITCHED  120V DOUBLE DUPLEX CONVENIENCE RECEPTACLE  DUPLEX RECEPTACLE ABOVE COUNTER, 8" ABOVE COUNTER TO Q.	0	CEILING MOUNTED LIGHT FIXTURE.  WALL MOUNTED LIGHT FIXTURE.
S SINGLE POLE LIGHT SWITCH  S <sub>3</sub> THREE—WAY LIGHT SWITCHES  S <sub>D</sub> DIMMER SWITCH MINIMUM 1000W OR AS REQUIRED PER CIRCUIT  DUPLEX RECEPTACLE, 120V,18" AFF.  DUPLEX RECEPTACLE WITH GROUND FAULT INTERRUPTER 8" ABOVE COUNTER TO  DUPLEX RECEPTACLE, 120V,18" AFF., ONE OUTLET SWITCHED  120V DOUBLE DUPLEX CONVENIENCE RECEPTACLE  DUPLEX RECEPTACLE ABOVE COUNTER, 8" ABOVE COUNTER TO Q.  TELEPHONE JACK COMPLETE W/JACK AND COVER, WALL MOUNTED @ 4'-0" A.F  MOTOR  SYSTEM TYPE SMOKE DETECTOR — DBEC  DUCT SMOKE DETECTOR W/REMOTE TEST SWITCH — DBEC  HEAT DETECTOR — DBEC  TIRE ALARM AUDIO/VISUAL UNIT. MTD. @ 6'-8" AFF — DBEC  JUNCTION BOX — DBEC  LIGHTING & POWER PANEL, RECESSED — DBEC  FACP  FIRE ALARM CONTROL PANEL — DBEC  ANN.  FIRE ALARM ANNUNCIATOR — DBEC		2'X2' OR 2'X4' FLUORESCENT LIGHT FIXTURE.
S <sub>3</sub> THREE-WAY LIGHT SWITCHES S <sub>D</sub> DIMMER SWITCH MINIMUM 1000W OR AS REQUIRED PER CIRCUIT  DUPLEX RECEPTACLE, 120V,18" AFF.  OFFI DUPLEX RECEPTACLE WITH GROUND FAULT INTERRUPTER 8" ABOVE COUNTER TO  DUPLEX RECEPTACLE, 120V,18" AFF., ONE OUTLET SWITCHED  120V DOUBLE DUPLEX CONVENIENCE RECEPTACLE  DUPLEX RECEPTACLE ABOVE COUNTER, 8" ABOVE COUNTER TO Q.  TELEPHONE JACK COMPLETE W/JACK AND COVER, WALL MOUNTED @ 4'-0" A.F.  MOTOR  SYSTEM TYPE SMOKE DETECTOR - DBEC  DUCT SMOKE DETECTOR W/REMOTE TEST SWITCH - DBEC  HEAT DETECTOR - DBEC  TIRE ALARM AUDIO/VISUAL UNIT. MTD. @ 6'-8" AFF - DBEC  JUNCTION BOX - DBEC  LIGHTING & POWER PANEL, RECESSED - DBEC  FACP FIRE ALARM CONTROL PANEL - DBEC  ANN FIRE ALARM ANNUNCIATOR - DBEC	S	· · · · · · · · · · · · · · · · · · ·
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FACP FIRE ALARM CONTROL PANEL — DBEC  ANN FIRE ALARM ANNUNCIATOR — DBEC	$\bigcirc$	JUNCTION BOX — DBEC
ANN FIRE ALARM ANNUNCIATOR — DBEC		LIGHTING & POWER PANEL, RECESSED — DBEC
	FACP	FIRE ALARM CONTROL PANEL - DBEC
Tv CABLE	ANN	FIRE ALARM ANNUNCIATOR — DBEC
	$T_V$	CABLE

TYPE	MANUFACTURER		SCHEDU	DESCRIPTION	
111 =	THE WATER ACTORES CALABOO HOWBER		VOLT	LAWII	DESCRIPTION
U1	PROGRESS	P2851-09	120	(2)23WCFL MINI-TWIST	KITCHEN
U2	PROGRESS	P3688-09	120	(1)13 CFL MINI-TWIST	ENTRANCE/LIVING RM/ HALLWAY & STAIR
U3	PROGRESS	P6163-09WB	120	(4)50W MR16	DINING ROOM
U4	PROGRESS	P3408-09	120	(1)13 CFL MINI-TWIST	CLOSET LIGHT
U5	PROGRESS	P3688-09	120	(1)13 CFL MINI-TWIST	BEDROOM LIGHT
U6	PROGRESS	P3223-09WB	120	(3)60W HALOGEN G9	BATHROOM VANITY ABOVE SINK
U7	PROGRESS	P3410-09	120	(2)13 CFL MINI-TWIST	BATHROOM CEILING LIGHT
Α	PROGRESS	P6017-84	120	(2)18W CFL	EXTERIOR CEILING MOUNTED
В	PROGRESS	P5749-84	120	(1)18W CFL	EXTERIOR WALL MOUNTED
С	PROGRESS	P3688-09	120	(1)13 CFL MINI-TWIST	BASEMENT LIGHT
D	PROGRESS	P2501-04			CEILING FAN

Compressor sized 3. 4 Heads. 4. No ducts shall be installed 5. HSPF of 12 or greater 6. SEER of 20 or greater HOT WATER SYSTEM: Gas domestic hot water system — instantaneous gas dhw system EF of .95 or higher If gas is not available use Electric heat pump water heater Locate Unit as Desired. Provide energy recovery system (ERV) by
Panasonic FV04VE1, Venmar or equivalent
Capable of meeting ventilation code 50—80 CFM that meets the
2012 IECC standards for efficacy ERV SYSTEM: Provide a radon resistant construction techniques including a passive system which from the perforated pipe under the slab, up through slab, and house, terminating above the roof with an electrical outlet in the attic for installing a fan, making it an active system, if there is a high PASSIVE RADON SYSTEM: reading measured.
ASTM E1465 Practice for Radon Control Options TO BE SOLAR PV READY: Install Conduit from roof to area in basement In basement room for a solar meter, an inverter and a switch box On exterior of basement room following the local electric company guidelines, an accessible safety off switch box PLUMBING: Water Sense (EPA) for all interior plumbing devices; Showerhead Toilet Lavatory Faucet Use Energy Star Appliances Use Electric Range and exhaust range to exterior APPLIANCES:

Power Requirement, Panel Location, Fire Alarm, CO2, Security and Final Design by the Architect and

1. Fajitsu, mitshubishi, or equal mini split heat pump system

MECHANICAL SYSTEMS

HEATING/COOLING SYSTEM:

# Micheal Washington Architects Inc.

891 Centre Street Jamaica Plain, MA 02130

Phone: 617-390-5515 E-MAIL: MWAINC1@HOTMAIL.COM

PROJECT


#### NEW ENGLAND HERITAGE HOMES

DORCHESTER, MASSACHUSETTS

DEVELOPER

## CODMAN SQUARE NEIGHBORHOOD DEVELOPMENT CORPORATION

DORCHESTER, MASSACHUSETTS

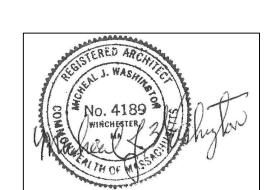

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SHEET TITLE

BASEMENT
ELECTRICAL PLAN
SCHEDULES AND
MECHANICAL NOTE

SEE SITE ON COVER PAGE FOR ADDRESS AND UNIT LOCATION


SCALE: 1/4"=1'-0"

DATE: 12/01/2015


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1ST FLOOR ELECTRICAL PLAN SCALE: 1/4"=1'-0"



2ND FLOOR ELECTRICAL PLAN SCALE: 1/4"=1'-0"
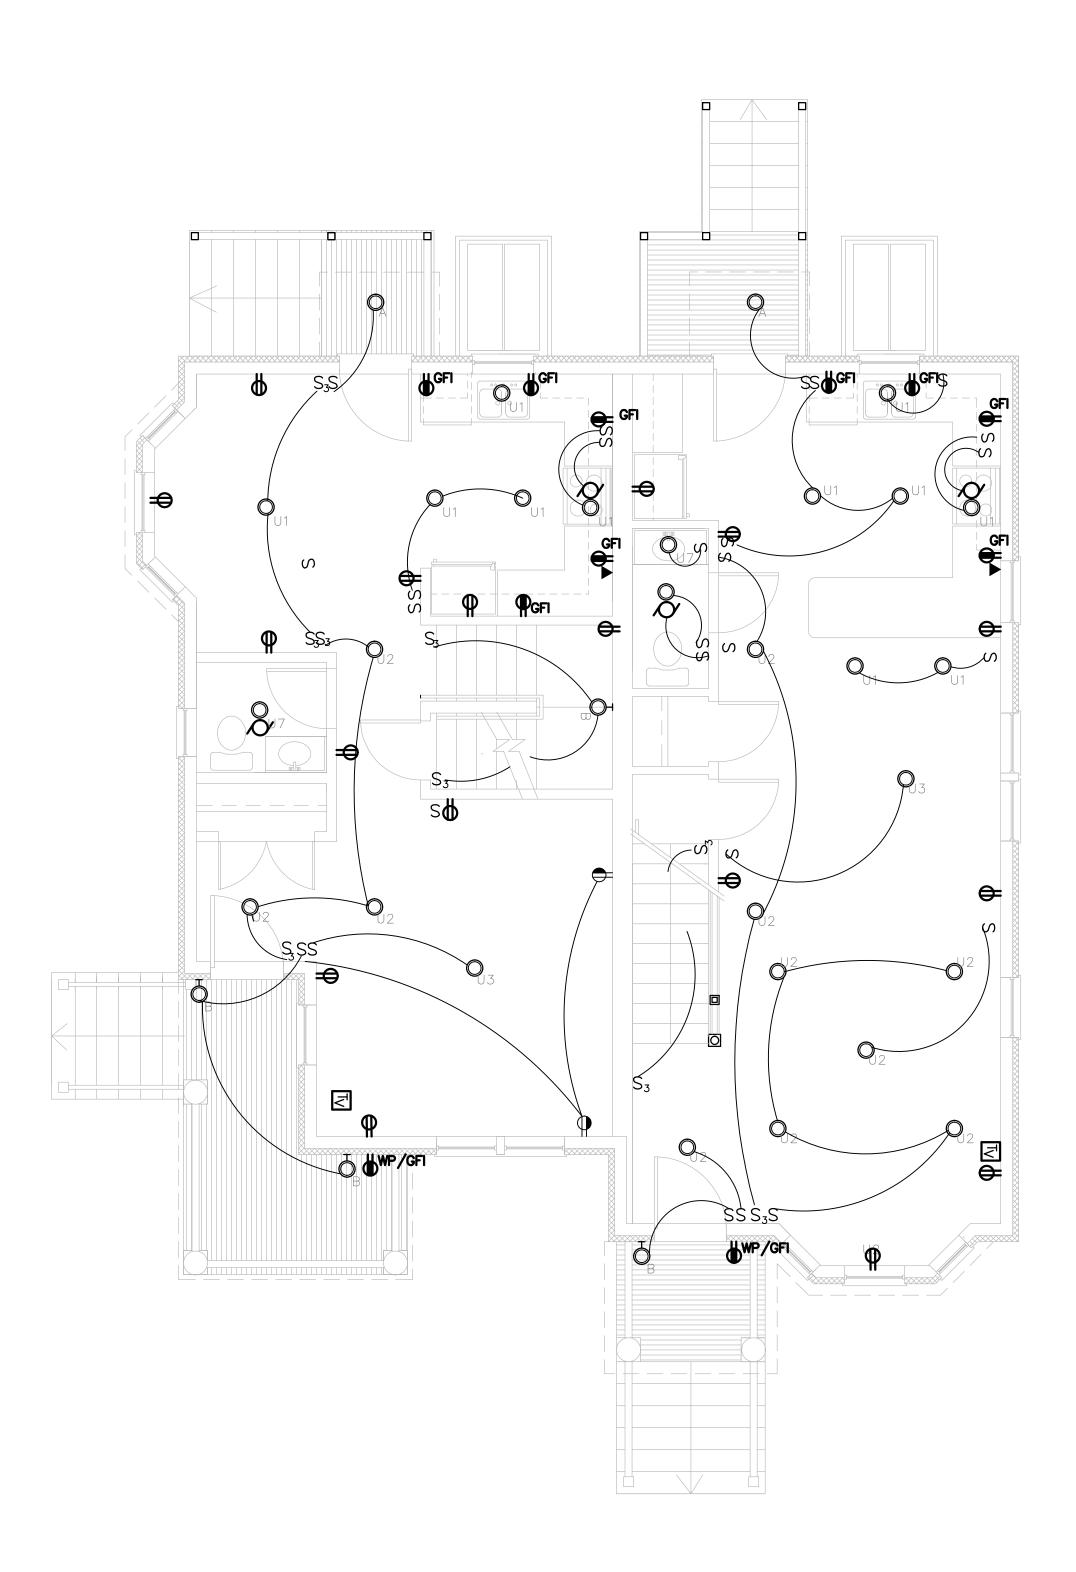
# Micheal Washington Architects Inc.

891 Centre Street Jamaica Plain, MA 02130

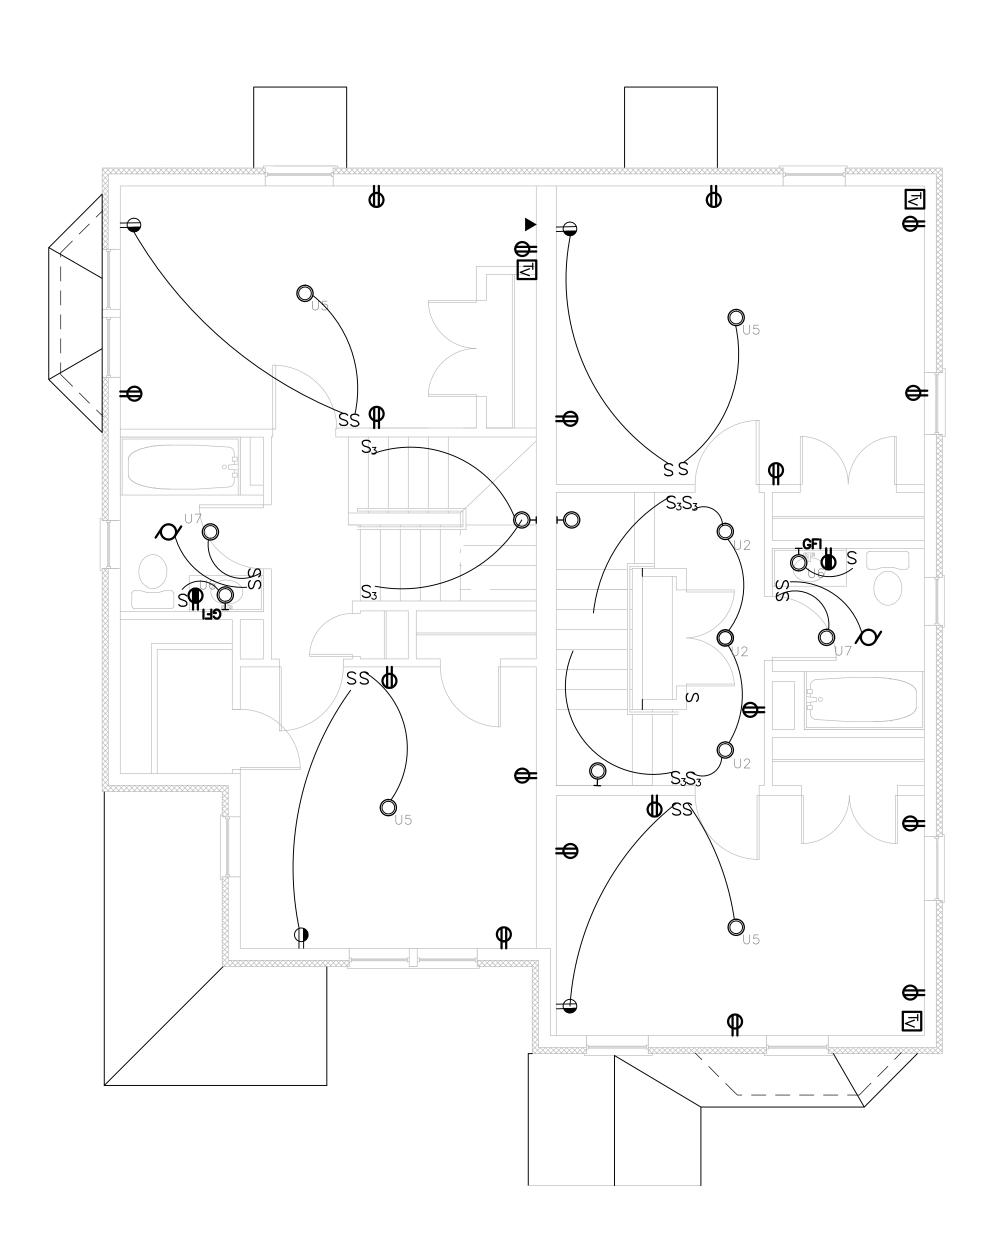
Phone: 617-390-5515 E-MAIL: MWAINC1@HOTMAIL.COM

#### **NEW ENGLAND HERITAGE HOMES**

DORCHESTER, MASSACHUSETTS

#### **CODMAN SQUARE NEIGHBORHOOD DEVELOPMENT** CORPORATION

DORCHESTER, MASSACHUSETTS

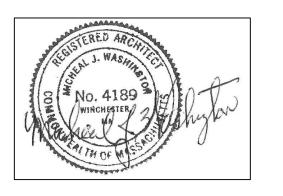


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1ST & 2ND FLOOR **ELECTRICAL PLANS** 

SEE SITE ON COVER PAGE FOR ADDRESS AND UNIT LOCATION

**E-E.2** 

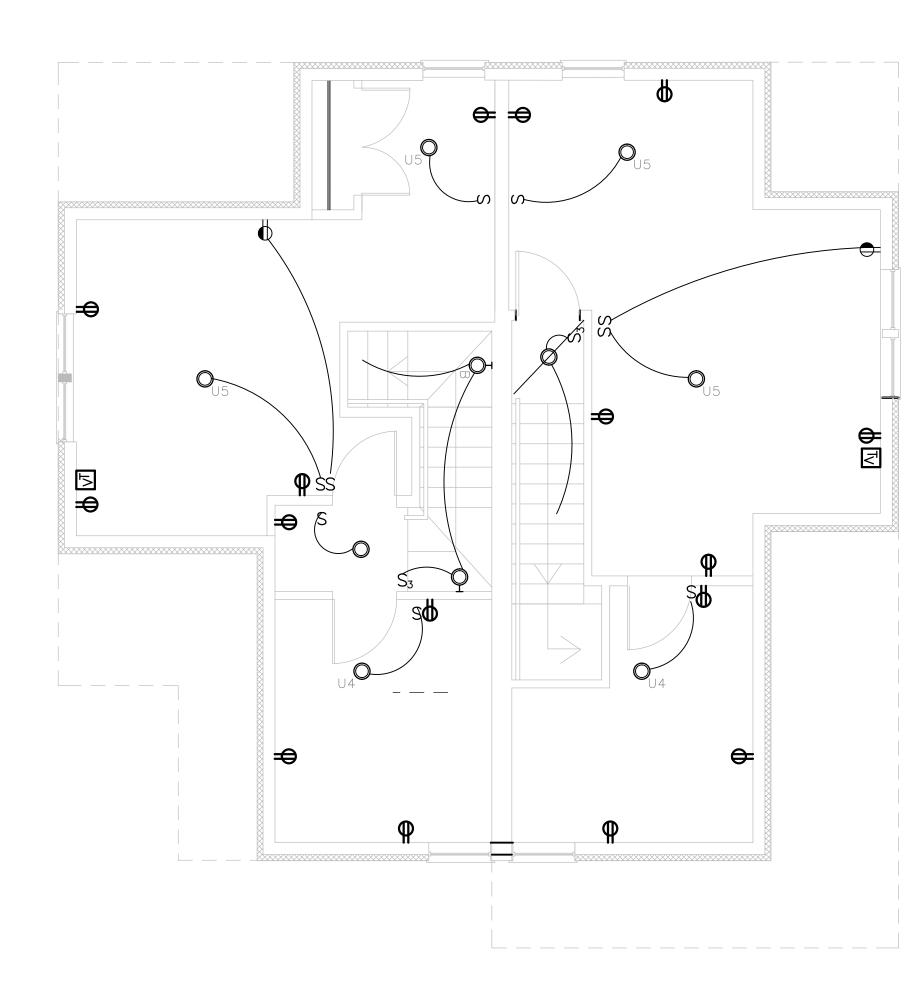

3RD FLOOR ELECTRICAL PLAN

SCALE: 1/4"=1'-0"

# Micheal Washington Architects Inc.

891 Centre Street Jamaica Plain, MA 02130

Phone: 617-390-5515 E-MAIL: MWAINC1@HOTMAIL.COM

PROJECT


#### NEW ENGLAND HERITAGE HOMES

DORCHESTER, MASSACHUSETTS

DEVELOPER

## CODMAN SQUARE NEIGHBORHOOD DEVELOPMENT CORPORATION

DORCHESTER, MASSACHUSETTS

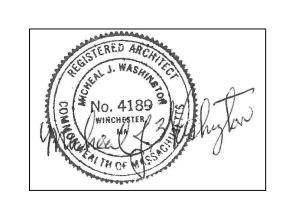

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SHEET TIT

3RD FLOOR ELECTRICAL PLAN

SEE SITE ON COVER PAGE FOR ADDRESS AND UNIT LOCATION

SCALE: 1/4"=1'-0"

DATE: 12/01/201!

DRAWING NO.

12/01/2015 BY:

**E-E.3** 

36 MALLARD AVENUE (BUILDING H)

# "NEW ENGLAND HERITAGE HOMES" AFFORDABLE HOMEOWNERSHIP DEVELOPMENT

PREPARED FOR:

## CODMAN SQUARE NEIGHBORHOOD DEVELOPMENT CORPORATION

587 WASHINGTON STREET DORCHESTER, MA 02124

PREPARED BY:


MICHEAL WASHINGTON ARCHITECTS, INC.

891 CENTRE ST.

JAMAICA PLAIN, MA 02130

TEL: (617) 390-5515

EMAIL: mwainc1@hotmail.com

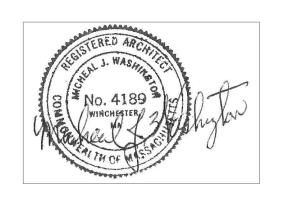

I. ALL DRAWINGS WILL BE UPDATED AND MODIFIED

2. ALL GENERAL DRAWINGS TO BE UPDATED
INCLUDING REMOVAL OF HUNTER PANELS AND
DOWNGRADING R VALUES TO CURRENT CODE.

3. WINDOW REQUIREMENTS TO BE DETERMINED LATER.

NOTES:

I. ALL WORK AND PERMITS AND APPROVALS WILL BE OBTAINED BY THE TRADE AND COORDINATED BY THE GENERAL CONTRACTOR AND THE OWNER. ALL WORK SHALL COMPLY WITH ALL PROVISIONS OF THE MASSACHUSETTS STATE BUILDING CODE, CURRENT EDITION, AND LOCAL CITY AND TOWN PROVISIONS.

2. ALL CONSTRUCTION IS TO COMPLY WITH THE MASSACHUSETTS STATE BUILDING CODE, EIGHTH EDITION AND WITH ALL SUPPLEMENTS, AMENDMENTS, AND OTHER APPLICABLE CODES AND REGULATIONS.

3. ALL ROOF INSULATION SHALL BE R-49; ALL WALLS SHALL BE R-21 AND IN COMPLIANCE WITH THE IECC REQUIREMENTS.ALLFIRST FLOOR AREAS R-30, IN COMPLIANCE WITH IBC REQUIREMENTS.

4. CONTRACTOR IS TO VERIFY ALL DIMENSION IN THE FIELD, NOTIFY ARCHITECT IF THERE ARE ANY VARIATIONS.

## 36 MALLARD AVENUE (BUILDING H)


#### LIST OF DRAWINGS

ARCHITECT	URAL INDEX OF DRAWINGS	ARCHITECT	URAL INDEX OF DRAWINGS
NUMBER	DRAWING NAME	NUMBER	DRAWING NAME
т-I	TITLE SHEET	GENERAL I G-I G-2.I	PRAMINGS  KICTHEN PLANS & ELEVATIONS  BATH PLANS & ELEVATIONS
C-I BPP	EXISTING CONDITIONS BUILDING PLOT PLAN	6-3 6-4	WINDOWS & DOORS SCHEDULE FINISH SCHEDULE & PARTITION TYPE
ARCHITECT	TURAL H UNIT	<i>6-</i> 5.3	WALL SECTIONS
A-H.I	BASEMENT & FIRST FLOOR PLAN	G-6.I	GENERAL TYPICAL DETAILS
A-H.2	SECOND & THIRD FLOOR PLAN	G-6.2	GENERAL TYPICAL DETAILS
A-H.3	ROOF FLOOR PLANS		
A-H.4	EXTERIOR ELEVATIONS		
A-H.5	EXTERIOR ELEVATIONS		
STRUCTURA	AL HUNIT SIMILAR DRAWINGS TO BE ADJU	STED TO PLANS	•
S-H.I	FOUNDATION & FIRST FRAMING PLAN		
S-H.2	SECOND & ATTIC FRAMING PLAN		
S-H.3	ROOF FRAMING PLAN		

#### 36 MALLARD AVENUE

I I	
REQUIRED	ACTUAL
6000 SF FOR 2 UNITS + 2500 PER ADDT'L UNIT	3,555 SF
40 FT	40.0' FT
40 FT	40.0' FT
0.4	0.49
2 1/2 STORY 35	35 FT
750 SF PER UNIT	4,498 SQ. FT.
15FT/MOD.	17.5 FT
10 FT	13.5 FT
10 FT	11.5 FT
20 FT	27.0 FT
1/UNIT	1
	6000 SF FOR 2 UNITS + 2500 PER ADDT'L UNIT  40 FT  40 FT  0.4  2 1/2 STORY 35  750 SF PER UNIT  15FT/MOD.  10 FT  10 FT  20 FT



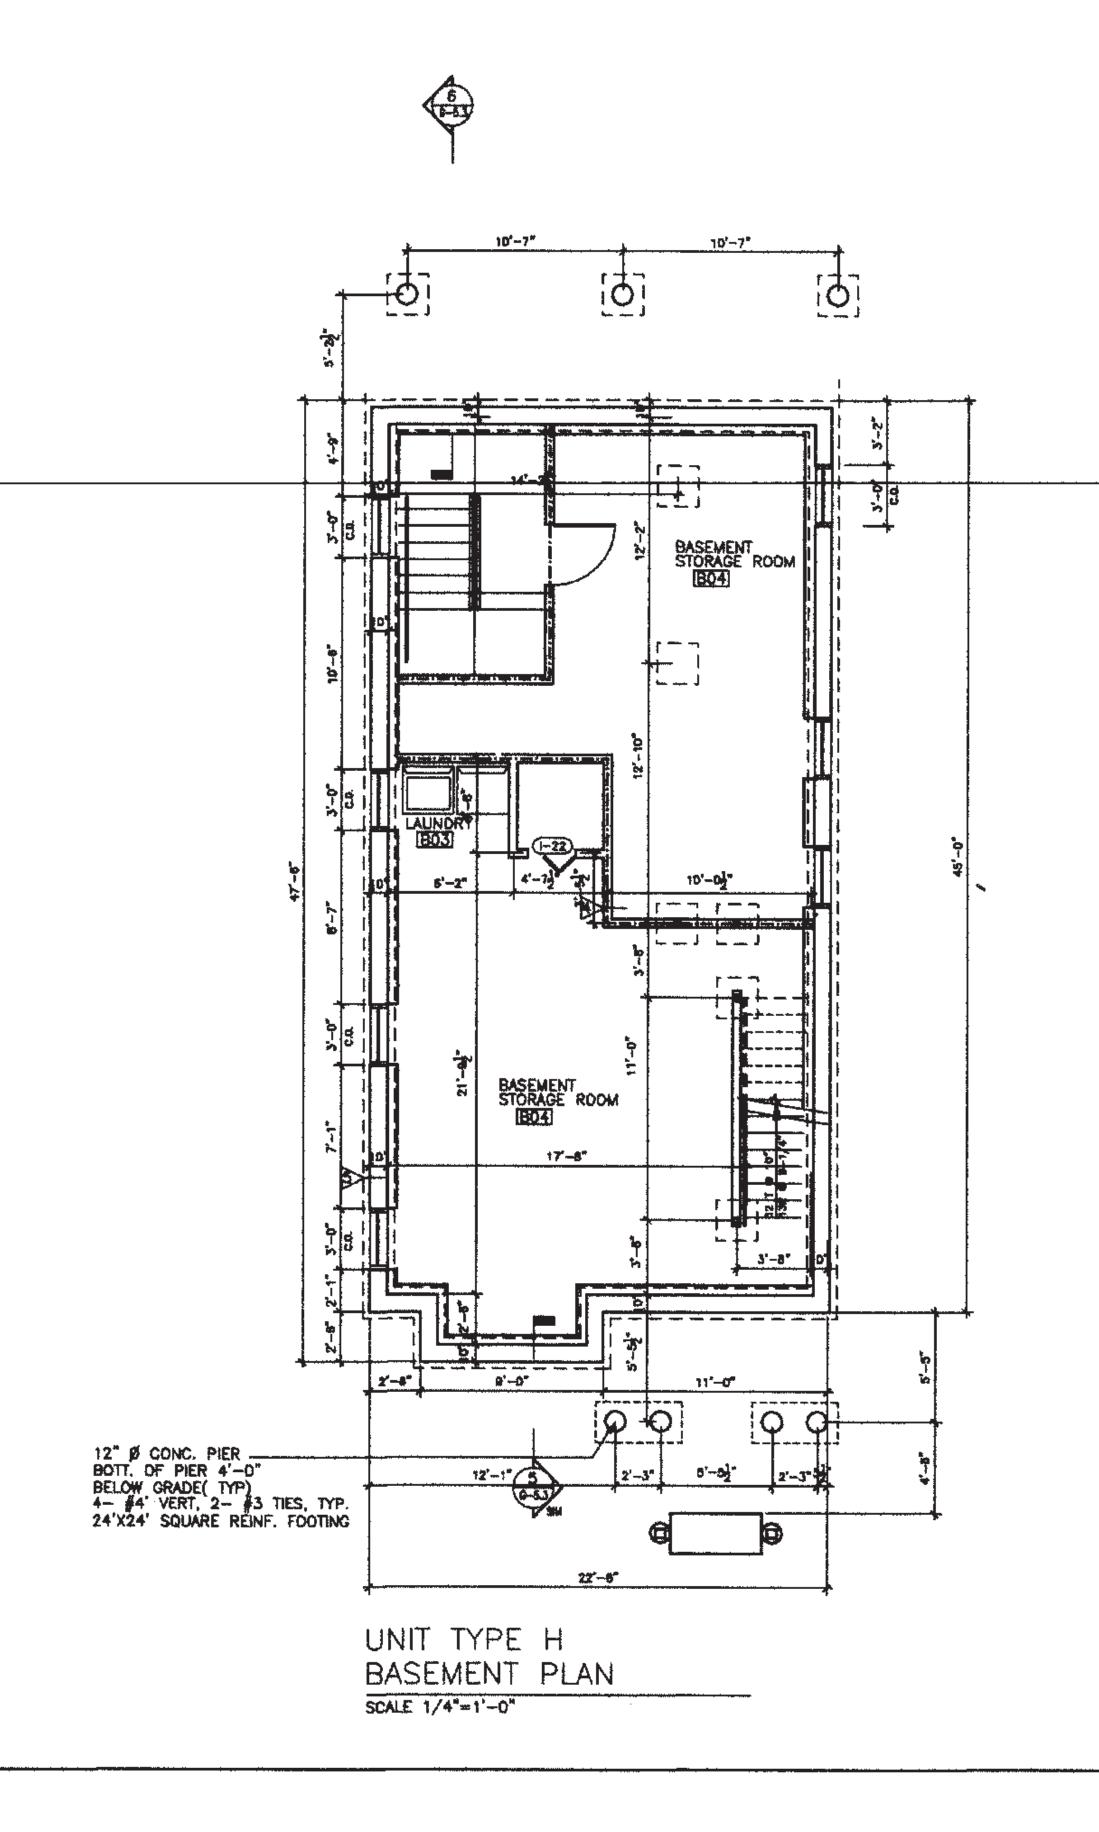

#### Architectural Firm Name

00 Street Address City, MA 00000

PROJECT

#### Project Name

00 Street Address City, MA 00000

#### Developer Name

00 Street Address City, MA 00000

#### CONSULTANT

#### Consultant Name

00 Street Address City, MA 00000

REVISION

3	Date	Description

DHEET THILE

TYPE H-FLAT STACK BASEMENT PLAN

SCALE: T/4"=Y'-0"

DATE: 104/104/201011


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THESE DRAWING ARE STENSED TO DETRIE SCOPE AND WAL PERSONS AND STRAIN BY THE ARCHITECT AND ENGINEERS ( STRUCTURAL DESCRIPTION) OF MICHAEL

A-H.1

# 22'-75"

UNIT TYPE H
FIRST FLOOR PLAN
SCALE 1/4"=1"-0"

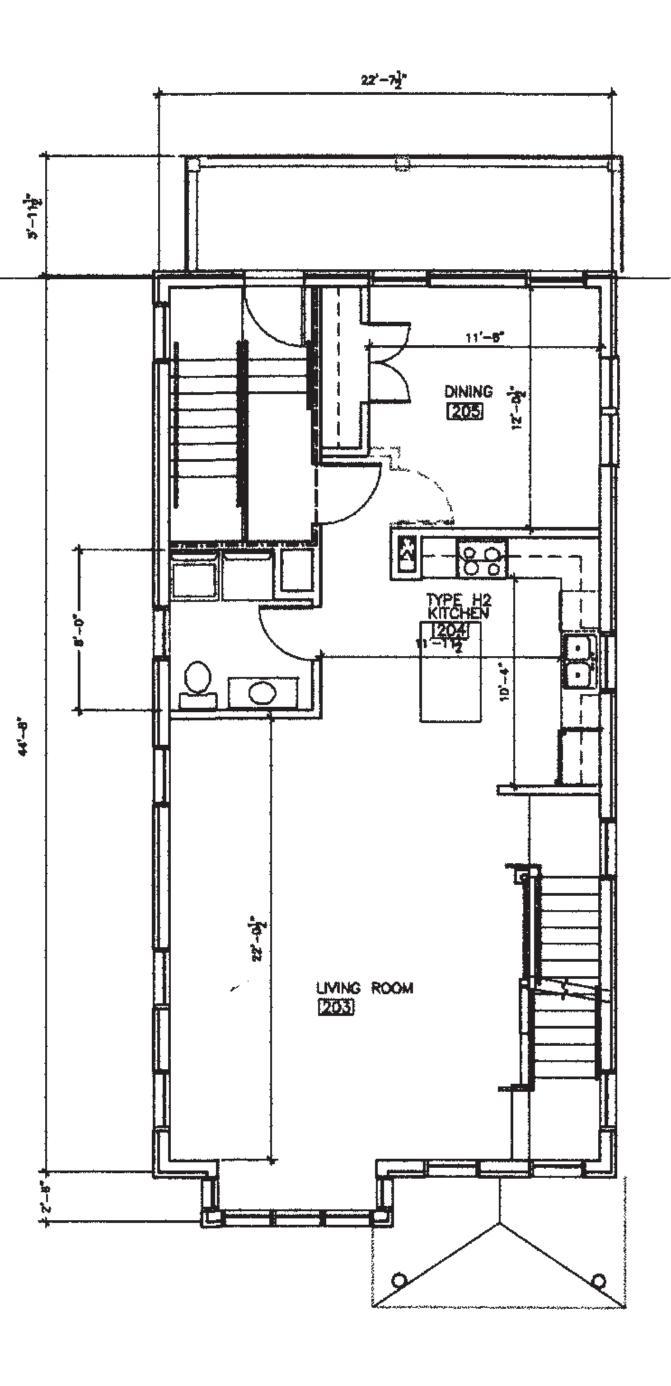

UNIT TYPE H
SECOND FLOOR PLAN

#### Architectural Firm Name

00 Street Address City, MA 00000

PROJECT

#### Project Name

00 Street Address City, MA 00000

#### Developer Name

00 Street Address City, MA 00000

CONSULTANT

#### Consultant Name

00 Street Address City, MA 00000

LEGEND:

TWO HOUR RATED PARTITION

ONE HOUR RATED PARTITION

NOTES

1. SEE G-4 FOR PARTITION TYPES.

2. SEE GA-1 FOR ENLARGED KITCHEN PLANS AND ELEVATIONS.

3, DIMENSIONS ARE TO EXTERIOR FACE OF EXTERIOR STUD WALL AND EXTERIOR FACE OF FOUNDATION WALL.

4. DIMENSIONS ARE TO CENTERLINE OF STUDS ON INTERIOR WALLS UNLESS OTHERWISE NOTED.

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REVISIONS

No.	Data	Description			

SHEET TITL


TYPE H- FLAT STACK FIRST & SECOND FLOOR PLANS

DEALE: 1/4"+1"-0"
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FILE:


A-H.2

DRAWING NO.

THESE DRAWING ARE WITHOUT AND WITHOUT AND RECEIVE WOMEN AND RECEIVED AND ENGINEERS ( RESPONDED AND PROPERTY AND PROPERTY OF MECOND.

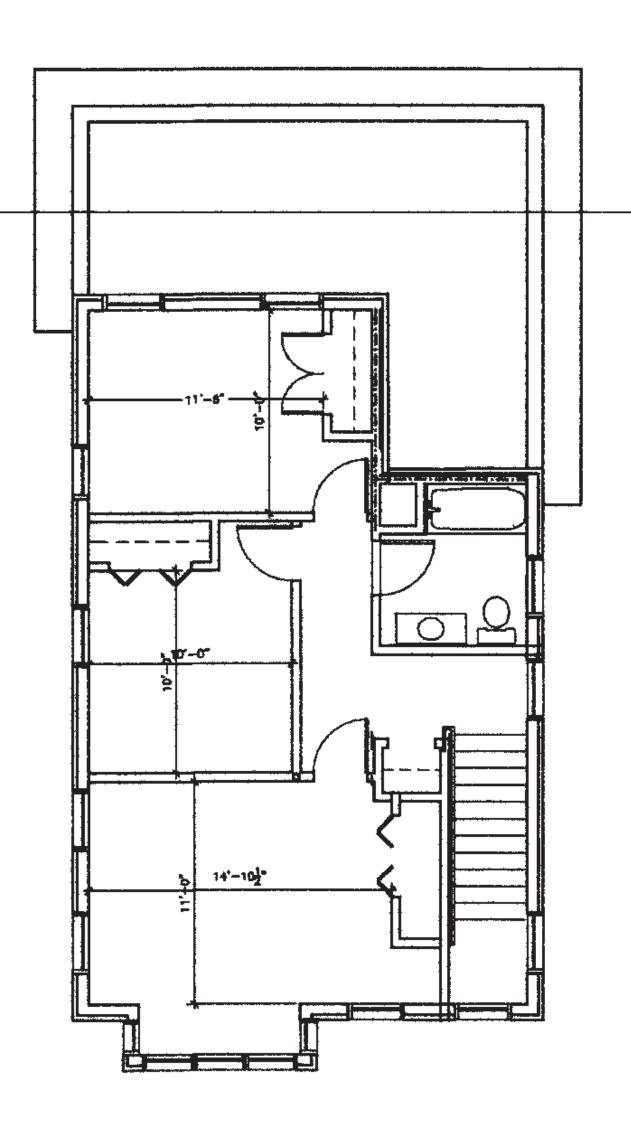

UNIT TYPE H
THIRD FLOOR PLAN
SCALE 1/4"=1'-0"

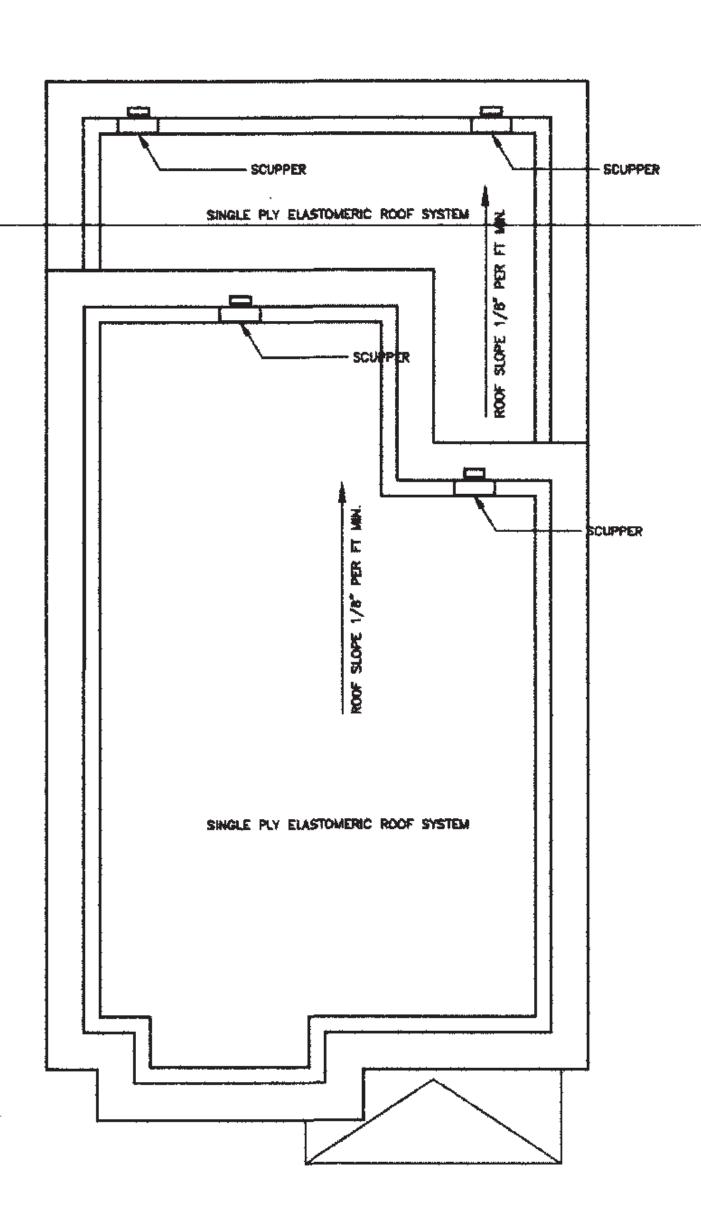

ROOF PLAN
SCALE 1/4"=1'-0"

THESE BRANCHE ARE INTERIOR TO DEPOSE SCOPE AND WAS PROPOSE PROPOSE AND STATE BY THE ARCHITECTURAL MEDITION OF PROPOSE ( STRUCTURAL MEDITIONAL PLANSING AND FIRST PROTECTION) OF PRODUCT.

#### Architectural Firm Name

00 Street Address City, MA 00000

PROJECT

#### Project Name

OO Street Address City, MA 00000

## Developer / OWNER Developer Name

00 Street Address City, MA 00000

CONSULTANT

#### Consultant Name

00 Street Address City, MA 00000

REVISIO


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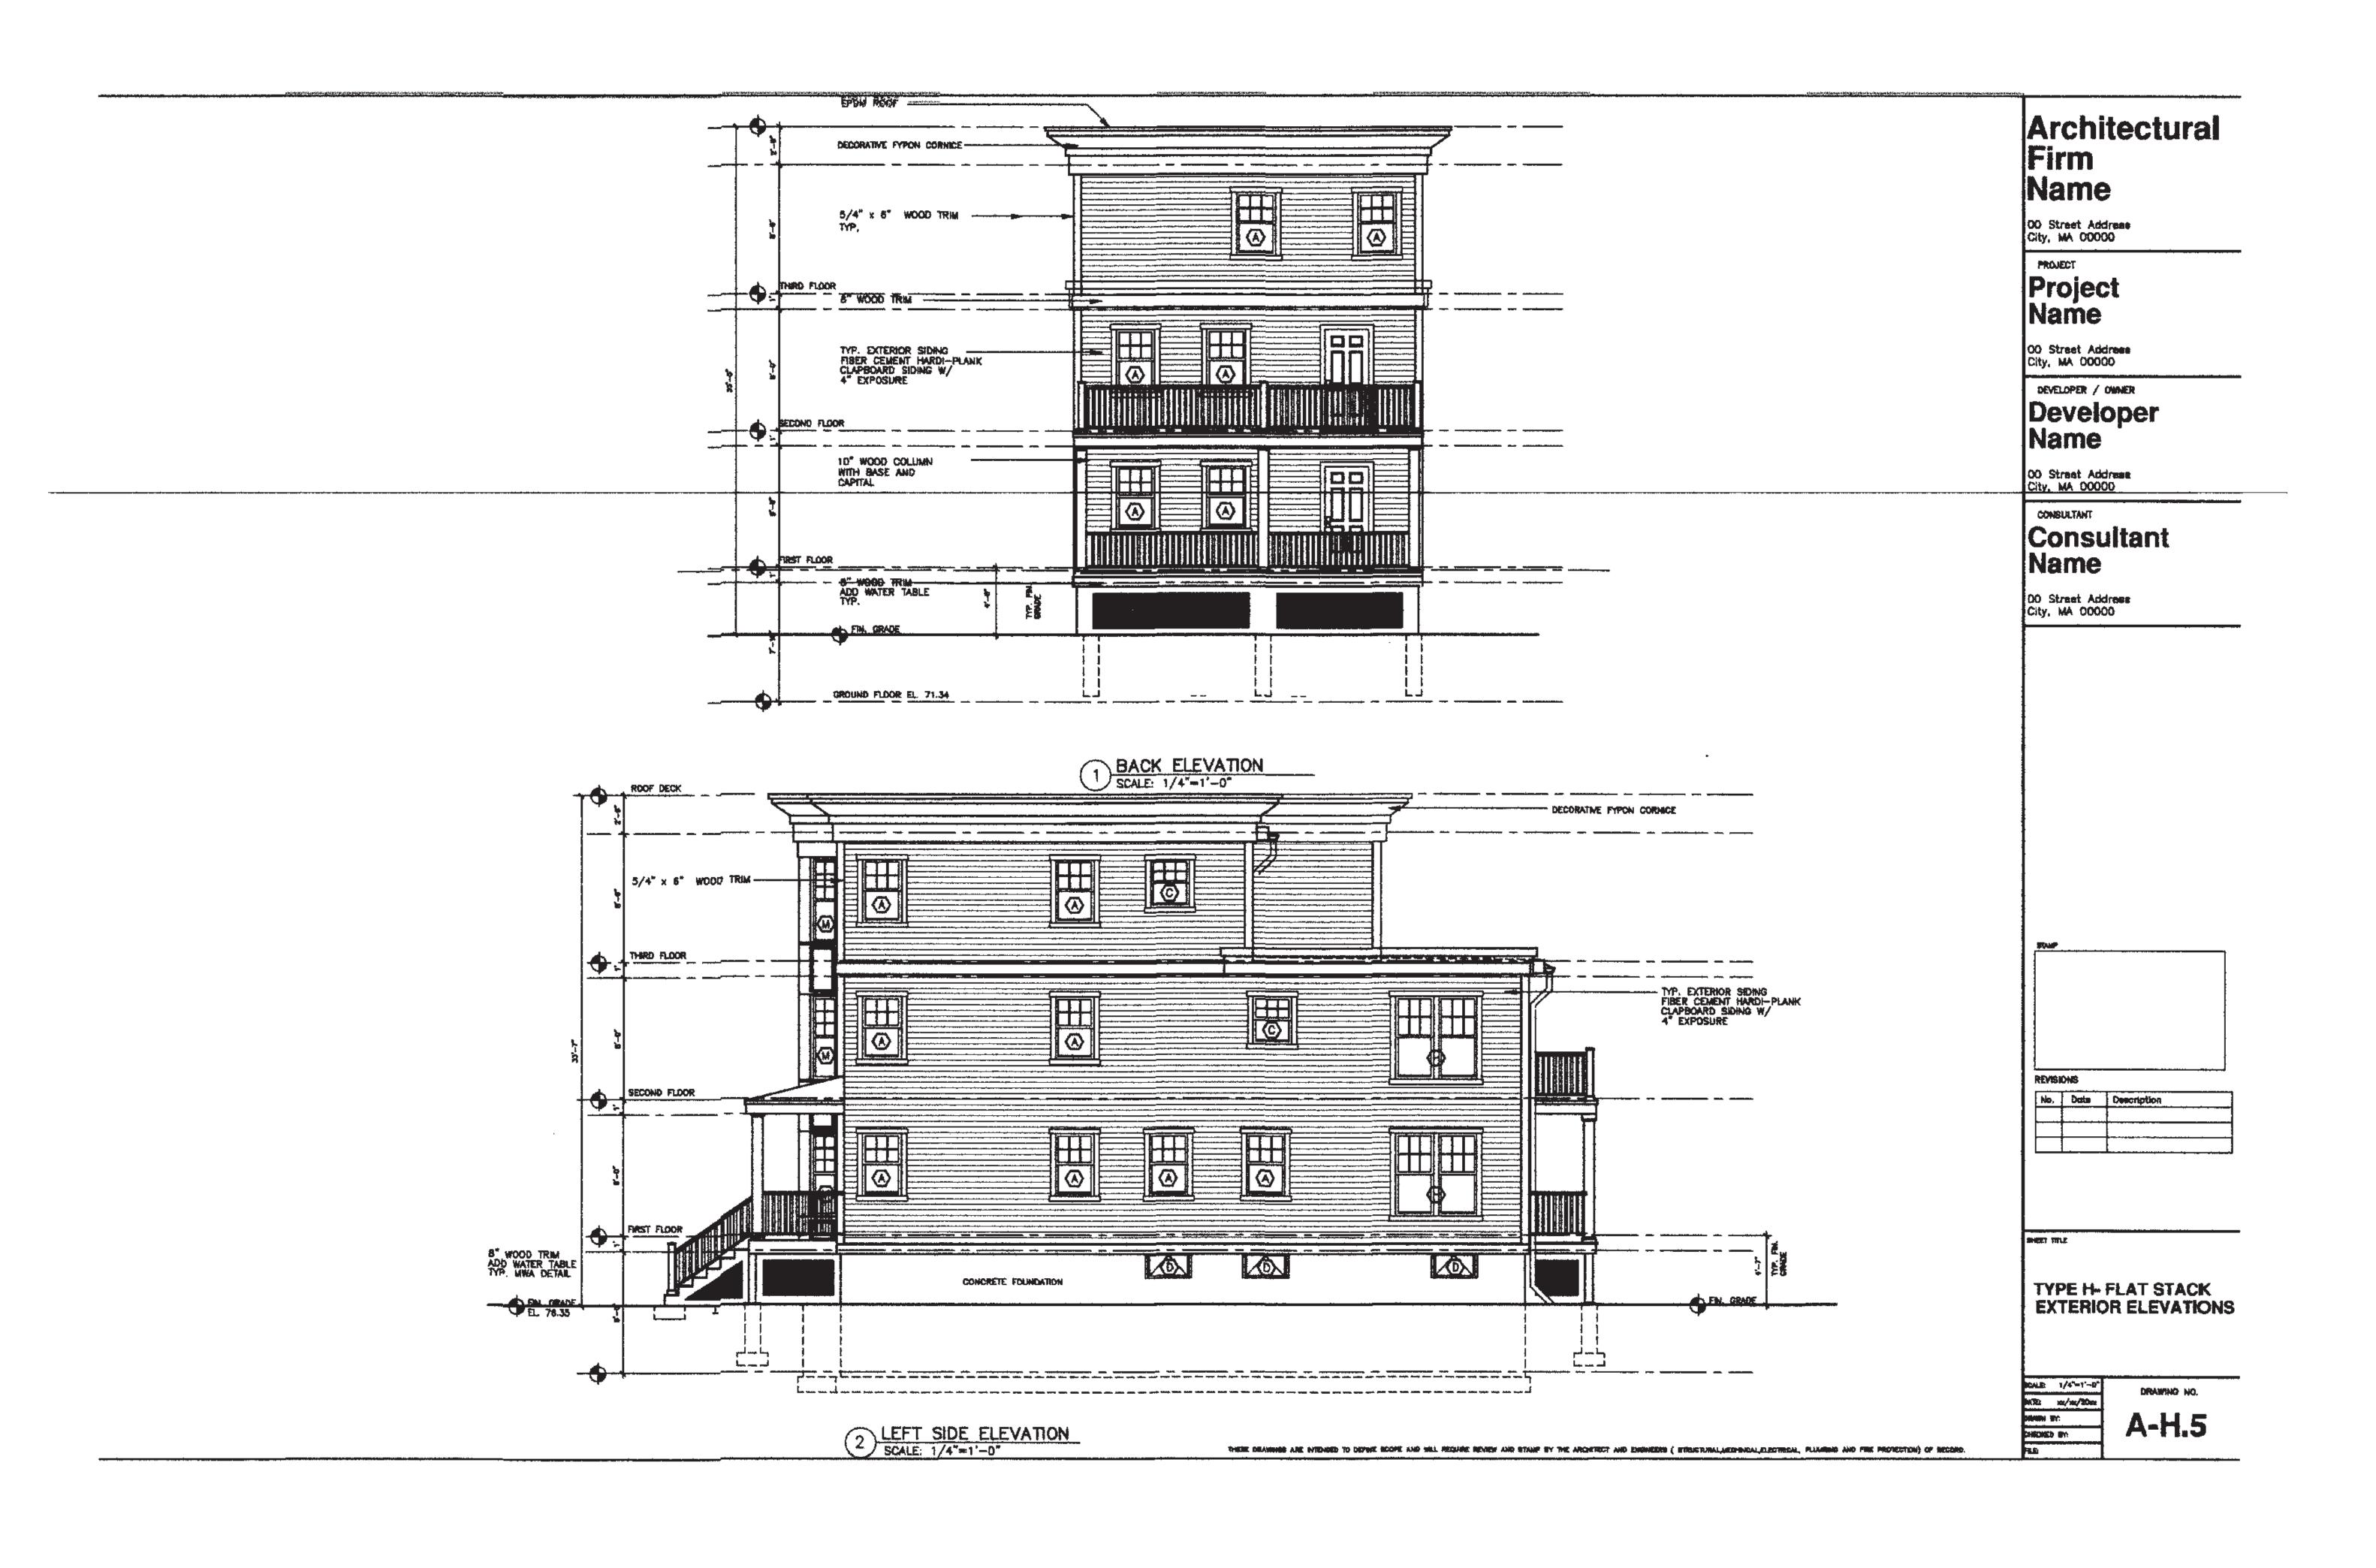
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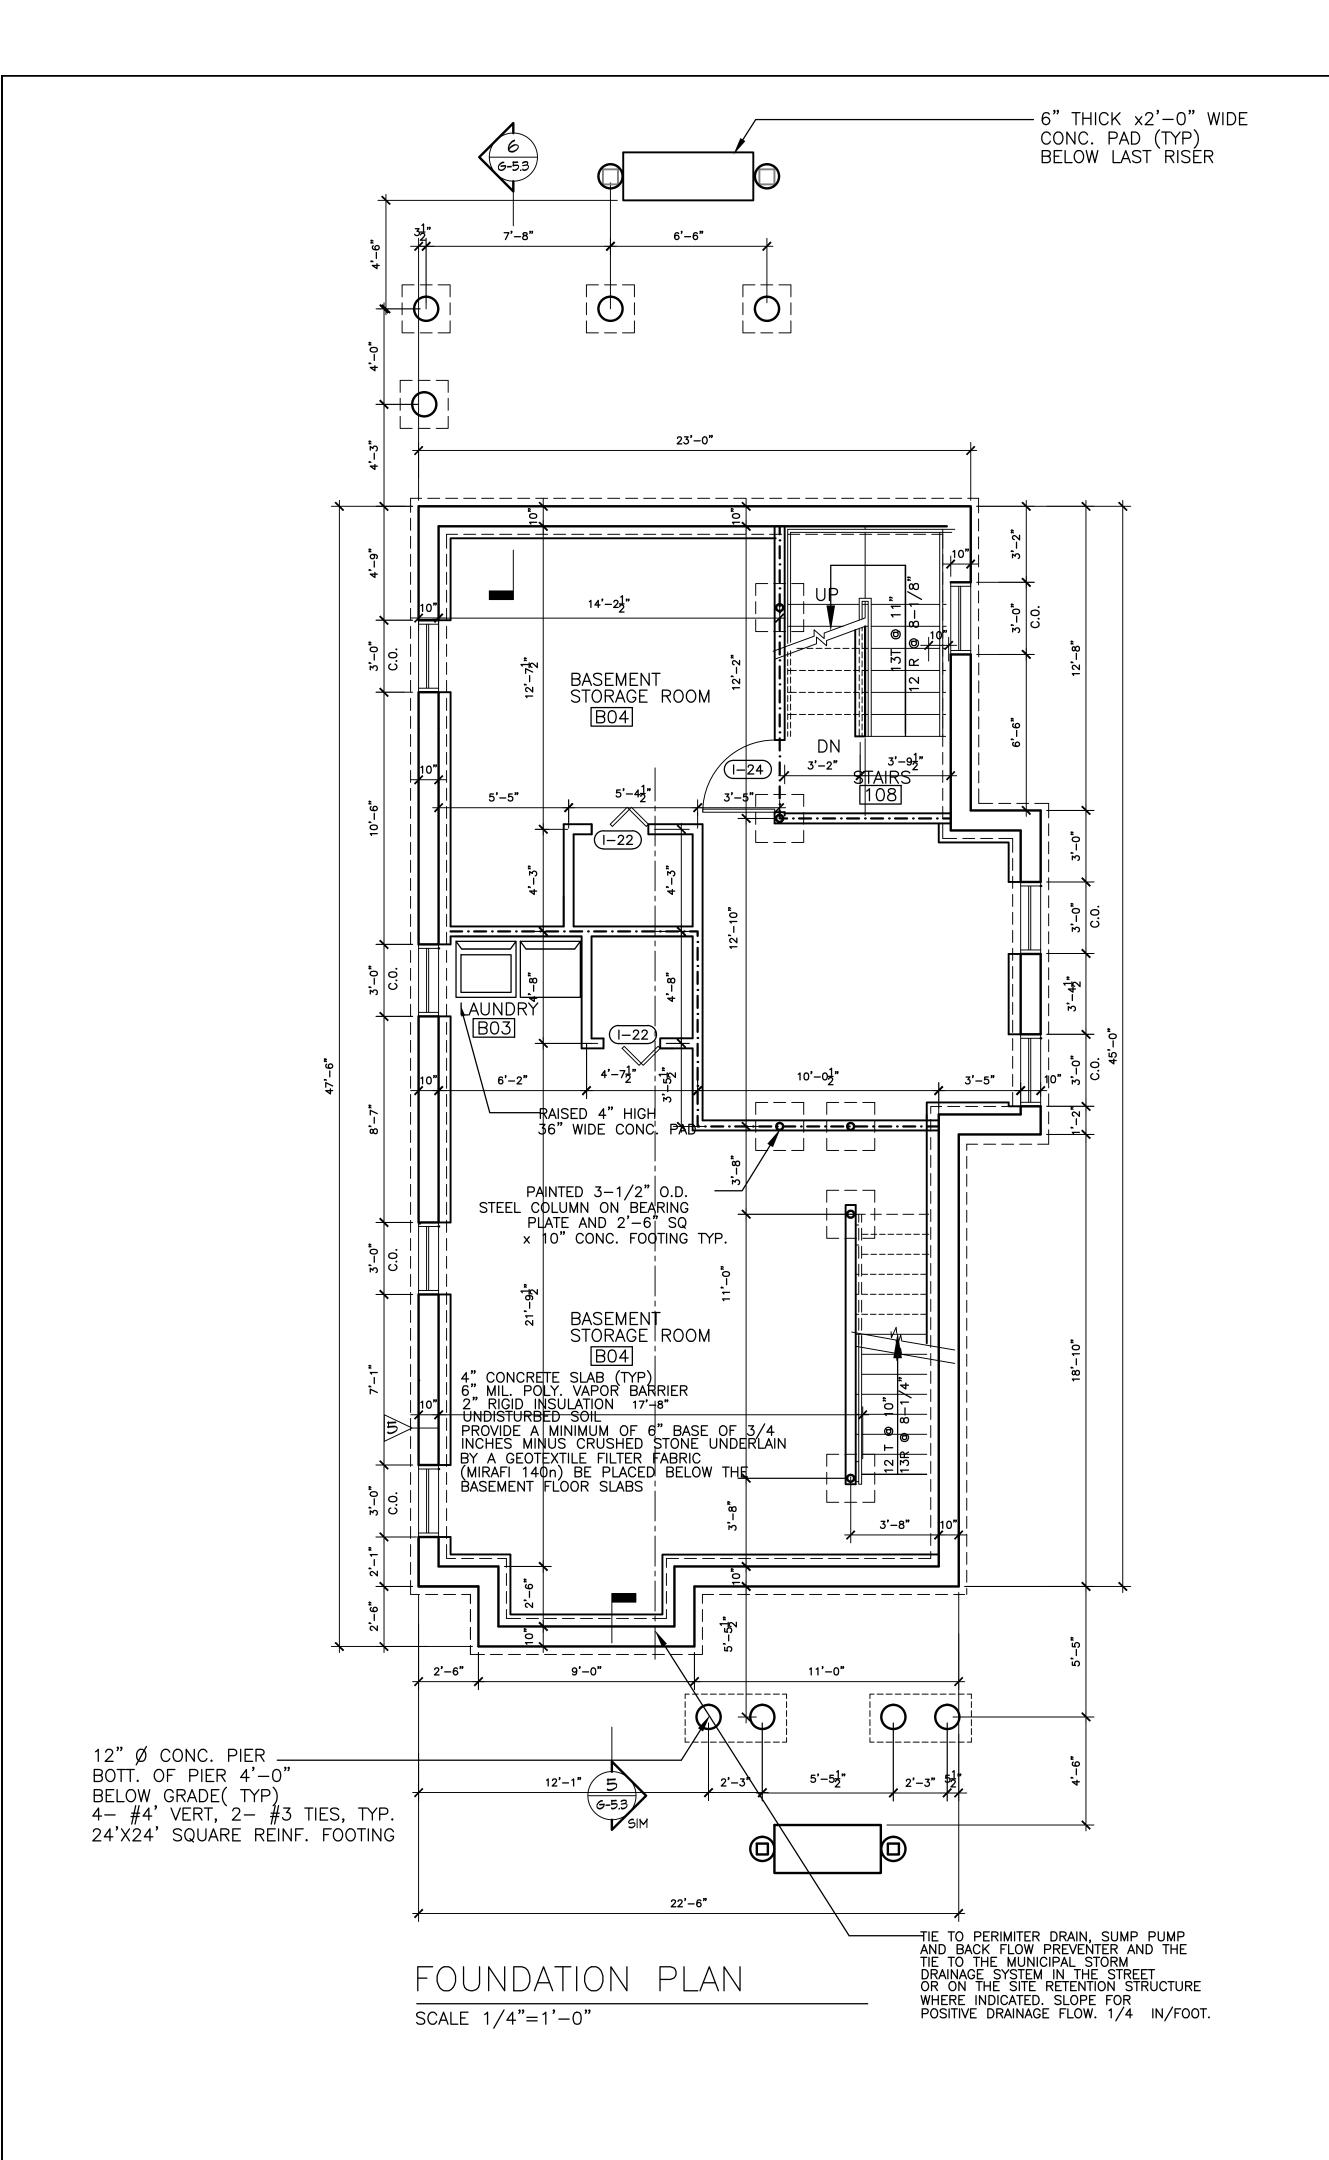
TYPE H- FLAT STACK THIRD FLOOR & ROOF PLANS


MCALIE: 1/4"=1"-0" DRIE: su/se/\$thex DRIMH IPC DRIMH IPC

A-H.3





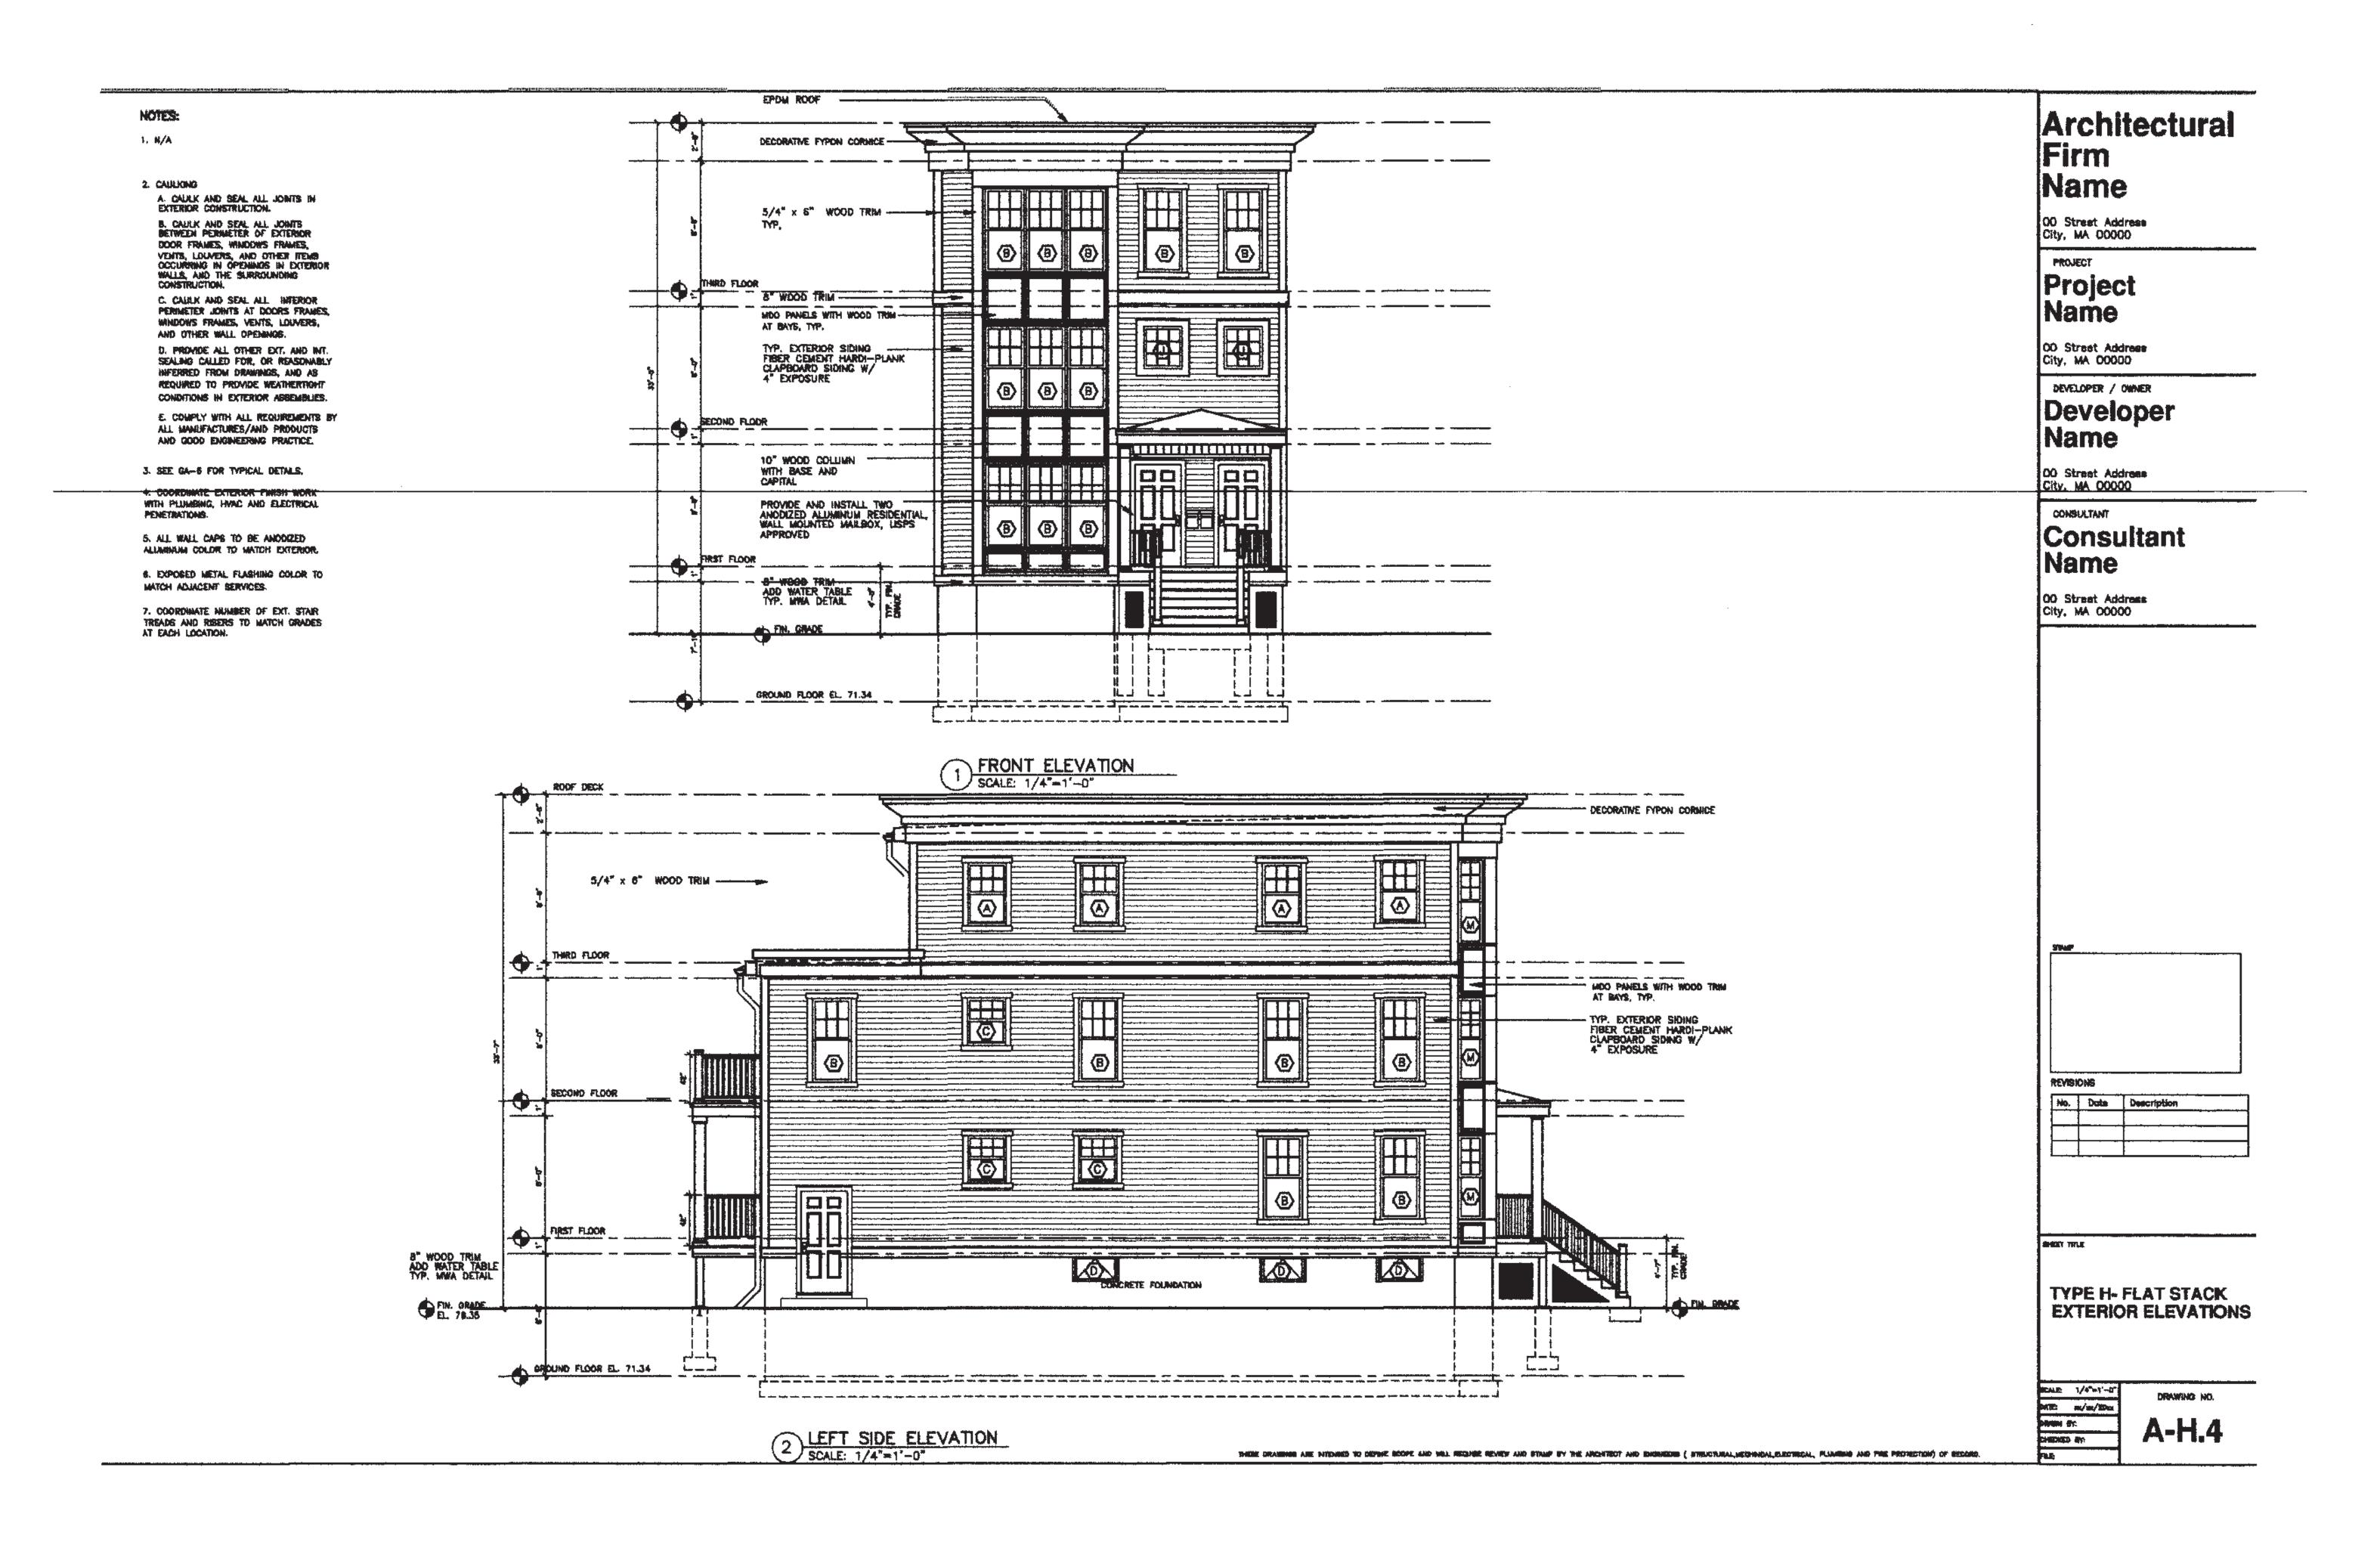

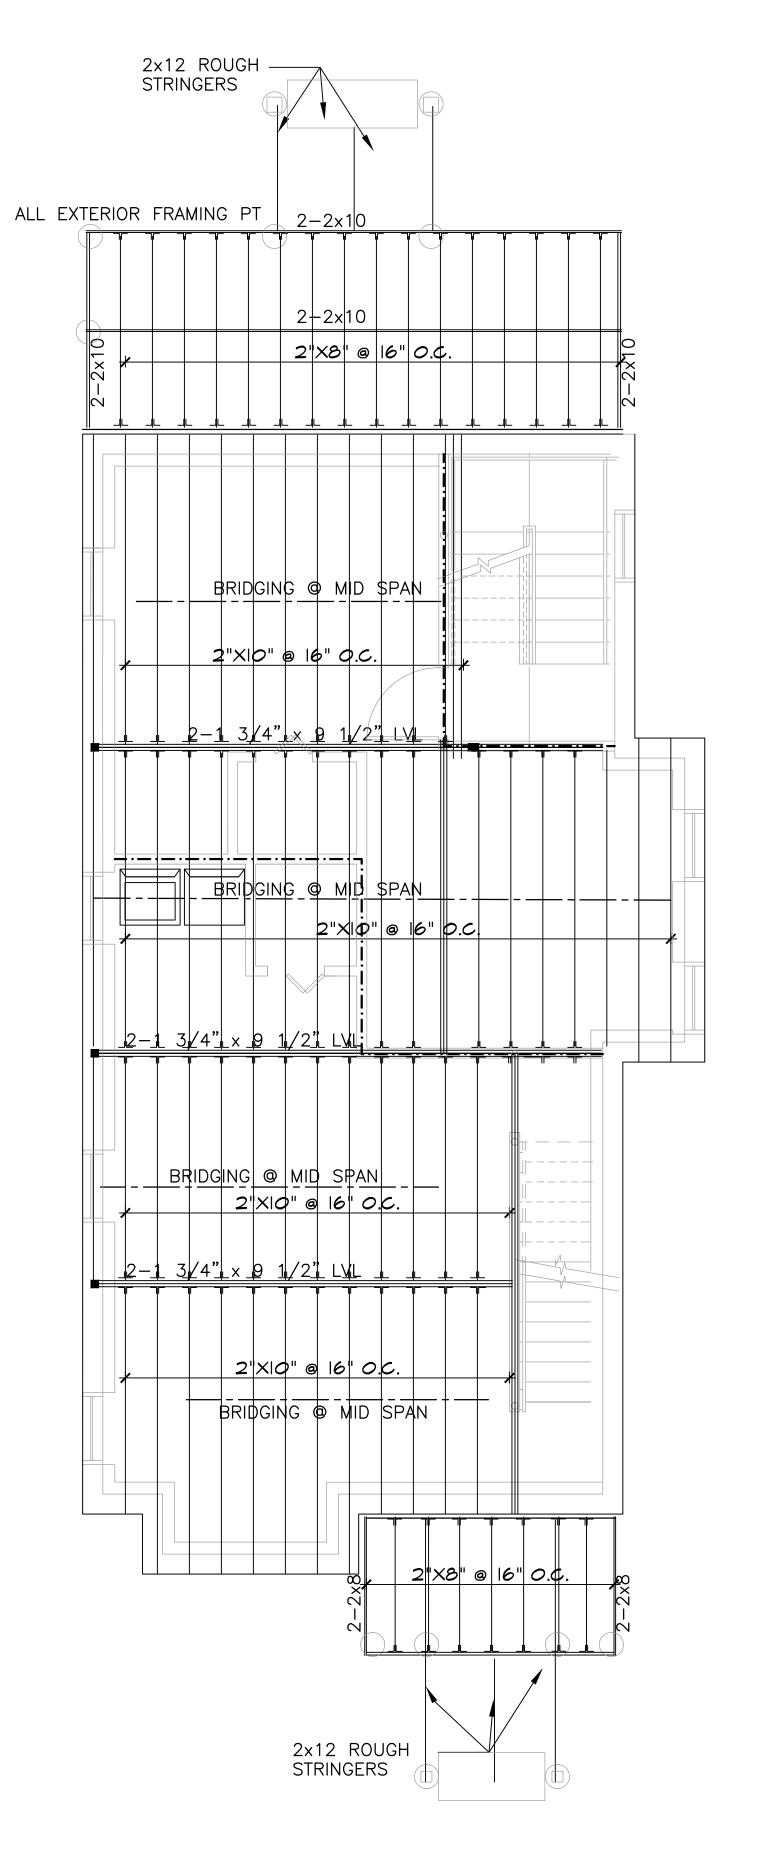

1ST FLOOR FRAMING PLAN SCALE: 1/4"=1'-0"

# Micheal Washington Architects Inc.

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Phone: 617-390-5515 E-MAIL: MWAINC1@HOTMAIL.COM

PROJECT

#### **NEW ENGLAND HERITAGE HOMES**


DORCHESTER, MASSACHUSETTS

DEVELOPER

#### **CODMAN SQUARE NEIGHBORHOOD DEVELOPMENT** CORPORATION

DORCHESTER, MASSACHUSETTS

1. ALL FRAMING AND STRUCTURAL DESIGN MEMBER, SIZES AND ELEMENTS TO BE CONFIRMED BY FINAL ARCHITECT AND ENGINEER OF RECORD.

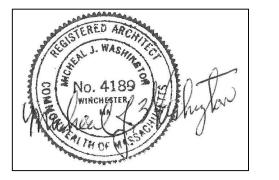

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SHEET TITLE


#### **FOUNDATION & 1ST FLOOR** FRAMING PLAN

SEE SITE ON COVER PAGE FOR ADDRESS AND UNIT LOCATION

1/4"=1'-0 12/01/201


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**S-H.1** 

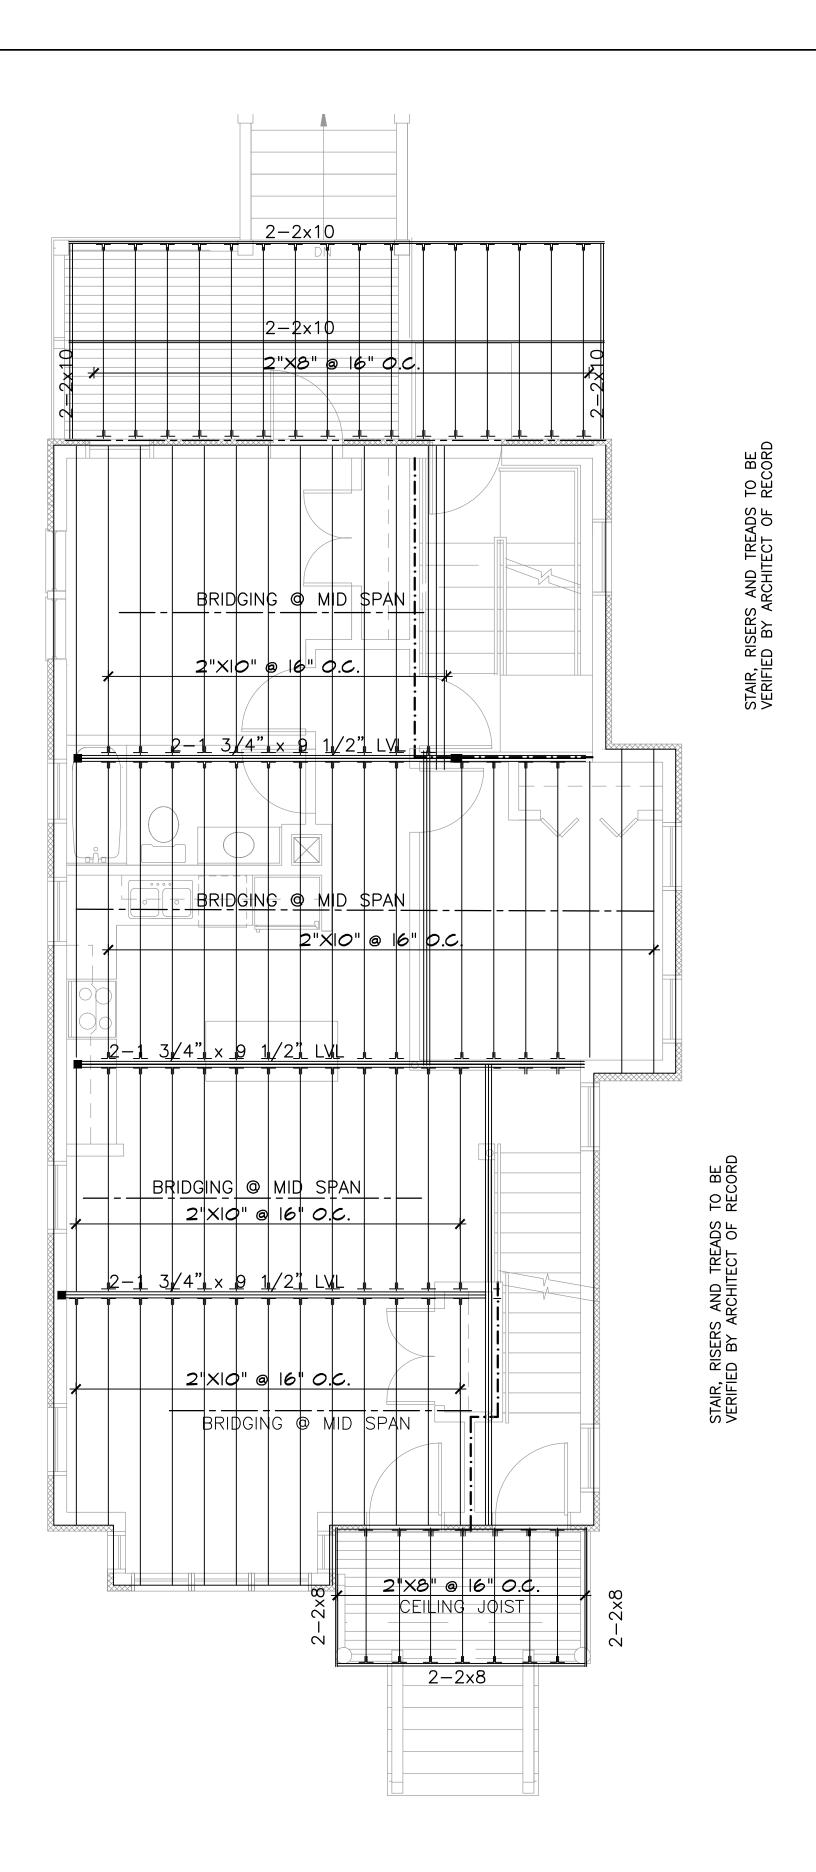

2ND FLOOR FRAMING PLAN

SCALE: 1/4"=1'-0"

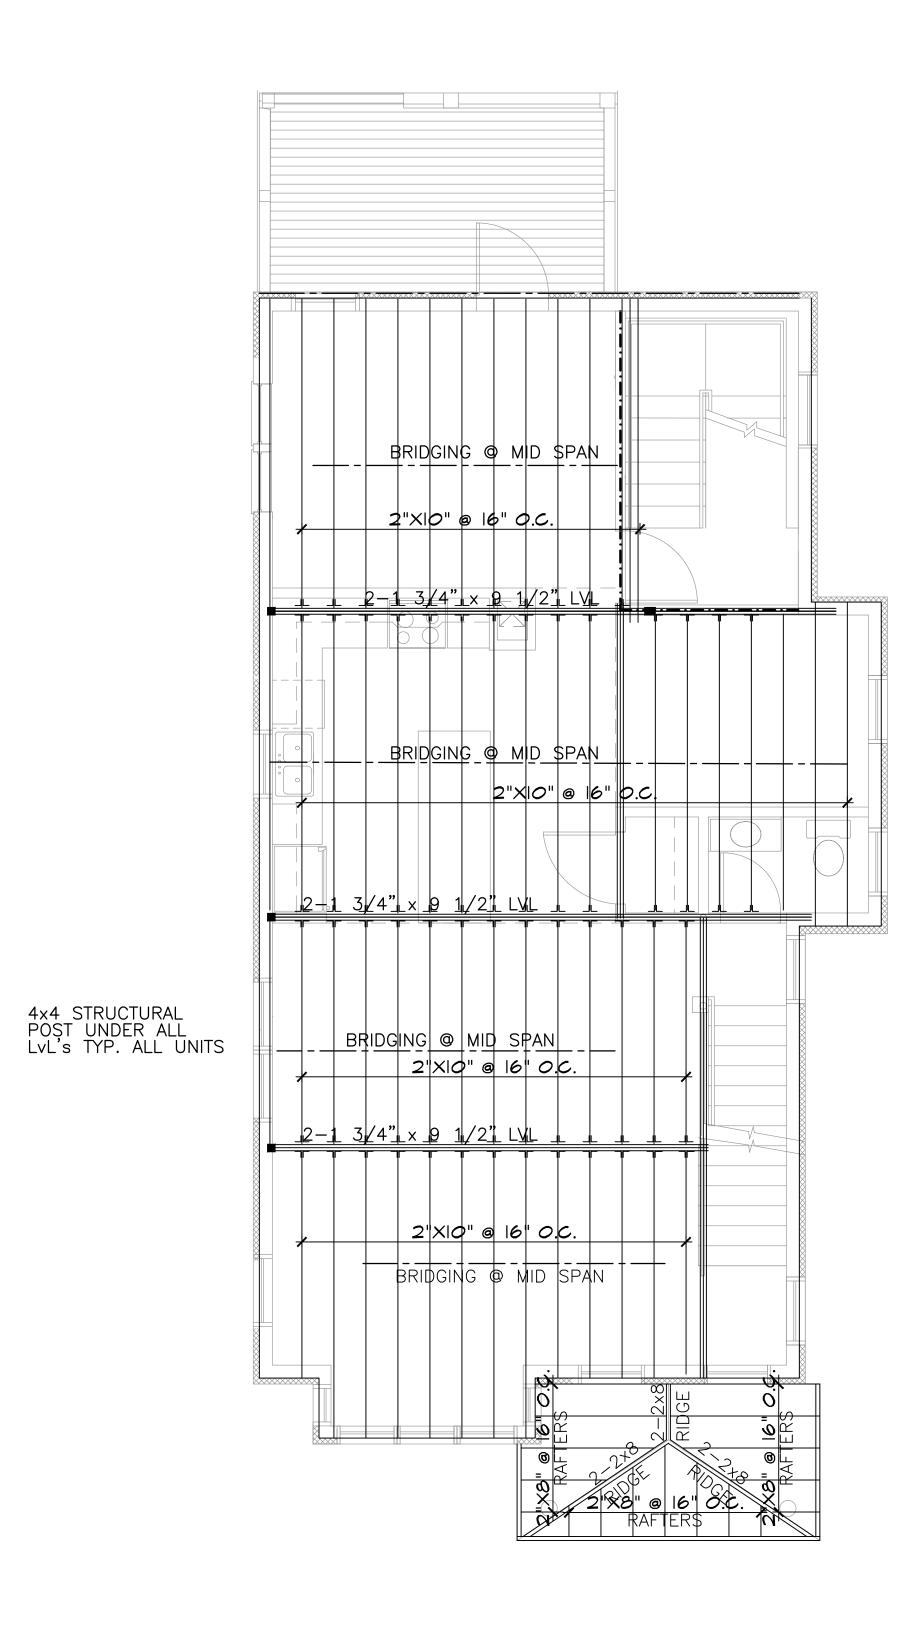

THIRD FLOOR FRAMING PLAN

SCALE: 1/4"=1'-0"

## Micheal Washington Architects Inc.

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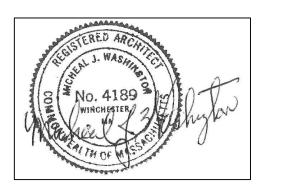
PROJECT

#### **NEW ENGLAND HERITAGE HOMES**

DORCHESTER, MASSACHUSETTS

#### **CODMAN SQUARE NEIGHBORHOOD DEVELOPMENT** CORPORATION

DORCHESTER, MASSACHUSETTS



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2ND & ATTIC FLOOR FRAMING PLANS

SEE SITE ON COVER PAGE FOR ADDRESS AND UNIT LOCATION


DATE: 12/01/2015

FILE: NEHH.dwg

DRAWING NO.

**S-H.2** 

#### SEE SECTION FOR SLOPE

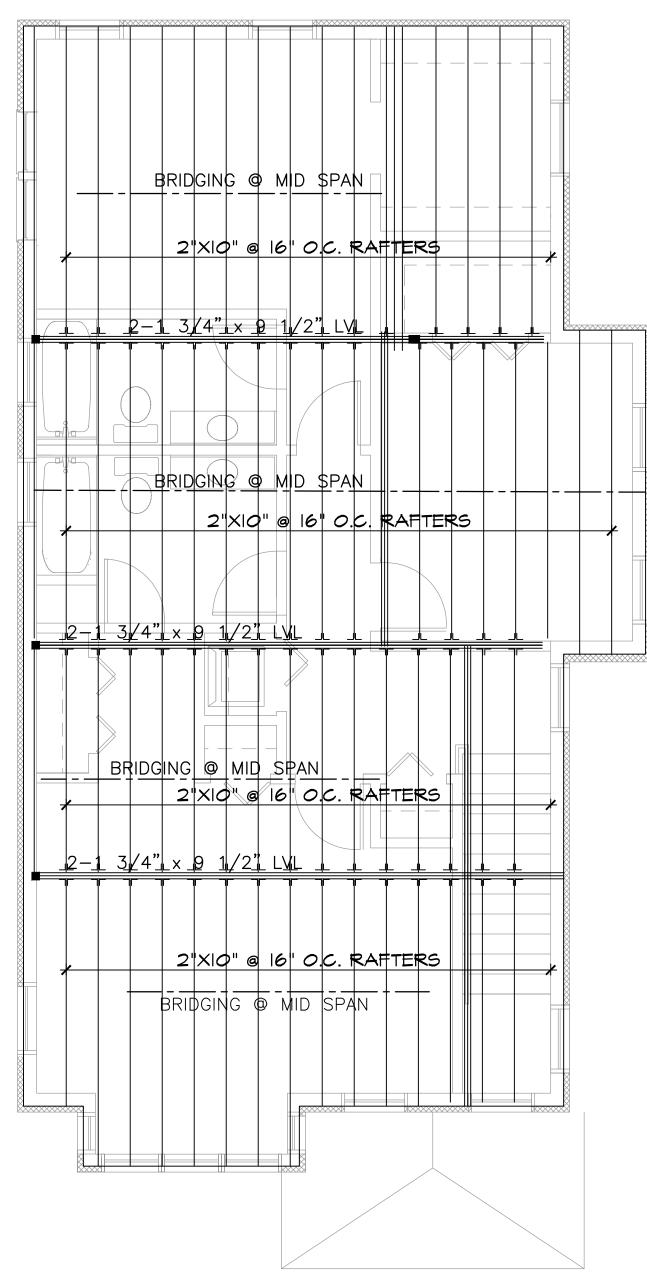

ROOF FRAMING PLAN
SCALE: 1/4"=1'-0"

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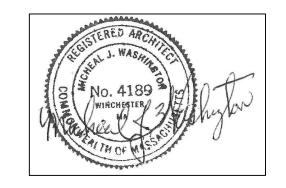
#### NEW ENGLAND HERITAGE HOMES

DORCHESTER, MASSACHUSETTS

DEVELOPER

## CODMAN SQUARE NEIGHBORHOOD DEVELOPMENT CORPORATION

DORCHESTER, MASSACHUSETTS



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ROOF FRAMING PLAN


SEE SITE ON COVER PAGE FOR ADDRESS AND UNIT LOCATION

1/4"=1'-0" DRAWING NO.

2/01/2015

S-H.3



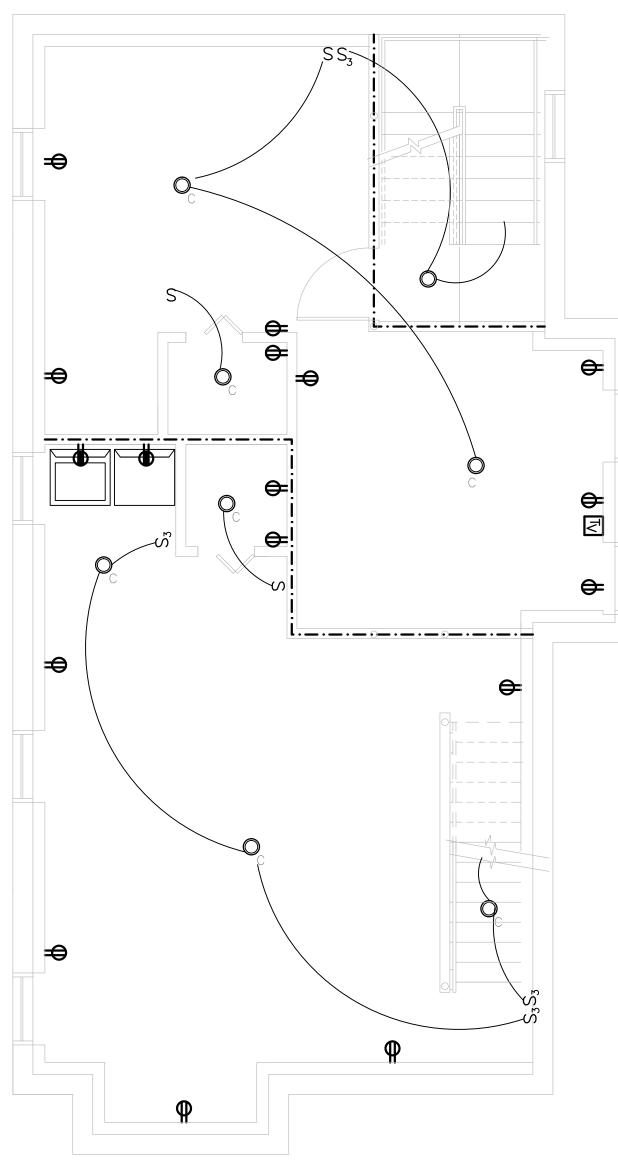

BASEMENT ELECTRICAL PLAN

SCALE: 1/4"=1'-0"

ELECT	<u>ELECTRICAL SYMBOLS</u>				
0	CEILING MOUNTED LIGHT FIXTURE.				
	WALL MOUNTED LIGHT FIXTURE.				
	2'X2' OR 2'X4' FLUORESCENT LIGHT FIXTURE.				
	1'x4' FLUORESCENT WALL/CEILING MOUNTED LIGHT FIXTURE.				
S S₃	SINGLE POLE LIGHT SWITCH				
S <sub>D</sub>	THREE-WAY LIGHT SWITCHES  DIMMER SWITCH MINIMUM 1000W OR AS REQUIRED PER CIRCUIT				
Φ	DUPLEX RECEPTACLE, 120V,18" AFF.				
⊕ <sup>GFI</sup>	DUPLEX RECEPTACLE WITH GROUND FAULT INTERRUPTER 8" ABOVE COUNTER TO Q				
•	DUPLEX RECEPTACLE, 120V,18" AFF., ONE OUTLET SWITCHED				
#	120V DOUBLE DUPLEX CONVENIENCE RECEPTACLE				
$lackbox{}{lackbox{}}{lackbox{}{lackbox{}{lackbox{}}{lackbox{}{lackbox{}}{lackbox{}{lackbox{}}{lackbox{}}{lackbox{}{lackbox{}}{lackbo$	DUPLEX RECEPTACLE ABOVE COUNTER, 8" ABOVE COUNTER TO φ.				
▼	TELEPHONE JACK COMPLETE W/JACK AND COVER, WALL MOUNTED @ 4'-0" A.F.F)				
$\bigcirc$	MOTOR				
<b>(</b> \$)	SYSTEM TYPE SMOKE DETECTOR - DBEC				
(\$) <sub>D</sub>	DUCT SMOKE DETECTOR W/REMOTE TEST SWITCH - DBEC				
( <del>1)</del>	HEAT DETECTOR - DBEC				
$\sum \sum^{F}$	FIRE ALARM AUDIO/VISUAL UNIT. MTD. @ 6'-8" AFF - DBEC				
H	FIRE ALARM MINI HORN - DBEC				
<b>(</b> )	JUNCTION BOX — DBEC				
	LIGHTING & POWER PANEL, RECESSED - DBEC				
FACP	FIRE ALARM CONTROL PANEL - DBEC				
ANN	FIRE ALARM ANNUNCIATOR — DBEC				
TV	CABLE				
DBEC - DI	ESIGN AND INSTALLED BY ELECTRICAL CONTRACTOR				

	FIXTURE SCHEDULE								
TYPE	MANUFACTURER	CATALOG NUMBER	VOLT	LAMP	DESCRIPTION				
U1	PROGRESS	P2851-09	120	(2)23WCFL MINI-TWIST	KITCHEN				
U2	PROGRESS	P3688-09	120	(1)13 CFL MINI-TWIST	ENTRANCE/LIVING RM/ HALLWAY & STAIR				
U3	PROGRESS	P6163-09WB	120	(4)50W MR16	DINING ROOM				
U4	PROGRESS	P3408-09	120	(1)13 CFL MINI-TWIST	CLOSET LIGHT				
U5	PROGRESS	P3688-09	120	(1)13 CFL MINI-TWIST	BEDROOM LIGHT				
U6	PROGRESS	P3223-09WB	120	(3)60W HALOGEN G9	BATHROOM VANITY ABOVE SINK				
U7	PROGRESS	P3410-09	120	(2)13 CFL MINI-TWIST	BATHROOM CEILING LIGHT				
А	PROGRESS	P6017-84	120	(2)18W CFL	EXTERIOR CEILING MOUNTED				
В	PROGRESS	P5749-84	120	(1)18W CFL	EXTERIOR WALL MOUNTED				
С	PROGRESS	P3688-09	120	(1)13 CFL MINI-TWIST	BASEMENT LIGHT				
D	PROGRESS	P2501-04			CEILING FAN				

Washington
Architects Inc.
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PROJECT

NEW ENGLAND
HERITAGE HOMES

Micheal

DORCHESTER, MASSACHUSETTS


DEVELOPER

CODMAN SQUARE NEIGHBORHOOD DEVELOPMENT CORPORATION

DORCHESTER, MASSACHUSETTS

MECHANICAL SYSTEMS Fajitsu, mitshubishi, or equal mini split heat pump system
 Compressor sized
 4 Heads. HEATING/COOLING SYSTEM: 4. No ducts shall be installed5. HSPF of 12 or greater 6. SEER of 20 or greater HOT WATER SYSTEM: Gas domestic hot water system — instantaneous gas dhw system EF of .95 or higher If gas is not available use Electric heat pump water heater Locate Unit as Desired. Provide energy recovery system (ERV) by Panasonic FV04VE1, Venmar or equivalent ERV SYSTEM: Capable of meeting ventilation code 50-80 CFM that meets the 2012 IECC standards for efficacy Provide a radon resistant construction techniques including a passive system which from the perforated pipe under the slab, up through slab, PASSIVE RADON SYSTEM: and house, terminating above the roof with an electrical outlet in the attic for installing a fan, making it an active system, if there is a high reading measured. ASTM E1465 Practice for Radon Control Options TO BE SOLAR PV READY: Install Conduit from roof to area in basement In basement room for a solar meter, an inverter and a switch box On exterior of basement room following the local electric company guidelines, an accessible safety off switch box PLUMBING: Water Sense (EPA) for all interior plumbing devices; Showerhead Toilet Lavatory Faucet Use Energy Star Appliances APPLIANCES: Use Electric Range and exhaust range to exterior Power Requirement, Panel Location, Fire Alarm, CO2, Security and Final Design by the Architect and

Engineers of Record.

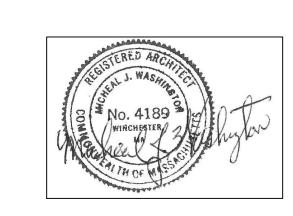

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SHEET TITLE


TYPE H TWO FAMILY BASEMENT ELECTRICAL PLAN SCHEDULES AND MECHANICAL NOTE

SEE SITE ON COVER PAGE FOR ADDRESS AND UNIT LOCATION

SCALE: 1/4"=1'-0"


DATE: 12/01/2015

CHECKED BY: MW FILE: NEHH.dwg E-H.1

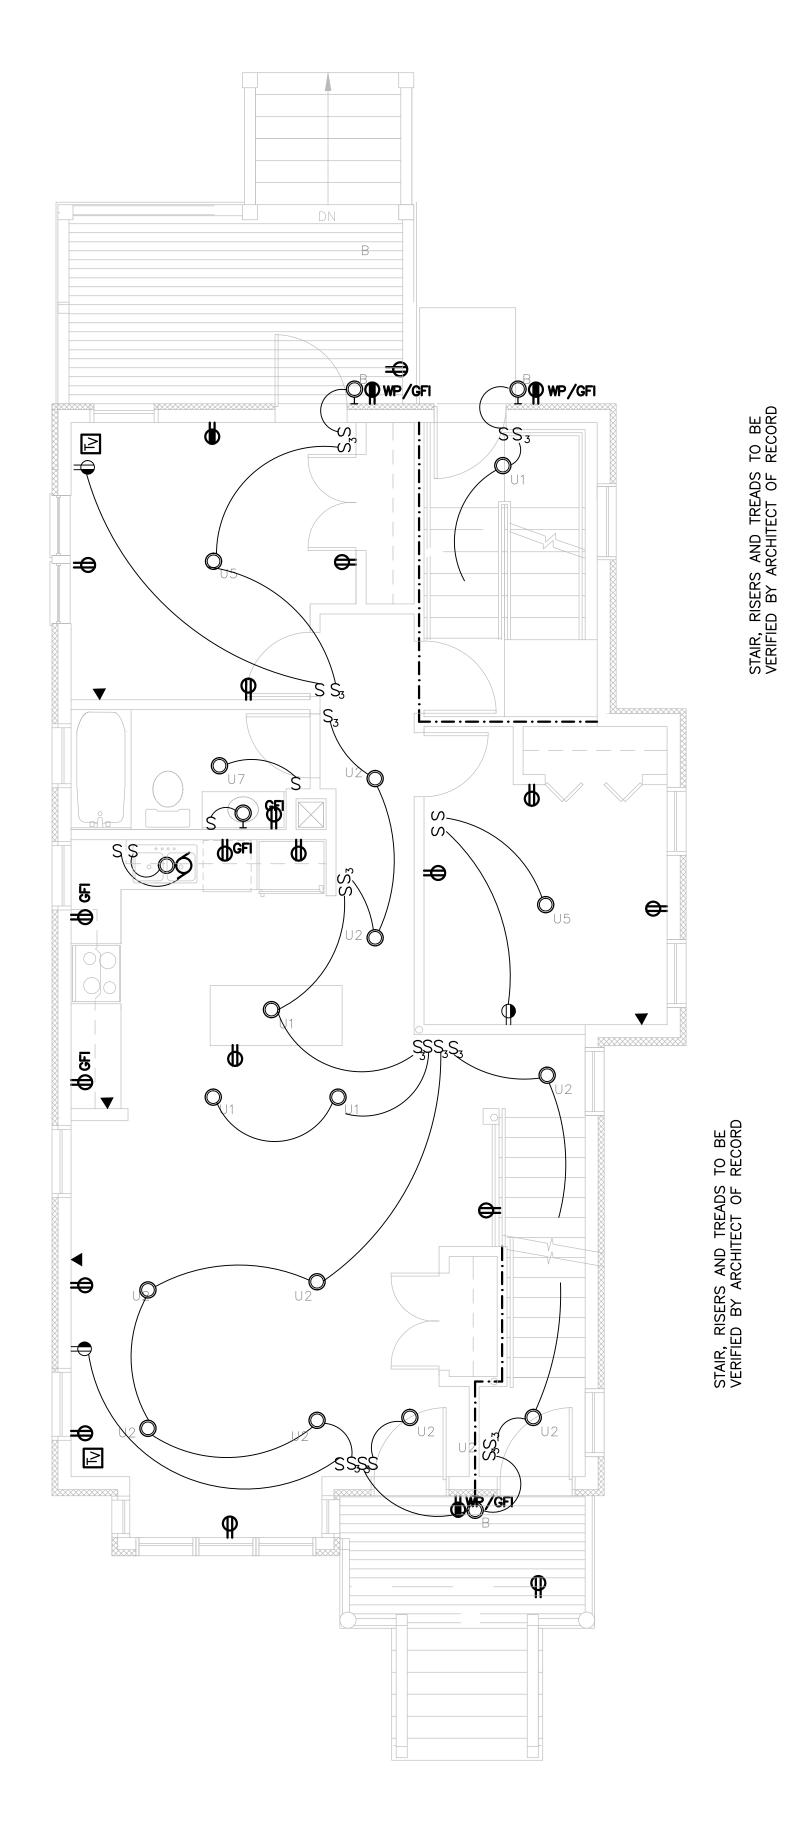

1ST FLOOR ELECTRICAL PLAN

SCALE: 1/4"=1'-0"

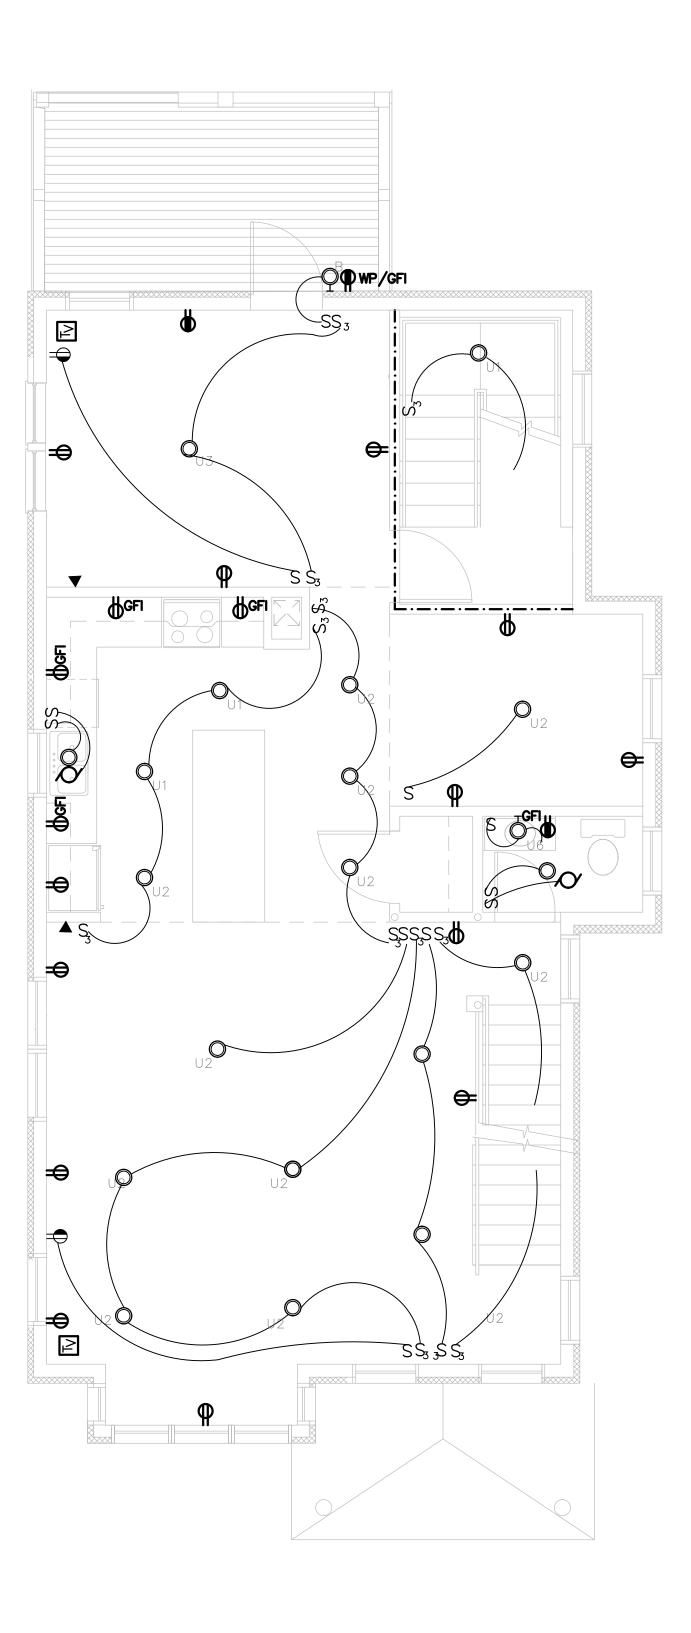

2ND FLOOR ELECTRICAL PLAN SCALE: 1/4"=1'-0"

# Micheal Washington Architects Inc.

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PROJECT


#### NEW ENGLAND HERITAGE HOMES

DORCHESTER, MASSACHUSETTS

DEVELOPER

## CODMAN SQUARE NEIGHBORHOOD DEVELOPMENT CORPORATION

DORCHESTER, MASSACHUSETTS

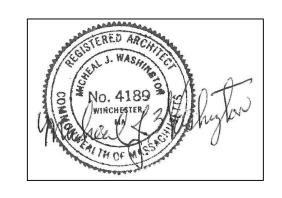

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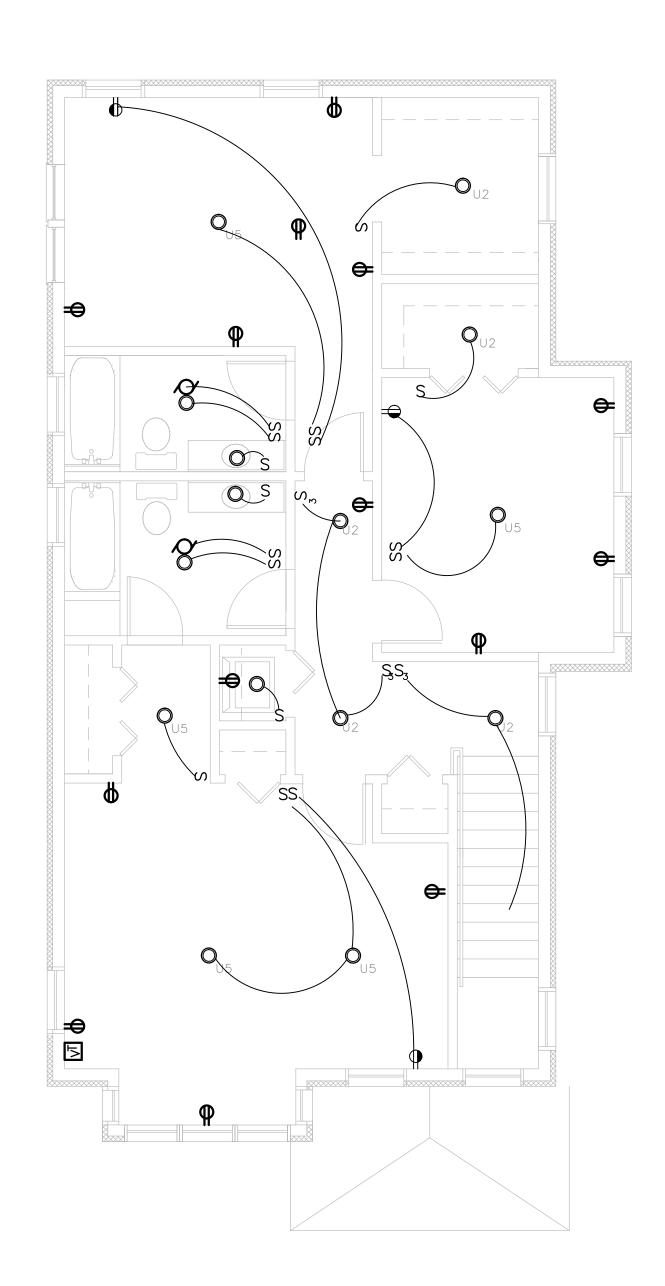
SHEET TITLE

TYPE H TWO FAMILY 1ST & 2ND FLOOR ELECTRICAL PLANS

SEE SITE ON COVER PAGE FOR ADDRESS AND UNIT LOCATION

ALE: TE: 12/01/2015 AWN BY: DRAWING NO.

E-H.2



3RD FLOOR ELECTRICAL PLAN
scale: 1/4"=1'-0"

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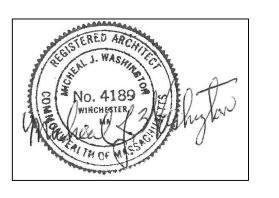
## NEW ENGLAND HERITAGE HOMES

DORCHESTER, MASSACHUSETTS

DEVELOPER

# CODMAN SQUARE NEIGHBORHOOD DEVELOPMENT CORPORATION

DORCHESTER, MASSACHUSETTS



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SHEET TIT

H-UNITS ATTIC ELECTRICAL

SEE SITE ON COVER PAGE FOR ADDRESS AND UNIT LOCATION

SCALE:

DATE: 12/01/201

DRAWING NO.

E-H.3

34 MALLARD AVENUE ( BUILDING EM)

# "NEW ENGLAND HERITAGE HOMES" AFFORDABLE HOMEOWNERSHIP DEVELOPMENT

PREPARED FOR:

# CODMAN SQUARE NEIGHBORHOOD DEVELOPMENT CORPORATION


587 WASHINGTON STREET DORCHESTER, MA 02124

PREPARED BY:

MICHEAL WASHINGTON ARCHITECTS, INC.

891 CENTRE ST. JAMAICA PLAIN, MA 02130 TEL: (617) 390-5515

EMAIL: mwainc1@hotmail.com

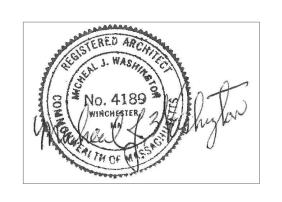

I. ALL DRAWINGS WILL BE UPDATED AND MODIFIED 2. ALL GENERAL DRAWINGS TO BE UPDATED INCLUDING REMOVAL OF HUNTER PANELS AND DOWNGRADING R VALUES TO CURRENT CODE. 3. WINDOW REQUIREMENTS TO BE DETERMINED LATER.

NOTES:

I. ALL WORK AND PERMITS AND APPROVALS WILL BE OBTAINED BY THE TRADE AND COORDINATED BY THE GENERAL CONTRACTOR AND THE OWNER. ALL WORK SHALL COMPLY WITH ALL PROVISIONS OF THE MASSACHUSETTS STATE BUILDING CODE, CURRENT EDITION, AND LOCAL CITY AND TOWN PROVISIONS.

2. ALL CONSTRUCTION IS TO COMPLY WITH THE MASSACHUSETTS STATE BUILDING CODE, EIGHTH EDITION AND WITH ALL SUPPLEMENTS, AMENDMENTS, AND OTHER APPLICABLE CODES AND REGULATIONS.

3. ALL ROOF INSULATION SHALL BE R-49; ALL WALLS SHALL BE R-21 AND IN COMPLIANCE WITH THE IECC REQUIREMENTS.ALLFIRST FLOOR AREAS R-30, IN COMPLIANCE WITH IBC REQUIREMENTS.

4. CONTRACTOR IS TO VERIFY ALL DIMENSION IN THE FIELD, NOTIFY ARCHITECT IF THERE ARE ANY VARIATIONS.

# 34 MALLARD AVENUE (BUILDING EM)

### LIST OF DRAWINGS

ARCHITEC	ARCHITECTURAL INDEX OF DRAWINGS		ARCHITECTURAL INDEX OF DRAWINGS	
NUMBER	DRAWING NAME	NUMBER	DRAWING NAME	
		GENERAL I	ORAMINGS	
T-I	TITLE SHEET	6-1	KICTHEN PLANS & ELEVATIONS	
		<b>6-2</b> .l	BATH PLANS & ELEVATIONS	
		<i>6-</i> 3	MINDOMS & DOORS SCHEDULE	
C-I	EXISTING CONDITIONS	6-4	FINISH SCHEDULE & PARTITION TYPE	
BPP	BUILDING PLOT PLAN	<i>G-</i> 5.I	MALL SECTIONS	
ARCHITEC	TURAL EM UNIT	<i>G-</i> 5.2	WALL SECTIONS	
A-1.0	BASEMENT & FIRST FLOOR PLAN	- 4 .		
A-I.I	SECOND & THIRD FLOOR PLANS	6-6.1	GENERAL TYPICAL DETAILS GENERAL TYPICAL DETAILS	
A-I.2	ROOF FLOOR PLAN	G-6.2	CENERAL III ICAE DETAILS	

### 34 MALLARD AVENUE

ZONING INFORMATION		
ZONING: 3F-6000 WARD 14 1 FAMILY ATTACHED	REQUIRED	ACTUAL
MIN. LOT SIZE:	6000 SF FOR 2 UNITS + 2500 PER ADDT'L UNIT	2,390 SF
MIN. LOT WIDTH:	40 FT	26.55'FT
MIN. LOT FRONTAGE:	40 FT	26.55' FT
MAX. F.A.R:	0.4	0.67
MAX. BLDG. HEIGHT:	2 1/2 STORY 35	35 FT
MIN. OPEN SPACE:	750 SF PER UNIT	1,769 SQ. FT.
MIN. FRONT YARD DEPTH:	15FT/MOD.	16.8 FT
MIN. SIDE YARD DEPTH:	10 FT	10.0 FT
	10 FT	
MIN. REAR YARD DEPTH:	20 FT	36.3 FT
MIN. PARKING:	1/UNIT	1

# 32 MALLARD AVENUE (BUILDING EM) "NEW ENGLAND HERITAGE HOMES" AFFORDABLE HOMEOWNERSHIP DEVELOPMENT

PREPARED FOR:

# CODMAN SQUARE NEIGHBORHOOD DEVELOPMENT CORPORATION


587 WASHINGTON STREET DORCHESTER, MA 02124

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EMAIL: mwainc1@hotmail.com



I. ALL DRAWINGS WILL BE UPDATED AND MODIFIED 2. ALL GENERAL DRAWINGS TO BE UPDATED INCLUDING REMOVAL OF HUNTER PANELS AND DOWNGRADING R VALUES TO CURRENT CODE. 3. WINDOW REQUIREMENTS TO BE DETERMINED LATER.

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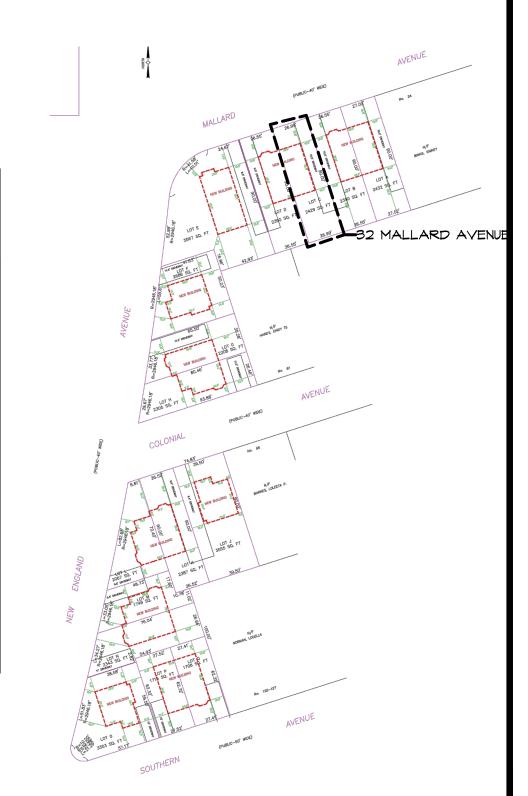
# 32 MALLARD AVENUE (BUILDING EM)
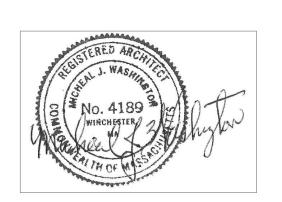
### LIST OF DRAWINGS

ARCHITECTURAL INDEX OF DRAWINGS		ARCHITECTURAL INDEX OF DRAWINGS		
NUMBER	DRAWING NAME	NUMBER	DRAWING NAME	
		GENERAL I	DRAMINGS	
T-I	TITLE SHEET	6-1	KICTHEN PLANS & ELEVATIONS	
		G-2.I	BATH PLANS & ELEVATIONS	
		<i>6-</i> 3	MINDOWS & DOORS SCHEDULE	
C-I	EXISTING CONDITIONS	6-4	FINISH SCHEDULE & PARTITION TYPE	
BPP	BUILDING PLOT PLAN	<i>G-</i> 5.1	WALL SECTIONS	
ARCHITEC	TURAL EM UNIT	<i>G-</i> 5.2	WALL SECTIONS	
A-1.0	BASEMENT & FIRST FLOOR PLAN			
A-I.I	SECOND & THIRD FLOOR PLANS	G-6.I	GENERAL TYPICAL DETAILS GENERAL TYPICAL DETAILS	
A-I.2	ROOF FLOOR PLAN	6-6.2	CEREICAE III IOAE DETAILS	

### 32 MALLARD AVENUE

JZ WALLAND AVENUE		
ZONING INFORMATION		
ZONING: 3F-6000 WARD 14 1 FAMILY ATTACHED	REQUIRED	ACTUAL
LOT SIZE:	6000 SF FOR 2 UNITS + 2500 PER ADDT'L UNIT	2,429 SF
LOT WIDTH:	40 FT	26.99' FT
LOT FRONTAGE:	40 FT	26.99' FT
F.A.R:	0.4	0.66
BLDG. HEIGHT:	2 1/2 STORY 35	35 FT
OPEN SPACE:	750 SF PER UNIT	1,820 SQ. FT.
FRONT YARD DEPTH:	15FT/MOD.	16.8 FT
SIDE YARD DEPTH:	10 FT	10.5 FT
REAR YARD DEPTH:	20 FT	36.3 FT
PARKING:	1/UNIT	1



# 30 MALLARD AVENUE ( BUILDING EM)

# "NEW ENGLAND HERITAGE HOMES" AFFORDABLE HOMEOWNERSHIP DEVELOPMENT

PREPARED FOR:

# CODMAN SQUARE NEIGHBORHOOD DEVELOPMENT CORPORATION


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# 30 MALLARD AVENUE (BUILDING EM)

### LIST OF DRAWINGS

ARCHITECT	TURAL INDEX OF DRAWINGS	ARCHITECTURAL INDEX OF DRAWINGS		
NUMBER	DRAWING NAME	NUMBER	DRAWING NAME	
		GENERAL I	DRAMINGS	
T-I	TITLE SHEET	<b>G-</b> I	KICTHEN PLANS & ELEVATIONS	
		G-2.I	BATH PLANS & ELEVATIONS	
		6-3	MINDOMS & DOORS SCHEDULE	
C-I	EXISTING CONDITIONS	G-4	FINISH SCHEDULE & PARTITION TYPES	
BPP	BUILDING PLOT PLAN	<i>G-</i> 5.I	MALL SECTIONS	
ARCHITECT	TURAL EM UNIT	<i>6</i> -5.2	MALL SECTIONS	
A-1.0	BASEMENT & FIRST FLOOR PLAN	- 4.		
A-I.I	SECOND & THIRD FLOOR PLANS	6-6.1	GENERAL TYPICAL DETAILS GENERAL TYPICAL DETAILS	
A-I.2	ROOF FLOOR PLAN	G-6.2	CENERAL III ICAE DETAILS	

30 MALLARD AVENUE

ZONING INFORMATION		
ZONING: 3F-6000 WARD 14 1 FAMILY ATTACHED	REQUIRED	ACTUAL
MIN. LOT SIZE:	6000 SF FOR 2 UNITS + 2500 PER ADDT'L UNIT	2,390 SF
MIN. LOT WIDTH:	40 FT	26.55' FT
MIN. LOT FRONTAGE:	40 FT	26.55' FT
MAX. F.A.R:	0.4	0.67
MAX. BLDG. HEIGHT:	2 1/2 STORY 35	35 FT
MIN. OPEN SPACE:	750 SF PER UNIT	1,769 SQ. FT.
MIN. FRONT YARD DEPTH:	15FT/MOD.	16.8 FT
MIN. SIDE YARD DEPTH:	10 FT 10 FT	10.0 FT
MIN. REAR YARD DEPTH:	20 FT	36.3 FT
MIN. PARKING:	1/UNIT	1

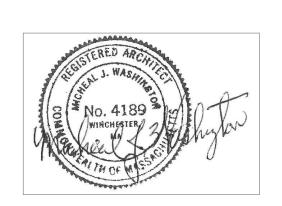

# 28 MALLARD AVENUE (BUILDING EM)

# "NEW ENGLAND HERITAGE HOMES" AFFORDABLE HOMEOWNERSHIP DEVELOPMENT

PREPARED FOR:

# CODMAN SQUARE NEIGHBORHOOD DEVELOPMENT CORPORATION


587 WASHINGTON STREET DORCHESTER, MA 02124

PREPARED BY:

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891 CENTRE ST. JAMAICA PLAIN, MA 02130 TEL: (617) 390-5515

EMAIL: mwainc1@hotmail.com

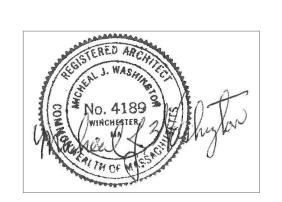

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# 28 MALLARD AVENUE (BUILDING EM)

### LIST OF DRAWINGS

ARCHITECTURAL INDEX OF DRAWINGS ARCHITECTURAL INDEX OF DRAWINGS DRAWING NAME KICTHEN PLANS & ELEVATIONS BATH PLANS & ELEVATIONS WINDOWS & DOORS SCHEDULE FINISH SCHEDULE & PARTITION TYPES MALL SECTIONS WALL SECTIONS BASEMENT & FIRST FLOOR PLAN GENERAL TYPICAL DETAILS GENERAL TYPICAL DETAILS ROOF FLOOR PLAN

EXTERIOR ELEVATIONS

28 MALLARD AVENUE		
ZONING INFORMATION		
ZONING: 3F-6000 WARD 14 1 FAMILY ATTACHED	REQUIRED	ACTUAL
LOT SIZE:	6000 SF FOR 2 UNITS + 2500 PER ADDT'L UNIT	2,432 SF
LOT WIDTH:	40 FT	27.02'FT
LOT FRONTAGE:	40 FT	27.02' FT
F.A.R:	0.4	0.66
BLDG. HEIGHT:	2 1/2 STORY 35	35 FT
OPEN SPACE:	750 SF PER UNIT	1,823 SQ. FT.
FRONT YARD DEPTH:	15FT/MOD.	16.8 FT
SIDE YARD DEPTH:	10 FT 10 FT	10.5 FT
REAR YARD DEPTH:	20 FT	36.3 FT
PARKING:	1/UNIT	1



129 SOUTHERN AVENUE ( BUILDING EM)

# "NEW ENGLAND HERITAGE HOMES" AFFORDABLE HOMEOWNERSHIP DEVELOPMENT

PREPARED FOR:

# CODMAN SQUARE NEIGHBORHOOD DEVELOPMENT CORPORATION


587 WASHINGTON STREET DORCHESTER, MA 02124

PREPARED BY:

MICHEAL WASHINGTON ARCHITECTS, INC.

891 CENTRE ST.
JAMAICA PLAIN, MA 02130
TEL: (617) 390-5515

EMAIL: mwainc1@hotmail.com

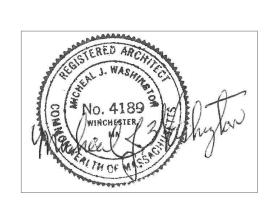

I. ALL DRAWINGS WILL BE UPDATED AND MODIFIED

2. ALL GENERAL DRAWINGS TO BE UPDATED
INCLUDING REMOVAL OF HUNTER PANELS AND
DOWNGRADING R VALUES TO CURRENT CODE.

3. WINDOW REQUIREMENTS TO BE DETERMINED LATER.

NOTES:

I. ALL WORK AND PERMITS AND APPROVALS WILL BE OBTAINED BY THE TRADE AND COORDINATED BY THE GENERAL CONTRACTOR AND THE OWNER. ALL WORK SHALL COMPLY WITH ALL PROVISIONS OF THE MASSACHUSETTS STATE BUILDING CODE, CURRENT EDITION, AND LOCAL CITY AND TOWN PROVISIONS.

2. ALL CONSTRUCTION IS TO COMPLY WITH THE MASSACHUSETTS STATE BUILDING CODE, EIGHTH EDITION AND WITH ALL SUPPLEMENTS, AMENDMENTS, AND OTHER APPLICABLE CODES AND REGULATIONS.

3. ALL ROOF INSULATION SHALL BE R-49; ALL WALLS SHALL BE R-21 AND IN COMPLIANCE WITH THE IECC REQUIREMENTS.ALLFIRST FLOOR AREAS R-30, IN COMPLIANCE WITH IBC REQUIREMENTS.

4. CONTRACTOR IS TO VERIFY ALL DIMENSION IN THE FIELD, NOTIFY ARCHITECT IF THERE ARE ANY VARIATIONS.

# 129 SOUTHERN AVENUE ( BUILDING EM)

### LIST OF DRAWINGS

ARCHITECTURAL INDEX OF DRAWINGS ARCHITECTURAL INDEX OF DRAWINGS DRAWING NAME DRAWING NAME KICTHEN PLANS & ELEVATIONS BATH PLANS & ELEVATIONS MINDOWS & DOORS SCHEDULE FINISH SCHEDULE & PARTITION TYPES WALL SECTIONS MALL SECTIONS BASEMENT & FIRST FLOOR PLAN GENERAL TYPICAL DETAILS SECOND & THIRD FLOOR PLANS GENERAL TYPICAL DETAILS ROOF FLOOR PLAN EXTERIOR ELEVATIONS

### 129 SOUTHERN AVENUE

EXTERIOR ELEVATIONS

ZONING INFORMATION		
ZONING: 3F-6000 WARD 14 1 FAMILY ATTACHED	REQUIRED	ACTUAL
MIN. LOT SIZE:	6000 SF FOR 2 UNITS + 2500 PER ADDT'L UNIT	1,708 SF
MIN. LOT WIDTH:	40 FT	27.41' FT
MIN. LOT FRONTAGE:	40 FT	27.41' FT
MAX. F.A.R:	0.4	0.94
MAX. BLDG. HEIGHT:	2 1/2 STORY 35	35 FT
MIN. OPEN SPACE:	750 SF PER UNIT	1,087 SQ. FT.
MIN. FRONT YARD DEPTH:	15FT/MOD.	15.3 FT
MIN. SIDE YARD DEPTH:	10 FT	10.9 FT
MIN. REAR YARD DEPTH:	20 FT	10.1 FT
MIN. PARKING:	1/UNIT	1



# 131 SOUTHERN AVENUE ( BUILDING EM)

# "NEW ENGLAND HERITAGE HOMES" AFFORDABLE HOMEOWNERSHIP DEVELOPMENT

PREPARED FOR:

# CODMAN SQUARE NEIGHBORHOOD DEVELOPMENT CORPORATION


587 WASHINGTON STREET DORCHESTER, MA 02124

PREPARED BY:

MICHEAL WASHINGTON ARCHITECTS, INC.

891 CENTRE ST. JAMAICA PLAIN, MA 02130 TEL: (617) 390-5515

EMAIL: mwainc1@hotmail.com

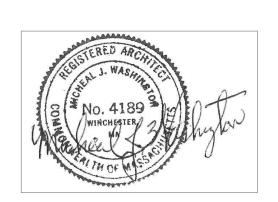

I. ALL DRAWINGS WILL BE UPDATED AND MODIFIED 2. ALL GENERAL DRAWINGS TO BE UPDATED INCLUDING REMOVAL OF HUNTER PANELS AND DOWNGRADING R VALUES TO CURRENT CODE. 3. WINDOW REQUIREMENTS TO BE DETERMINED LATER.

NOTES:

I. ALL WORK AND PERMITS AND APPROVALS WILL BE OBTAINED BY THE TRADE AND COORDINATED BY THE GENERAL CONTRACTOR AND THE OWNER. ALL WORK SHALL COMPLY WITH ALL PROVISIONS OF THE MASSACHUSETTS STATE BUILDING CODE, CURRENT EDITION, AND LOCAL CITY AND TOWN PROVISIONS.

2. ALL CONSTRUCTION IS TO COMPLY WITH THE MASSACHUSETTS STATE BUILDING CODE, EIGHTH EDITION AND WITH ALL SUPPLEMENTS, AMENDMENTS, AND OTHER APPLICABLE CODES AND REGULATIONS.

3. ALL ROOF INSULATION SHALL BE R-49; ALL WALLS SHALL BE R-21 AND IN COMPLIANCE WITH THE IECC REQUIREMENTS.ALLFIRST FLOOR AREAS R-30, IN COMPLIANCE WITH IBC REQUIREMENTS.

4. CONTRACTOR IS TO VERIFY ALL DIMENSION IN THE FIELD, NOTIFY ARCHITECT IF THERE ARE ANY VARIATIONS.

# 131 SOUTHERN AVENUE ( BUILDING EM)


### LIST OF DRAWINGS


ARCHITECTURAL INDEX OF DRAWINGS ARCHITECTURAL INDEX OF DRAWINGS DRAWING NAME KICTHEN PLANS & ELEVATIONS BATH PLANS & ELEVATIONS MINDOWS & DOORS SCHEDULE FINISH SCHEDULE & PARTITION TYPES WALL SECTIONS MALL SECTIONS BASEMENT & FIRST FLOOR PLAN GENERAL TYPICAL DETAILS SECOND & THIRD FLOOR PLANS GENERAL TYPICAL DETAILS ROOF FLOOR PLAN

EXTERIOR ELEVATIONS EXTERIOR ELEVATIONS

131 SOUTHERN AVENUE		
ZONING INFORMATION		
ZONING: 3F-6000 WARD 14 1 FAMILY ATTACHED	REQUIRED	ACTUAL
LOT SIZE:	6000 SF FOR 2 UNITS + 2500 PER ADDT'L UNIT	1,715 SF
LOT WIDTH:	40 FT	27.52' FT
LOT FRONTAGE:	40 FT	27.52' FT
F.A.R:	0.4	0.94
BLDG. HEIGHT:	2 1/2 STORY 35	35 FT
OPEN SPACE:	750 SF PER UNIT	1,106 SQ. FT.
FRONT YARD DEPTH:	15FT/MOD.	15.3 FT
SIDE YARD DEPTH:	10 FT	11.0 FT
REAR YARD DEPTH:	20 FT	10.1 FT
PARKING:	1/UNIT	1



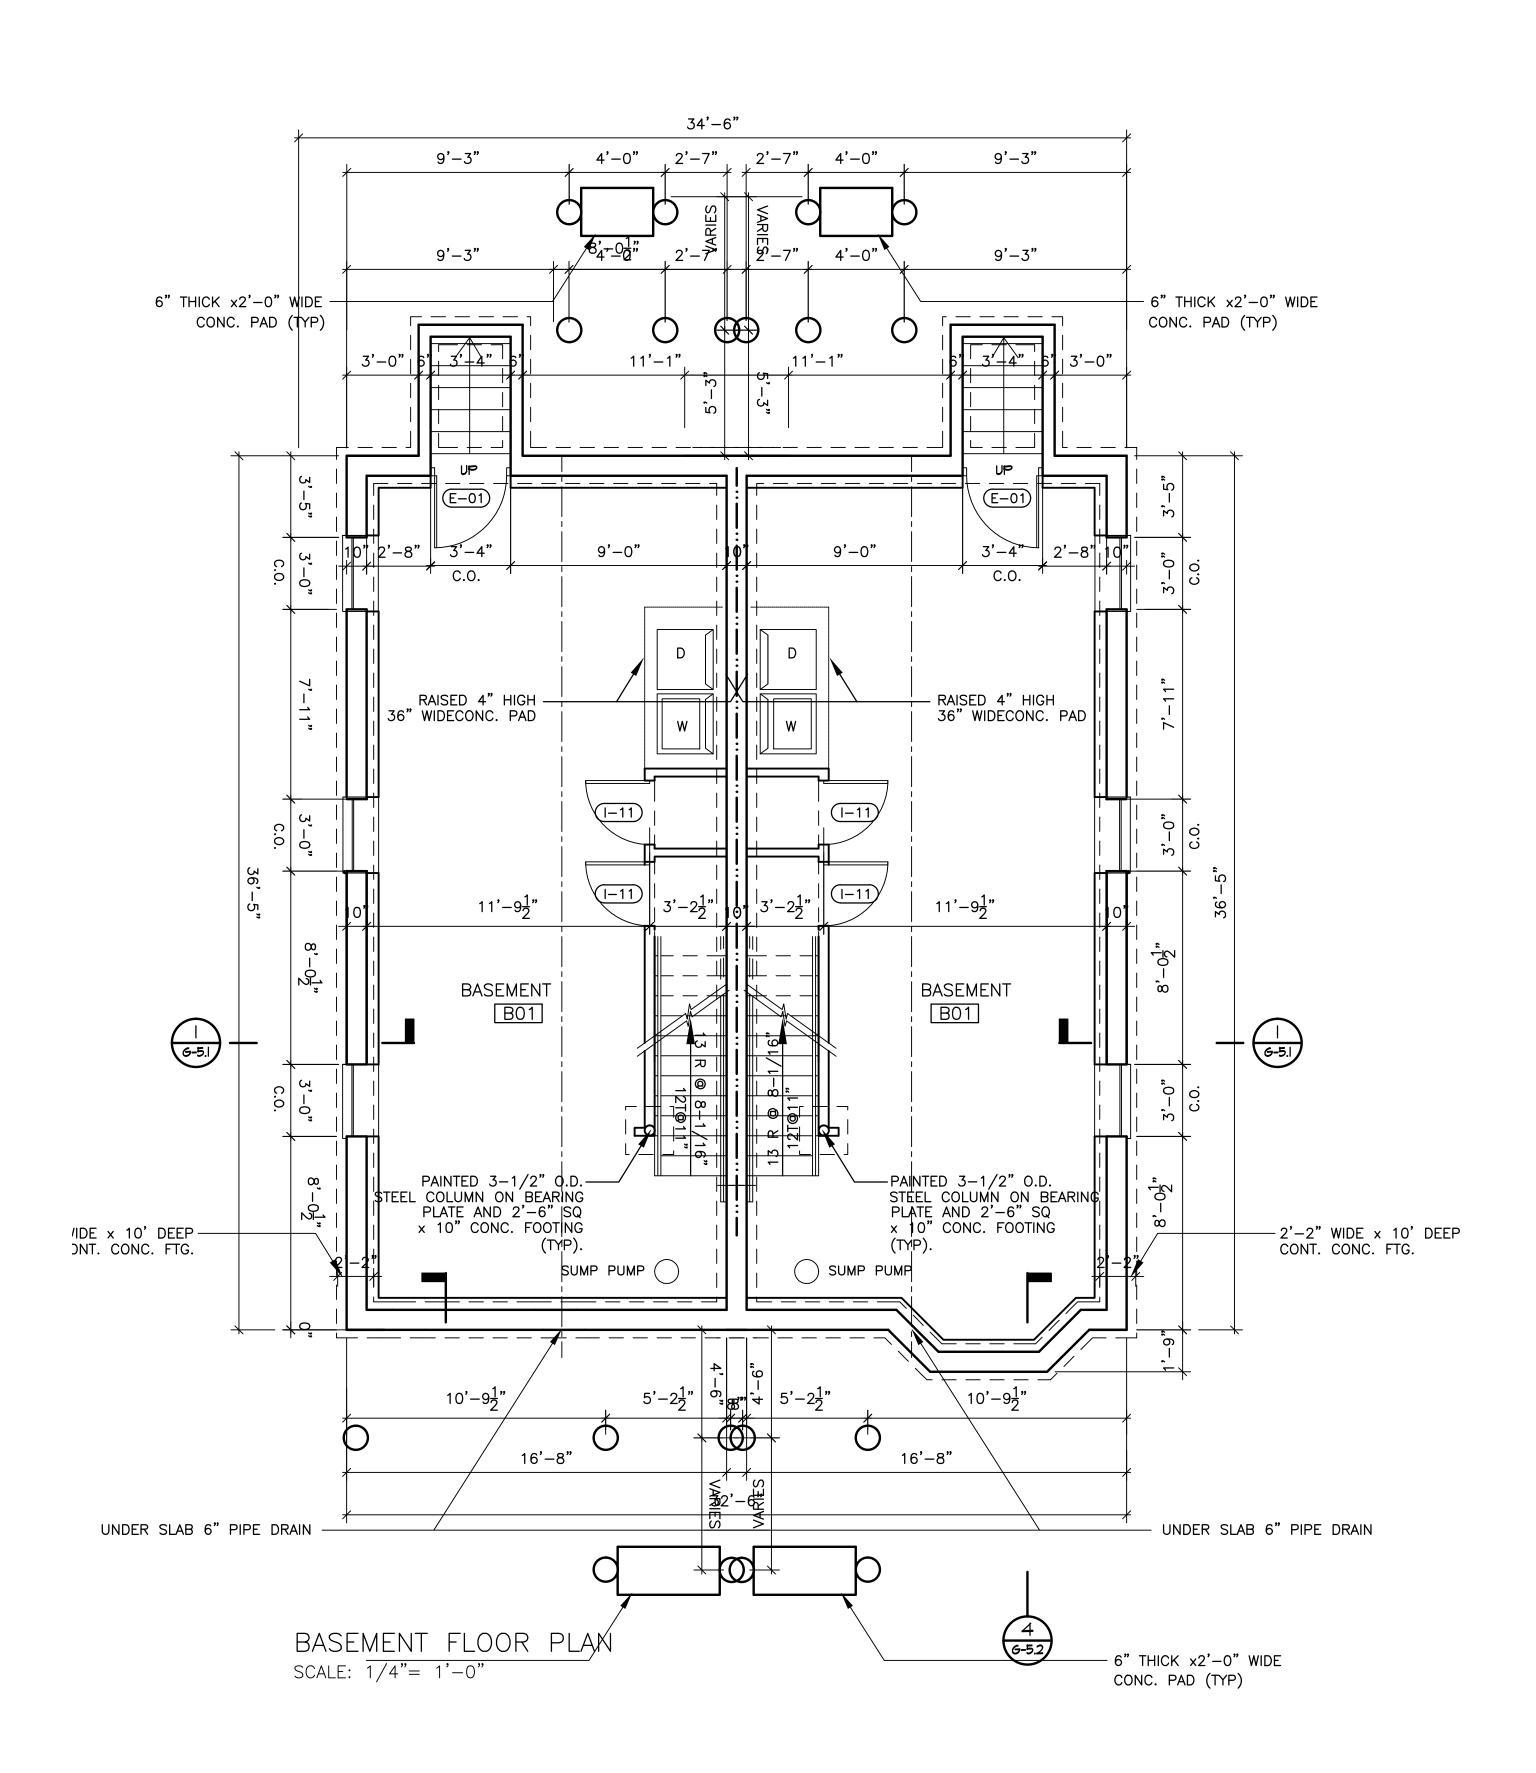

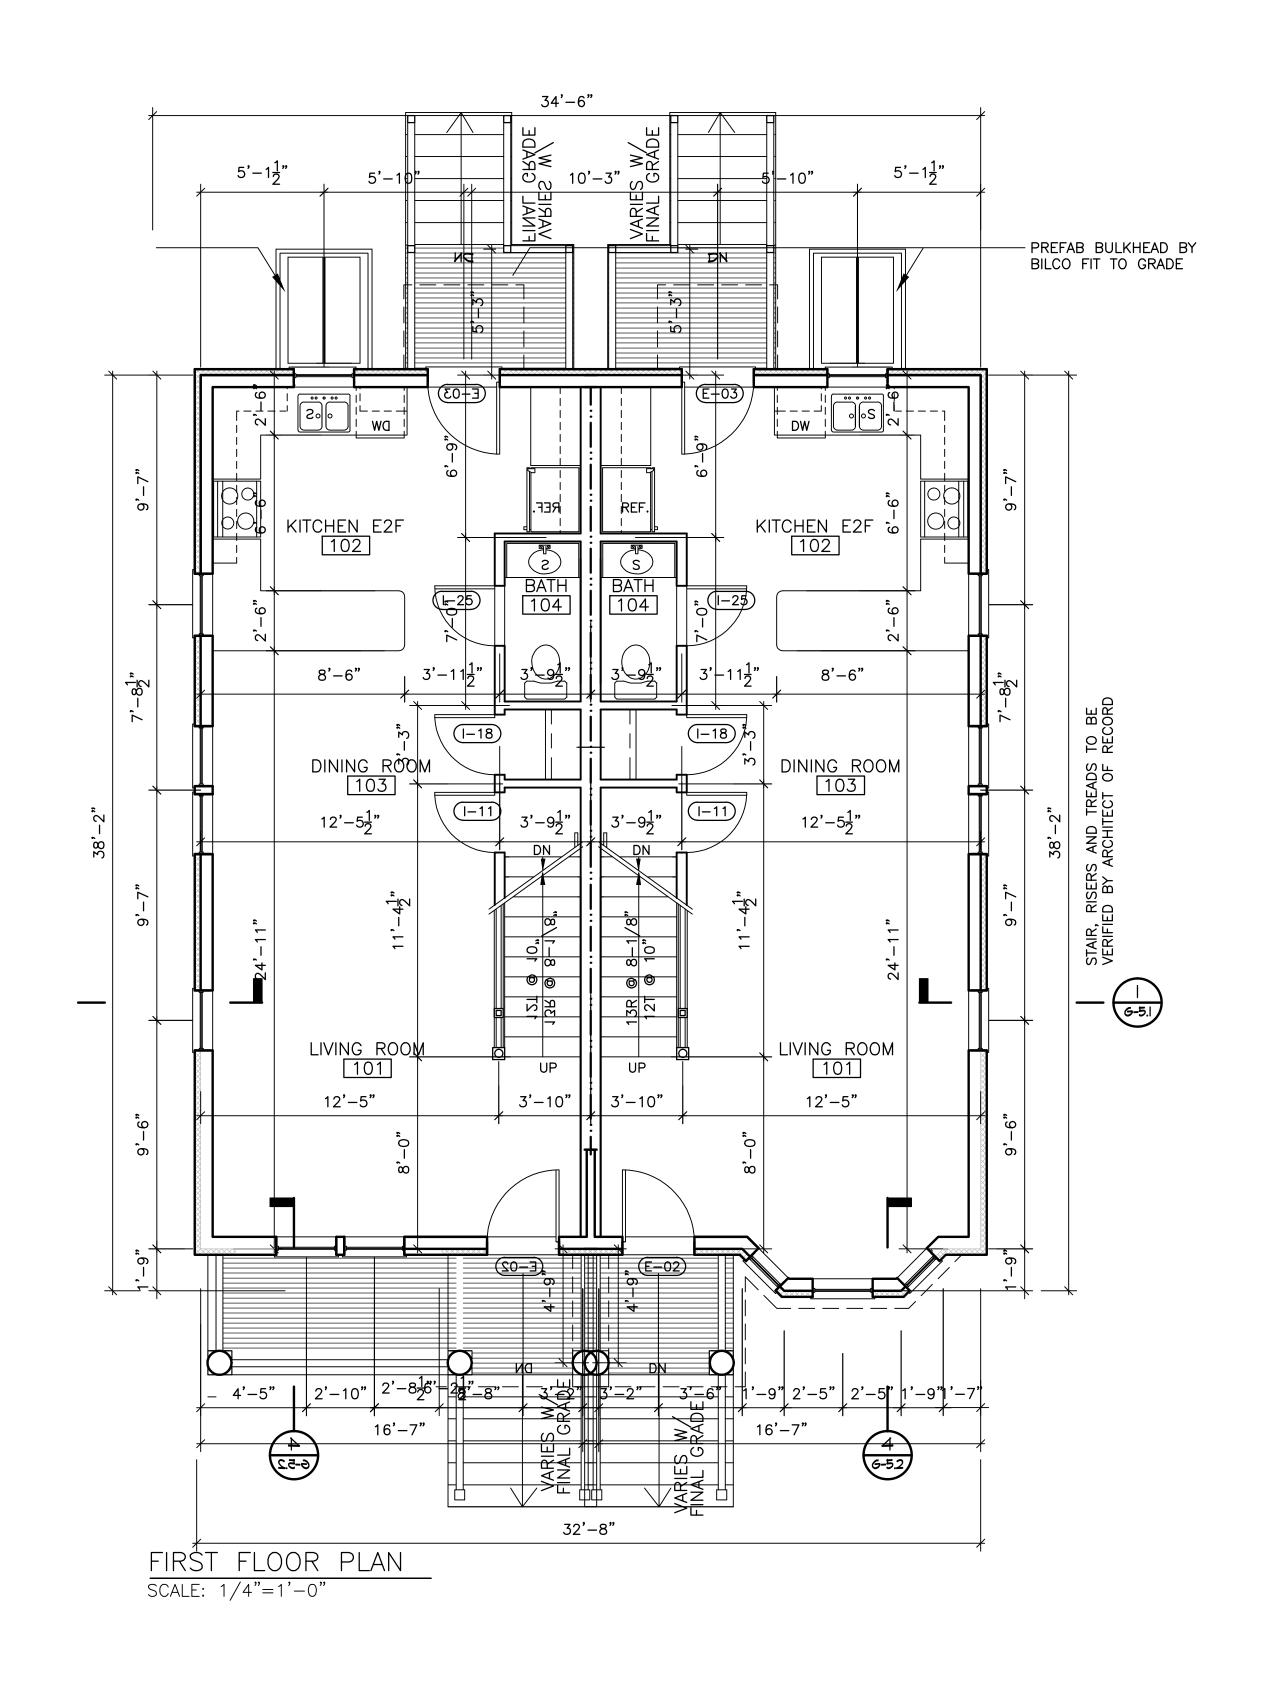

# Micheal Washington Architects Inc.

891 Centre Street Jamaica Plain, MA 02130

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PROJECT

### **NEW ENGLAND HERITAGE HOMES**

DORCHESTER, MASSACHUSETTS

DEVELOPER

### **CODMAN SQUARE NEIGHBORHOOD DEVELOPMENT CORPORATION**

DORCHESTER, MASSACHUSETTS

LEGEND:

TWO HOUR RATED PARTITION

ONE HOUR RATED PARTITION

I. SEE G-4 FOR PARTITION TYPES.

2. SEE GA-I FOR ENLARGED KITCHEN PLANS AND ELEVATIONS.

3. DIMENSIONS ARE TO EXTERIOR FACE OF EXTERIOR STUD WALL AND EXTERIOR FACE OF FOUNDATION WALL.

4. DIMENSIONS ARE TO CENTERLINE OF STUDS ON INTERIOR WALLS UNLESS OTHERWISE NOTED.



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SHEET TITLE

### TYPE EM **BASEMENT &** FIRST FLOOR PLAN

SEE SITE ON COVER PAGE FOR ADDRESS AND UNIT LOCATION


12/01/201

FILE: NEHH.dwg


CHECKED BY: MW

**A-EM.1** 

DRAWING NO.

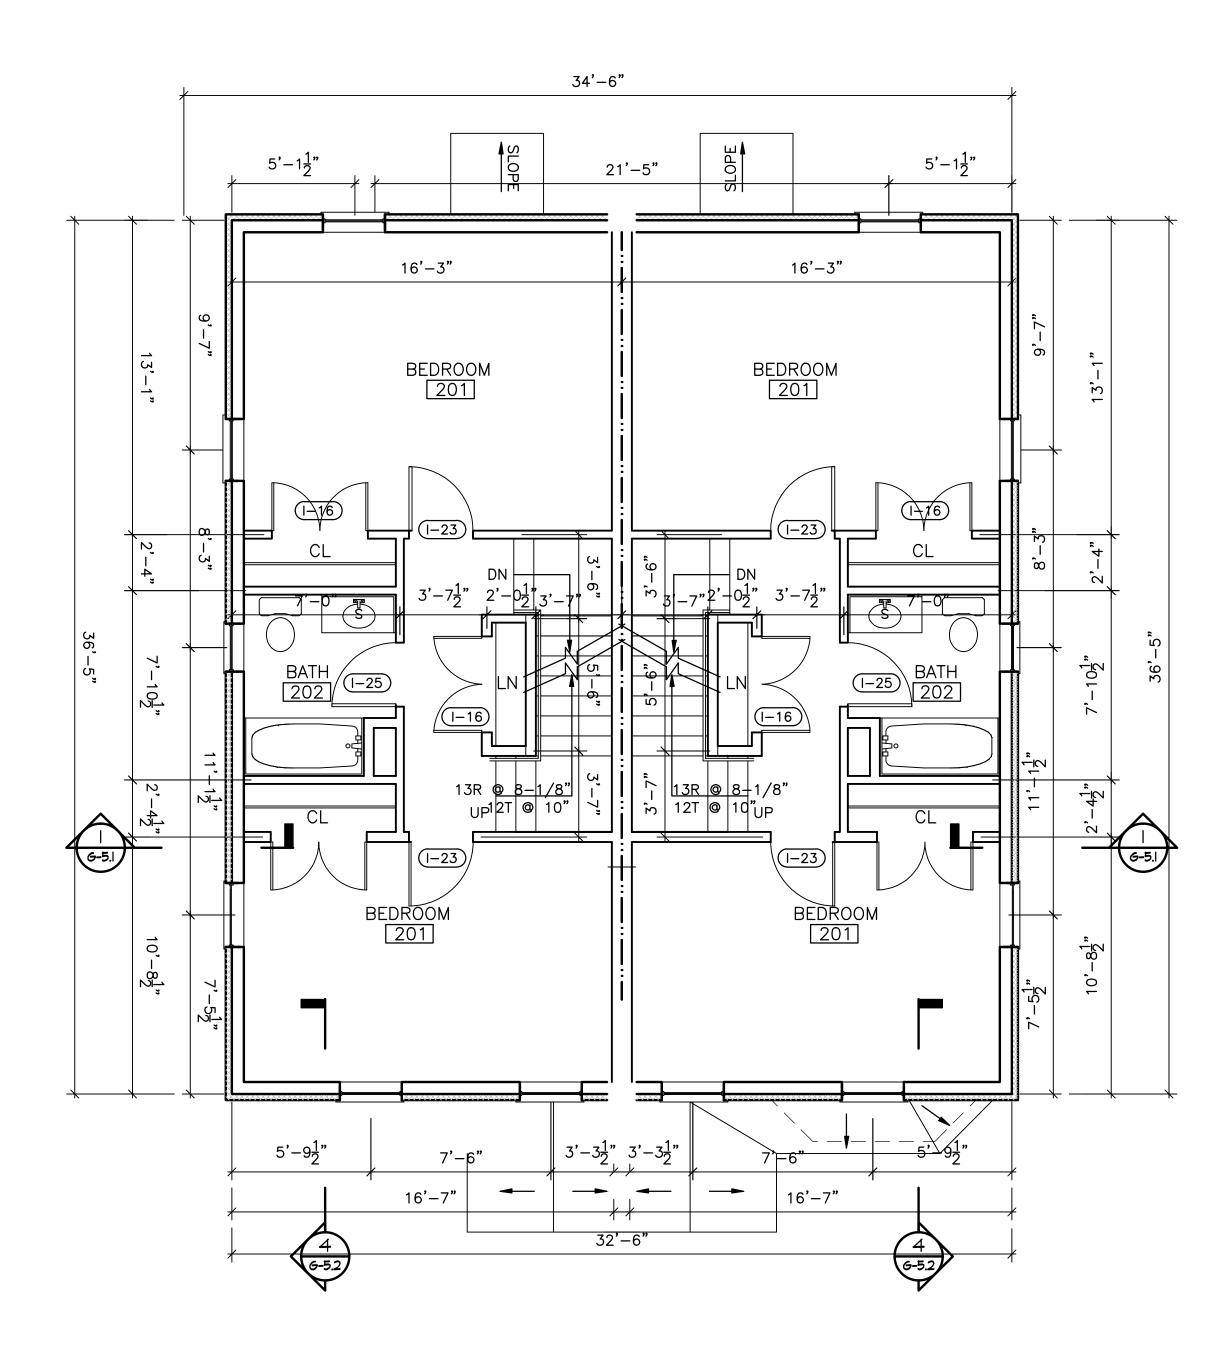

SCALE: 1/4"=1'-0"

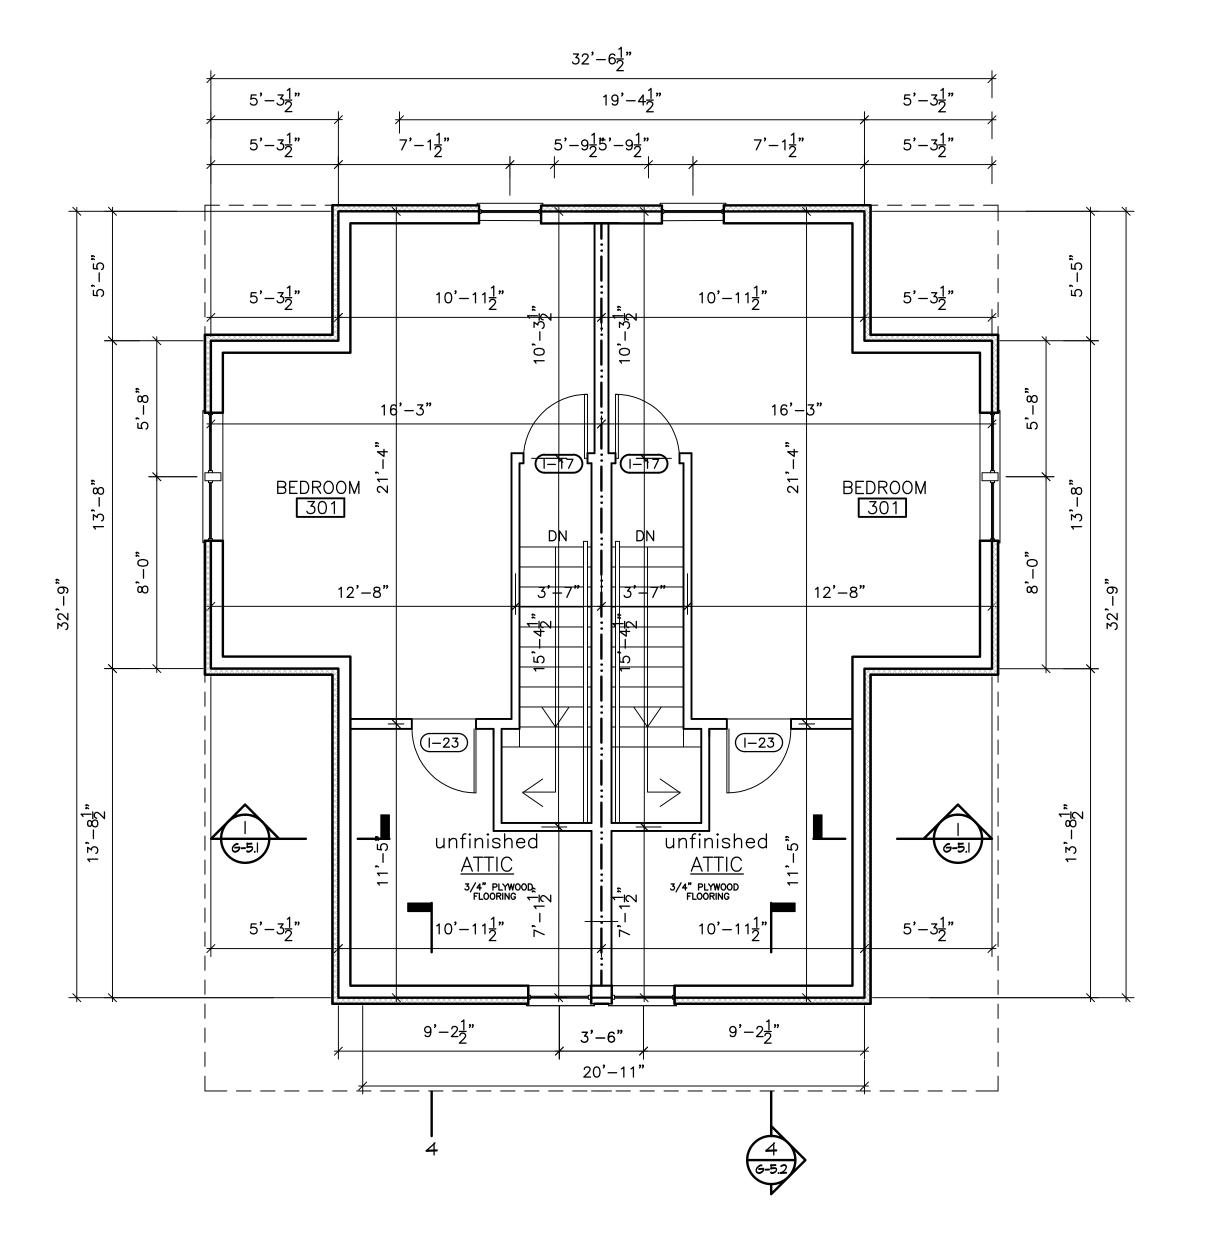

THIRD FLOOR PLAN

SCALE: 1/4"= 1'-0"

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PROJECT

### NEW ENGLAND HERITAGE HOMES

DORCHESTER, MASSACHUSETTS

DEVELOPER

# CODMAN SQUARE NEIGHBORHOOD DEVELOPMENT CORPORATION

DORCHESTER, MASSACHUSETTS

LEGEND:

TWO HOUR RATED PARTITION

ONE HOUR RATED PARTITION


NOTES

I. SEE 6-4 FOR PARTITION TYPES.

2. SEE GA-I FOR ENLARGED KITCHEN PLANS AND ELEVATIONS.

3. DIMENSIONS ARE TO EXTERIOR FACE OF EXTERIOR STUD WALL AND EXTERIOR FACE OF FOUNDATION WALL.

4. DIMENSIONS ARE TO CENTERLINE OF STUDS ON INTERIOR WALLS UNLESS OTHERWISE NOTED.

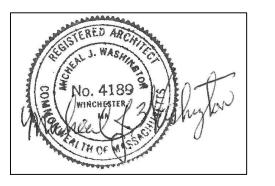

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SHEET TITLE

# TYPE EM SECOND & THIRD FLOOR PLAN


SEE SITE ON COVER PAGE FOR ADDRESS AND UNIT LOCATION

1/4"=1'-0" DRAWING NO.

FILE: NEHH.dwg

12/01/2015 :

A-EM.2

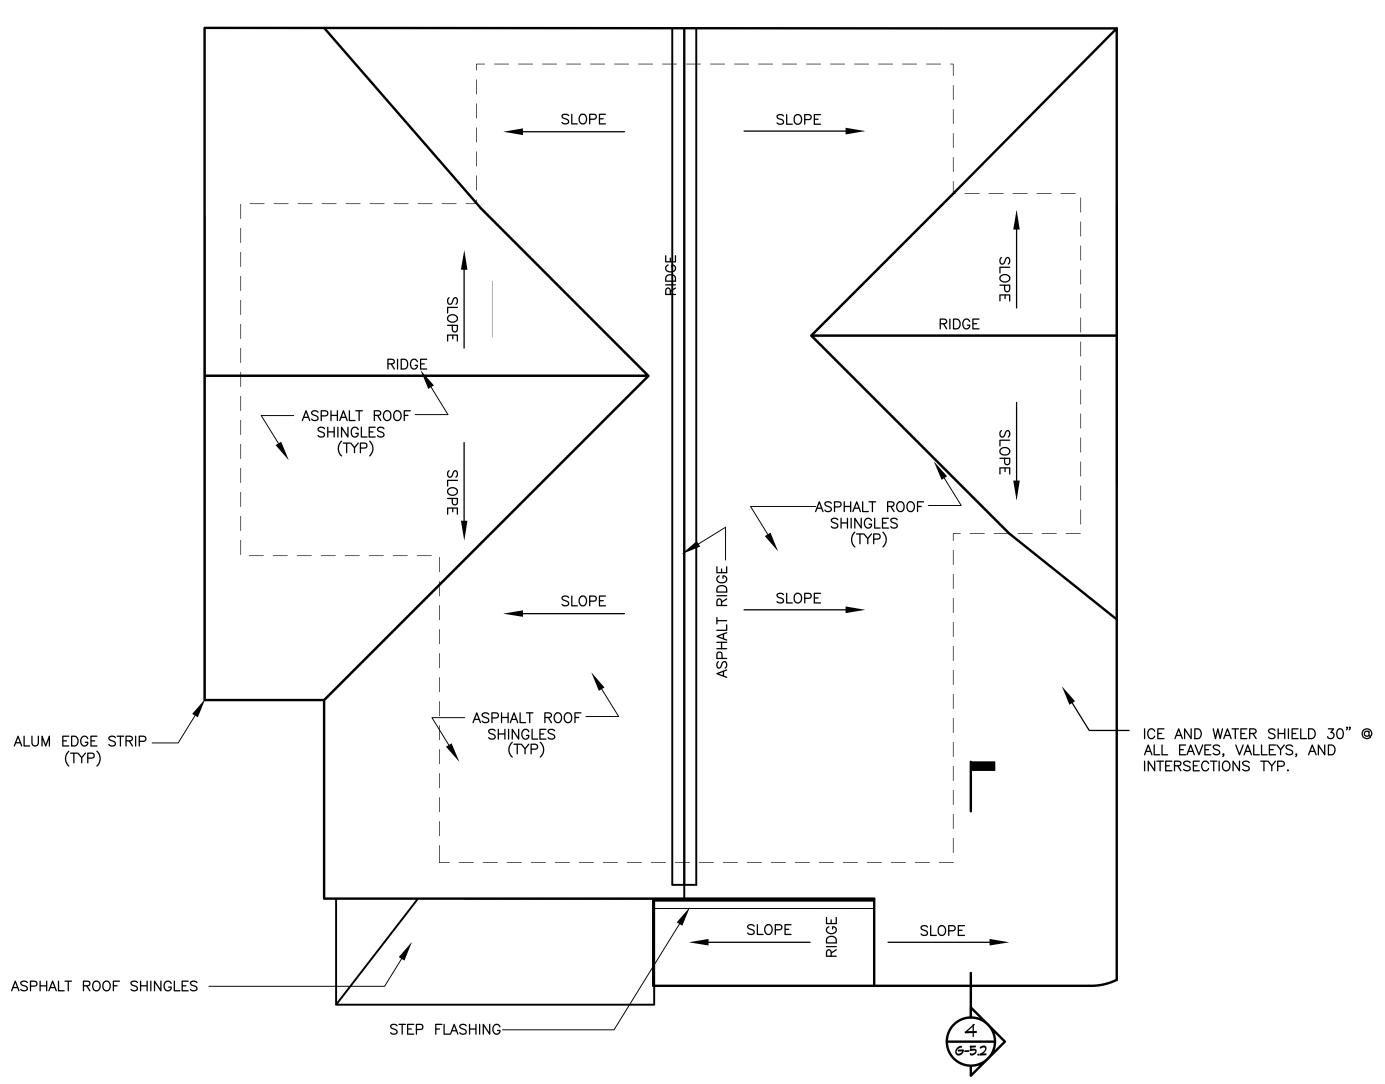

ROOF PLAN
SCALE: 1/4"=1'-0"

# Micheal Washington Architects Inc.

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Phone: 617-390-5515 E-MAIL: MWAINC1@HOTMAIL.COM

PROJECT

### **NEW ENGLAND HERITAGE HOMES**

DORCHESTER, MASSACHUSETTS

### **CODMAN SQUARE NEIGHBORHOOD DEVELOPMENT** CORPORATION

DORCHESTER, MASSACHUSETTS

LEGEND:

TWO HOUR RATED PARTITION


ONE HOUR RATED PARTITION

I. SEE G-4 FOR PARTITION TYPES.

2. SEE GA-I FOR ENLARGED KITCHEN PLANS AND ELEVATIONS.

3. DIMENSIONS ARE TO EXTERIOR FACE OF EXTERIOR STUD WALL AND EXTERIOR FACE OF FOUNDATION WALL.

4. DIMENSIONS ARE TO CENTERLINE OF STUDS ON INTERIOR WALLS UNLESS OTHERWISE NOTED.

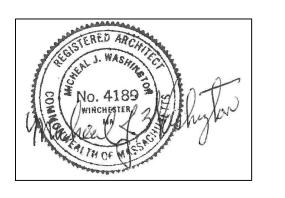

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SHEET TITLE

TYPE EM

ROOF PLAN

SEE SITE ON COVER PAGE FOR ADDRESS AND UNIT LOCATION


DATE: 12/01/2015

CHECKED BY: MW FILE: NEHH.dwg

DRAWING NO.

A-EM.3



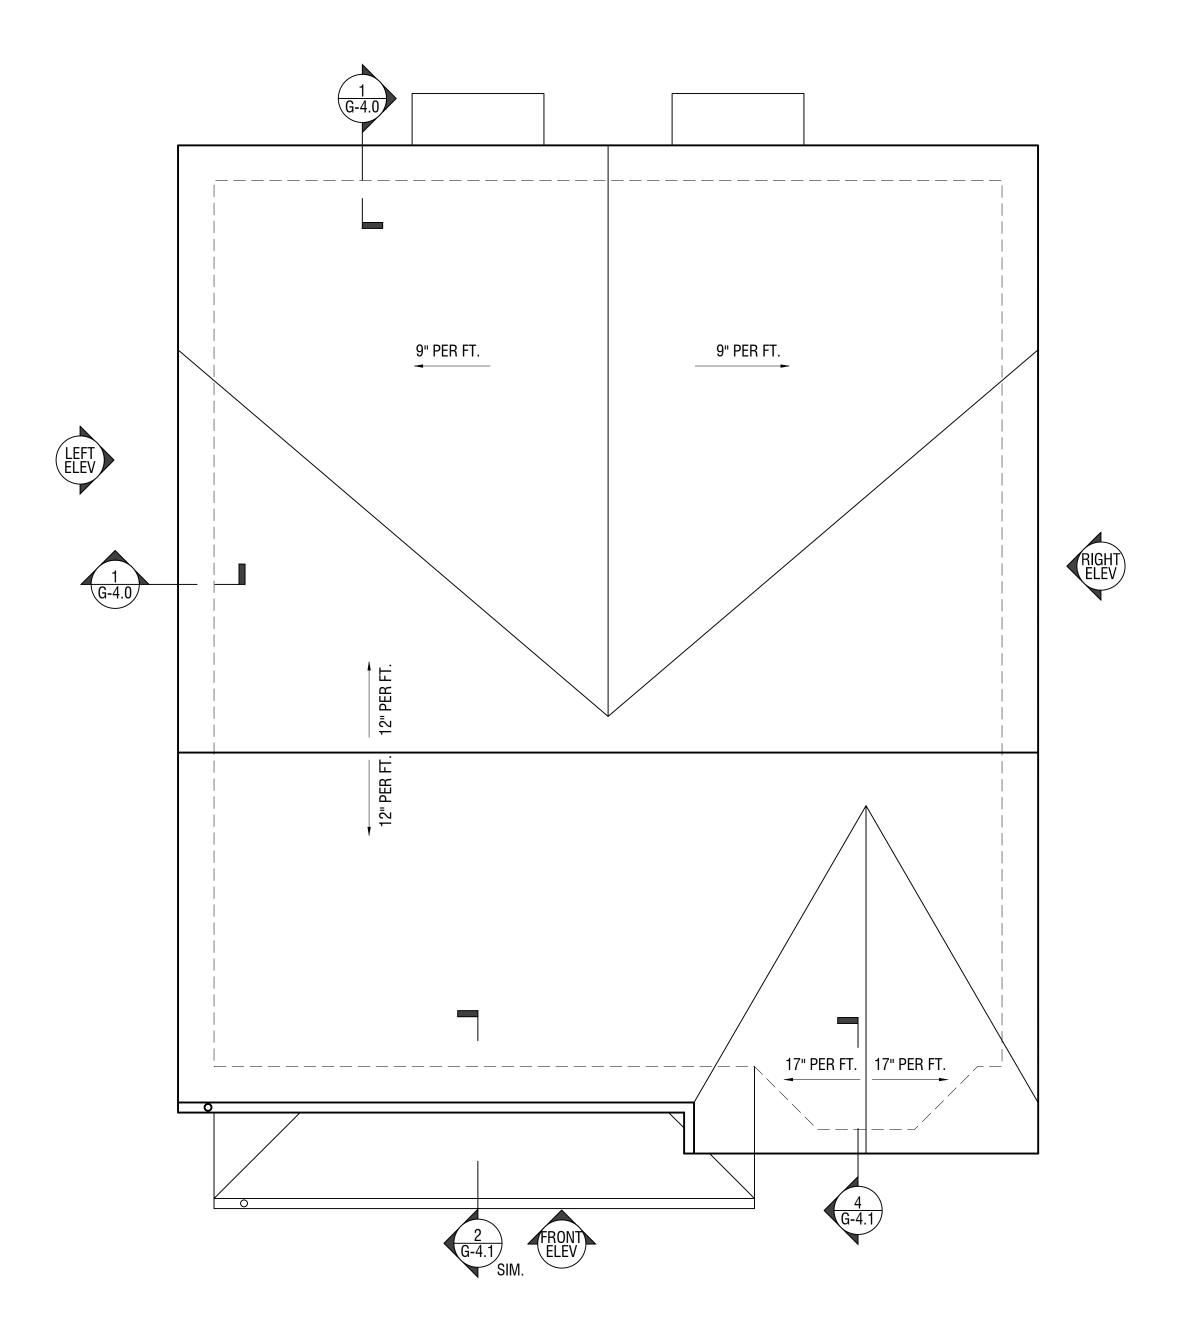

UNIT TYPE MB ROOF PLAN

SCALE: 1/4" = 1'-0"

## Architectural Firm Name

00 Street Address City, MA 00000

PROJECT

## Project Name

00 Street Address City, MA 00000

DEVELOPER / OWNER

## Developer Name

00 Street Address City, MA 00000

CONSULTANT

## Consultant Name

00 Street Address City, MA 00000

THESE DRAWINGS ARE INTENDED TO DEFINE SCOPE & WILL REQUIRE REVIEW & STAMP BY THE ARCHITECT & ENGINEERS (STRUCTURAL, MECHANICAL, ELECTRICAL, PLUMBING & FIRE PROTECTION) OF RECORD.

STAMP:

	REVI	SIONS:	
	NO.	DATE:	DESCRIPTION:
	01	-	-

# PROGRESS PRINT NOT FOR CONSTRUCTION

ROOF PLAN


SCALE:	1/4" = 1'-0"
DATE:	10/30/2015
DRAWN BY:	My.K.
CHECKED BY:	M.k.
	·

DRAWING NO.

A-1.2
TYPE E - TWO-FAMILY





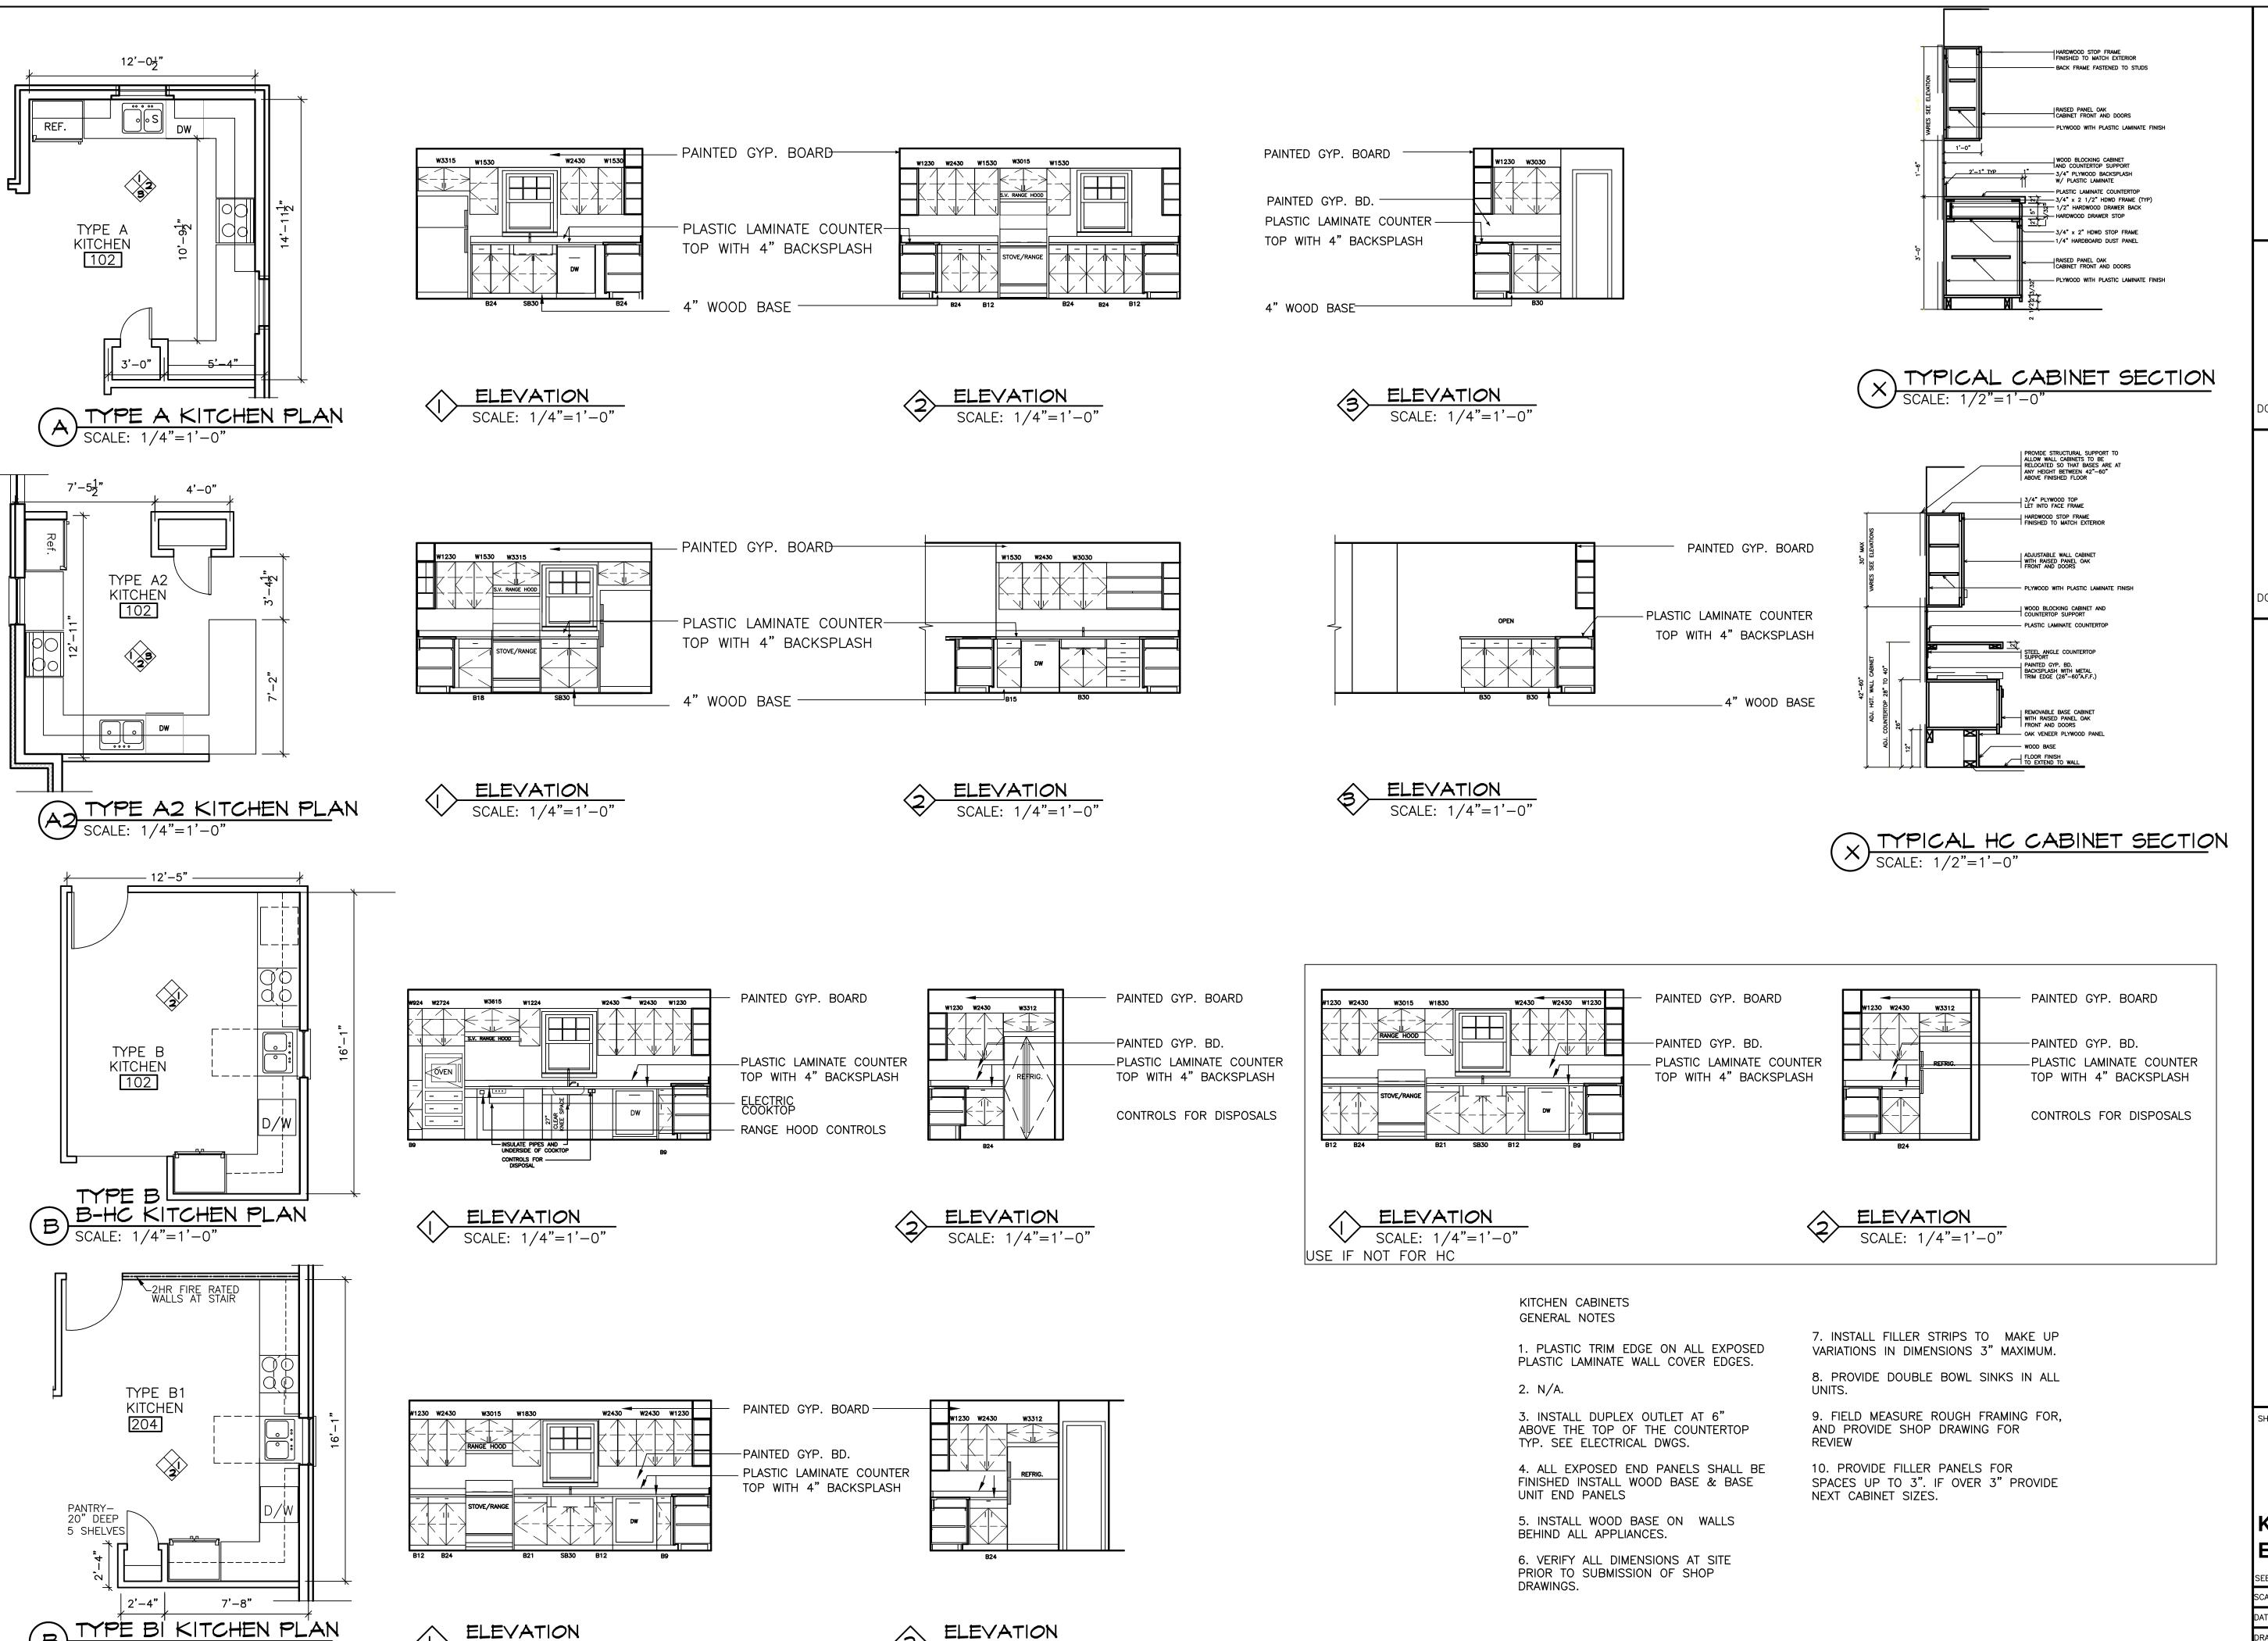

SCALE: 1/4"=1'-0"

SCALE: 1/4"=1'-0"

# Micheal Washington Architects Inc.

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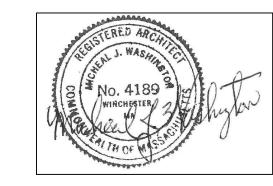
PROJECT

### NEW ENGLAND HERITAGE HOMES

DORCHESTER, MASSACHUSETTS

# CODMAN SQUARE NEIGHBORHOOD DEVELOPMENT CORPORATION

DORCHESTER, MASSACHUSETTS



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SHEET TITLE

CHECKED BY: MW FILE:NEHH.dwg

# KITCHEN DETAILS & ELEVATIONS


SEE SITE ON COVER PAGE FOR ADDRESS AND UNIT LOCATION

DRAWING NO.


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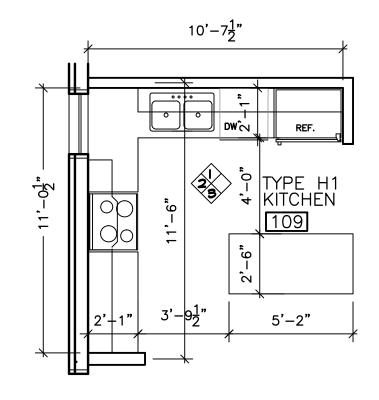
G-1






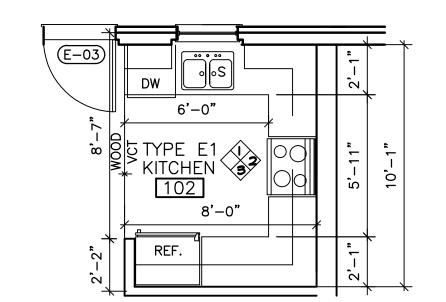


TYPE E2 & F KITCHEN PLAN
SCALE: 1/4"=1'-0"

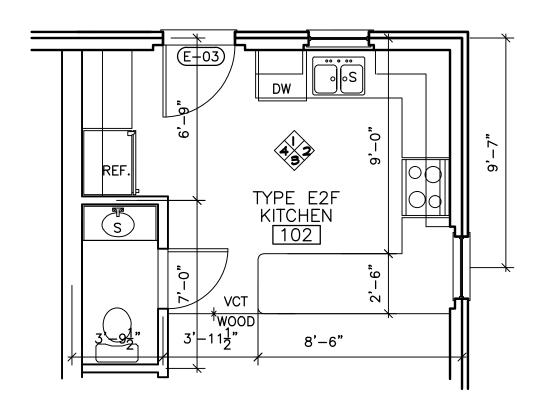


HI) TYPE HI KITCHEN PLAN SCALE: 1/4"=1'-0"

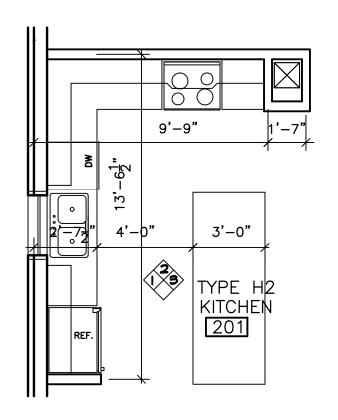

TYPE H2 KITCHEN PLAN
SCALE: 1/4"=1'-0"

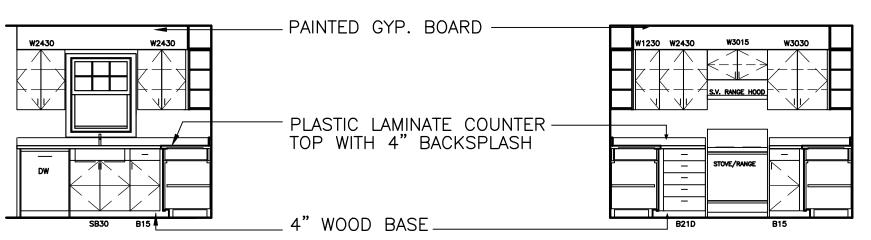




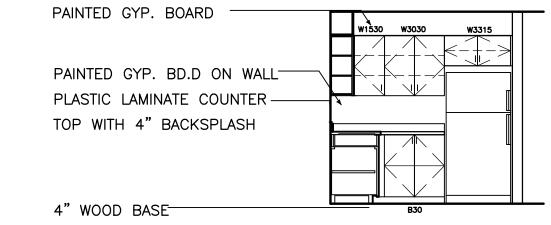





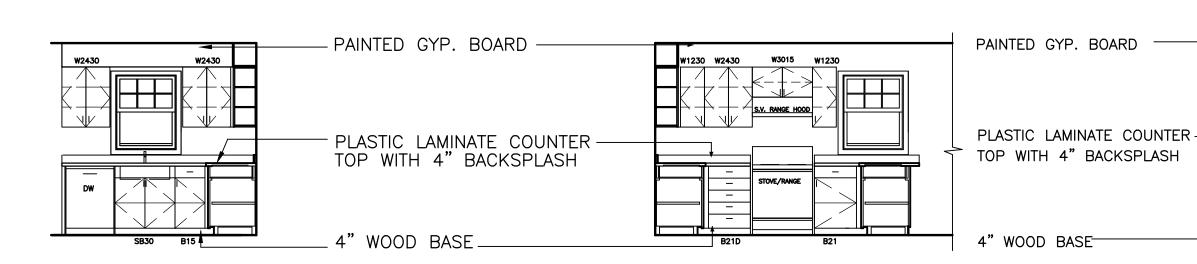

PAINTED GYP. BOARD


'WOOD BASE

<sup>-</sup> PLASTIC LAMINATE COUNTER — TOP WITH 4" BACKSPLASH








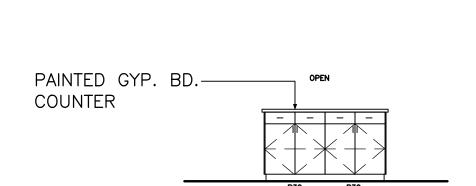







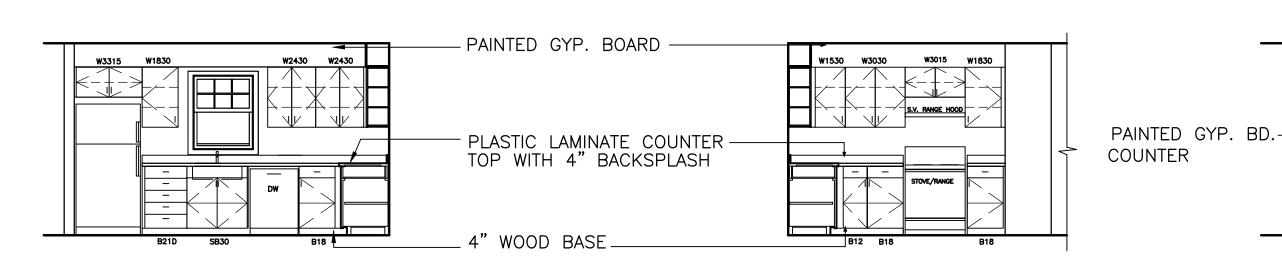





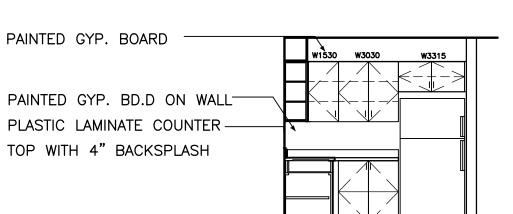

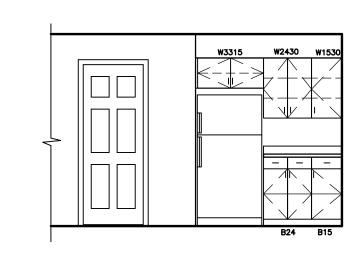

SCALE: 1/4"=1'-0"

KITCHEN CABINETS GENERAL NOTES

1. PLASTIC TRIM EDGE ON ALL EXPOSED PLASTIC LAMINATE WALL COVER EDGES.

2. N/A.

3. INSTALL DUPLEX OUTLET AT 6" ABOVE THE TOP OF THE COUNTERTOP TYP. SEE ELECTRICAL DWGS.

4. ALL EXPOSED END PANELS SHALL BE FINISHED INSTALL WOOD BASE & BASE UNIT END PANELS

5. INSTALL WOOD BASE ON WALLS BEHIND ALL APPLIANCES.

6. VERIFY ALL DIMENSIONS AT SITE PRIOR TO SUBMISSION OF SHOP DRAWINGS.

7. INSTALL FILLER STRIPS TO MAKE UP VARIATIONS IN DIMENSIONS 3" MAXIMUM.

8. PROVIDE DOUBLE BOWL SINKS IN ALL

9. FIELD MEASURE ROUGH FRAMING FOR, AND PROVIDE SHOP DRAWING FOR

10. PROVIDE FILLER PANELS FOR SPACES UP TO 3". IF OVER 3" PROVIDE NEXT CABINET SIZES.

## Micheal Washington Architects Inc.

891 Centre Street Jamaica Plain, MA 02130

Phone: 617-390-5515 E-MAIL: MWAINC1@HOTMAIL.COM

PROJECT


### **NEW ENGLAND HERITAGE HOMES**

DORCHESTER, MASSACHUSETTS

DEVELOPER

### **CODMAN SQUARE NEIGHBORHOOD DEVELOPMENT CORPORATION**

DORCHESTER, MASSACHUSETTS

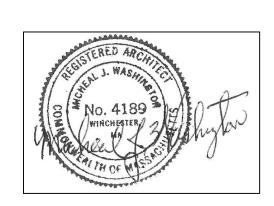

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SHEET TITLE

# KITCHEN DETAILS &


**ELEVATIONS** SEE SITE ON COVER PAGE FOR ADDRESS AND UNIT LOCATION

12/01/201 DRAWN BY:

FILE: NEHH.dwg

DRAWING NO.

G-1.2

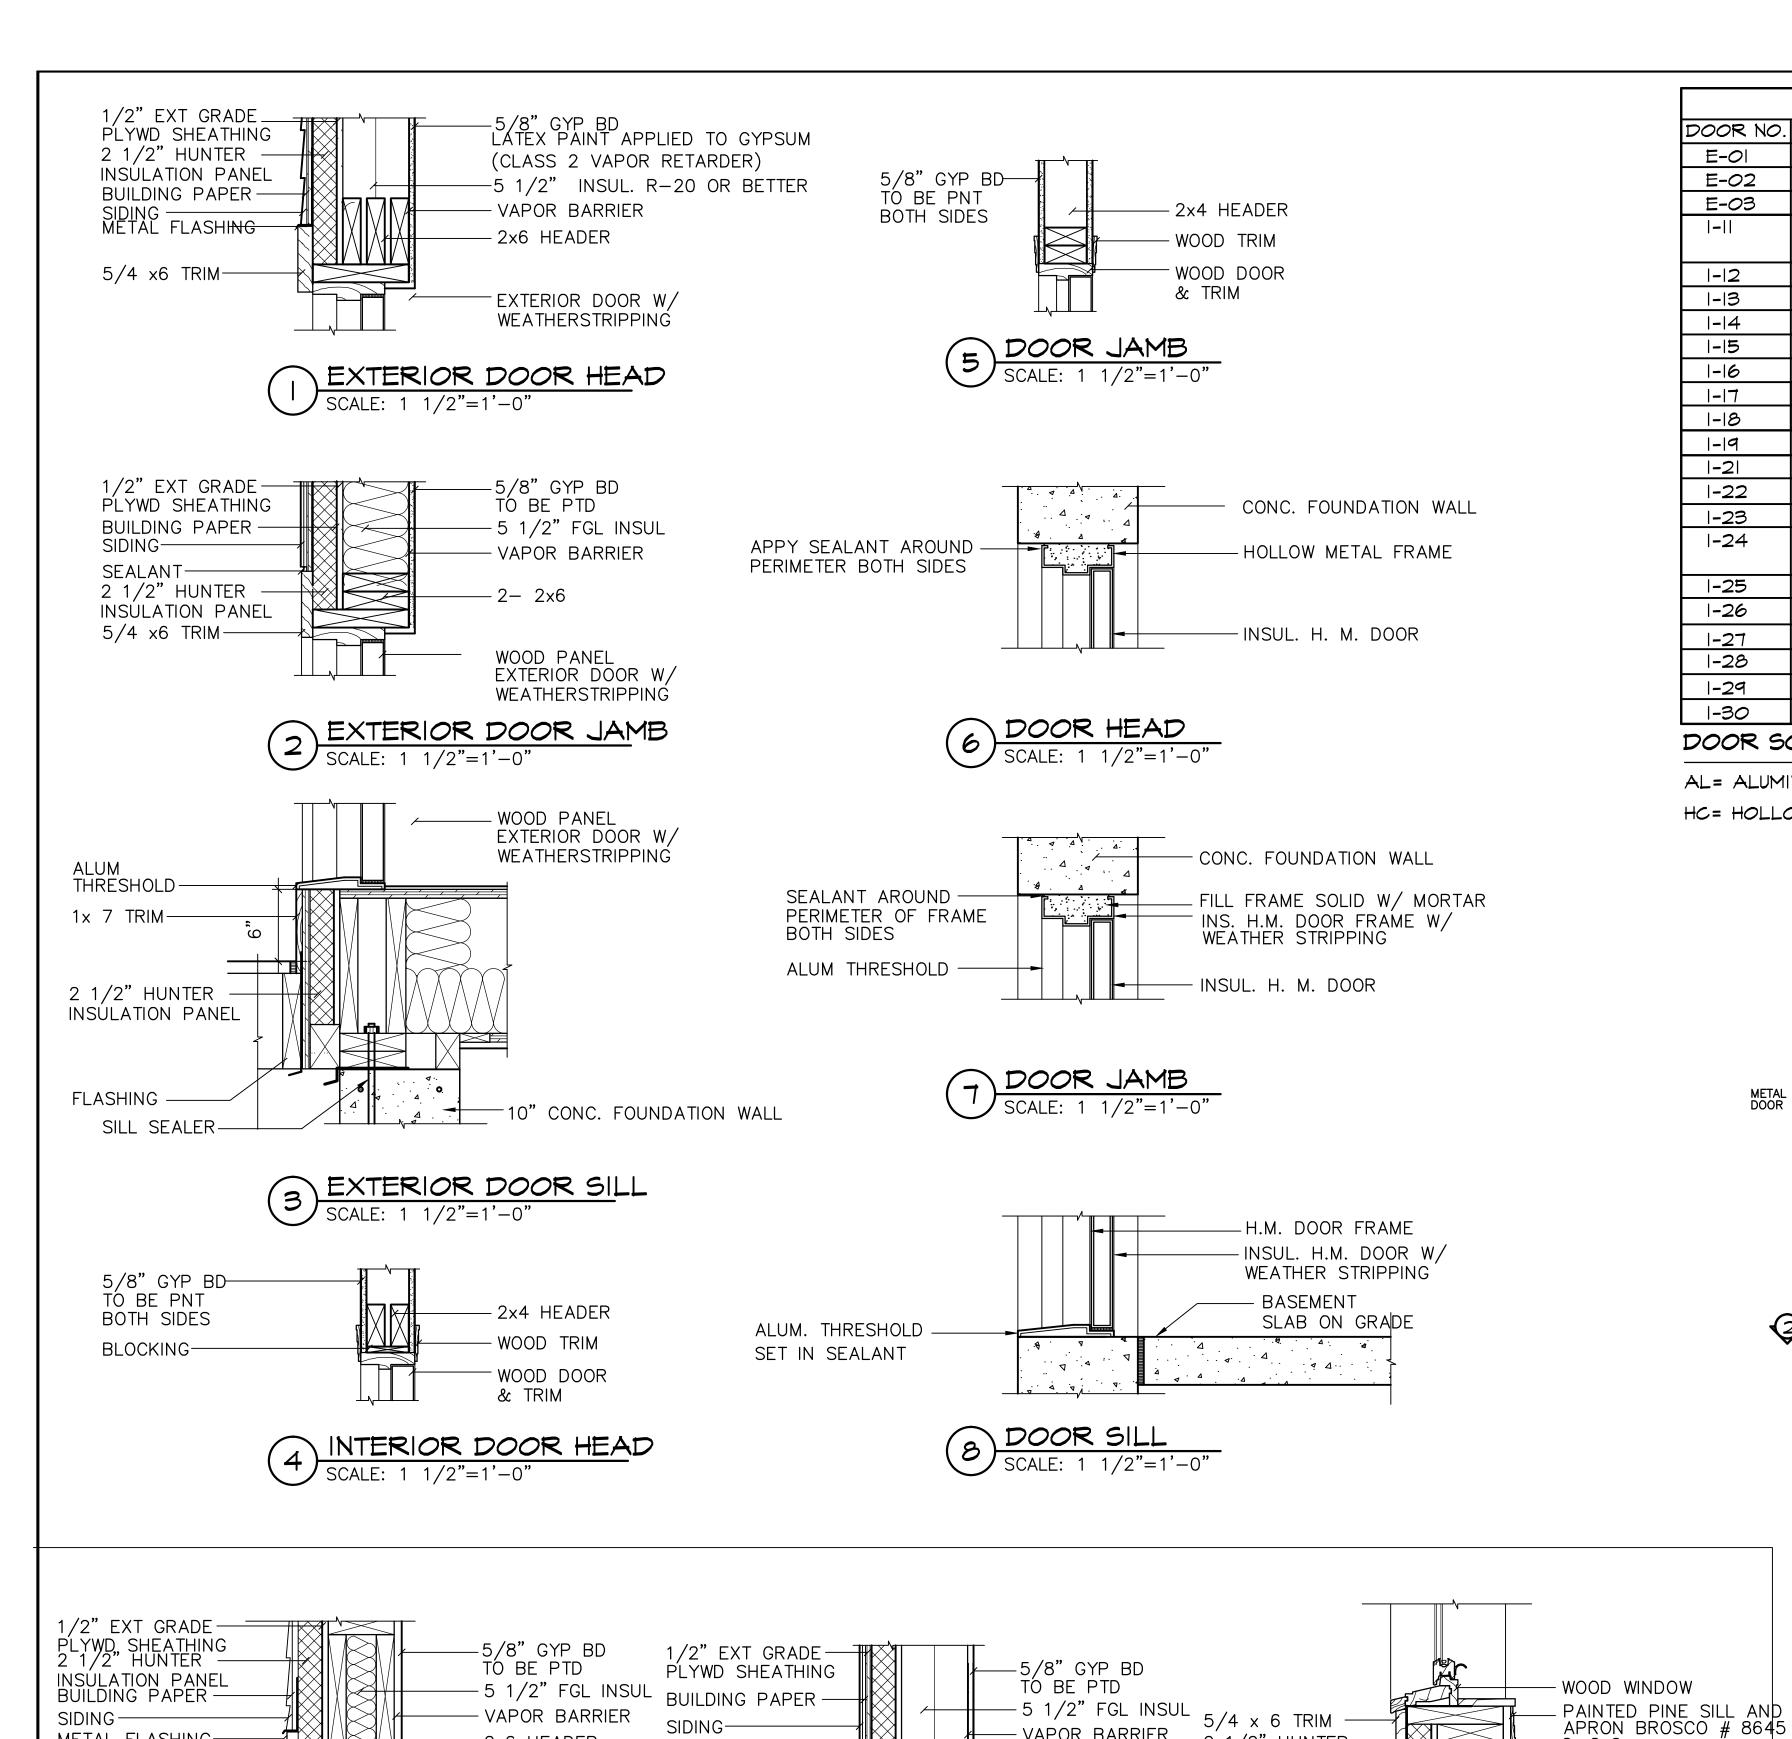

METAL FLASHING-

 $5/4 \times 6 \text{ TRIM}$ 

- 2x6 HEADER

MINDOM HEAD

SCALE: 1 1/2"=1'-0"


WOOD WINDOW


SEALANT-


2 1/2" HUNTER


5/4 x6 TRIM -

INSULATION PANEL

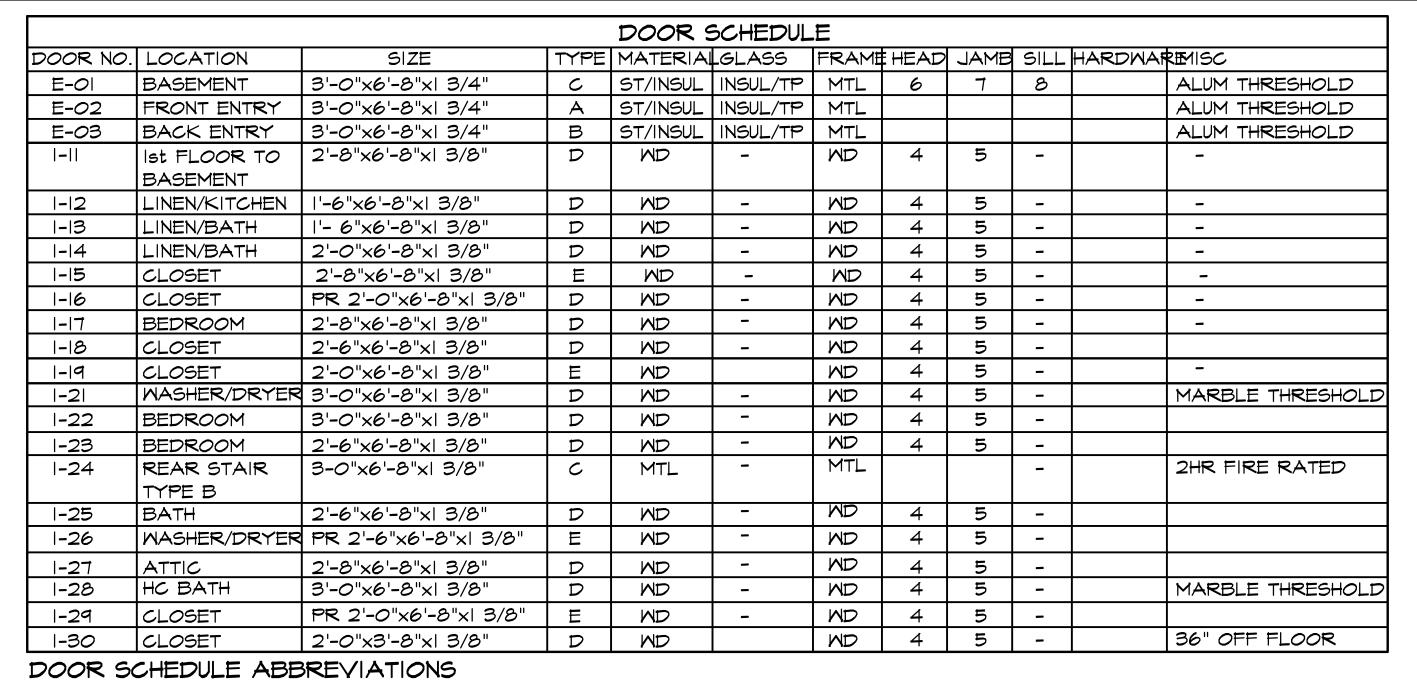

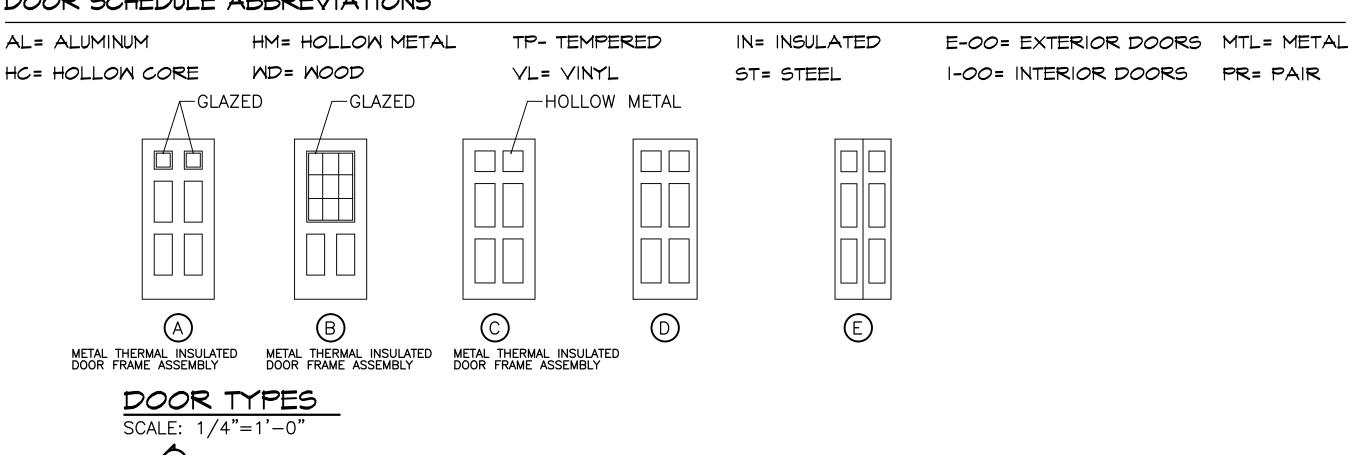

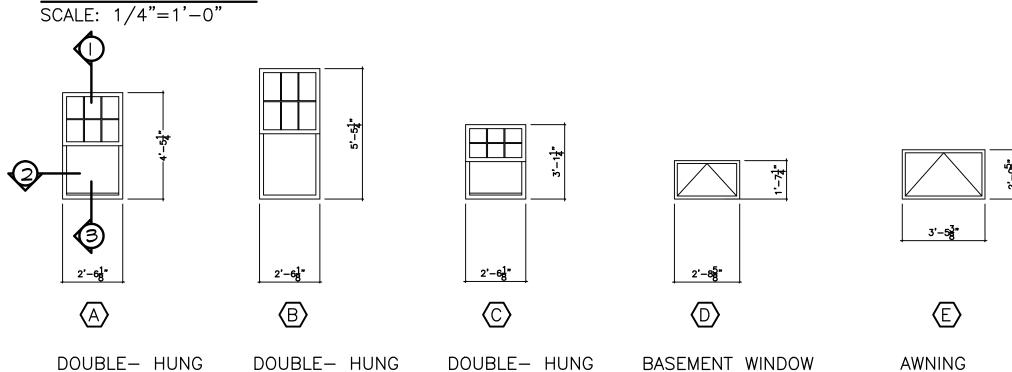

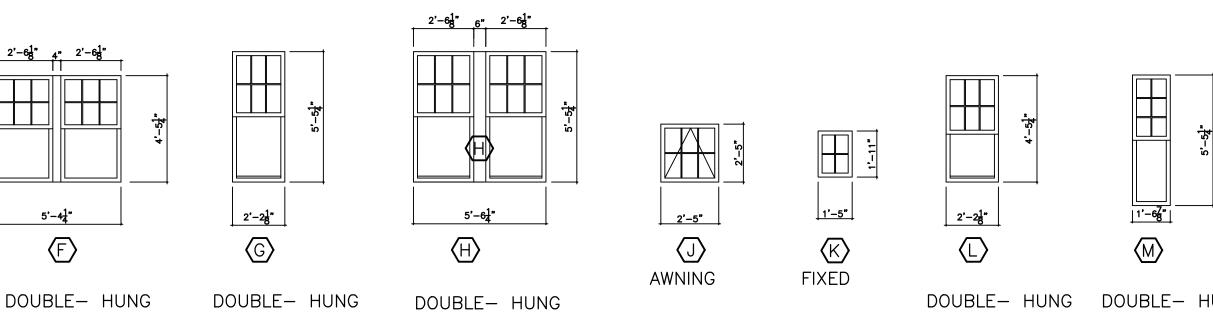

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GENERAL SHEETS DOOR SCHEDULE

12/01/201

FILE: NEHH.dwg

4. ONLY USE DIVIDED LIGHT IF IN CONTEXT

5. FOR WINDOW SIZES THE CLOSEST WINDOW SIZE AVAILABLE SIZES INDICATED OR THE NEXT LARGER SIZE. DIVIDED LITES A REQUIREMENT USE IF CONTEXTUALLY APPROPRIATE.

**DOOR & WINDOW TYPES** 

**Micheal** 

Washington

Architects Inc.

891 Centre Street Jamaica Plain, MA 02130

Phone: 617-390-5515

**PROJECT** 

E-MAIL: MWAINC1@HOTMAIL.COM

**NEW ENGLAND** 

DORCHESTER, MASSACHUSETTS

**HERITAGE HOMES** 

**CODMAN SQUARE** 

**NEIGHBORHOOD** 

**DEVELOPMENT** 

**CORPORATION** 

DORCHESTER, MASSACHUSETTS

SEE SITE ON COVER PAGE FOR ADDRESS AND UNIT LOCATION DRAWING NO.

**G-3** HECKED BY: MW

DOUBLE- HUNG

- VAPOR BARRIER

- 2, 2x6

WOOD WINDOW

2 1/2" HUNTER -

INSÚLATION PANEL

1/2" EXT GRADE-

BUILDING PAPER -

SIDING-

PLYWD SHEATHING

- VAPOR BARRIER

-5/8" GYP BD

TÓ BE PTD

-5 1/2" FGL INSUL

### MINDOW TYPES

### SCALE: 1/4"=1'-0"


ALL WINDOWS ARE INDICATED BY ROUGH OPENING ADJUST TO MANUFACTURES CLOSEST CURRENT SIZE


### **WINDOWS:**


1. PELLA PROLINE ALUM. CLAD WOOD DBL HUNG WINDOWS, WITH ADVANCED COMFORT LOW-E W/ ARGON (DUAL GLAZED UNITS) WITH SIMULATED DIVIDED LITE. U- VALUE .26; SHGC .27.


### 2. OR EQUAL

3. INSTALL ICE AND WATER SHIELD AROUND ALL WINDOW OPENING AS PER MANUFACTURER RECOMMENDATION.

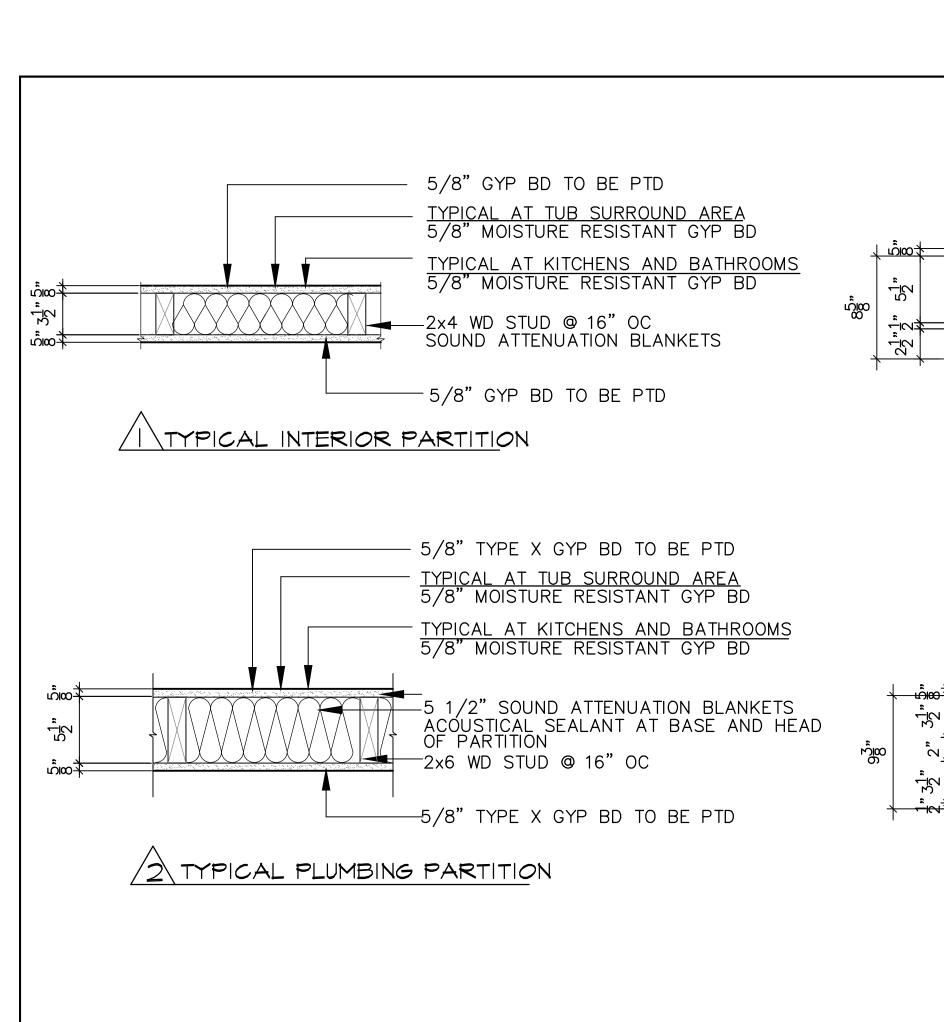

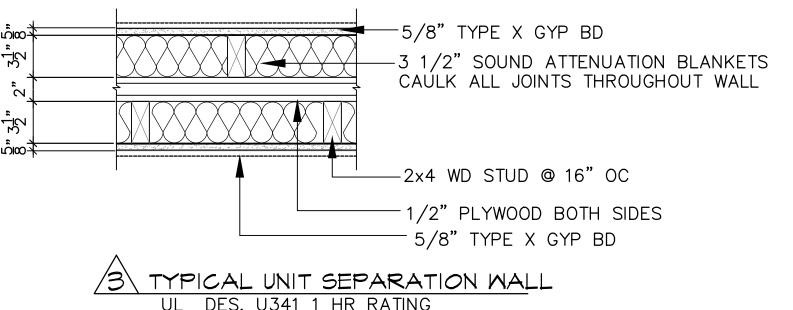


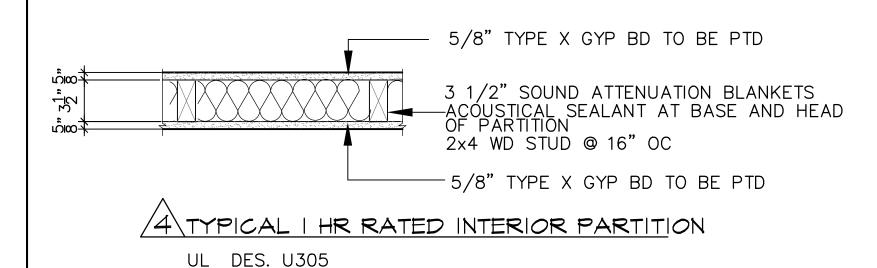

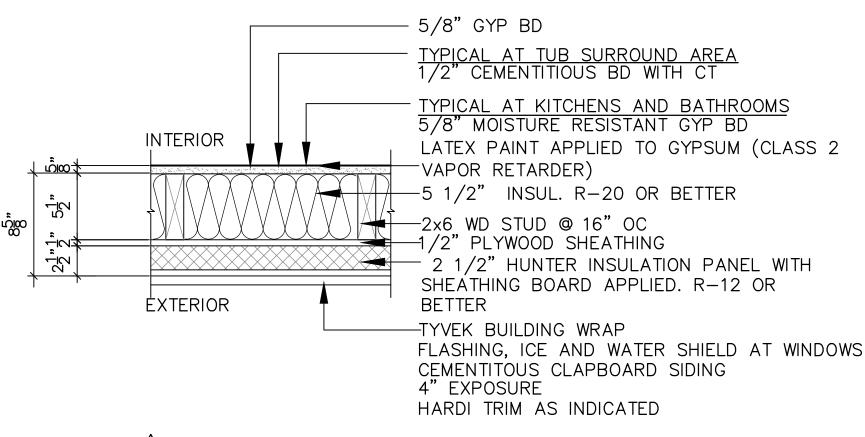

5 TYPICAL EXTERIOR WALL


R - 32

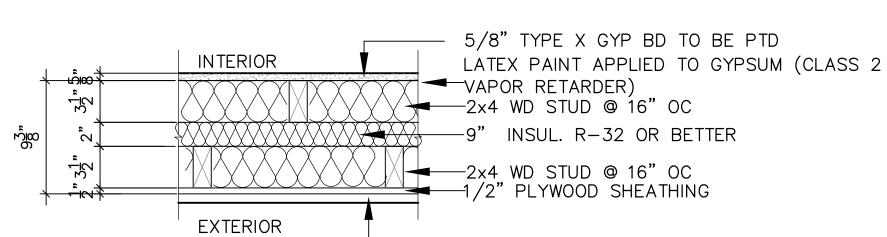

-TYVEK BUILDING WRAP


FLASHING, ICE AND WATER SHIELD AT WINDOWS

CEMENTITOUS CLAPBOARD SIDING 4" EXPOSURE HARDI TRIM AS INDICATED ALTERNATE EXTERIOR WALL

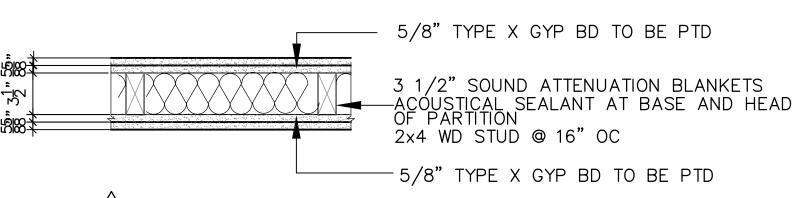

/TYPICAL 2 HR RATED INTERIOR PARTITION UL DES. U301

# CEILING DETAILS

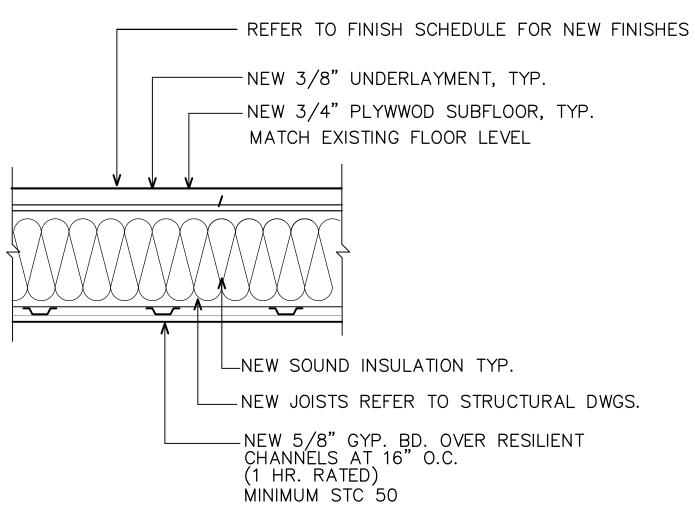

ROOM FINISH SCHEDULE ROOM NAME WALLS/WAINSCOTBASE FLOOR CEILING CLNG HGT MISC REMARKS ROOM NO. CONC BOI BASEMENT GMB DS ව'−O" BOILER ROOM GMB CONC GWB 8'-0" WASHER/DRYER CONC GMB 8'-0" GMB LIVING ROOM GMB MD MD ව'**-**0" 101 GMB - | -102 KITCHEN MD MD 8'-0" GMB GMB -103 DINING ROOM MD MD GMB ව'**-**0" GMB - | -104 1/2 BATH MR BD CT GMB 7'-6" GMB MD MD 8'-0" MASHER/DRYER MD MD GMB 8'-0" BEDROOM GMB MD MD GMB 8'-0" 107 FOYER GMB \_ BEDROOM MD MD ව'**-**0" GMB GMB BATH MR BD CT CT 7'-6" GMB 203 LIVING ROOM MD MD 8'-0" GMB GMB - | -204 KITCHEN MD MD GMB 8'-0" GMB 205 DINING ROOM GMB MD MD GMB 8'-0" \_ MD MD 206 STUDY GMB GMB 8'-0" 207 STAIRS/HALL MD MD 8'-0" SEE NOTE 5 GMB GMB \_ 208 HALL GMB MD MD GMB 8'-0" ව'**-**0" 301 BEDROOM GMB MD MD GMB - | -302 STORAGE GMB MD MD GMB 8'-0"

#### ROOM FINISH SCHEDULE ABBREVIATIONS

CRPT= CARPET PNT= PAINTED VB= VINYL BASE DS= DUST SHIELD VNL= SHEET VINYL CONC = CONCRETE

MR BD = MOISTURE RESISTANT GYPSUM WALL BOARD CMU= CONCRETE MASONRY UNIT

MD= MOOD

EXP = EXPOSED

GMB= GYPSUM WALL BOARD

I. TYP. FIRST FLOOR/ BASEMENT CEILING ASSEMBLY - PROVIDE BATT, SPRAY FOAM OR NETTED LOOSE INSULATION R-30 W/ STRAPPING FIRE RATED GYP BD AT BOILER AREA (TYP.)

2. AT TOP HABITABLE (SECOND OR ATTIC) FLOOR/CEILING ASSEMBLY PROVIDE FIBERGLASS BATT INSULATION R-60 OR BETTER TYP

3. CLOSET FINISHES AND LAUNDRY CLOSET TO MATCH ROOM CLOSET OPENS INTO

4. PROVIDE OAK CAP AT STAR HANDRAIL

5. STAIR TREAD AND LANDING FINISHES -BASEMENT TREADS - PROVIDE UNPAINTED HARD PINE FIRST FLOOR LANDING - PROVIDE WOOD FLOORING

6. ALL WASHING MACHINES IN LIVING AREA TO HAVE CONNECTED METAL PAN TO DRAIN.

7. PROVIDE MIN. ONE HAND HANDRAIL AT ALL STAIRS. TWO WHEN SHOWED IN THE DRAWINGS.

8. STAIR HANDRAILS WITH OPEN BALUSTER B-720 BEECH NATURAL FINISH HANDRAIL 1-1/4" SQUARE PAINTED BALUSTER AND 3-1/4" SQUARE PAINTED NEWELL: BY BROSCO OR ARCHITECT APPROVED EQUAL.

9. INTERIOR STAIR RAIL BRACKET: C- 3002 BROSCO BRASS FINISH OR ARCHITECT APPROVED EQUAL.

10. WALL HANG RAILINGS BROSCO 1-1/2" x 1-11/16" NO. 75 ROUND AT BASEMENT STAIRS ONLY. NO. 66 TAPERED PROFILE PINE WITH INTERIOR STAIR HANDRAIL BRACKETS AT STAIRS WITHIN UNITS MITERED RETURNS.

Micheal Washington Architects Inc.

891 Centre Street Jamaica Plain, MA 02130

Phone: 617-390-5515 E-MAIL: MWAINC1@HOTMAIL.COM

PROJECT

**NEW ENGLAND HERITAGE HOMES** 


DORCHESTER, MASSACHUSETTS

### **CODMAN SQUARE NEIGHBORHOOD DEVELOPMENT CORPORATION**

DORCHESTER, MASSACHUSETTS

NOTES:

DIMENSIONS TO EXTERIOR WALLS ARE TO EXTERIOR FACE OF EXTERIOR STUD AND EXTERIOR FACE OF FOUNDATION WALL

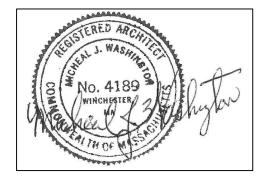

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SHEET TITLE

GENERAL SHEETS **ROOM FINISH SCHEDULE PARTITION TYPES** 

SEE SITE ON COVER PAGE FOR ADDRESS AND UNIT LOCATION

DATE: 12/01/201 RAWN BY:

HECKED BY: MW


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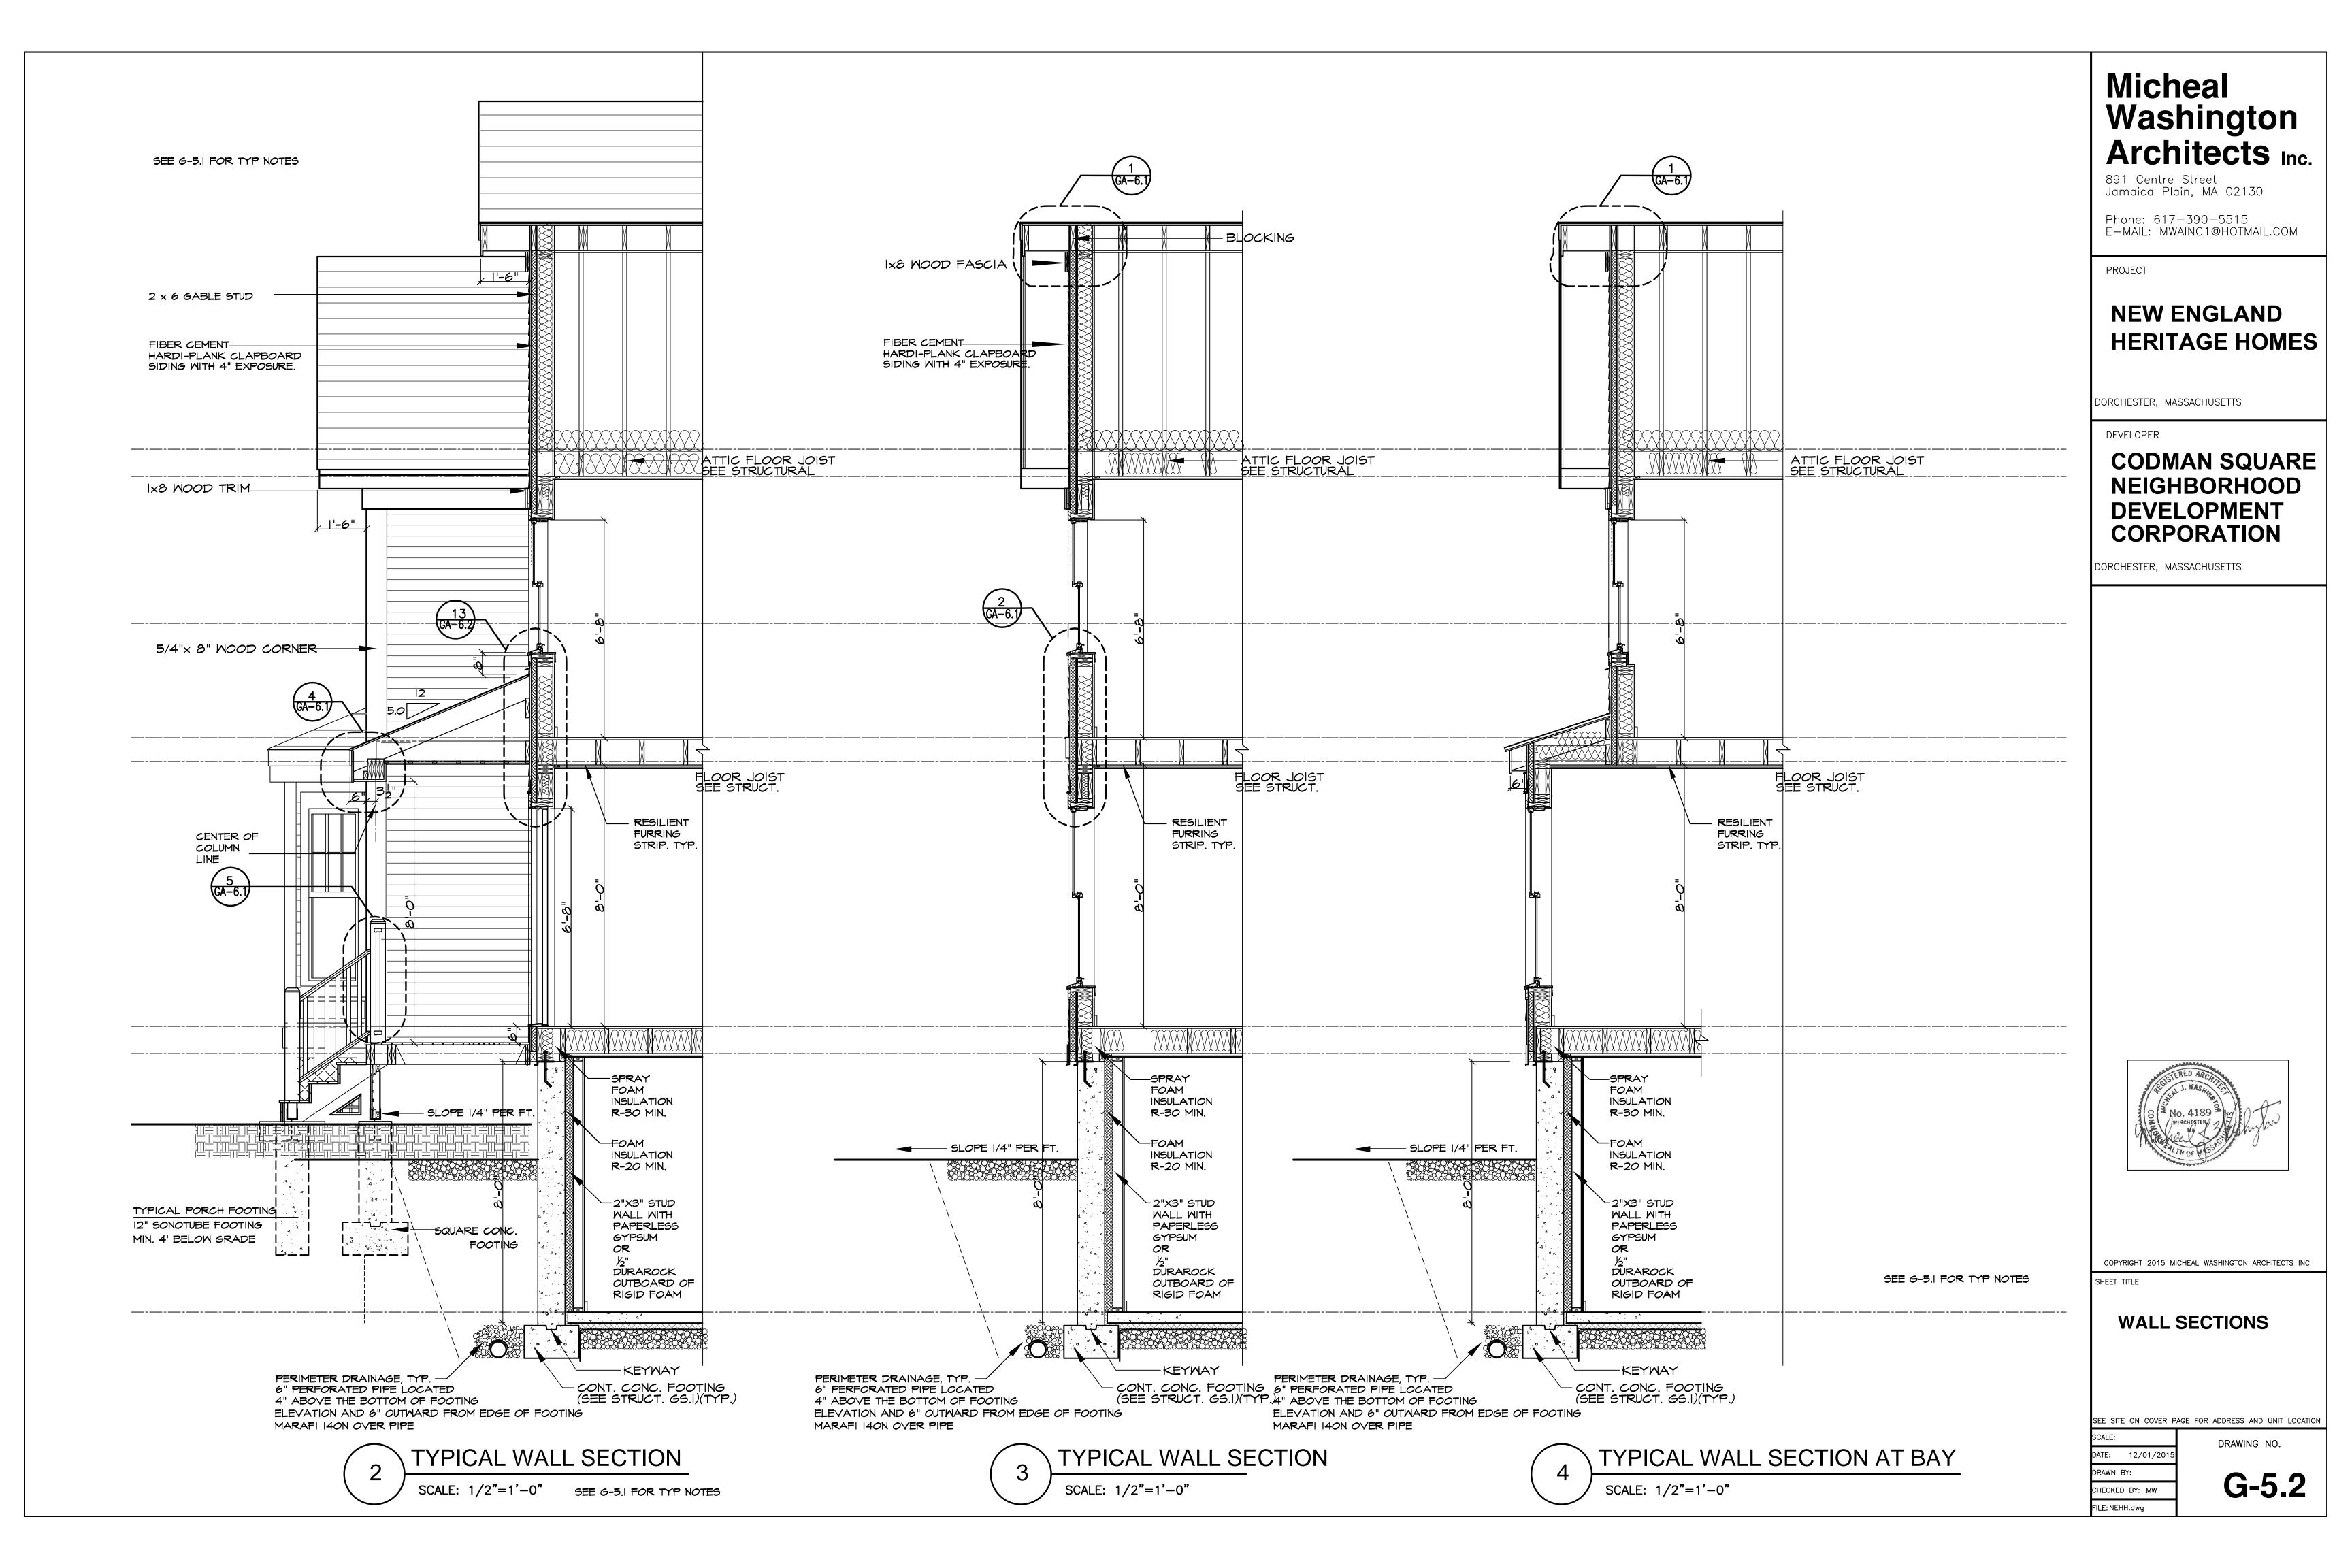
**G-4** 


DRAWING NO.


TYPICAL NEW FLOOR/ CEILING I HR RATED BETWEEN UNITS IN BUILDING TYPE B


UL 513



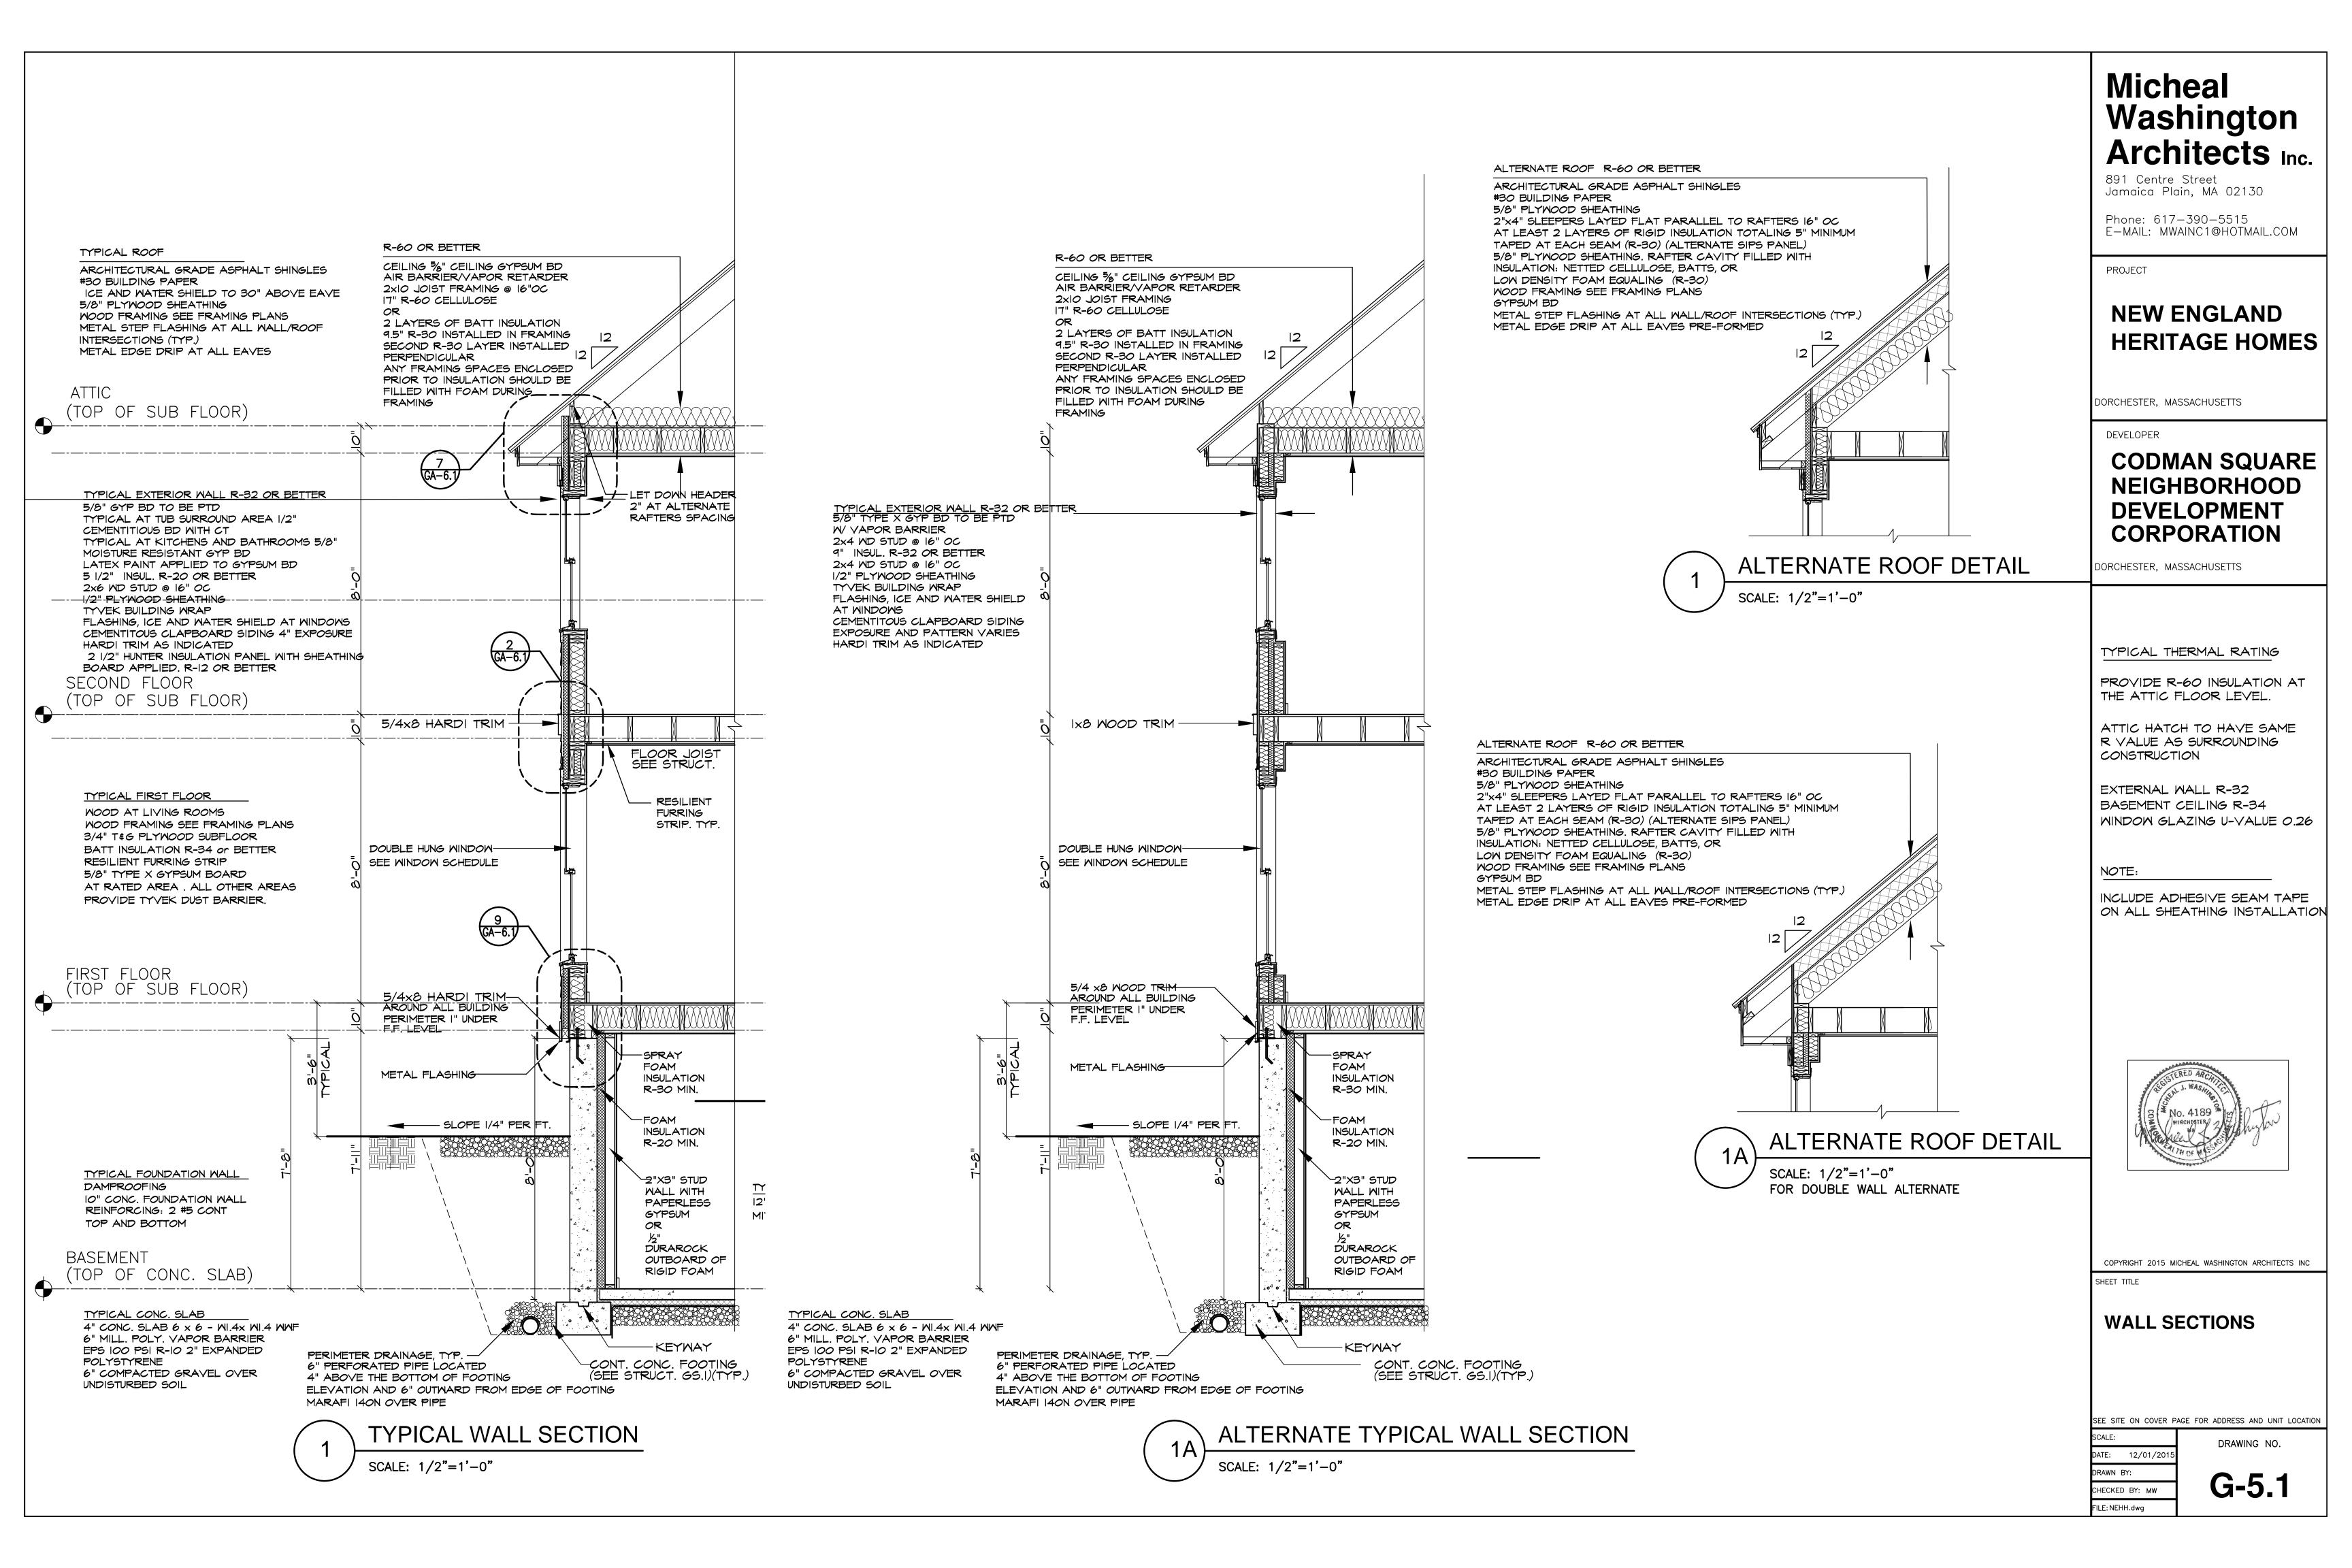

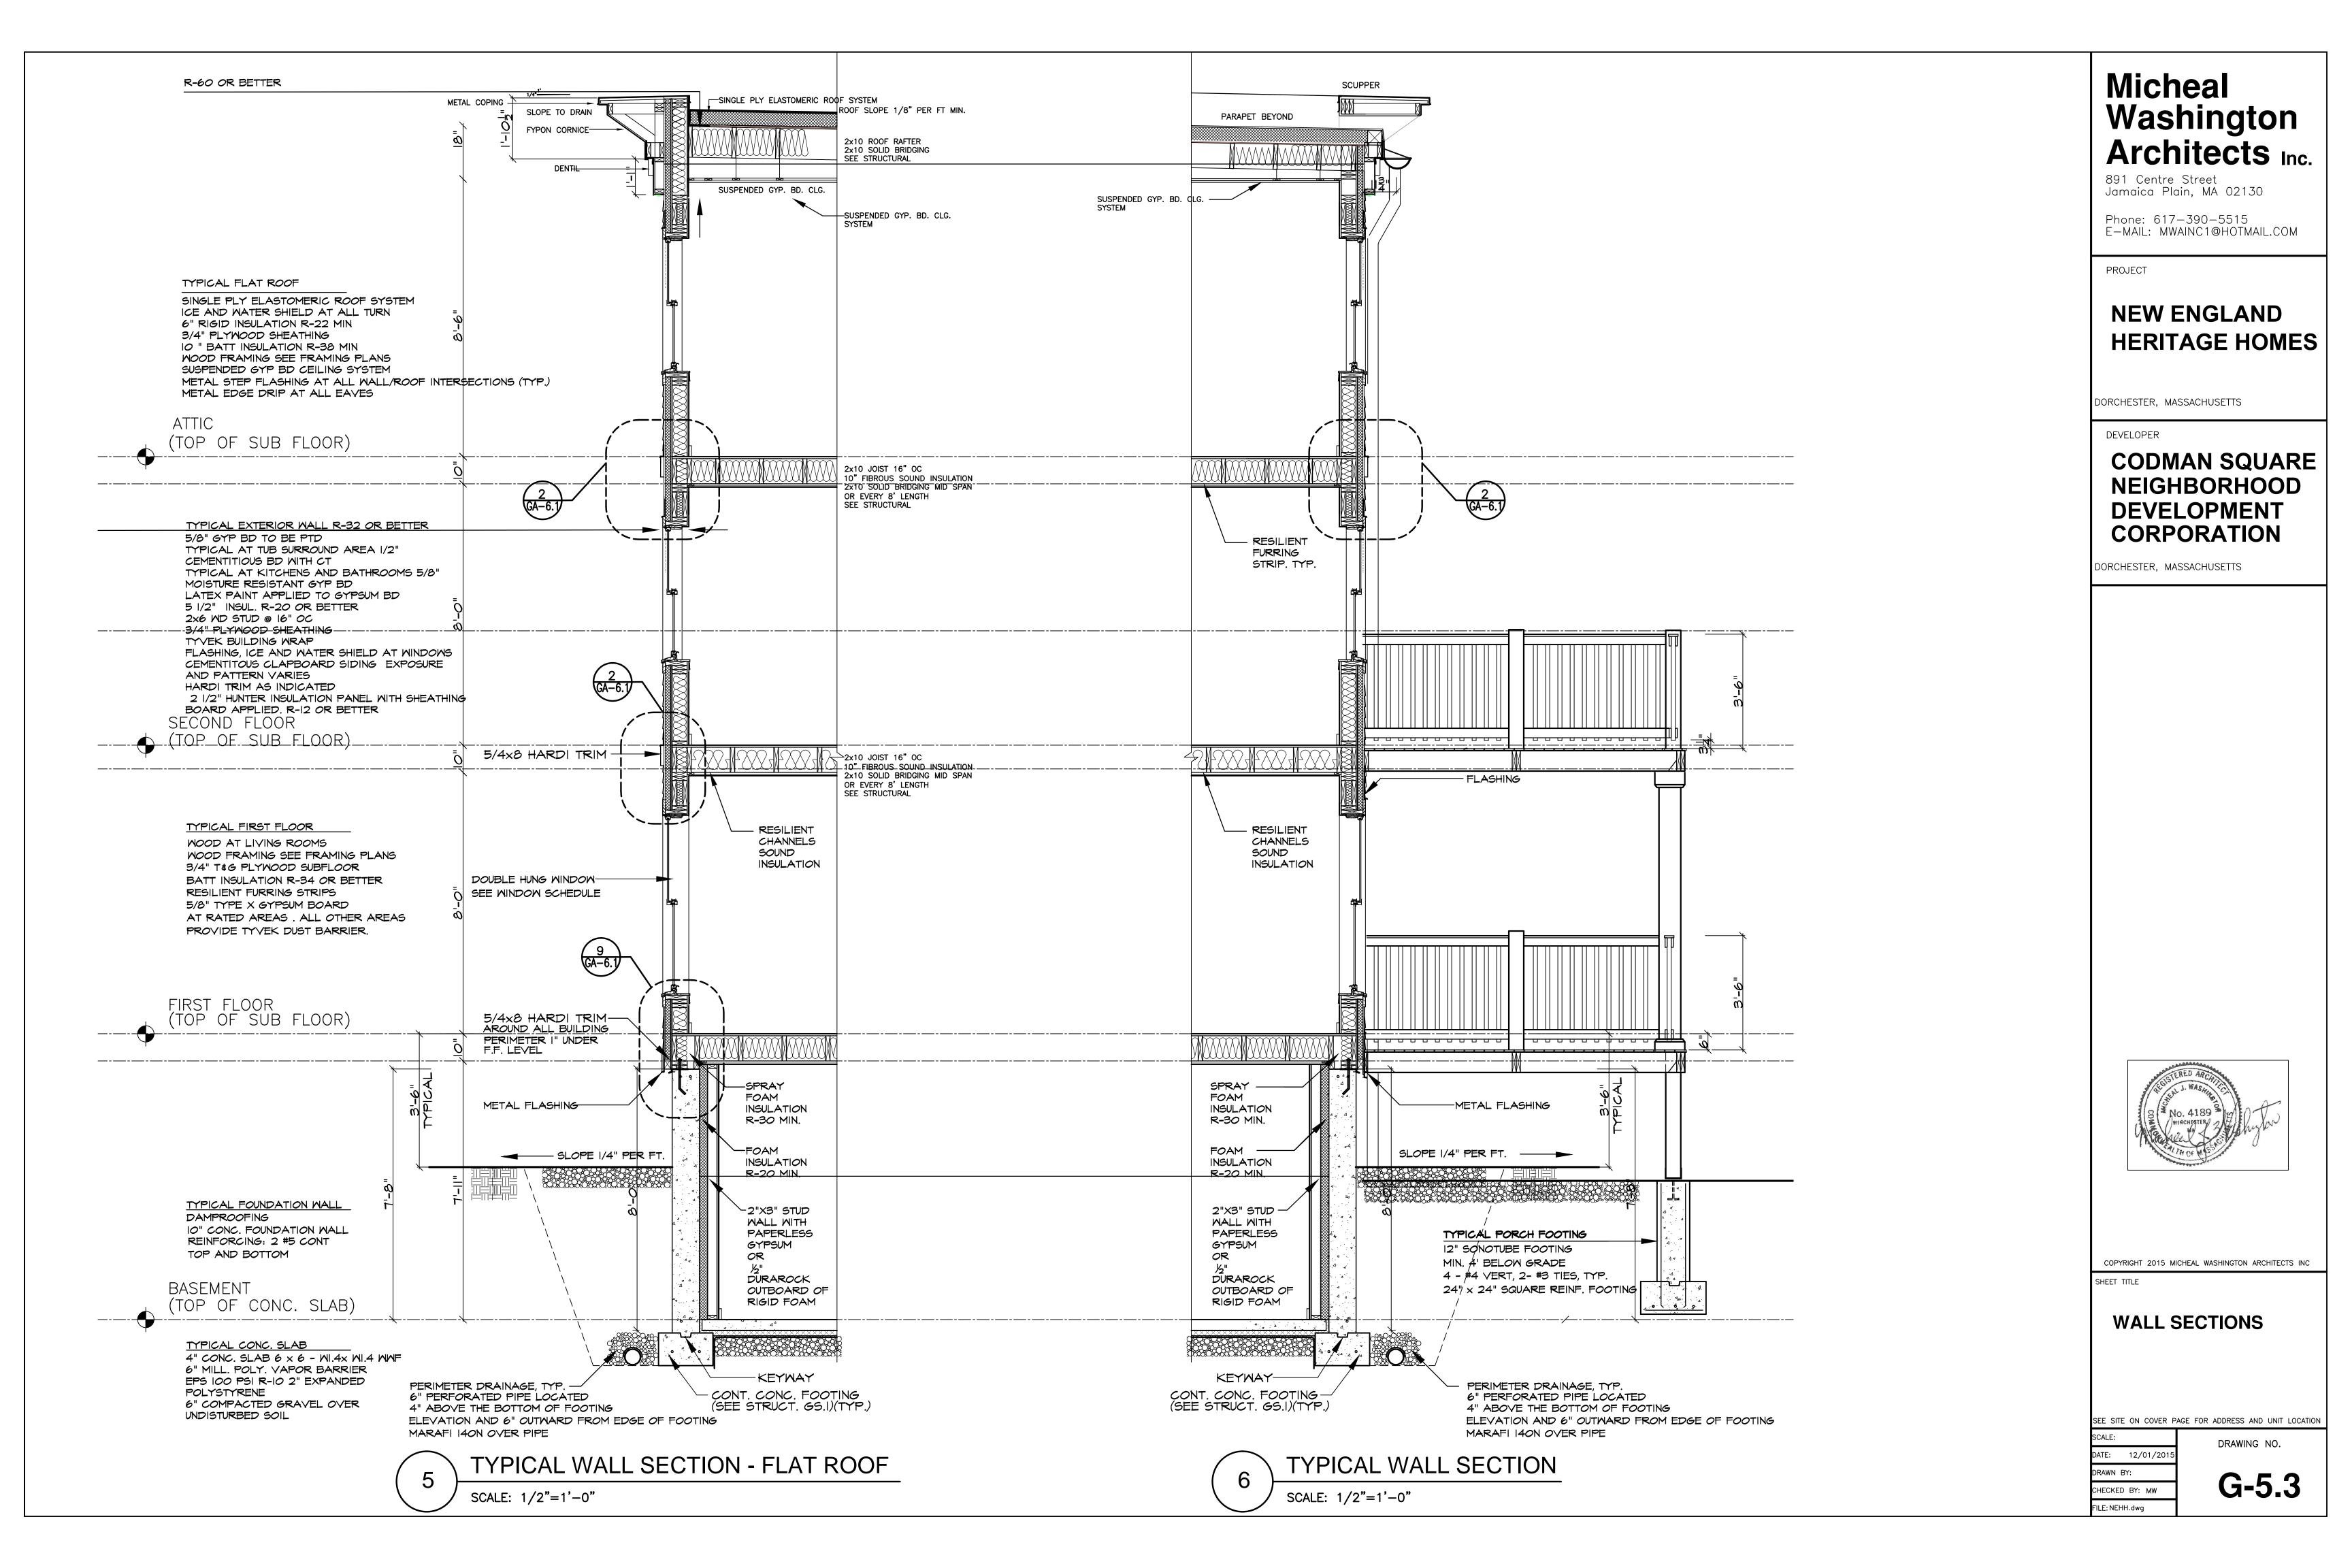

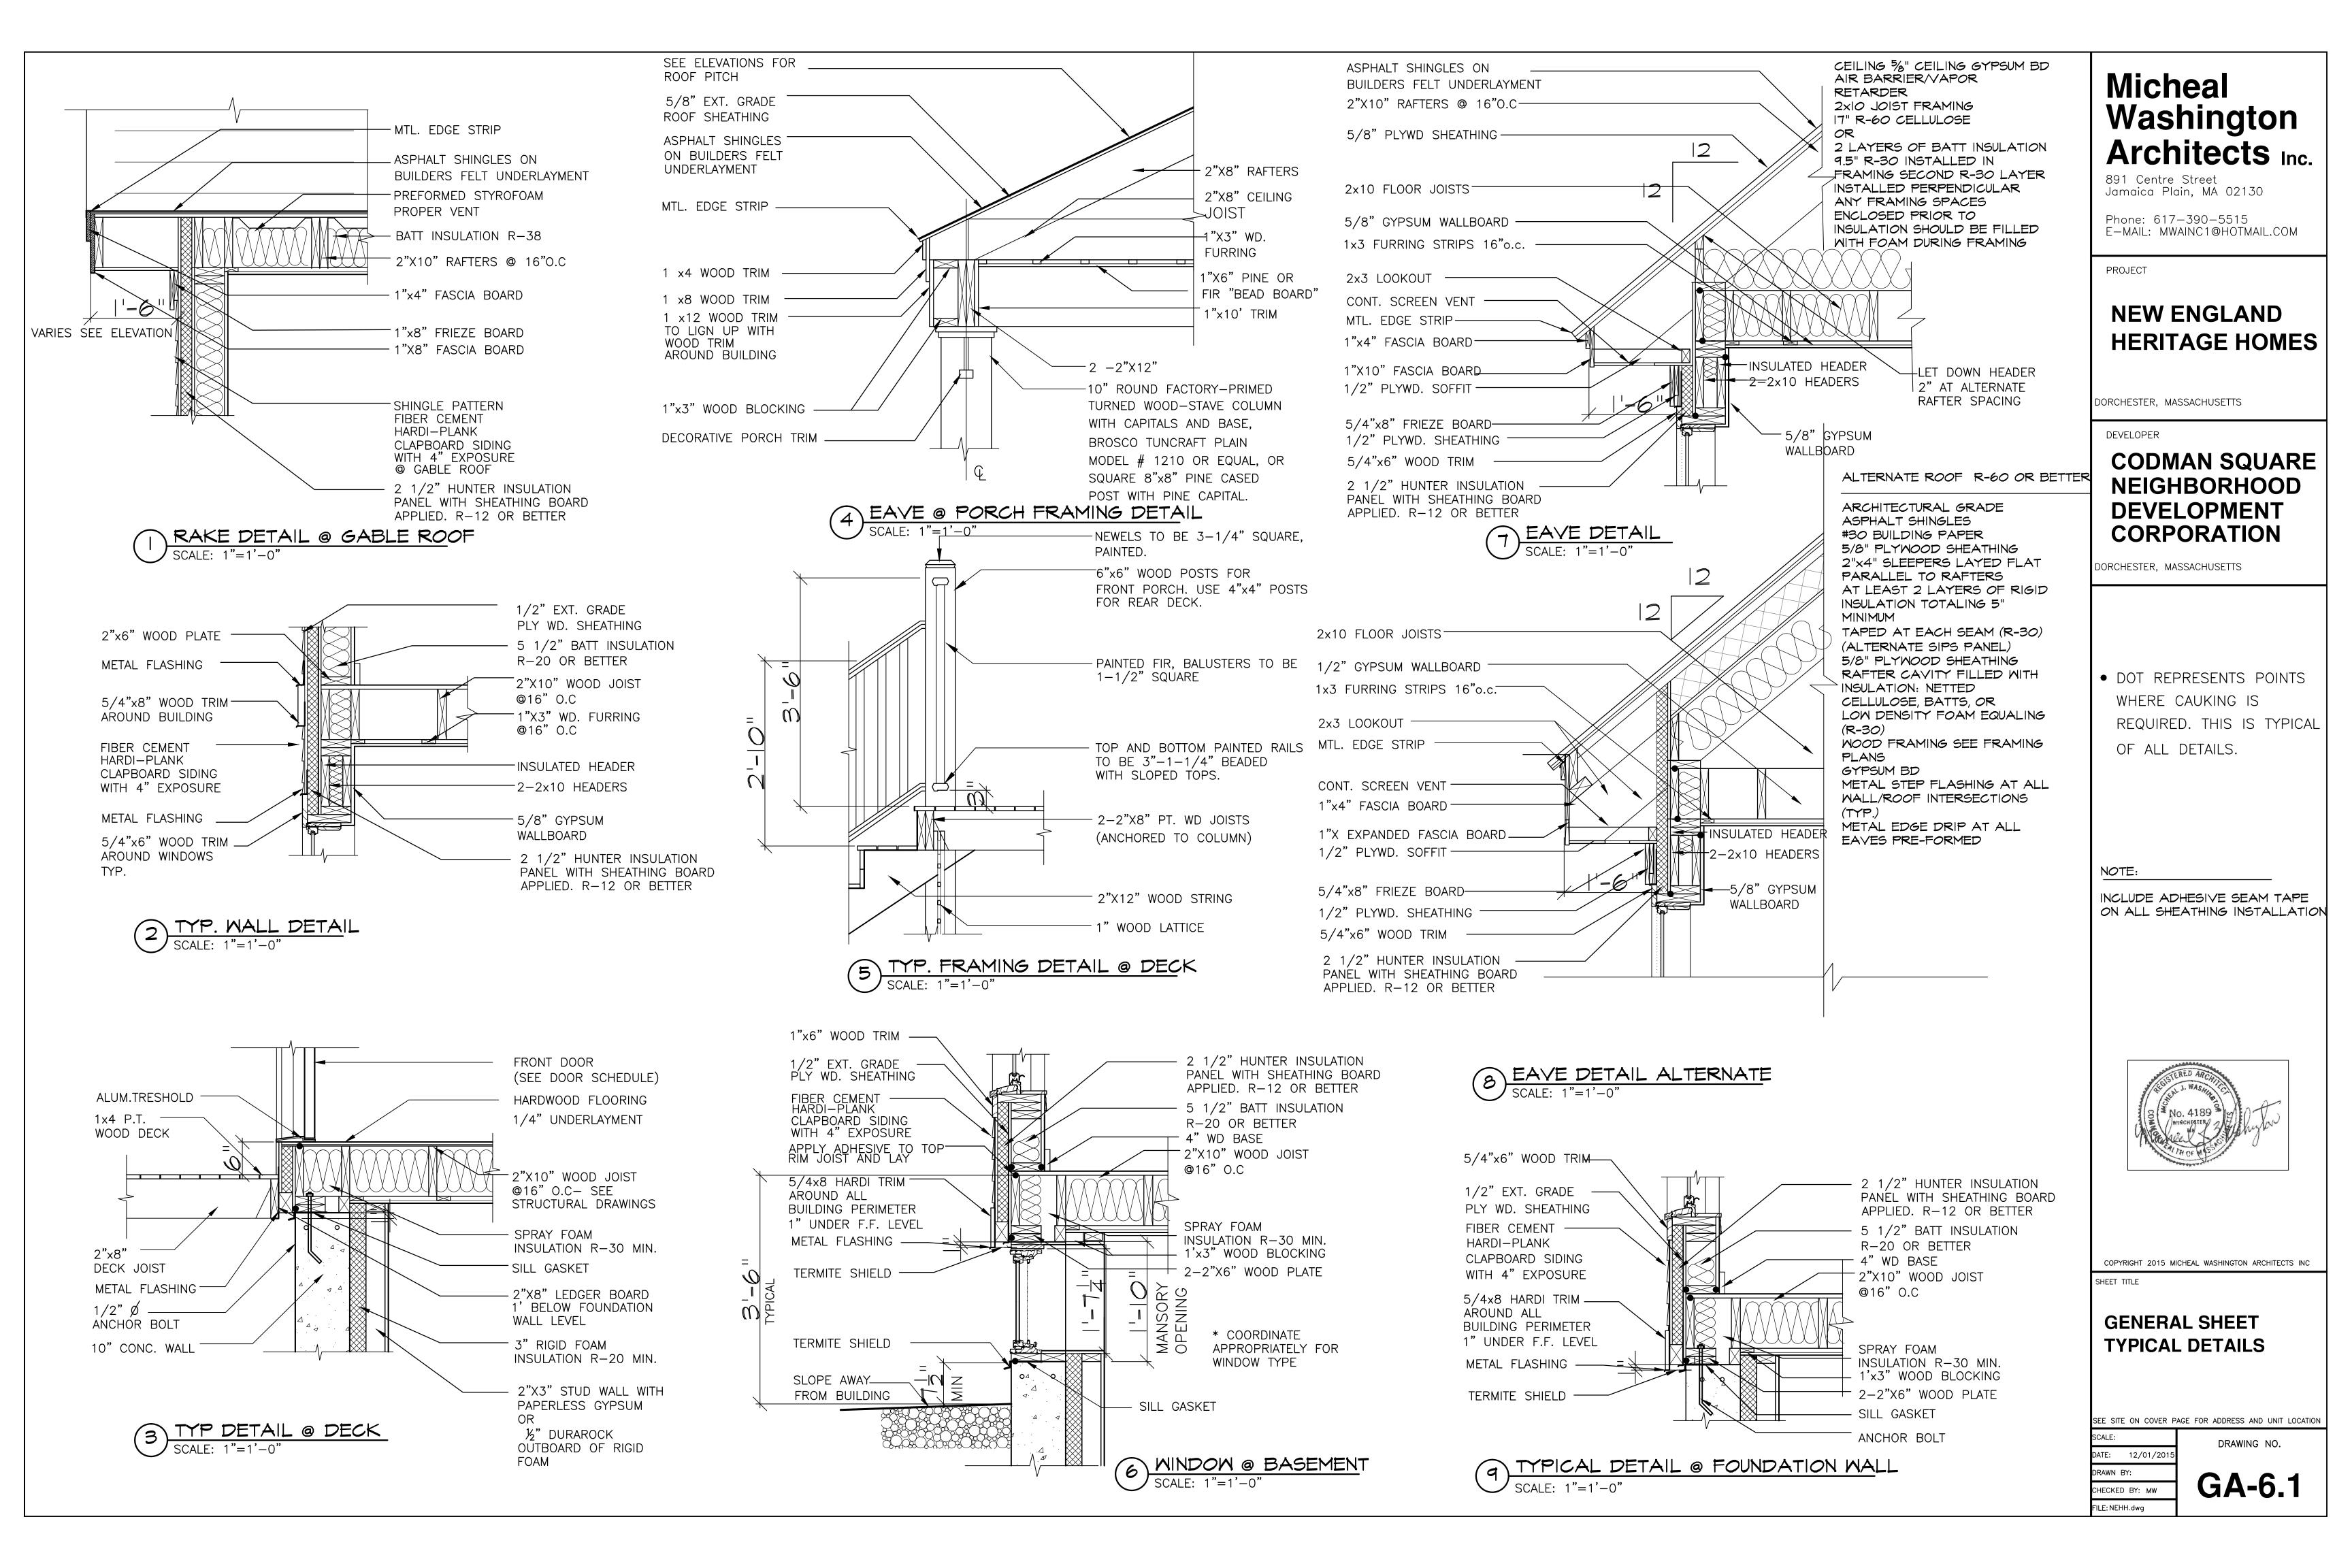

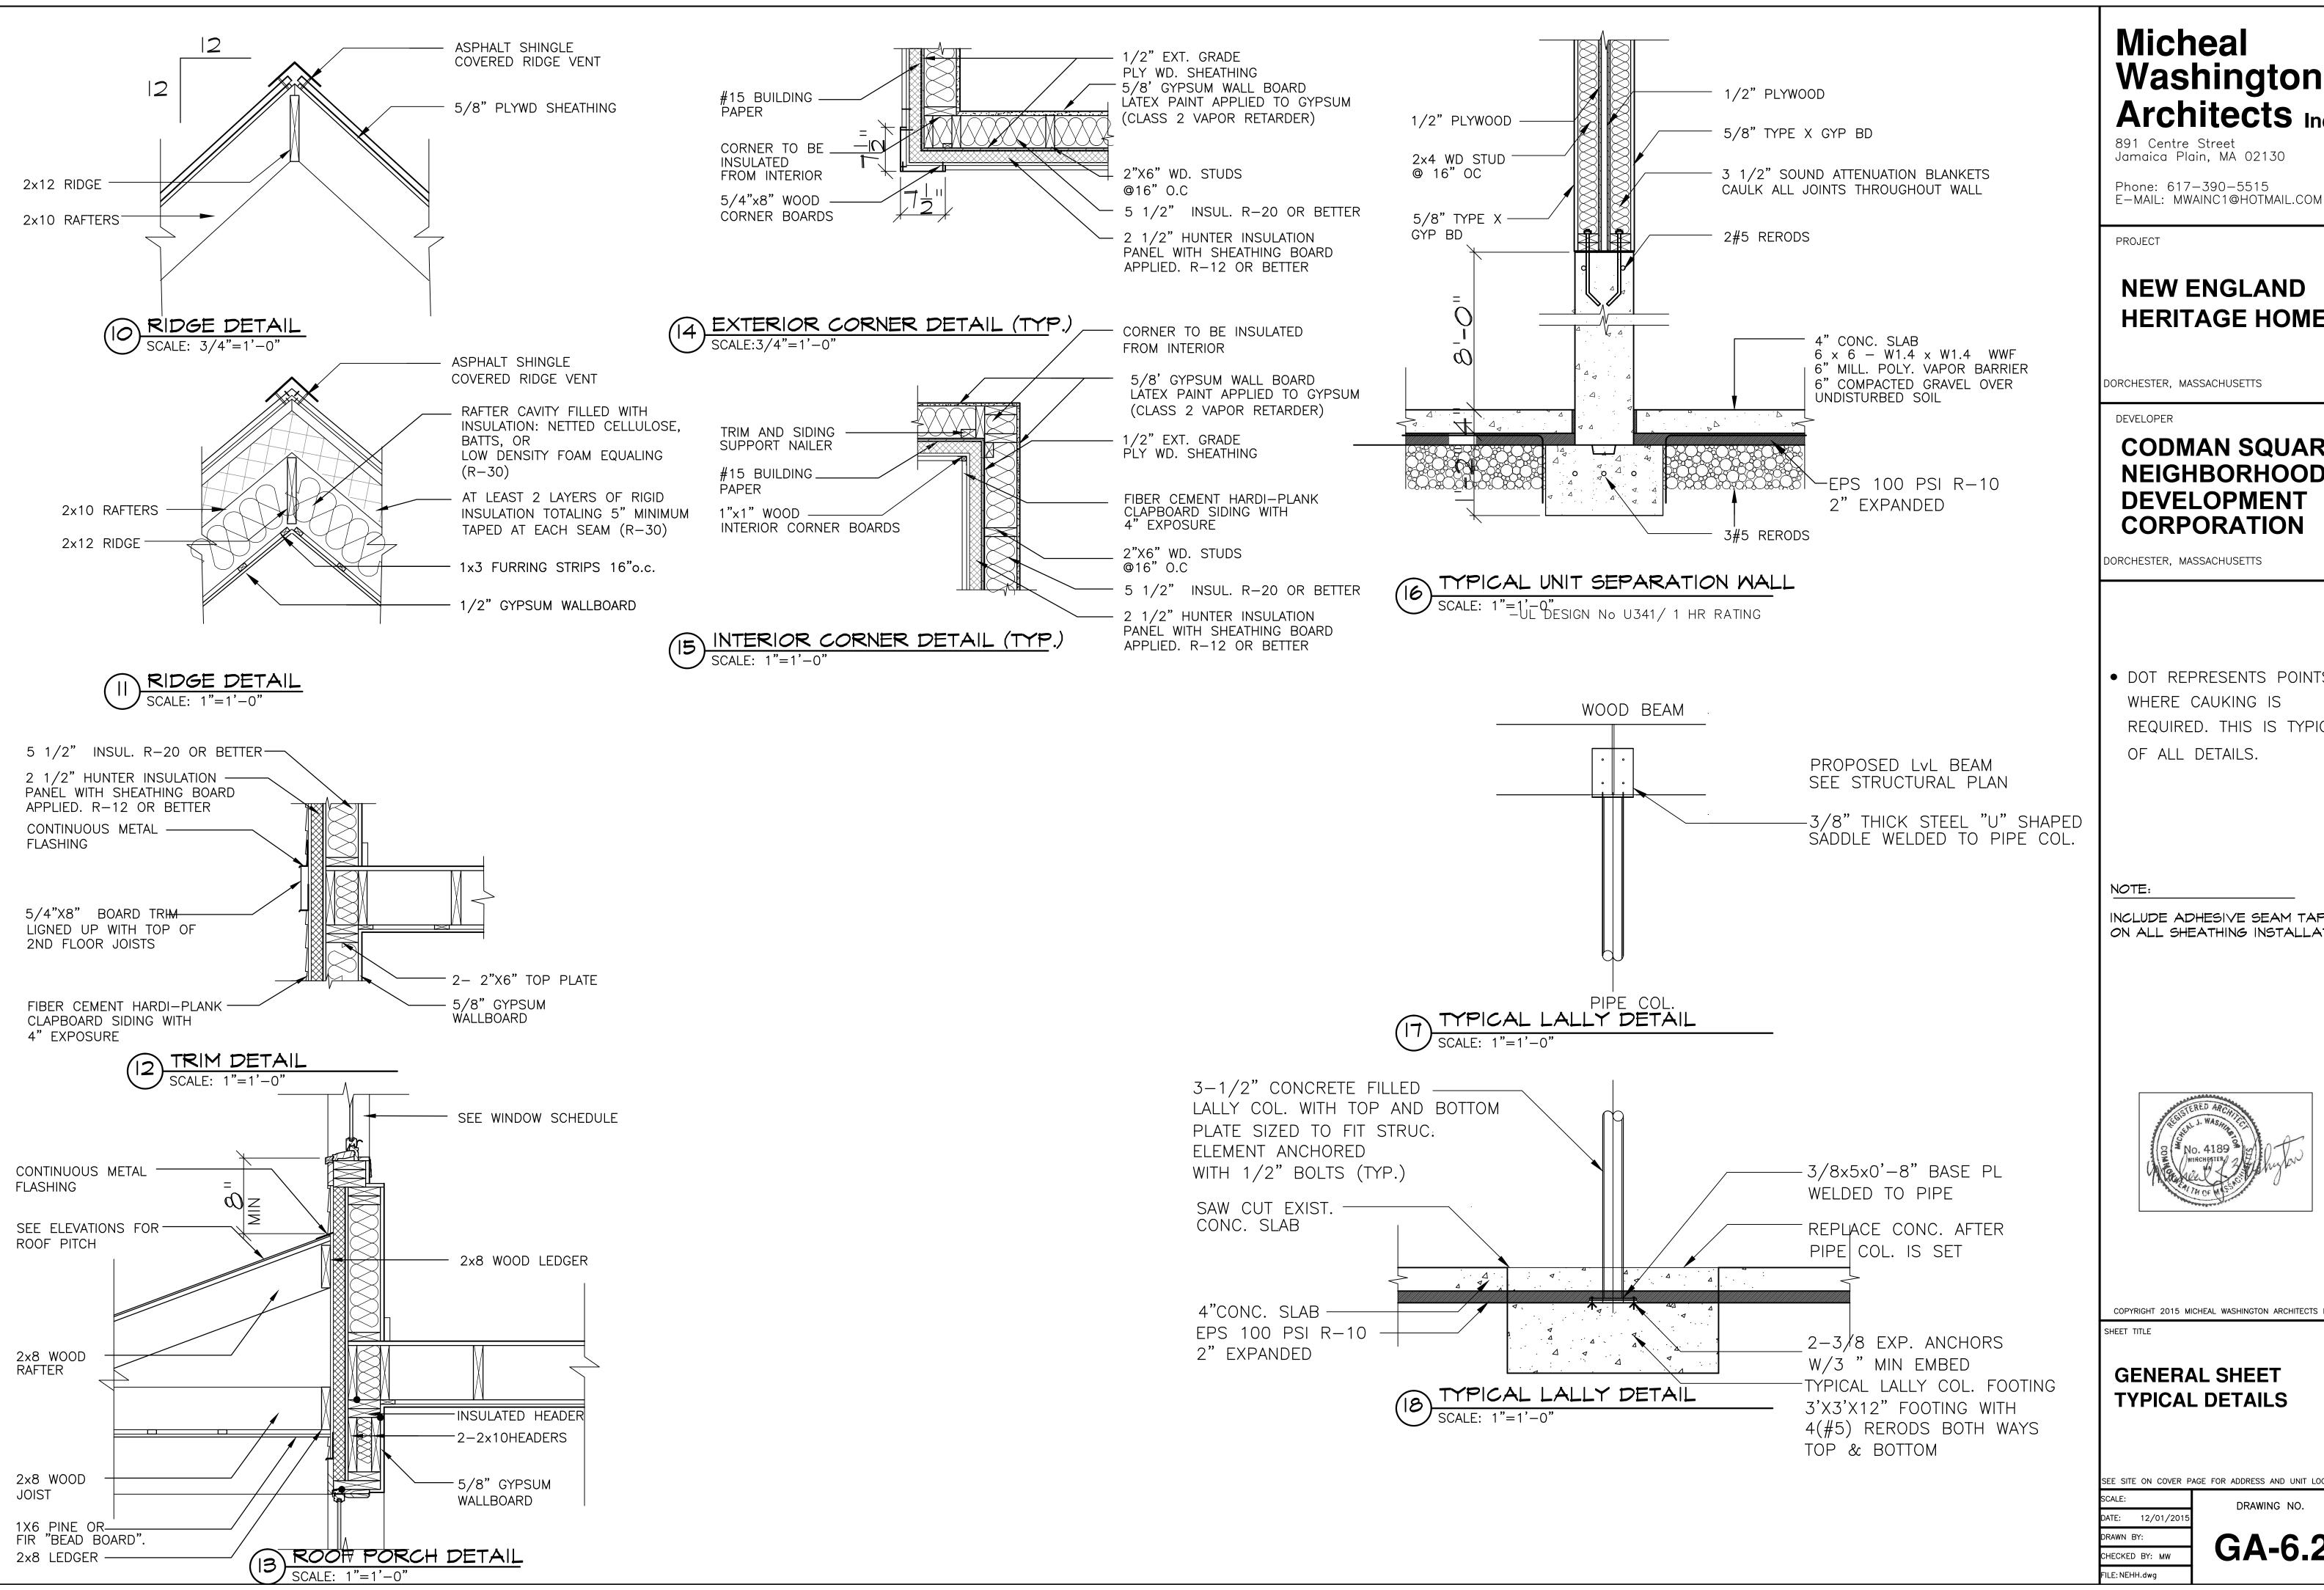

# Washington Architects Inc.


Phone: 617-390-5515

### **NEW ENGLAND HERITAGE HOMES**

### **CODMAN SQUARE NEIGHBORHOOD DEVELOPMENT CORPORATION**

• DOT REPRESENTS POINTS WHERE CAUKING IS REQUIRED. THIS IS TYPICAL

INCLUDE ADHESIVE SEAM TAPE ON ALL SHEATHING INSTALLATION

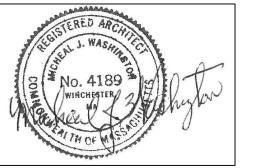

COPYRIGHT 2015 MICHEAL WASHINGTON ARCHITECTS INC

**GENERAL SHEET** 

SEE SITE ON COVER PAGE FOR ADDRESS AND UNIT LOCATION

DRAWING NO.

**GA-6.2** 

CSNDC: New England Heritage Homes BRA Article 80, Small Project Review Application

Appendix B: Permit Applications and Responses



1010 Massachusetts Avenue Boston, MA 02118 Telephone: (617) 635-5300

#### Martin J. Walsh Mayor

#### **ZONING CODE REFUSAL**

MAY 0 7 2015

Gary P. Moccia
Inspector of Buildings

March 27, 2015

JIRAIR OSTAYAN 587 WASHINGTON ST. DORCHESTER, MA 02124

Location:

63 COLONIAL AV DORCHESTER, MA 02124

Ward:

17

**Zoning District:** 

Dorchester

**Zoning Subdistrict:** 

3F-6000

Appl. #: Date Filed:

ERT441535 January 14, 2015

Purpose:

The work consists of construction of a new two family wood framed structure. This will be one of six buildings that will be built on three parcels that will be consolidated into one. Parcels ID 1701568000 (6,425 SF), Parcel ID 1701569000 (11,472 SF) & Parcel ID 1701570000 (4,500 SF). Consolidated Lot area = 22,397 SF. This structure will be attached to a similar structure and separated by a fire separation wall. The units are for sale housing The foundation is a concrete foundation with a wood framed superstructure and a sloped roof. The walls and roof are wood framed composite construction with insulation that exceeds the current energy code. Walls are R-32 and roofs are R-60, and windows are U-.24. Exterior finishes will include Hardi plank siding and asphalt shingled roofs. The building will have an automatic sprinkler system. There will be one parking space per unit on the ground level, plus two parking spaces deeded to the two attached adjacent units. Green spaces will be developed for home owners and the adjacent community.

Violation	Violation Description	Violation Comments
Article 65, Section 8	Use Regulations	3 structures on parcel consisting of 12 total units- (MFR- forbidden)
Article 65, Section 9	Dimensional Regulations	Height/#of stories has been exceeded
Article 65, Section 9	Dimensional Regulations	Excessive F.A.R.
Article 65, Section 9	Dimensional Regulations	Insufficient lot area per unit
Notes		Pending a favorable ZBA decision, a full set of construction documents shall be required.

Location:

63 COLONIAL AV DORCHESTER, MA 02124

Ward:

17

**Zoning District: Zoning Subdistrict:** 

Dorchester 3F-6000

Appl. #:
Date Filed:

ERT441535 January 14, 2015

Purpose:

The work consists of construction of a new two family wood framed structure. This will be one of six buildings that will be built on three parcels that will be consolidated into one. Parcels ID 1701568000 (6,425 SF), Parcel ID 1701569000 (11,472 SF) & Parcel ID 1701570000 (4,500 SF). Consolidated Lot area = 22 397 SF. This structure will be attached to a similar structure and

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Francesco D'Amato

for the Commissioner



1010 Massachusetts Avenue Boston, MA 02118 Telephone: (617) 635-5300

#### Martin J. Walsh Mayor

#### ZONING CODE REFUSAL

MAY 0 7 2015 Inspector of Buildings

March 27, 2015



JIRAIR OSTAYAN 587 WASHINGTON ST. DORCHESTER, MA 02124

Location: 28 MALLARD AV DORCHESTER, MA 02124 🔞

Ward: 17

Zoning District: Dorchester
Zoning Subdistrict: 3F-6000
Appl. #: ERT441543
Date Filed: January 14, 2015

Purpose: The work consists of construction of a new two family wood framed structure. This will be one of

six buildings that will be built on three parcels that will be consolidated into one. Parcels ID 1701568000 (6,425 SF), Parcel ID 1701569000 (11,472 SF) & Parcel ID 1701570000 (4,500 SF). Consolidated Lot area = 22,397 SF. This structure will be attached to a similar structure and separated by a fire separation wall. The units are for sale housing. The foundation is a concrete foundation with a wood framed superstructure and a sloped roof. The walls and roof are wood framed composite construction with insulation that exceeds the current energy code. Walls are R-32 and roofs are R-60, and windows are U-.24. Exterior finishes will include Hardi plank siding and asphalt shingled roofs. The building will have an automatic sprinkler system. There will be one parking space per unit deeded from the attached adjacent building. Green spaces will be developed

for home owners and the adjacent community.

Violation	<u>Violation Description</u>	Violation Comments
Article 65, Section 8	Use Regulations	Three structures on one lot consisting of 12 units MFR/Forbidden
Article 65, Section 9	Dimensional Regulations	Insufficient lot area per unit
Article 65, Section 9	Dimensional Regulations	Insufficient lot size
Article 65, Section 9	Dimensional Regulations	Number of stories/height has been exceeded
Article 65, Section 9	Dimensional Regulations	Excessive F.A.R.
Article 65, Section 9	Dimensional Regulations	Rear yard setback is insufficient
Notes		Pending a favorable ZBA decison, a full set of code compliant stamped construction drawings shall be required, to include, DPW/BWSC departmental approvals.  *Note: 521 CMR compliance

Location:

28 MALLARD AV DORCHESTER, MA 02124

Ward:

17

Zoning District:

Dorchester

Zoning Subdistrict:

3F-6000

Appl. #:
Date Filed:

ERT441543 January 14, 2015

Purpose:

The work consists of construction of a new two family wood framed structure. This will be one of six buildings that will be built on three parcels that will be consolidated into one. Parcels ID 1701568000 (6,425 SF), Parcel ID 1701569000 (11,472 SF) & Parcel ID 1701570000 (4,500 SF). Consolidated Lot area = 22,397 SF. This structure will be attached to a similar structure and separated by a fire separation wall. The units are for sale housing. The foundation is a concrete foundation with a wood framed superstructure and a sloped roof. The walls and roof are wood framed composite construction with insulation that exceeds the current energy code. Walls are R-32 and roofs are R-60, and windows are U-.24. Exterior finishes will include Hardi plank siding and asphalt shingled roofs. The building will have an automatic sprinkler system. There will be one parking space per unit deeded from the attached adjacent building. Green spaces will be developed for home owners and the adjacent community.

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Francesco D'Amato

for the Commissioner



1010 Massachusetts Avenue Boston, MA 02118 Telephone: (617) 635-5300

#### Martin J. Walsh Mayor

#### ZONING CODE REFUSAL

Gary P. Moccia
Inspector of Buildings

MAY 0 7 2015

March 27, 2015



JIRAIR OSTAYAN 587 WASHINGTON ST. DORCHESTER, MA 02124

Location: 32-34 MALLARD AV DORCHESTER MA 02124

Ward:

Zoning District: Dorchester
Zoning Subdistrict: 3F-6000
Appl. #: ERT441549
Date Filed: January 14, 2015

Purpose: The work consists of construction of a new two family wood framed structure. This will be one of

six buildings that will be built on three parcels that will be consolidated into one. Parcels ID 1701568000 (6,425 SF), Parcel ID 1701569000 (11,472 SF) & Parcel ID 1701570000 (4,500 SF). Consolidated Lot area = 22,397 SF. This structure will be attached to a similar structure and separated by a fire separation wall. The units are for sale housing The foundation is a concrete foundation with a wood framed superstructure and a sloped roof. The walls and roof are wood framed composite construction with insulation that exceeds the current energy code. Walls are R-32 and roofs are R-60, and windows are U-.24. Exterior finishes will include Hardi plank siding and

asphalt shingled roofs. The building will have an automatic sprinkler system. There will be one parking space per unit on the ground level, plus two parking spaces deeded to the two attached adjacent units. Green spaces will be developed for home owners and the adjacent community.

Violation	Violation Description	Violation Comments
Article 65, Section 8	Use Regulations	Three structures on one lot consisting of 12 units MFR/Forbidden
Article 65, Section 9	Dimensional Regulations	Insufficient lot size
Article 65, Section 9	Dimensional Regulations	Insufficient additionally required lot area per unit
Article 65, Section 9	Dimensional Regulations	Excessive F.A.R.
Article 65, Section 9	Dimensional Regulations	Number of stories/height exceeded
Article 65, Section 9	Dimensional Regulations	Rear yard setback is insufficient
Notes		Pending a favorable ZBA decison, a full set of code compliant stamped construction drawings shall be required, to include, DPW/BWSC departmental approvals.  *521 CMR

Location:

32-34 MALLARD AV DORCHESTER MA 02124

Ward:

17

**Zoning District: Zoning Subdistrict:** 

Dorchester 3F-6000

Appl. # :
Date Filed:

ERT441549 January 14, 2015

Purpose:

The work consists of construction of a new two family wood framed structure. This will be one of six buildings that will be built on three parcels that will be consolidated into one. Parcels ID

1701568000 (6,425 SF), Parcel ID 1701569000 (11,472 SF) & Parcel ID 1701570000 (4,500 SF). Consolidated Lot area = 22,397 SF. This structure will be attached to a similar structure and separated by a fire separation wall. The units are for sale housing The foundation is a concrete foundation with a wood framed superstructure and a sloped roof. The walls and roof are wood framed composite construction with insulation that exceeds the current energy code. Walls are R-32 and roofs are R-60, and windows are U-.24. Exterior finishes will include Hardi plank siding and

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Francesco D'Amato

for the Commissioner



1010 Massachusetts Avenue Boston, MA 02118 Telephone: (617) 635-5300

#### Martin J. Walsh Mayor

#### **ZONING CODE REFUSAL**

Gary P. Moccia Inspector of Buildings

JIRAIR OSTAYAN 587 WASHINGTON ST. DORCHESTER, MA 02124

Location:

36-38 MALLARD AV DORCHESTER MA 02124

Ward:

17

**Zoning District:** 

Dorchester 3F-6000

**Zoning Subdistrict:** Appl.#:

ERT441550

**Date Filed:** 

January 14, 2015

Purpose:

The work consists of construction of a new two family wood framed structure. This will be one of six buildings that will be built on three parcels that will be consolidated into one. Parcels ID 1701568000 (6,425 SF), Parcel ID 1701569000 (11,472 SF) & Parcel ID 1701570000 (4,500 SF). Consolidated Lot area = 22,397 SF. This structure will be attached to a similar structure and separated by a fire separation wall. The units are for sale housing The foundation is a concrete foundation with a wood framed superstructure and a sloped roof. The walls and roof are wood framed composite construction with insulation that exceeds the current energy code. Walls are R-32 and roofs are R-60, and windows are U-.24. Exterior finishes will include Hardi plank siding and asphalt shingled roofs. The building will have an automatic sprinkler system. There will be one parking space per unit on the ground level, plus two parking spaces deeded to the two attached adjacent units. Green spaces will be developed for home owners and the adjacent community.

Violation	Violation Description	Violation Comments
Article 65, Section 8	Use Regulations	Three structures on one lot MFR/Forbidden
Article 65, Section 9	Dimensional Regulations	Additional lot area required per unit is insufficient
Article 65, Section 9	Dimensional Regulations	Rear yard setback is insufficient
Article 65, Section 9	Dimensional Regulations	Number of stories/height has been exceeded
Article 65, Section 9	Dimensional Regulations	Excessive F.A.R.
Notes		Pending a favorable ZBA decision, a full set of code compliant stamped drawings shall be required, to include, DPW/BWSC departmental approvals

Location:

36-38 MALLARD AV DORCHESTER MA 02124

Ward:

17

**Zoning District: Zoning Subdistrict:** 

Dorchester 3F-6000

Appl. # : Date Filed: 3F-6000 ERT441550 January 14, 2015

Purpose:

The work consists of construction of a new two family wood framed structure. This will be one of six buildings that will be built on three parcels that will be consolidated into one. Parcels ID

1701568000 (6,425 SF), Parcel ID 1701569000 (11,472 SF) & Parcel ID 1701570000 (4,500 SF). Consolidated Lot area = 22,397 SF. This structure will be attached to a similar structure and separated by a fire separation wall. The units are for sale housing The foundation is a concrete foundation with a wood framed superstructure and a sloped roof. The walls and roof are wood framed composite construction with insulation that exceeds the current energy code. Walls are R-32 and roofs are R-60, and windows are U-.24. Exterior finishes will include Hardi plank siding and

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Francesco D'Amato

for the Commissioner



1010 Massachusetts Avenue Boston, MA 02118 Telephone: (617) 635-5300

#### Martin J. Walsh Mayor

Location:

#### **ZONING CODE REFUSAL**

MAY 0 7 2015

March 27, 20

Gary P. Moccia Inspector of Buildings

JIRAIR OSTAYAN 587 WASHINGTON ST. DORCHESTER, MA 02124

40-42 MALLARD AV DORCHESTER MA 02124 A

Ward: 17

Zoning District: Dorchester
Zoning Subdistrict: 3F-6000
Appl. #: ERT441554
Date Filed: January 14, 2015

Purpose: The work consists of construction of a new two family wood framed structure. This will be one of

six buildings that will be built on three parcels that will be consolidated into one. Parcels ID 1701568000 (6,425 SF), Parcel ID 1701569000 (11,472 SF) & Parcel ID 1701570000 (4,500 SF). Consolidated Lot area = 22,397 SF. This structure will be attached to a similar structure and separated by a fire separation wall. The units are for sale housing. The foundation is a concrete foundation with a wood framed superstructure and a sloped roof. The walls and roof are wood framed composite construction with insulation that exceeds the current energy code. Walls are R-32 and roofs are R-60, and windows are U-.24. Exterior finishes will include Hardi plank siding and

asphalt shingled roofs. The building will have an automatic sprinkler system. There will be one parking space per unit deeded from the attached adjacent building. Green spaces will be developed

for home owners and the adjacent community.

<u>Violation</u>	Violation Description	Violation Comments
Article 65, Section 8	Use Regulations	Three structures on one lot MFR/Forbidden
Article 65, Section 9	Dimensional Regulations	Additional lot are required per unit is insufficient
Article 65, Section 9	Dimensional Regulations	Rear yard setback is insufficient
Article 65, Section 9	Dimensional Regulations	Number of stories/height has been exceeded
Article 65, Section 9	Dimensional Regulations	Excessive F.A.R.
Notes		Pending a favorable ZBA decision, a full set of construction documents shall be required, to include, DPW/BWSC departmental approvals

**Location:** 40-42 MALLARD AV DORCHESTER MA 02124

Ward:

Zoning District:

Zoning Subdistrict:

Appl. #:

Dorchester

3F-6000

ERT441554

January 14, 2015

Purpose:

The work consists of construction of a new two family wood framed structure. This will be one of six buildings that will be built on three parcels that will be consolidated into one. Parcels ID 1701568000 (6,425 SF), Parcel ID 1701569000 (11,472 SF) & Parcel ID 1701570000 (4,500 SF). Consolidated Lot area = 22,397 SF. This structure will be attached to a similar structure and separated by a fire separation wall. The units are for sale housing. The foundation is a concrete foundation with a wood framed superstructure and a sloped roof. The walls and roof are wood framed composite construction with insulation that exceeds the current energy code. Walls are R-32 and roofs are R-60, and windows are U-.24. Exterior finishes will include Hardi plank siding and

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Francesco D'Amato

for the Commissioner



1010 Massachusetts Avenue Boston, MA 02118 Telephone: (617) 635-5300

#### Martin J. Walsh Mayor

#### **ZONING CODE REFUSAL**

MAY 0 7 2015 Gary P. Moccia Inspector of Buildings

JIRAIR OSTAYAN 587 WASHINGTON ST. DORCHESTER, MA 02124

March 27, 2015

Location: 67-69 COLONIAL AV DORCHESTER MA 02124 ♥

Ward:

Zoning District: Dorchester
Zoning Subdistrict: 3F-6000
Appl. #: ERT441540
Date Filed: January 14, 2015

Purpose: The work consists of construction of a new two family wood framed structure. This will be one of

six buildings that will be built on three parcels that will be consolidated into one. Parcels ID 1701568000 (6,425 SF), Parcel ID 1701569000 (11,472 SF) & Parcel ID 1701570000 (4,500 SF). Consolidated Lot area = 22,397 SF. This structure will be attached to a similar structure and separated by a fire separation wall. The units are for sale housing. The foundation is a concrete foundation with a wood framed superstructure and a sloped roof. The walls and roof are wood framed composite construction with insulation that exceeds the current energy code. Walls are R-32 and roofs are R-60, and windows are U-.24. Exterior finishes will include Hardi plank siding and asphalt shingled roofs. The building will have an automatic sprinkler system. There will be one parking space per unit deeded from the attached adjacent building. Green spaces will be developed

for home owners and the adjacent community.

Violation	Violation Description	Violation Comments
Article 65, Section 8	Use Regulations	Three structures on one lot consisting of 12 units MFR/forbidden
Article 65, Section 9	Dimensional Regulations	Insufficient lot area/unit
Article 65, Section 9	Dimensional Regulations	Number of stories/height has been exceeded
Article 65, Section 9	Dimensional Regulations	Excessive F.A.R.
Article 65, Section 9	Dimensional Regulations	Insufficent lot size
Notes		Pending a favorable ZBA decison, a full set of code compliant stamped drawings shall be required, to inlcude, DPW/BWSC departmental approvals.\ * Consult architect with respects to 521 CMR compliance for future building code review

67-69 COLONIAL AV DORCHESTER MA 02124 Location:

17 Ward:

> Dorchester 3F-6000 ERT441540 January 14, 2015

**Zoning Subdistrict:** Appl.#: **Date Filed:** 

**Zoning District:** 

Purpose:

The work consists of construction of a new two family wood framed structure. This will be one of six buildings that will be built on three parcels that will be consolidated into one. Parcels ID

1701568000 (6,425 SF), Parcel ID 1701569000 (11,472 SF) & Parcel ID 1701570000 (4,500 SF). Consolidated Lot area = 22,397 SF. This structure will be attached to a similar structure and separated by a fire separation wall. The units are for sale housing. The foundation is a concrete foundation with a wood framed superstructure and a sloped roof. The walls and roof are wood framed composite construction with insulation that exceeds the current energy code. Walls are R-32 and roofs are R-60, and windows are U-.24. Exterior finishes will include Hardi plank siding and

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Francesco D'Amato

for the Commissioner



1010 Massachusetts Avenue Boston, MA 02118 Telephone: (617) 635-5300

### Martin J. Walsh Mayor ZONING CODE REFUSAL

Gary P. Moccia Inspector of Buildings

MAY 0 7 2015

March 27, 2015

JIRAIR OSTAYAN 587 WASHINGTON ST. DORCHESTER, MA 02124

Location:

68-70 COLONIAL AV DORCHESTER MA 02124

Ward:

17

**Zoning District:** 

Dorchester 3F-6000

Zoning Subdistrict: Appl. #:

ERT441522

Date Filed:

January 14, 2015

Purpose:

The work consists of construction of a new two family wood framed structure. This will be one of three buildings that will be built on four parcels that will be **consolidated into one**. Parcels ID

1701534000 (4,000 SF), Parcel ID 1701534001 (5,943 SF), Parcel ID 1701535000 (5,354 SF) & Parcel ID 1701536000 (3,600 SF). Consolidated Lot area = 18,897 SF. This structure will be attached to a similar structure and separated by a fire separation wall. The units are for sale housing The foundation is a concrete foundation with a wood framed superstructure and a sloped roof. The walls and roof are wood framed composite construction with insulation that exceeds the current energy code. Walls are R-32 and roofs are R-60, and windows are U-.24. Exterior finishes will include Hardi plank siding and asphalt shingled roofs. There will be one parking space per unit on the ground level, plus two parking spaces deeded to the two attached adjacent units. Green spaces will be developed for

home owners and the adjacent community.

\* (3F+(2F+2F))

Violation	Violation Description	Violation Comments
Article 65, Section 8	Use Regulations	Multifamily structures are forbidden within this subdistrict (Total Structures on combined parcel (detached 3F) and (an attached 2F+2F = 4 unit structure)
Article 65, Section 9	Dimensional Regulations	Insufficient lot size
Article 65, Section 9	Dimensional Regulations	Additional lot area required is insufficient
Article 65, Section 9	Dimensional Regulations	Rear yard setback is insufficient due to 2nd story decks
Article 65, Section 9	Dimensional Regulations	Number of stories/height has been exceeded
Article 65, Section 9	Dimensional Regulations	Excessive F.A.R.
Notes		Pending a favorable ZBA decision, a full set of code compliant drawings with schedules shall be required consisting of stamped: Structurals, foundation, mechanicals, electrical, civil, etc., with BWSC/DPW approvals

Location:

68-70 COLONIAL AV DORCHESTER MA 02124

Ward:

17

Zoning District:

Dorchester

Zoning Subdistrict:

3F-6000

Appl. #:

ERT441522

Date Filed:

January 14, 2015

Purpose:

The work consists of construction of a new two family wood framed structure. This will be one of three buildings that will be built on four parcels that will be **consolidated into one**. Parcels ID 1701534000 (4,000 SF), Parcel ID 1701534001 (5,943 SF), Parcel ID 1701535000 (5,354 SF) & Parcel ID 1701536000 (3,600 SF). Consolidated Lot area = 18,897 SF. This structure will be attached to a similar structure and separated by a fire separation wall. The units are for sale housing The foundation is a concrete foundation with a wood framed superstructure and a sloped roof. The walls and roof are wood framed composite construction with insulation that exceeds the current energy code. Walls are R-32 and roofs are R-60, and windows are U-.24. Exterior finishes will include Hardi plank siding and asphalt shingled roofs. There will be one parking space per unit on the ground level, plus two parking spaces deeded to the two attached adjacent units. Green spaces will be developed for home owners and the adjacent community.

\* (3F+(2F+2F))

THIS DECISION MAY BE APPEALED TO THE BOARD OF APPEAL WITHIN FORTY-FIVE (45) DAYS PURSUANT TO CHAPTER 665 OF THE ACTS OF 1956, AS AMENDED. APPLICATIONS NOT APPEALED WITHIN THAT TIME PERIOD WILL BE DEEMED ABANDONED. IF YOU HAVE INQUIRIES REGARDING THE NEIGHBORHOOD PROCESS AND PUBLIC PARTICIPATION, PLEASE CONTACT THE MAYOR'S OFFICE OF NEIGHBORHOOD SERVICES AT

Francesco D'Amato

for the Commissioner



1010 Massachusetts Avenue Boston, MA 02118 Telephone: (617) 635-5300

#### Martin J. Walsh Mayor

Purpose:

#### **ZONING CODE REFUSAL**

MAY 0 > 2015 Gary P. Moccia
Inspector of Buildings

.... March 27, 2015

JIRAIR OSTAYAN 587 WASHINGTON ST. DORCHESTER, MA 02124

Location: 72-74 COLONIAL AV DORCHESTER MA 02124

Ward: 17

Zoning District: Dorchester
Zoning Subdistrict: 3F-6000
Appl. #: ERT441527
Date Filed: January 14, 2015

The work consists of construction of a new two family wood framed structure. This will be one of

three buildings that will be built on four parcels that will be consolidated into one. Parcels ID

1701534000 (4,000 SF), Parcel ID 1701534001 (5,943 SF), Parcel ID 1701535000 (5,354 SF) & Parcel ID 1701536000 (3,600 SF). Consolidated Lot area = 18,897 SF. This structure will be attached to a similar structure and separated by a fire separation wall. The units are for sale housing The foundation is a concrete foundation with a wood framed superstructure and a sloped roof. The walls and roof are wood framed composite construction with insulation that exceeds the current energy code. Walls are R-32 and roofs are R-60, and windows are U-.24. Exterior finishes will include Hardi plank siding and asphalt shingled roofs. There will be one parking space per unit deeded from the attached

adjacent building. Green spaces will be developed for home owners and the adjacent community.

Article 65, Section 8  Article 65, Section 9  Dimensional Regulations  Number of stories/height has been exceeded  Article 65, Section 9  Dimensional Regulations  Excessive F.A.R.  Notes  Pending a favorable ZBA decison, a full set of code compliant stamped drawings shall be required, to inleude DPW/BWSC departmental approvals	Violation	Violation Description	Violation Comments
Article 65, Section 9 Dimensional Regulations Article 65, Section 9 Dimensional Regulations Rear yard setback is insufficient  Rear yard setback is insufficient  Number of stories/height has been exceeded  Article 65, Section 9 Dimensional Regulations Excessive F.A.R.  Notes  Pending a favorable ZBA decison, a full set of code compliant stamped drawings shall be required, to	Article 65, Section 8	Use Regulations	Three structures on one lot/MFR
Article 65, Section 9 Dimensional Regulations Rear yard setback is insufficient Number of stories/height has been exceeded Article 65, Section 9 Dimensional Regulations Dimensional Regulations Excessive F.A.R.  Pending a favorable ZBA decison, a full set of code compliant stamped drawings shall be required, to	Article 65, Section 9	Dimensional Regulations	Insufficient lot size
Article 65, Section 9 Dimensional Regulations Number of stories/height has been exceeded Excessive F.A.R.  Notes Pending a favorable ZBA decison, a full set of code compliant stamped drawings shall be required, to	Article 65, Section 9	Dimensional Regulations	Additional lot are required per unit is insufficient
Article 65, Section 9 Dimensional Regulations Excessive F.A.R.  Notes Pending a favorable ZBA decison, a full set of code compliant stamped drawings shall be required, to	Article 65, Section 9	Dimensional Regulations	Rear yard setback is insufficient
Notes  Pending a favorable ZBA decison, a full set of code compliant stamped drawings shall be required, to	Article 65, Section 9	Dimensional Regulations	Number of stories/height has been exceeded
compliant stamped drawings shall be required, to	Article 65, Section 9	Dimensional Regulations	Excessive F <sub>*</sub> A <sub>*</sub> R <sub>*</sub>
	Notes		compliant stamped drawings shall be required, to

Location:

72-74 COLONIAL AV DORCHESTER MA 02124

Ward:

17

**Zoning District: Zoning Subdistrict:** 

Dorchester 3F-6000

Appl. #:
Date Filed:

ERT441527

Date Filed Purpose:

January 14, 2015

The work consists of construction of a new two family wood framed structure. This will be one of three buildings that will be built on four parcels that will be consolidated into one. Parcels ID

1701534000 (4,000 SF), Parcel ID 1701534001 (5,943 SF), Parcel ID 1701535000 (5,354 SF) & Parcel ID 1701536000 (3,600 SF). Consolidated Lot area = 18,897 SF. This structure will be attached to a similar structure and separated by a fire separation wall. The units are for sale housing The foundation is a concrete foundation with a wood framed superstructure and a sloped roof. The walls and roof are wood framed composite construction with insulation that exceeds the current energy code. Walls are R-32 and roofs are R-60, and windows are U-.24. Exterior finishes will include Hardi plank siding and asphalt shingled roofs. There will be one parking space per unit deeded from the attached

adjacent building. Green spaces will be developed for home owners and the adjacent community.

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Francesco D'Amato

for the Commissioner



1010 Massachusetts Avenue Boston, MA 02118 Telephone: (617) 635-5300

#### Martin J. Walsh Mayor

#### ZONING CODE REFUSAL

MAY 0 7 2015

Gary P. Moccia Inspector of Buildings

JIRAIR OSTAYAN 587 WASHINGTON ST. DORCHESTER, MA 02124

March 27, 2015

Location:

131-133 SOUTHERN AV DORCHESTER MA 02124

Ward:

17

Zoning District: Zoning Subdistrict: Dorchester 3F-6000

Appl. #:
Date Filed:

ERT441519 January 14, 2015

Purpose:

The work consists of construction of a new three family wood framed structure. This will be one of

three buildings that will be built on four parcels that will be consolidated into one. Parcels ID

1701534000 (4,000 SF), Parcel ID 1701534001 (5,943 SF), Parcel ID 1701535000 (5,354 SF) & Parcel ID 1701536000 (3,600 SF). Consolidated Lot area = 18,897 SF. There are two duplex townhouse units over a single story H.C. accessible unit. The foundation is a concrete slab on grade foundation with a wood framed superstructure and a sloped roof. The walls and roof are wood framed composite construction with insulation that exceeds the current energy code. Walls are R-32 and roofs are R-60, and windows are U-.24. Exterior finishes will include Hardi plank siding and asphalt shingled roofs. The building will have an automatic sprinkler system. The building will have one parking space per unit. Green spaces will be developed for home owners and the adjacent

community.

YOUR APPLICATION REQUIRES RELIEF FROM THE BOARD OF APPEAL AS SAME WOULD BE IN VIOLATION OF THE BOSTON ZONING CODE TO WIT: CHAPTER 665, ACTS OF 1956 AS AMENDED:

<u>Violation Description</u> <u>Violation Comments</u>

Article 65, Section 9

Dimensional Regulations

Excessive F.A.R.

Article 65, Section 9

**Dimensional Regulations** 

Number of stories/height has been exceeded

Notes

Pending a favorable ZBA decision, a full set of code compliant construction documents shall be required.

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Francesco D'Amato

for the Commissioner



ity of Boston Inspectional Services 617-635-5300

Discount

Receipt #: 01085281 Permit # ERT546001 

 Date:
 12/9/2015 11:28 AM

 Cashier:
 078135
 Batch:
 24264

 Office:
 ISD
 Tran #:
 42

COBISD120415-NEH... NEHH: ISD permit app and BZC fees for church lots project

Payee CITY OF BOSTON
Vendor ID COBISD

Payment Total:

Invoice

\$300.00 \$300.00 \$50.00

Payment Total: \$5,600.00 \$5,600.00 \$700.00

Thank you for your payment. Have a Nice Day!

ww.cityofboston.gov/isd/

Total:

Account #:

Description

\$0.00

\$0.00

\$5,600.00

103030 12/7/2015

\$5,600.00

**Amount**