Boston Planning and Development Authority Article 80 Small Project Review

Submittal for Proposed Residential Conversion 735 Truman Parkway Hyde Park, Massachusetts



Submitted By Nordblom Company 71 Third Avenue Burlington, MA 01803



735 Truman Parkway Residential Project



April 4, 2017

Brian Golden, Director Boston Planning and Development Authority Boston City Hall, 9th Floor Boston, MA 02201

Dear Mr. Golden:

It is my pleasure to submit this application for Small Project Review pursuant to Article 80, Section 80E, of the Boston Zoning Code, for the 735 Truman Parkway residential conversion project in Hyde Park.

The project consists of 46 units of residential apartment units, primarily market rate, with 6 affordable units in accordance with the Mayor's executive order on inclusionary development, served by 62 parking spaces located on grade in existing parking lots. The project is a renovation of a nursing home which closed in the spring of 2016.

The applicant is 735 Truman Property Owner, LLC C/O Nordblom Development Company, the current owner of the project site. Architectural services are being provided by Choo & Company, Inc. of Quincy, Massachusetts.

On behalf of the applicant and development team, I wish to thank the BPDA for its guidance and assistance to date for this project. We look forward to continuing our strong working relationship with you and your staff as we move towards approval of this project.

Sincerely,

Todd Fremont-Smith

735 Truman Parkway Residential Project

Hyde Park, MA

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- Exhibit 6: Views of contextual Apartment on Truman
- Exhibit 8: Elevations, Floor Plans and Architectural Site Plan

I. PROJECT SUMMARY

1.1 Project Team

Developer and Applicant Nordblom Development Company Attn: Todd Fremont-Smith 71 Third Avenue Burlington, MA 01803 Email: tfremont-smith@nordblom.com

Legal Council Rubin and Rudman LLP Attn: Paula Devereaux 50 Rowes Wharf Boston, MA 02110 617-330-7000 Email: pdevereaux@rubinrudman.com

Architecture Choo & Company, Inc. Attn: Arthur Choo One Billings Road Quincy, MA 02171 Tel.: 617-786-7727 Email: arthur@choo-design.com

<u>Civil Engineer</u> Design Consultants, Inc. (DCI) Attn: Steve Sawyer 120 Middlesex Ave, Suite 20 Somerville, MA 02145 617-776-3350 Email: <u>SSawyer@dci-ma.com</u>

1.2 PROJECT NARRATIVE

The proposed project consists of renovating an existing 3 story building situated at 735 Truman Parkway in Hyde Park. The lot size is 55,329 square feet with 62 surface parking spaces, and a building living area of 34,604 square feet (approximately 49,805 gross square feet). The existing building, which is currently vacant, was formerly used as an assisted-living nursing home through April 2016. The developer and applicant, Nordblom Development Company, purchased the property in February 2017 in the name of 735 Truman Property Owner, LLC.

The proposed renovated building footprint would remain unchanged. The building would contain approximately 49,805 gross square feet, with the building's main residential entrance and lobby facing Truman Parkway. The 62 existing surface parking spaces remain. There would be 46 residential units located on three floors.

1.3 COMMUNITY BENEFITS

The proposed project will offer many public benefits to the surrounding neighborhood and to the City of Boston, including:

- Repurposing of an important community landmark, The Parkwell, an assisted-living community that served the Hyde Park neighborhood for over 50 years. The Parkwell lost its operating license, closed its doors in spring 2016 and has been vacant since that time.
- The creation of 46 new residential units in an existing low-rise building, including 13% affordable units in accordance with the Mayor's Execution Order on Inclusionary Development;
- Generation of thousands of dollars in revenue annually to the City of Boston once the project is completed in the form of new real property tax payments
- The expected creation of approximately 50 construction jobs to complete the proposed project.

II. DETAILED PROJECT INFORMATION

2.1 Project Description

The project site consists of 55,329+/- square feet of land area, being a single parcel of land situated at 735 Truman Parkway in Hyde Park, being the City of Boston's Assessor's Parcel No. 1810591000. The site fronts onto Truman Parkway and is bordered on the left and right sides by residential buildings. To the rear of the property is the Massachusetts Bay Transit Authority's commuter rail, the Forge Park line.

Projected Total Construction Costs:\$6,000,000Estimated Construction Start:Summer 2017Estimated Construction Completion:Spring 2018

2.2 Propose Project Program, Data and Dimensions

Lot Area:	55,329 +/-
Maximum Building Height:	29'3"
Number of Residential Units:	46 units

Residential Unit Description:

1st floor:	
1 BR =9 units	9BR
1 BR/ST =3 units	3BR
2 BR =2 units	4 BR
14 UNITS	16 BEDROOMS

2nd floor:

3rd floor: 1 BR =9 units 1 BR/ST =2 units 2 BR =5 units 16 UNITS 9 BR 2 BR 10 BR 21 BEDROOMS

Building totals: TOTAL 46 UNITS 58 BEDROOMS

Total Building Gross Square Footage: 49,805 square feet

Floor Area Ratio:	0.92
Parking Spaces:	62

2.3 Urban Design Approach – Building Program, Massing and Materials

The proposed project will re-use the existing three story masonry building. The project will replace existing windows with dark (brown/green) casement windows, as well as enlarge the window opening on the first floor such that they are building standard. The gravel stop will be replaced to match the color of the windows as well.

All three stories will be converted from their prior use to rental apartments. On the first floor there will be 14 apartments. On the second floor there will be 16 apartments. And on the third floor there will be 16 apartments. A common patio of approximately 200 square feet will be provided for residents use on the southwest side of the building, above the entrance.

Building setbacks will remain as they exist today.

2.4 Traffic, Parking and Access

The projects existing 62 parking spaces will be accessed via Truman Parkway using two existing curb cuts. All loading and unloading activity will be confined to the main tenant entrance where direct elevator access to all floors will be provided.

The site is located 0.2 miles from the Fairmont stop of the Fairmont/Franklin line of the MBTA Commuter rail. Departures run every 20-30 minutes during commuting hours. The proximity and regularity of public transportation will reduce vehicle trip generation from the proposed Project.

Agency Name	Permit or Action	
Boston Planning and Development Authority	Article 80 Small Project Review	
	Affordable Housing Agreement	
	Design Review Approval	
Zoning Board of Appeals	Variance Use Permits	
Boston Inspectional Services Department	Building Permit	
	Certificate of Occupancy	
Boston Water and Sewer Commission	Approvals	
Conservation Commission	Approvals	

2.5 Anticipated Permits and Approvals

2.6 Community Outreach

The Project has engaged the community in the process and presented plans to both the Hyde Park Neighborhood Association and the Fairmont Neighborhood Association. Through this process the project has received considerable community input regarding the form and function of the proposed re-use. Both neighborhood groups have been receptive to the proposal to change the use of the property from its current state of a closed nursing home to a residential apartment building. Additionally, the neighborhoods input of keeping the existing building shell and site layout largely undisturbed influenced the project scope. Lastly, and perhaps most importantly, the communities feedback on parking, specifically maintaining a 1 car per bedroom parking ratio, greatly influenced the decision not to expand on the existing structure but rather to utilize the existing parking spaces with a 46 unit layout within the existing building footprint. The two neighborhood associations support the project, documented by their verbal support and pending joint letter of support.

III. BOSTON ZONING CODE DATA

3.1 Zoning District Requirements

The Site is located at 735 Truman Parkway within the Hyde Park Neighborhood District which is governed by Article 69 of the Boston Zoning Code (Code) and shown on Map 12 of the zoning maps. The Site is located within the 1F - 6,000 zoning district, the Greenbelt Protection Overlay District (GPOD), and the Riverfront Protection Overlay District. The proposed multifamily use of the Site is not allowed in this district. The prior use of the Site for a nursing home facility (also a forbidden use) was allowed by a decision of the Boston Board of Appeals in 1966, with additional relief granted in 1978. The nursing home closed in 2016.

3.2 Zoning Relief Required

It is anticipated that relief from the provisions of the Code will be obtained from the Board of Appeals for the Proposed Project. The relief may include, without limitation, approval for the change of use of the Site from nursing home use to multifamily use (Article 9 of the Code), a GPOD conditional use permit (Articles 29 and 6 of the Code), and a possible variance for parking (the required parking ratio for residential use is 2 spaces per dwelling unit, the Proposed Project will contain 1.25 spaces per dwelling unit). The exact nature and form of the relief that will be sought from the Board of Appeals for the Proposed Project will be finalized with the Inspectional Services Department. The Proposed Project will comply with the Inclusionary Development Policy established by the Executive Order of Mayor Martin J. Walsh dated December 9, 2015.

LEGAL INFORMATION

Legal Judgments Adverse to Proposed Project. There are no legal judgments that affect the Proposed Project.

History of Tax Arrears on Property. Property taxes are paid when due and there are no outstanding unpaid taxes or other fees owed by the Proponent.

Site Control/ Easements. The Site is owned by 735 Truman Property Owner LLC, a Massachusetts limited liability company pursuant to Deed dated February 6, 2017 and recorded with the Suffolk County Registry of Deeds in Book 57551, Page 134. The Site is not subject to any easements that would prohibit the construction of the Proposed Project.

IV. URBAN DESIGN SUBMISSION: PHOTOGRAPHS, MAPS, & PLANS

Exhibit 1:	Assessor's Map
Exhibit 2:	Aerial View
Exhibit 3:	Views of Site from Truman Parkway
Exhibit 4:	Views of Site from within Property
Exhibit 5:	Views of contextual Neighboring Sites
Exhibit 6:	Views of contextual Apartment Sites on Truman
Exhibit 8:	Elevations, Floor Plans, and Architectural Site Plan

EXHIBIT 1 – ASSESSOR'S MAP





EXHIBIT 3 – VIEWS OF SITE FROM TRUMAN PARKWAY







735 Truman Parkway Residential Project

EXHIBIT 4 – VIEWS OF SITE FROM WITHIN PROPERTY



735 Truman Parkway Residential Project

EXHIBIT 5 – VIEWS OF CONTEXTUAL NEIGHBORING SITES











EXHIBIT 6 – VIEWS OF CONTEXTUAL APARTMENT PROJECTS ON TRUMAN

690 Truman Parkway



605 Truman Parkway




EXHIBIT 7 – ELEVATIONS, FLOOR PLANS, AND ARCHITECTURAL SITE PLAN







No.	Revision Date		Drawing Name
Road Quincy, MA 02171 fax 617-786-7715	3-10-2017	Project No:16258Scale:AS NOTEDDate:02-22-2017Drawn By:SL	COVER SHEET

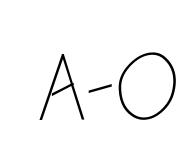

CODE ANALYSIS

Applicable Codes:

IBC 2009 w/ MA Amend (780 CMR)/ IEBC 2009 Existing Building Code City of Boston Zoning Code

527 CMR MA Fire Prevention Regulations

521 CMR MA Architectural Access Board

248 CMR MA Gas & Plumbing Code

524 CMR MA Elevator Code (2004 ASME A17.1) IEEC 2015 & MA 780 CMR 115.AA Stretch Energy Code

Occupancy Classification:		
Existing	Proposed	
I-2 Nursing Home	R-2 Multifamily	

Construction Type:			
Building Level	Existing	Proposed	Notes
1st Floor	2B	2B	
Upper Floors	2B	2B	

Building Height & Area Limitations (780 CMR Chapter 5)			
Code Citation	Construction Type 2B		
code citation	Height	Area	Notes
Table 503	4	16000 SF	
Section 504.2 Sprinkler Height Increase	Additional 1 story and 20'		
Section 506.3 Sprinkler Area Increase		Additional 200% Add 32,000 SF	
Section 506.2 Frontage Area Increase		NA	
Section 506.1 Total Area Increase		Aa=At+(At x If)+(At x Is) 12000+(0)+(1600 0x2)=	
Total Allowed	5	48000 s.f. PER FL	
Actual Proposed	3	Maxfloor = 1765 s.f. PER	

Building Areas:			
Building Level	FAR GSF	Total GSF	Notes
1st Floor	15265	17644	
2nd Floor	17570	17644	
3rd Floor	17042	17116	
Roof Level	0	0	
	49877	52404	
Sprinkler Requirements: (780 CMR Chapter 9)			

System Type & Use		Proposed	Notes
	THROUGHOUT	NFPA 13R	

ccupant Loa	d: (780 CMR Tak	ole 1004.1.1 or	Actual)					
Floor	Occupant Type	Floor Area	Floor Area Per Occupant	Total Occupant	Means of Egress: Exit Travel Distance (Table 1		L016.1)	
	.,,,,,,,,,,,,,,,,,,,,,,,,,,,,,,,,,,,,,,			Load	Occupancy	w/o Sprinkler	W/ Sprinkler	Notes
1st Floor	1st Garage/trash/ Bike/Mech	2379	300	8	Residential	NA	250'	
	Residential	15265	200	76				
1st Floor					Means of Egre	ess: Exit Width		
2nd Floor	Residential	17570	200	88	Occupancy	Corridors/ Stairs	Doors	Notes
3rd Floor	Residential	17042	200	85	Required	44	36	
	1			TOTAL	Proposed	48	36	
				257	1			

Notes

Means of Egress: Number of Exits (1021.1)(1021.2)					
Building Level	Occupant Load	Required Exits	Proposed Exits	N	
1st Floor	84	2	3		
2nd Floor	88	2	3		
3rd Floor	85	2	3		
Roof Level					





Means of Egress:	Width	(Section	1005)
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Building Level	Occupant Load	Limiting Width Factor	Egress Element Width	Egress Element Occupant Allowance
1st Floor	84	Door (.2" per)	16.8/ 5.6" PER EXIT	36" PER EXIT
2nd Floor	88	Door (.2" per)	17.6/ 5.9" PER EXIT	36" PER EXIT
3rd Floor	85	Door (.2" per)	17/ 5.7" PER EXIT	36" PER EXIT
Roof Level				


1. Minimum egress width requirement .3 "perperson for stairs & .2 "perperson for doors? hallways 2. With installed sprinklers and VOICE alarm (903.3.1.1 or 903.3.1.2 & 907.5.2.2).2* per person for stairs & .15* per

person for doors? hallways **Voice alarm not required in existing buildings as per 1005.1 MAA mend. Exception 3

Means of Egress: General Not

Exit Doors Serving	; 50+ People Must
Max Exit Access Ti	ravel Distance: 10
R,	250' (with
Common Path of E	gress Travel: 1014
R-2	125' (wi

Width 44"	
Headroom	(80")
Min Tread	Depth 11"
Max Riser	Height 7"
Continuou	s Handrails Both Sides
Handrail H	leight 34-38" Max 4.5" projection into width
Handrail p	rojection 12" at top of stair & 12" + tread depth at bottom
Guardrails	42" min high/ Max 4" opening limitation
Means of	Egress: Ramp Notes
Slope grea	ter than 1/20 Requires Railings
Min 48" cle	ear between railings
1/12 Max s	lope
Maxslope	run 30'
Continuou	s Handrails Both Sides
Upper Han	drail Height 34-38" Lower Rail Height 18-20"
Handrail E	xtension 12" at Top & Bottom
Max Cross	Slope to be 1/50 (2%)
Guardrails	42" min high/ Max 4" opening limitation
Clearance	Between Wall and Railing 1.5"
Edge Curbs	(2" min) to be provided at all drop offs
Landings s	hall minimally be 60" or 60" X 60" for change of direction
Handrail C	ross section to be round or oval and be 1-1/4 to 2" max
	mps Are not Allowed

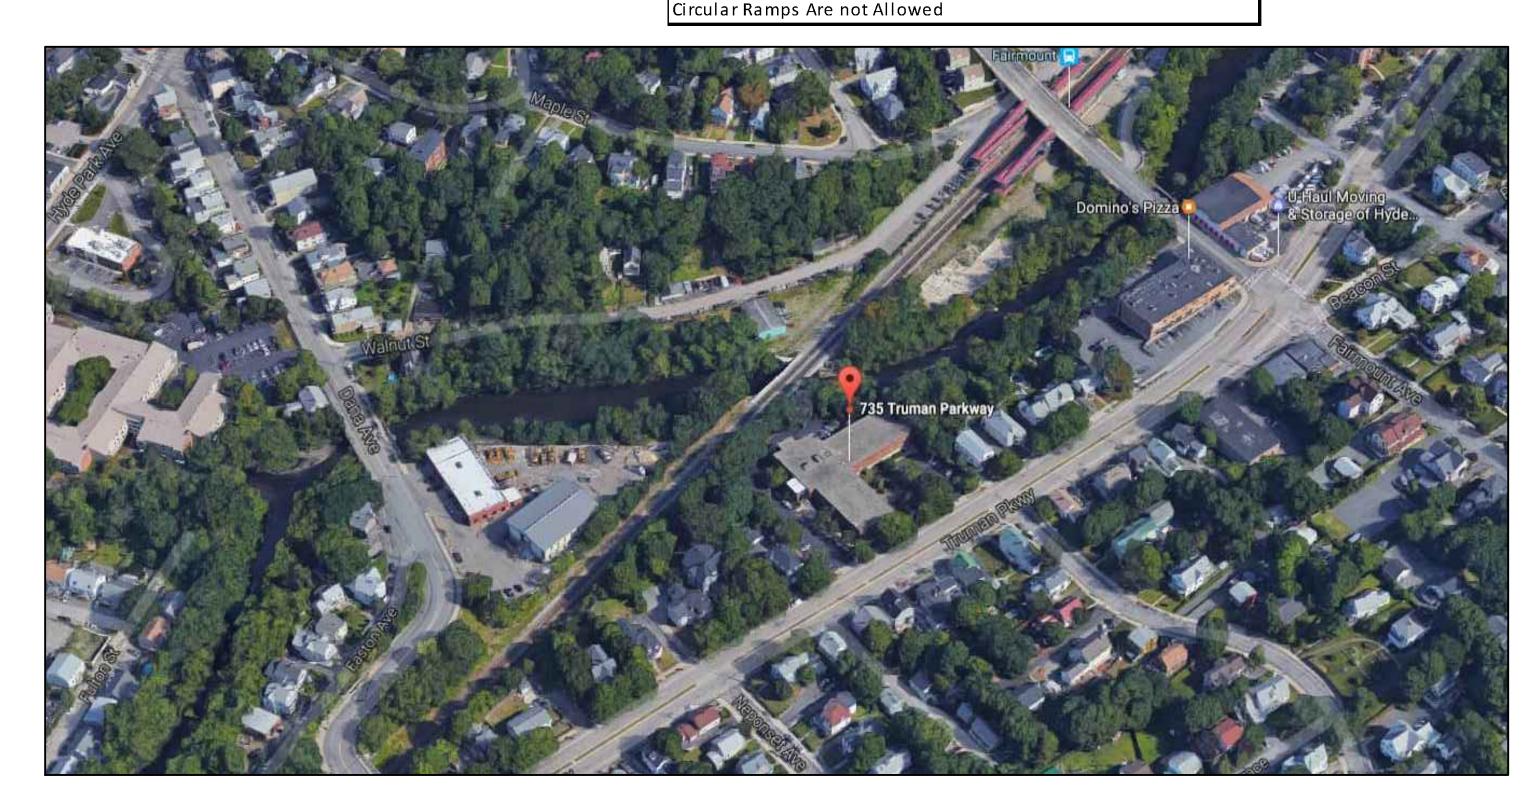



tes
st Swing in the Direction of Travel.
1016.1
th Sprinkler)
14.3
vith Sprinkler)

Structural Fire Resistant Ratings (780 CMR Chapter 6)

Building	Construction Type 2B				
Element	А	В	Notes		
Structural Frame	0				
Bearing Walls Exterior	0				
Bearing Walls Interior	0				
Non Bearing Walls Exterior	0/ 1 @ 10' to prop line				
Non Bearing Walls Interior	0				
Floor	0				
Roof Construction	0				

Interior Fire Resistant Ratings

	Construction Type 2B				
Building Element	Wall Type	Fire Resistant Rating	Opening Ratings		
Fire Wall	Fire Wall	na	na		
Stair Shaft 4 Stories Plus 708.4	Fire Barrier	2 hr	90 min		
Stair Shaft Less Than 4 Stories 708.4	Fire Barrier	1 hr	45 min		
Other Shafts 4 Stories Plus 708.4	Fire Barrier	2 hr	90 min		
Other Shafts Less Than 4 Stories 708.4	Fire Barrier	1 hr	45 min		
Dwelling Unit Separation Walls 709.3	Fire Partition	1 hr	na		
Dwelling Unit Separation Floors 712.3		1 hr	na		
Tenant Separations	Fire Partition	1 hr	45 min		
Common Area Dwelling Corridors 709.3	Fire Partition	30 min	20 min		
Separation of Incidental Accessory uses 508.2.5	Fire Barrier	1 hr	45 min		

Exterior Wall Fire Resistant Ratings (780 CMR 602)				
Fire Separation	Construction	Fire Resistant Wall Rating		
Distance	Туре		Use R	
< 5 feet	All		1	
>=5' to < 10'	1A Others		1	
>=10' to < 30'	1A, 1B 2B,5B Othe rs		1 0 1	
>=30'	All		0	

Exterior Wall Max Opening Area (780 Allowal Fire Separation Distance 0 to less than 3' 3 to less than 5' 5 to less than 10

10 to less than 15'

Accessibility Notes:
521 CMR 9 ADDRESSES THE REQUIREMENTS WITHIN DWELLING UNITS
521 CMR 10 ADDRESSES COMMON AREAS.
(521 CMR 9.2.2) AS A RENOVATION/ REUSE PROJECT, GROUP 2 UNITS ARE REQUIRED FOR 5% OF THE UNITS (3 TOTAL FOR 46 UNITS). GROUP
GROUP 2A UNITS ARE NOT REQUIRED UNDER 20 UNITS.
(521 CMR 10.5) IF REMOTE STORAGE IS PROVIDED TO RESIDENTS THEN ACCESSIBLE STORAGE MUST BE AVAILABLE.
(521 CMR 10.1) ALL PUBLIC AND COMMON AREAS MUST BE ACCESSIBLE INCLUDING STORAGE ROOMS, TRASH ROOMS AND ETC
(521 CMR 23.2.1) 3 ACCESIBLE PARKING SPACES ARE REQUIRED. 1 SHAL BE VAN ACCESSIBLE.

ZONING CODE ANALYSIS

Governing Article: 69 HYDE PARK Subdistrict: 1F-6000

Use Regulations: Section Table			
Existing	Proposed		
Nursing or convalescent home			
EXISTING NON CONFORMING	MULTIFAMILY / FORBIDDEN		

Dimensional Regulations: Table

A = A llowed F = Forbidden C = Conditional

	Code Re	equirement	Existing Condition	Proposed Project	Notes	
	Use 1	Any Other Use				
Lot Area Minimum		6000				
Min Lot Area for Additional Units		na				
Total Required Lot Size		6000	55,329	no change		
Min Required Lot Width and Frontage		60	240'	no change		
Max FAR		0.5	50700/55329 =.92	49805/55329= .9	Ex'g Non Conformance Reduced	
Max Building Height / Stories		2.5/35'	3	3	Ex'g Non Conformance	
Usable Open Space		1800+12333	na	607719 required	Table Cnote 325% increase for excess lotarea	
Min Front Yard		25	19.75'	no change	Ex'g Non Conformance	
Min Side Yard		10	2.5'	no change	Ex'g Non Conformance	
Min Rear Yard		40	27.25 at shallowest	no change	Ex'g Non Conformance	
Max Use of Rear Yard		25%	0%)%		

NDOD (BPDA Review Required)

GREENBELT PROTECTION (Article 29 Triggered by Substantial Renovation) PARKS REVIEW (Required per Article 29)

Other Non-Dimensional Zoning Issues: parking 2 spaces per unit required (92 Total) Existing 58 Parking spaces to remain excess of 14 added units and 20,000 s.f. requires small project review (BPDA Review Required)


3-10-2017 3-10-2017 Scale: AS NOTED Date: 02-22-2017 Drawn By: SL	ompany, Inc. s Road Quincy, MA 02171	No. Revision Date	2017		Date: 0	2-22-2017	_	
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	Sprinkled or						
	Protected						
	0%						
	15%						
	25%						
	45%						


Sheet No.

Violations Required Review by Other City Agencies

A-(

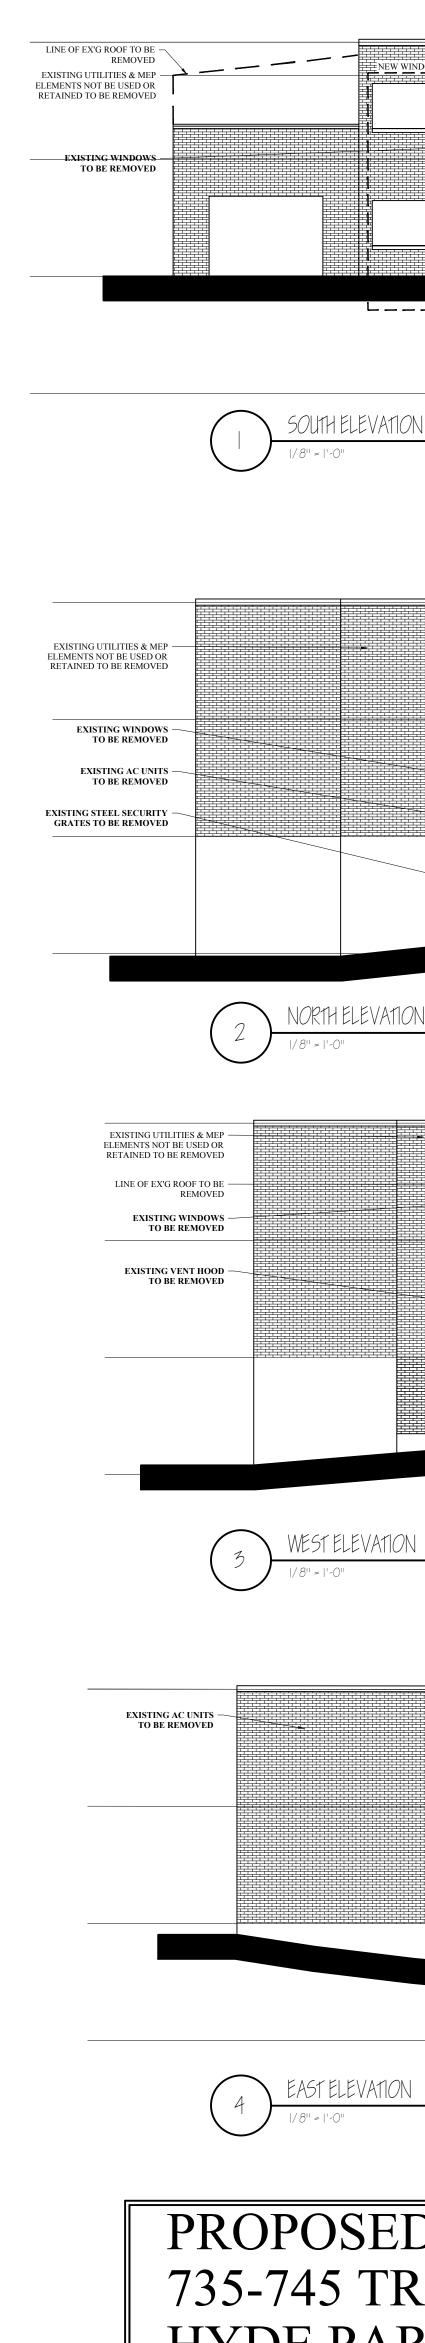


		INE OF ENGROOF TO BE REMOVED REAR PARAPET WALL TO BE REMOVED
ENLARGED WINDOW = ENLARGED WINDO	EXISTING RAMP AND STAIR TO BE REMOVED	

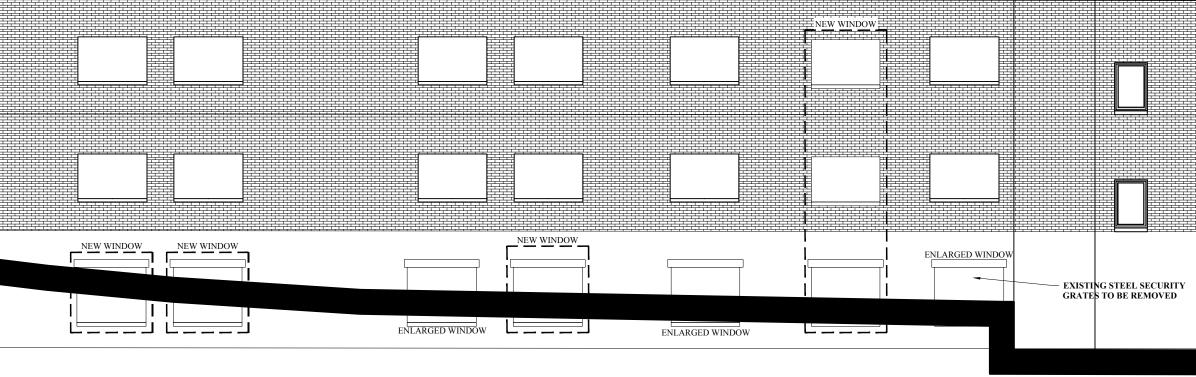




		EXISTING UTILITIES & MEP ELEMENTS NOT BE USED OR RETAINED TO BE REMOVED EXISTING WINDOWS
		 EXISTING WINDOWS TO BE REMOVED EXISTING VENTS TO BE REMOVED

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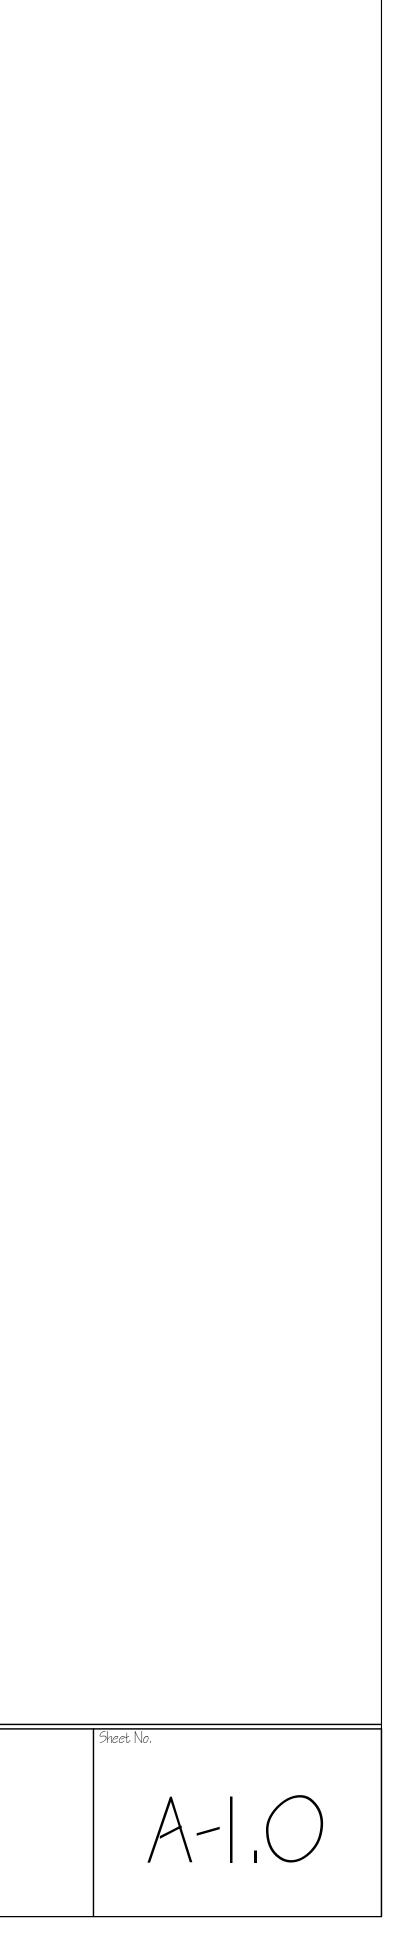


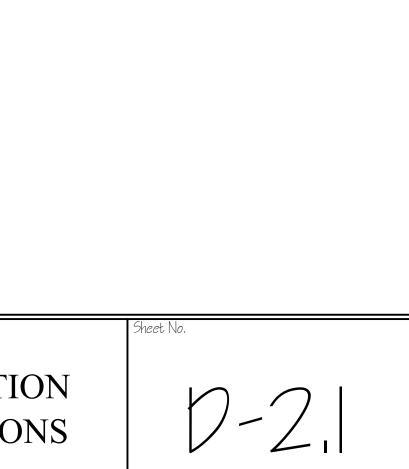


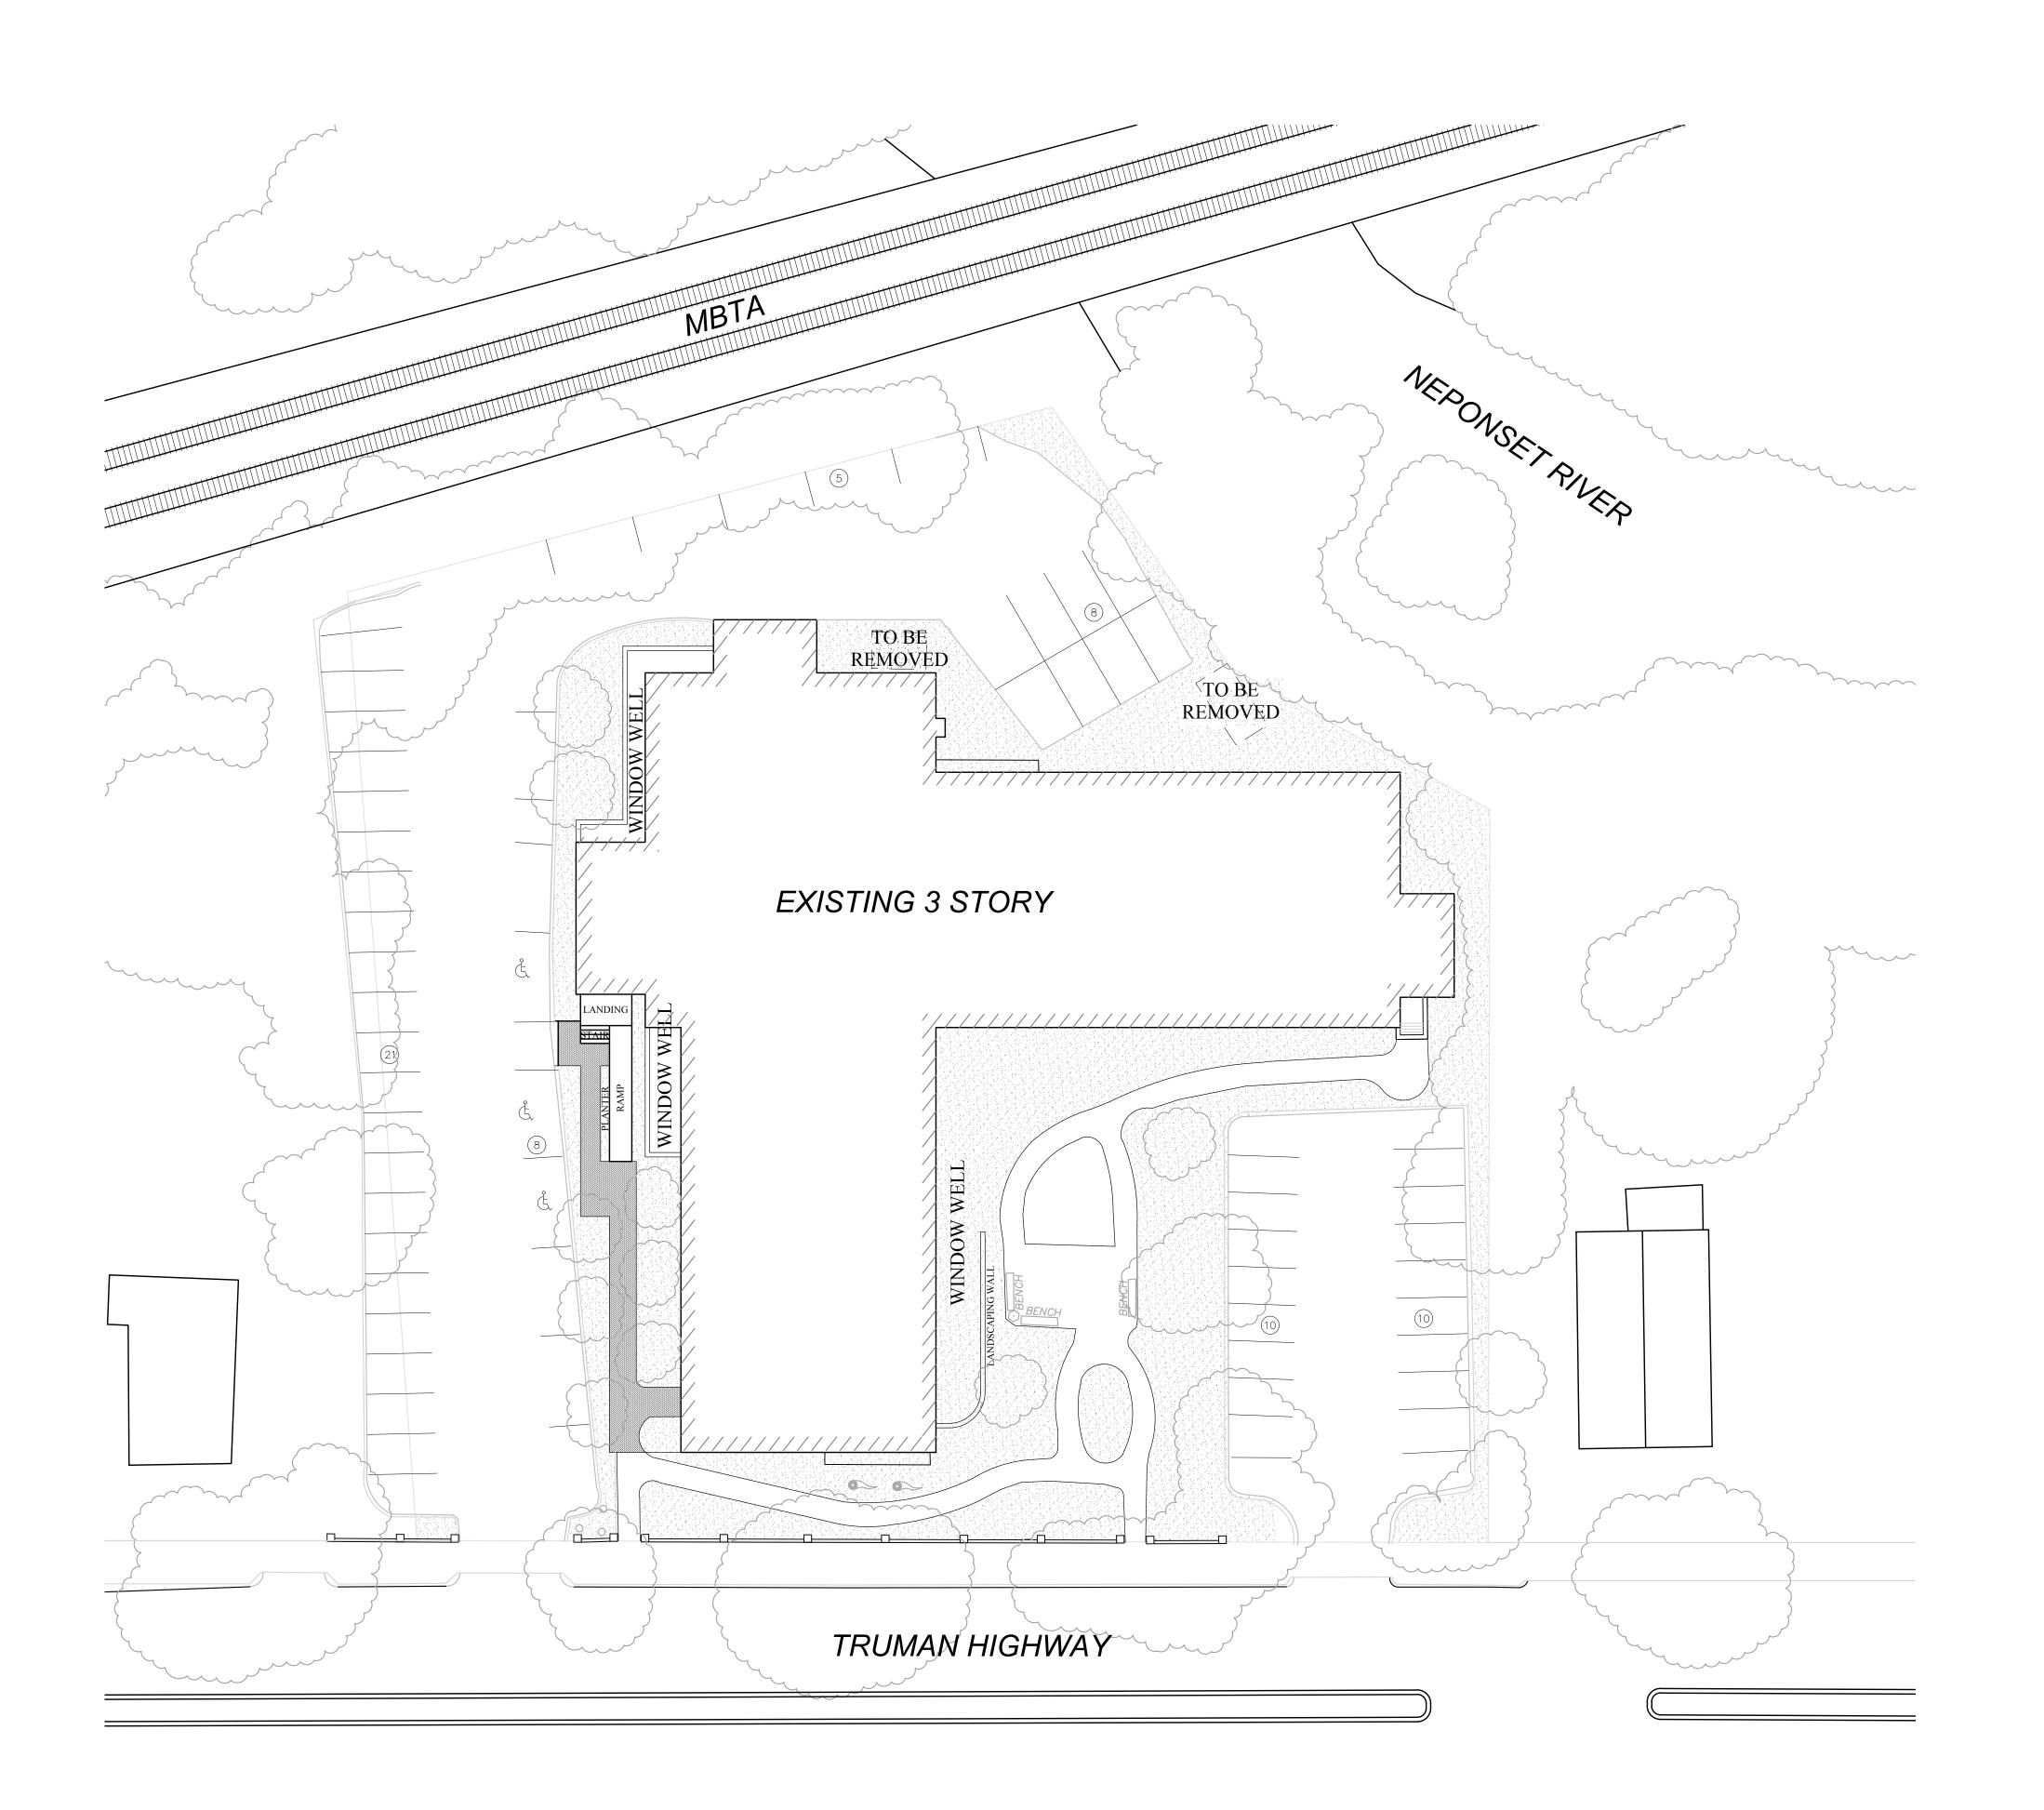



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OO Ompany, Inc. gs Road Quincy, MA 02171 27 fax 617-786-7715	Revision Date 3-10-2017	Project No: 16258 Scale: AS NOTED Date: 02-22-2017 Drawn By: SL	ARCH SITE PLAN




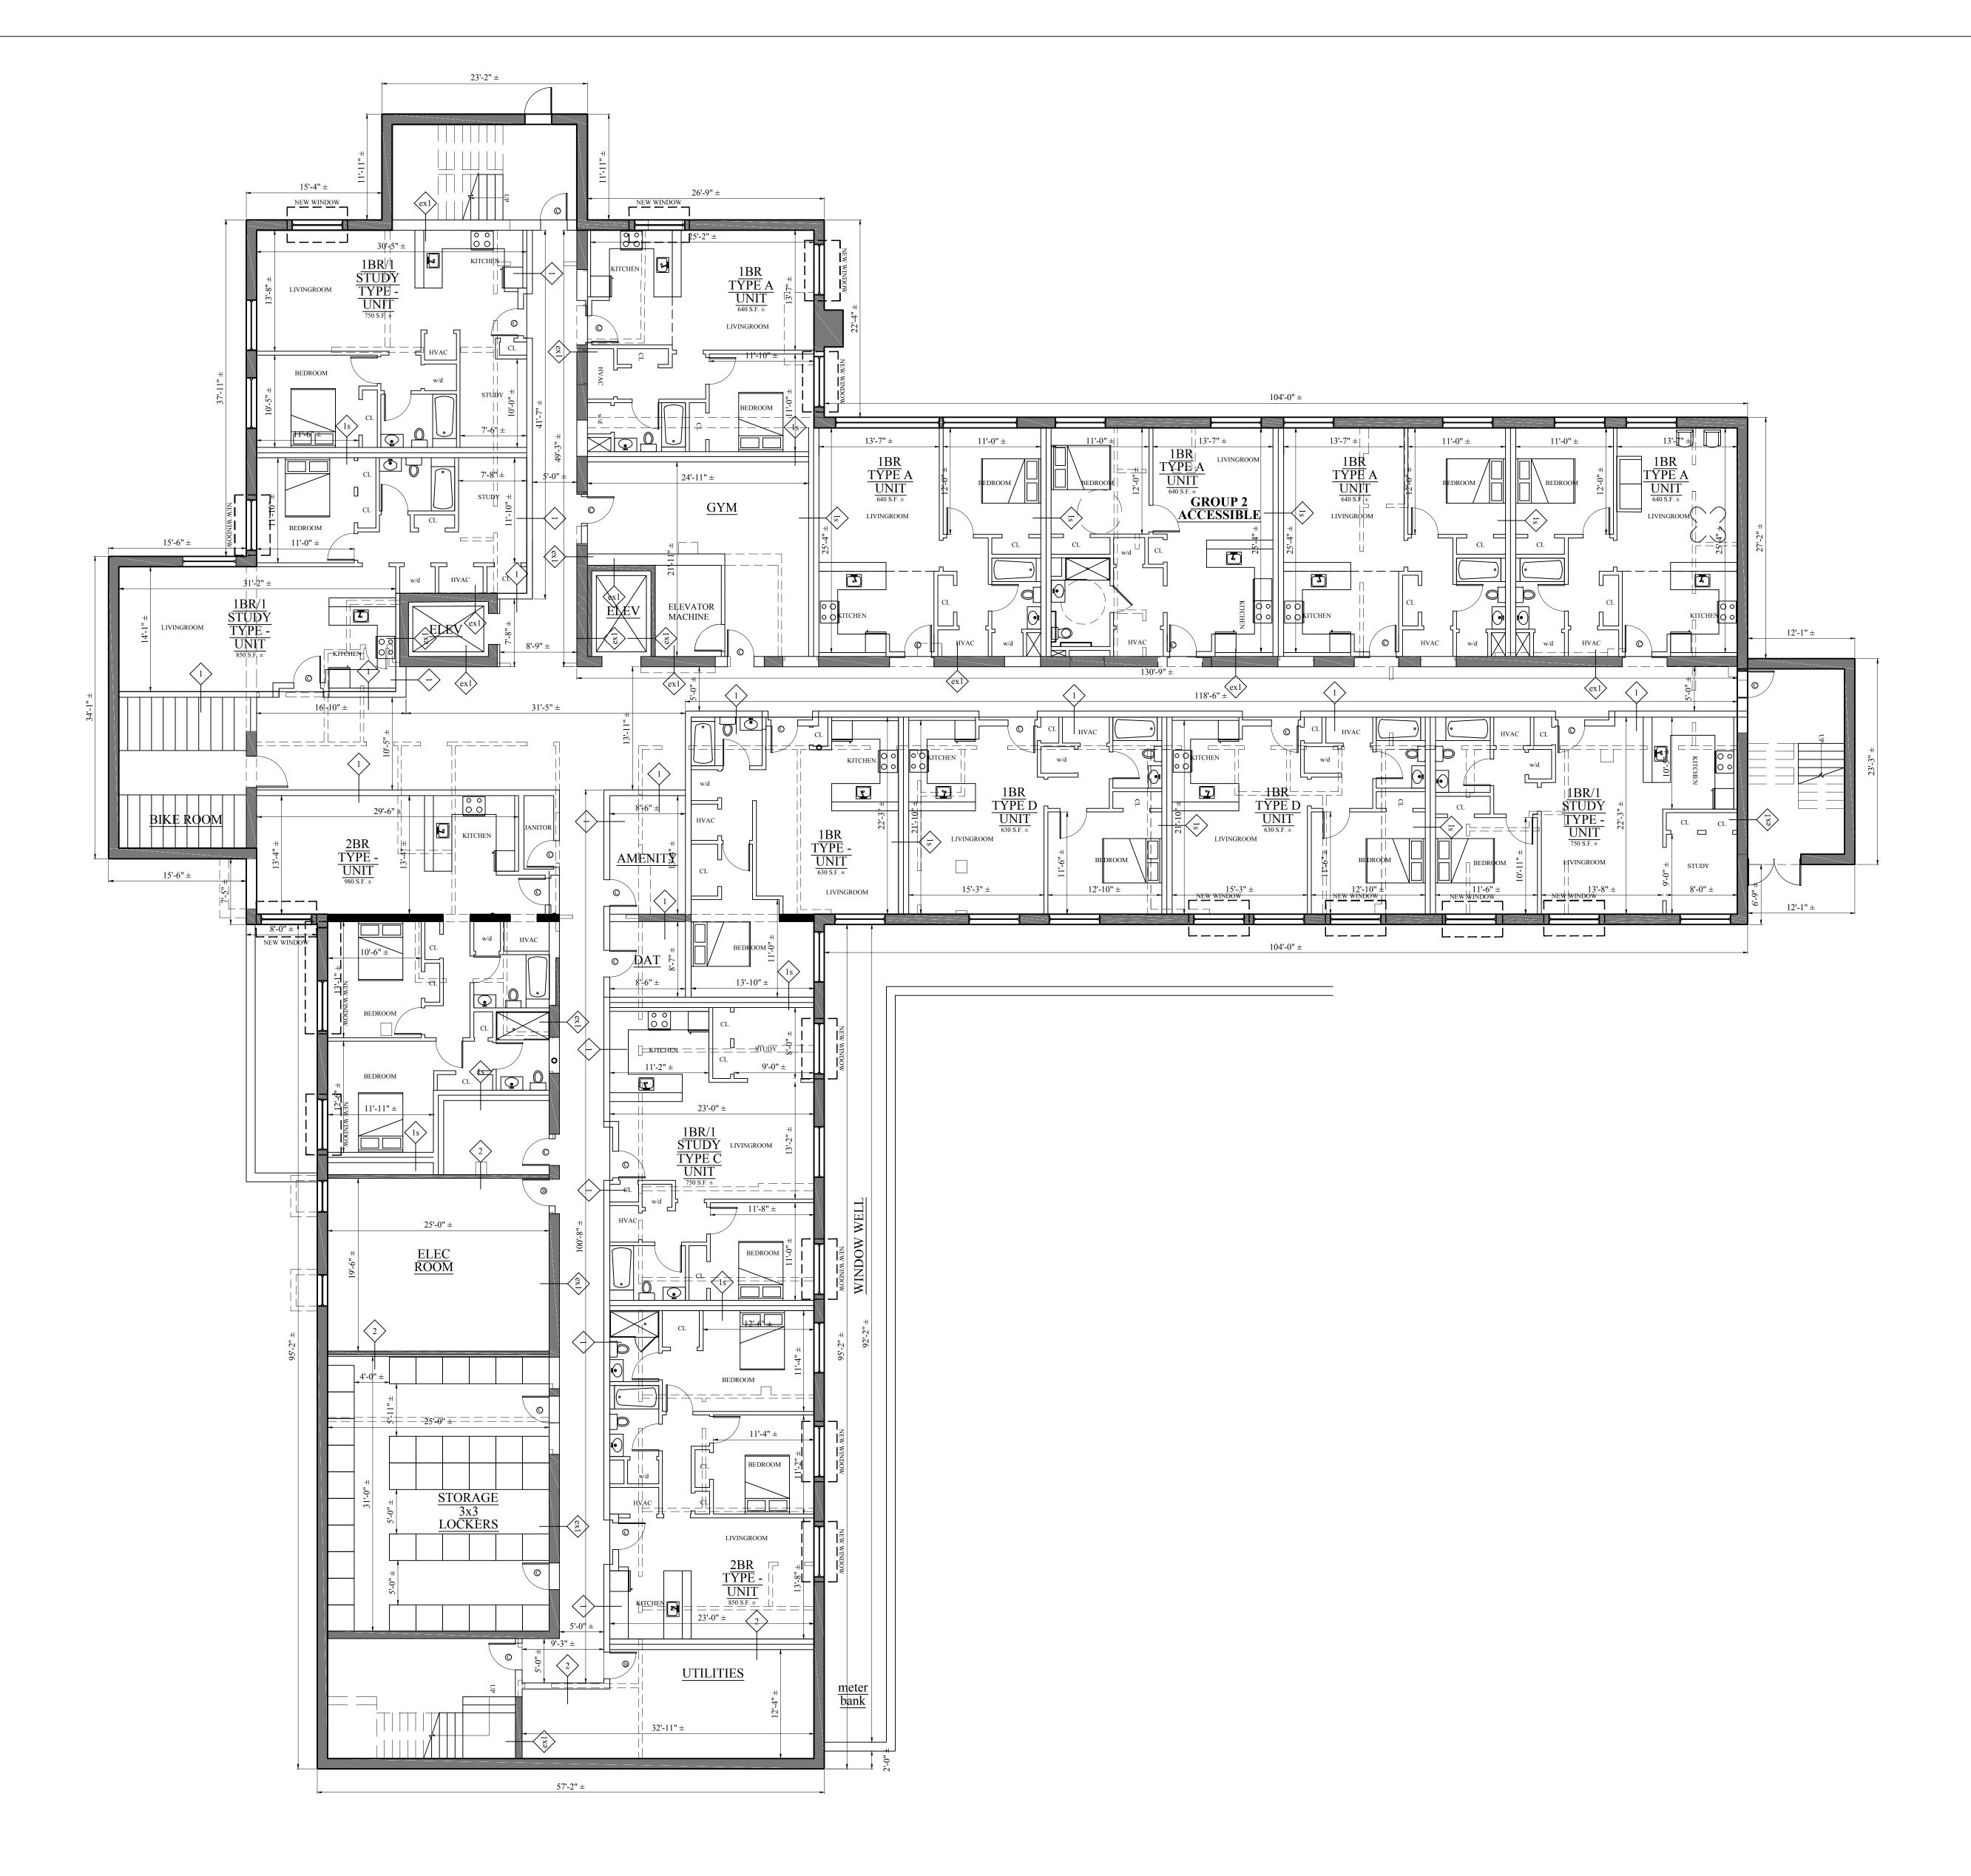







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Company, Inc. S Road Quincy, MA 02171 fax 617-786-7715	3-10-2017	Project No: 16258 Scale: 1/8"=1'-0" Date: 02-22-2017 Drawn By: SL	PROPOSED PLANS LOWER LE

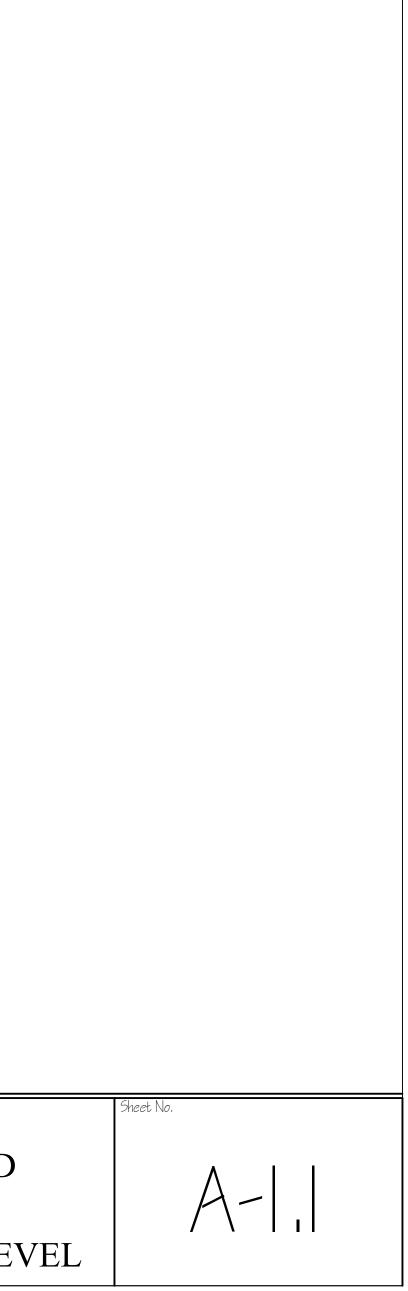


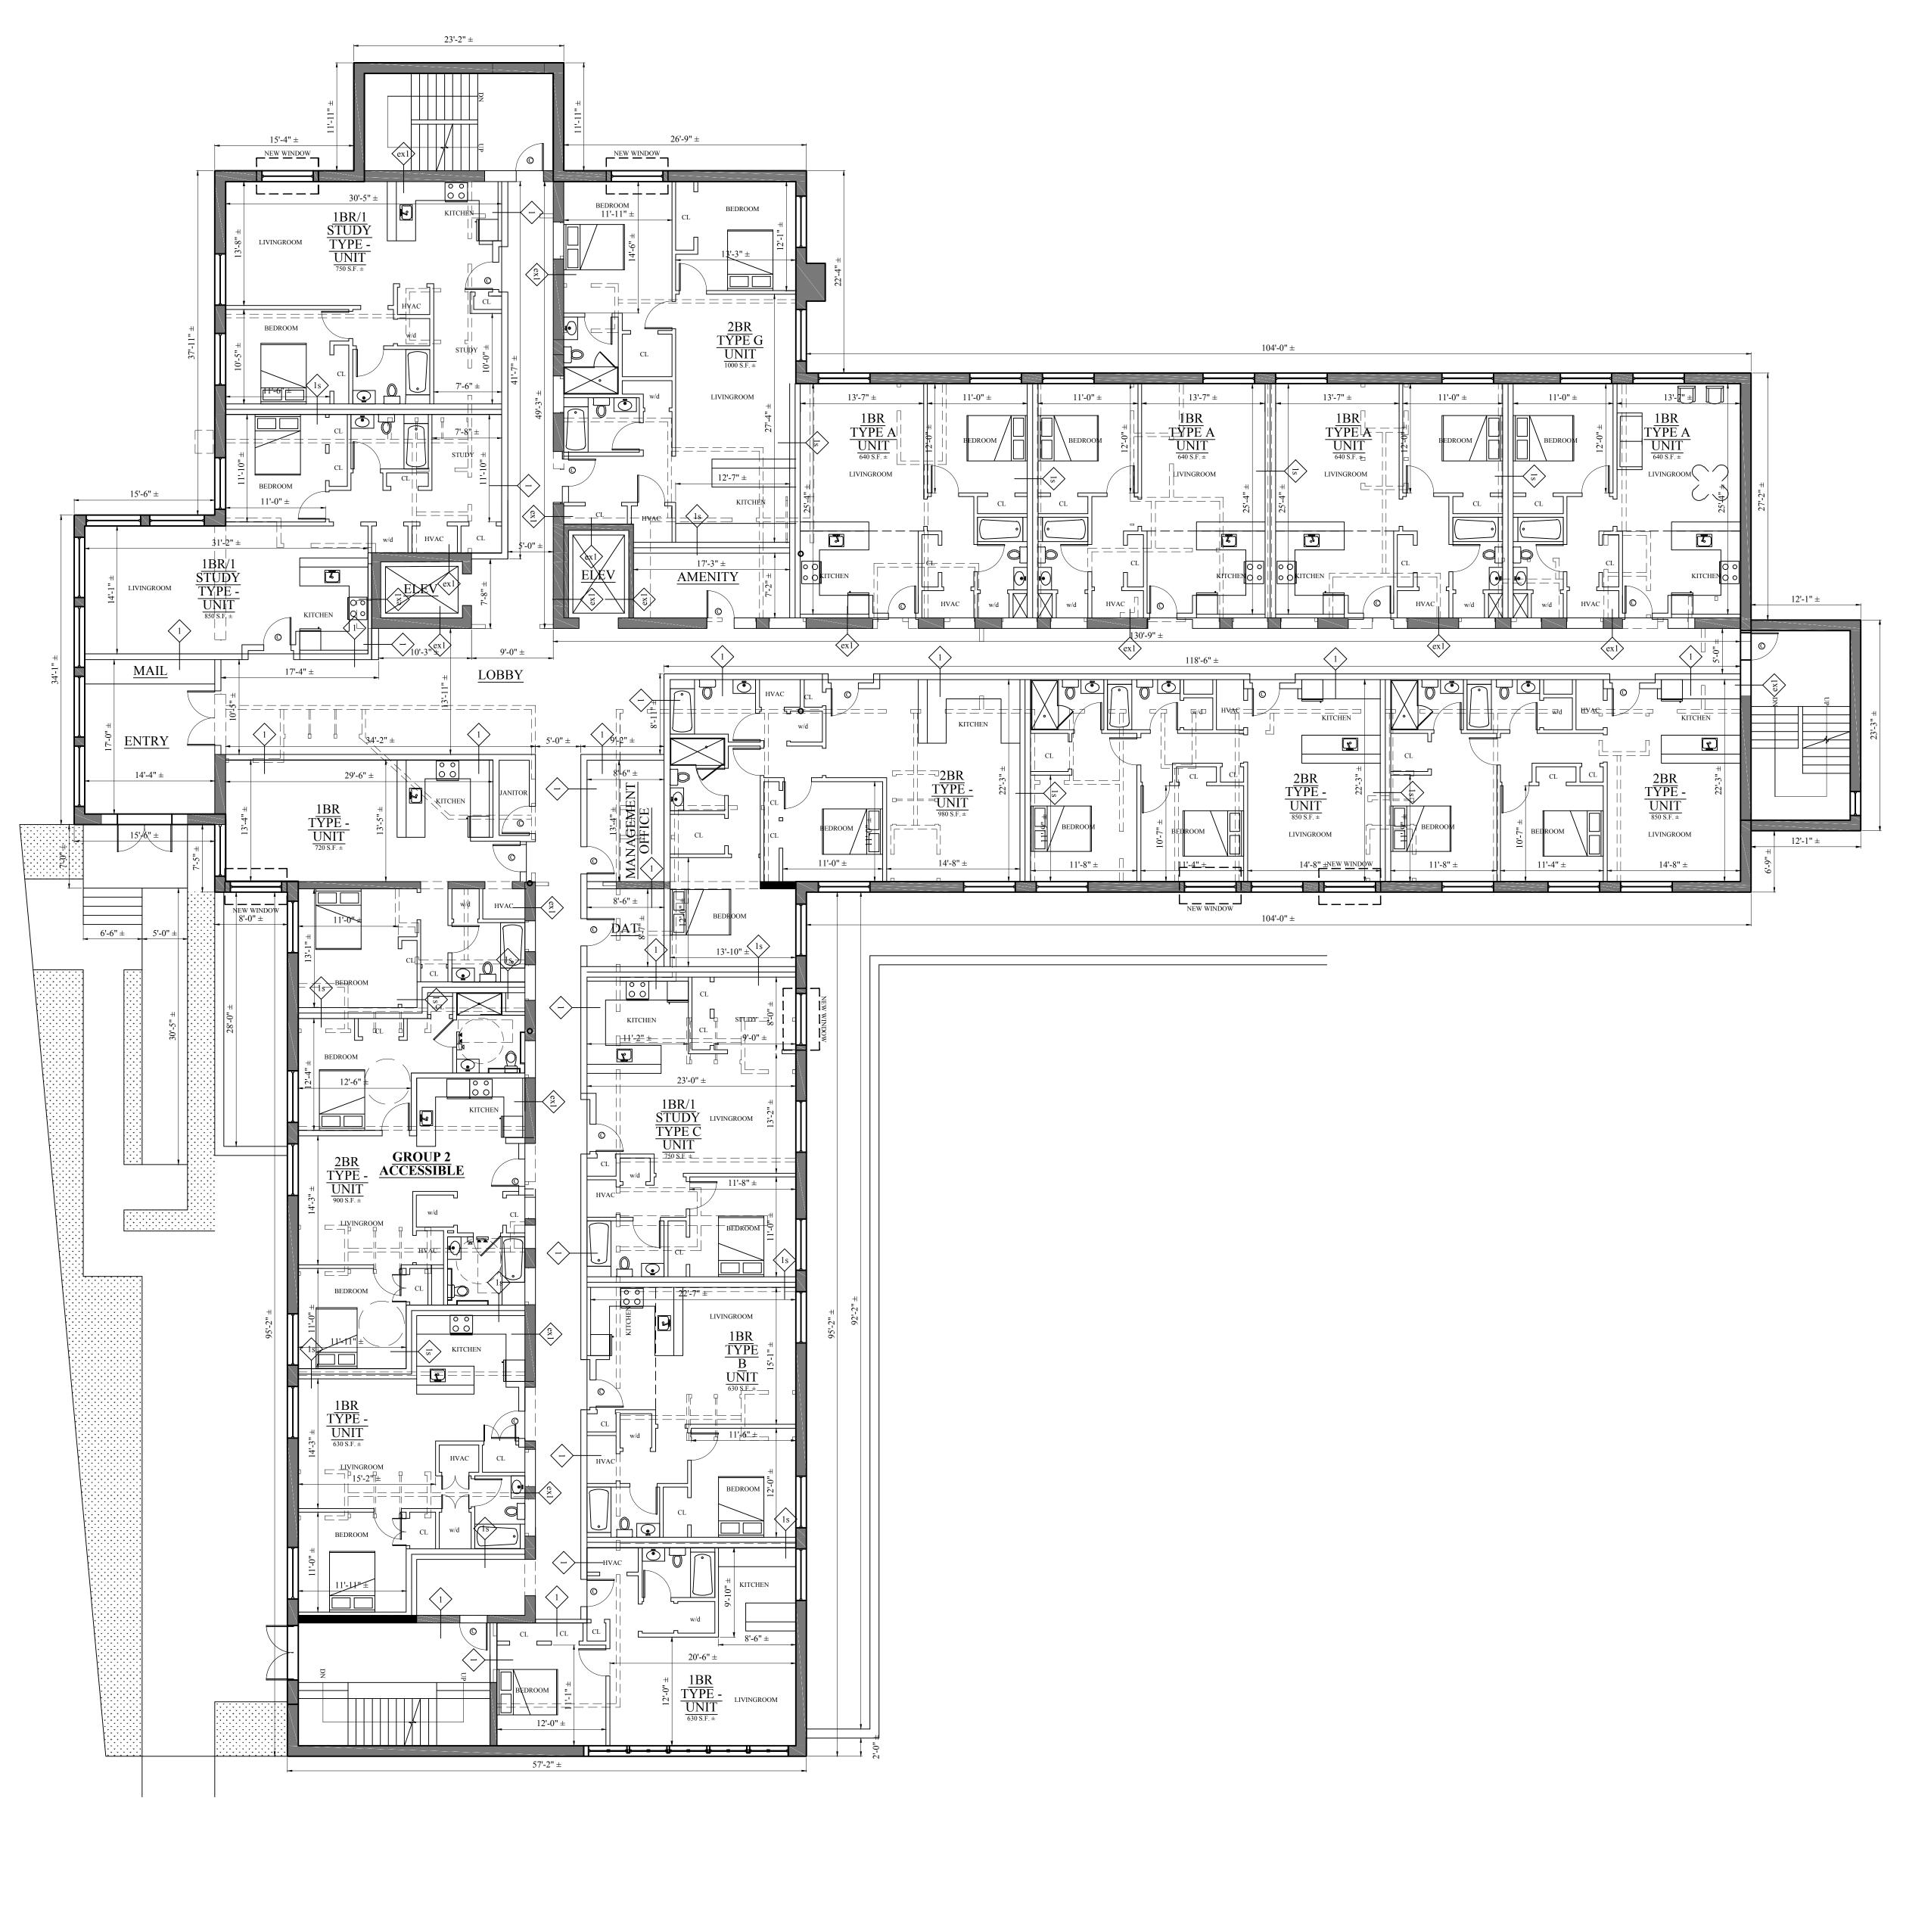



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Company, Inc. S Road Quincy, MA 02171 fax 617-786-7715	3-10-2017	Project No: 16 Scale: 1/8"=1 Date: 02-22-2 Drawn By: SI	2017 PLANS

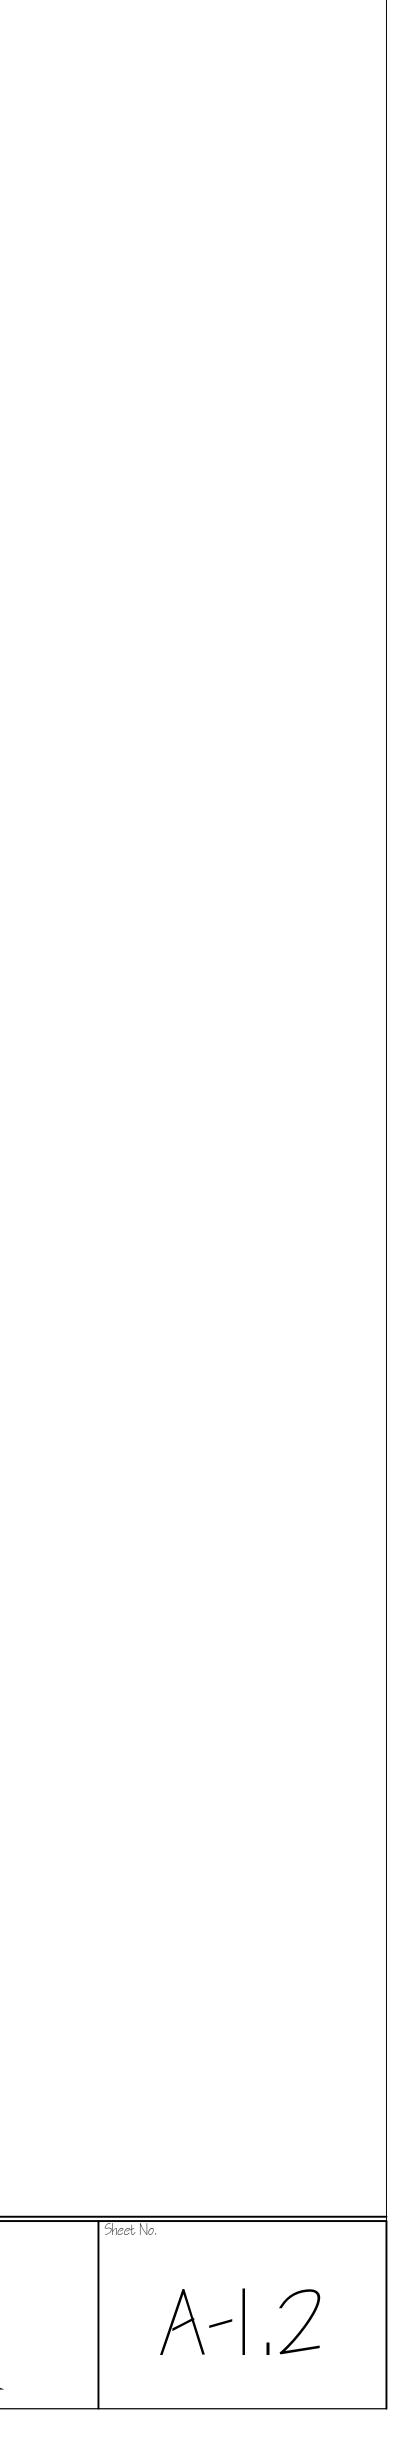


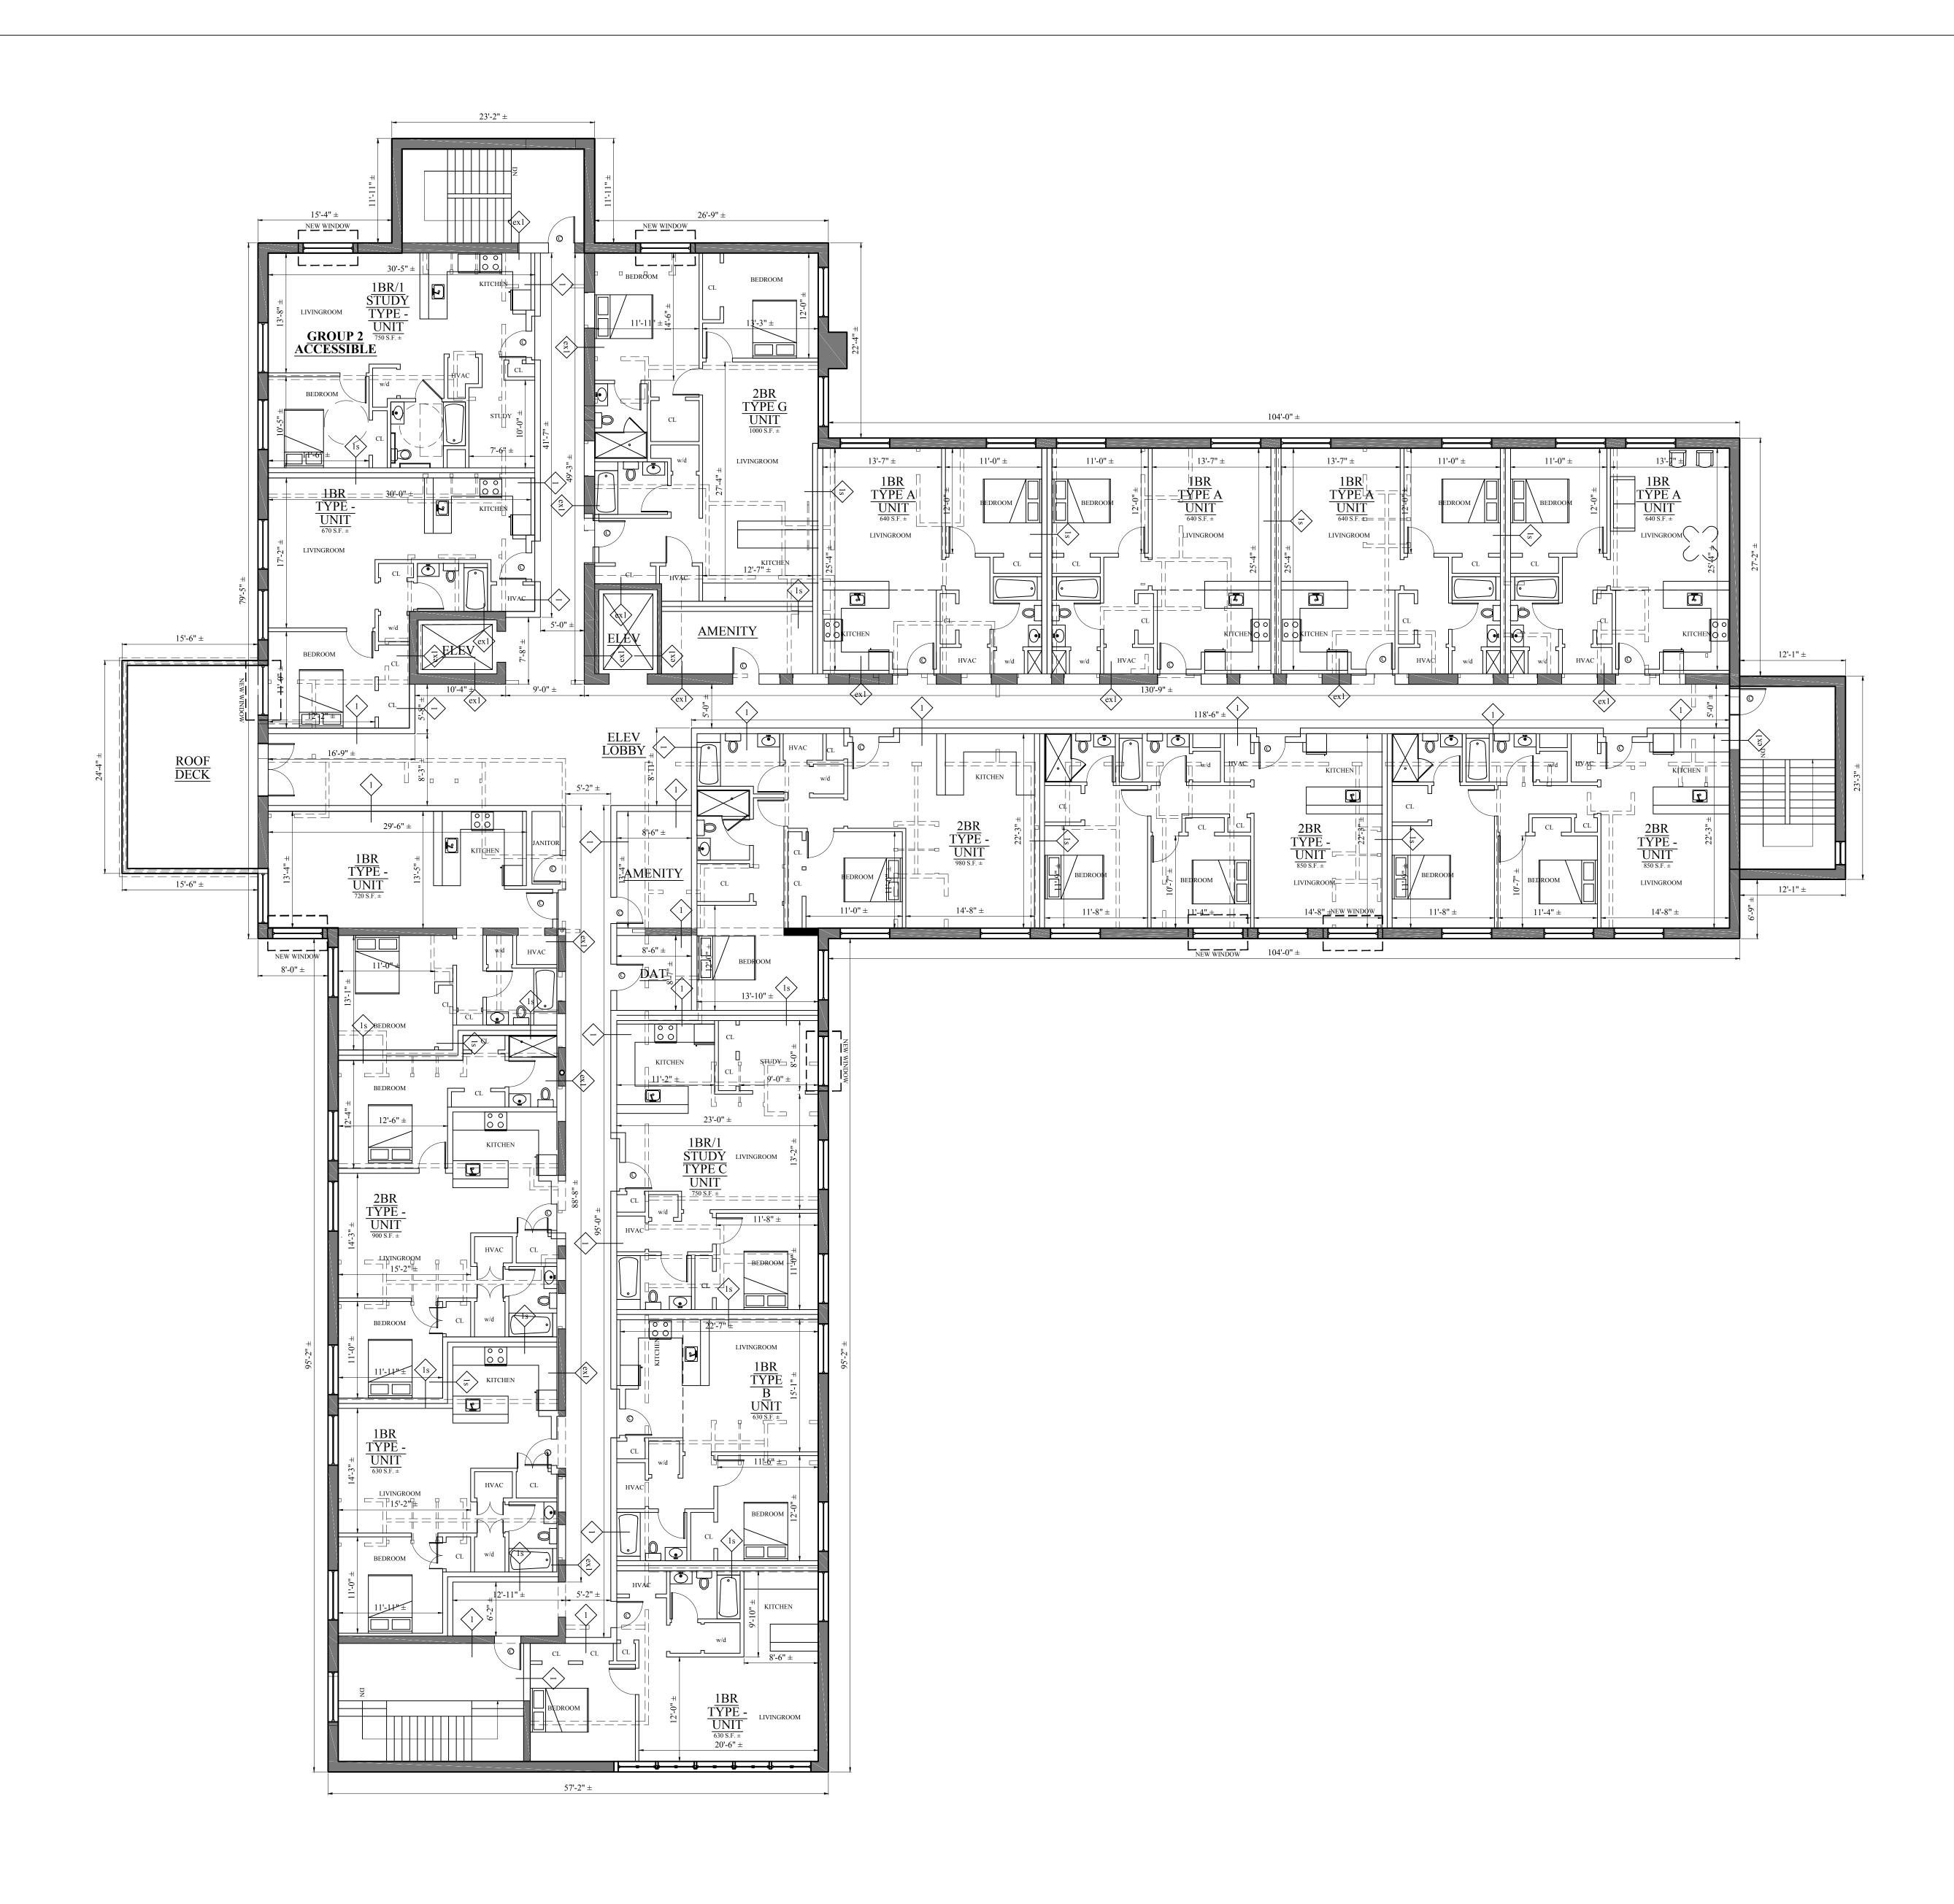









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Ompany, Inc. s Road Quincy, MA 02171 fax 617-786-7715	3-10-2017	Project No: 16258 Scale: 1/8"=1'-0" Date: 02-22-2017 Drawn By: SL	PROPOSED PLANS 2ND FLOOF

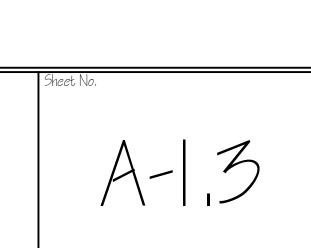

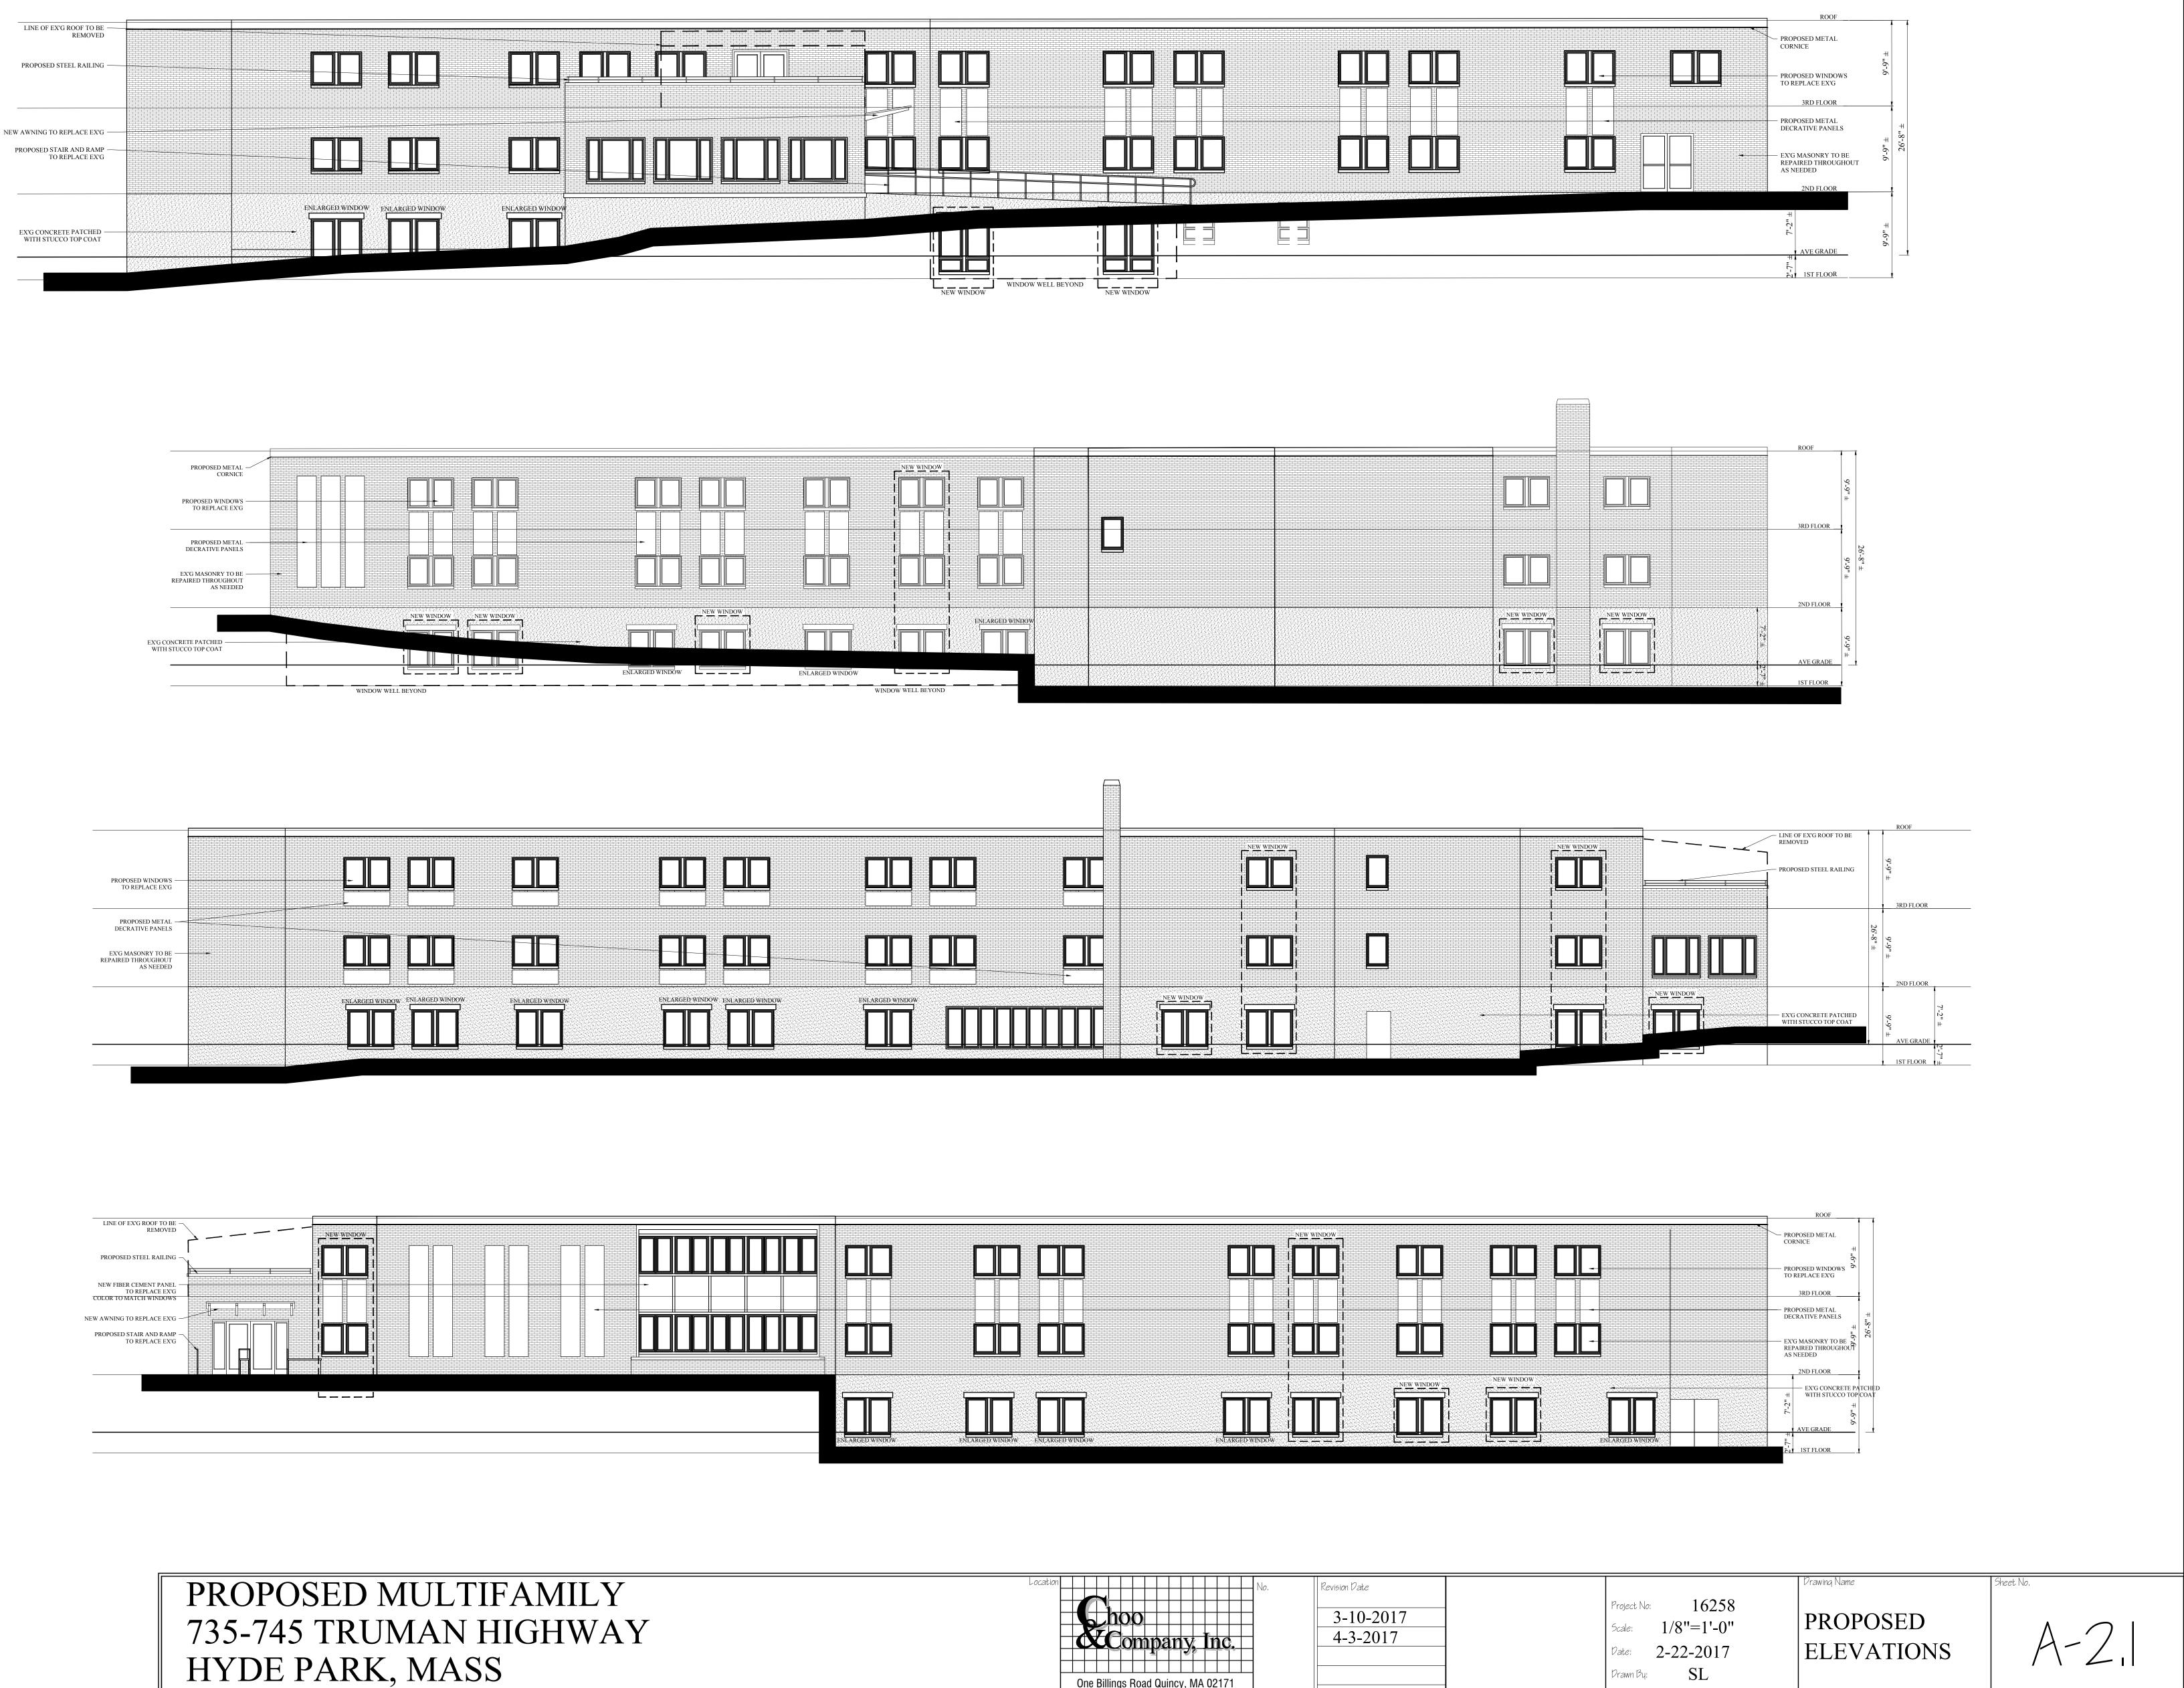

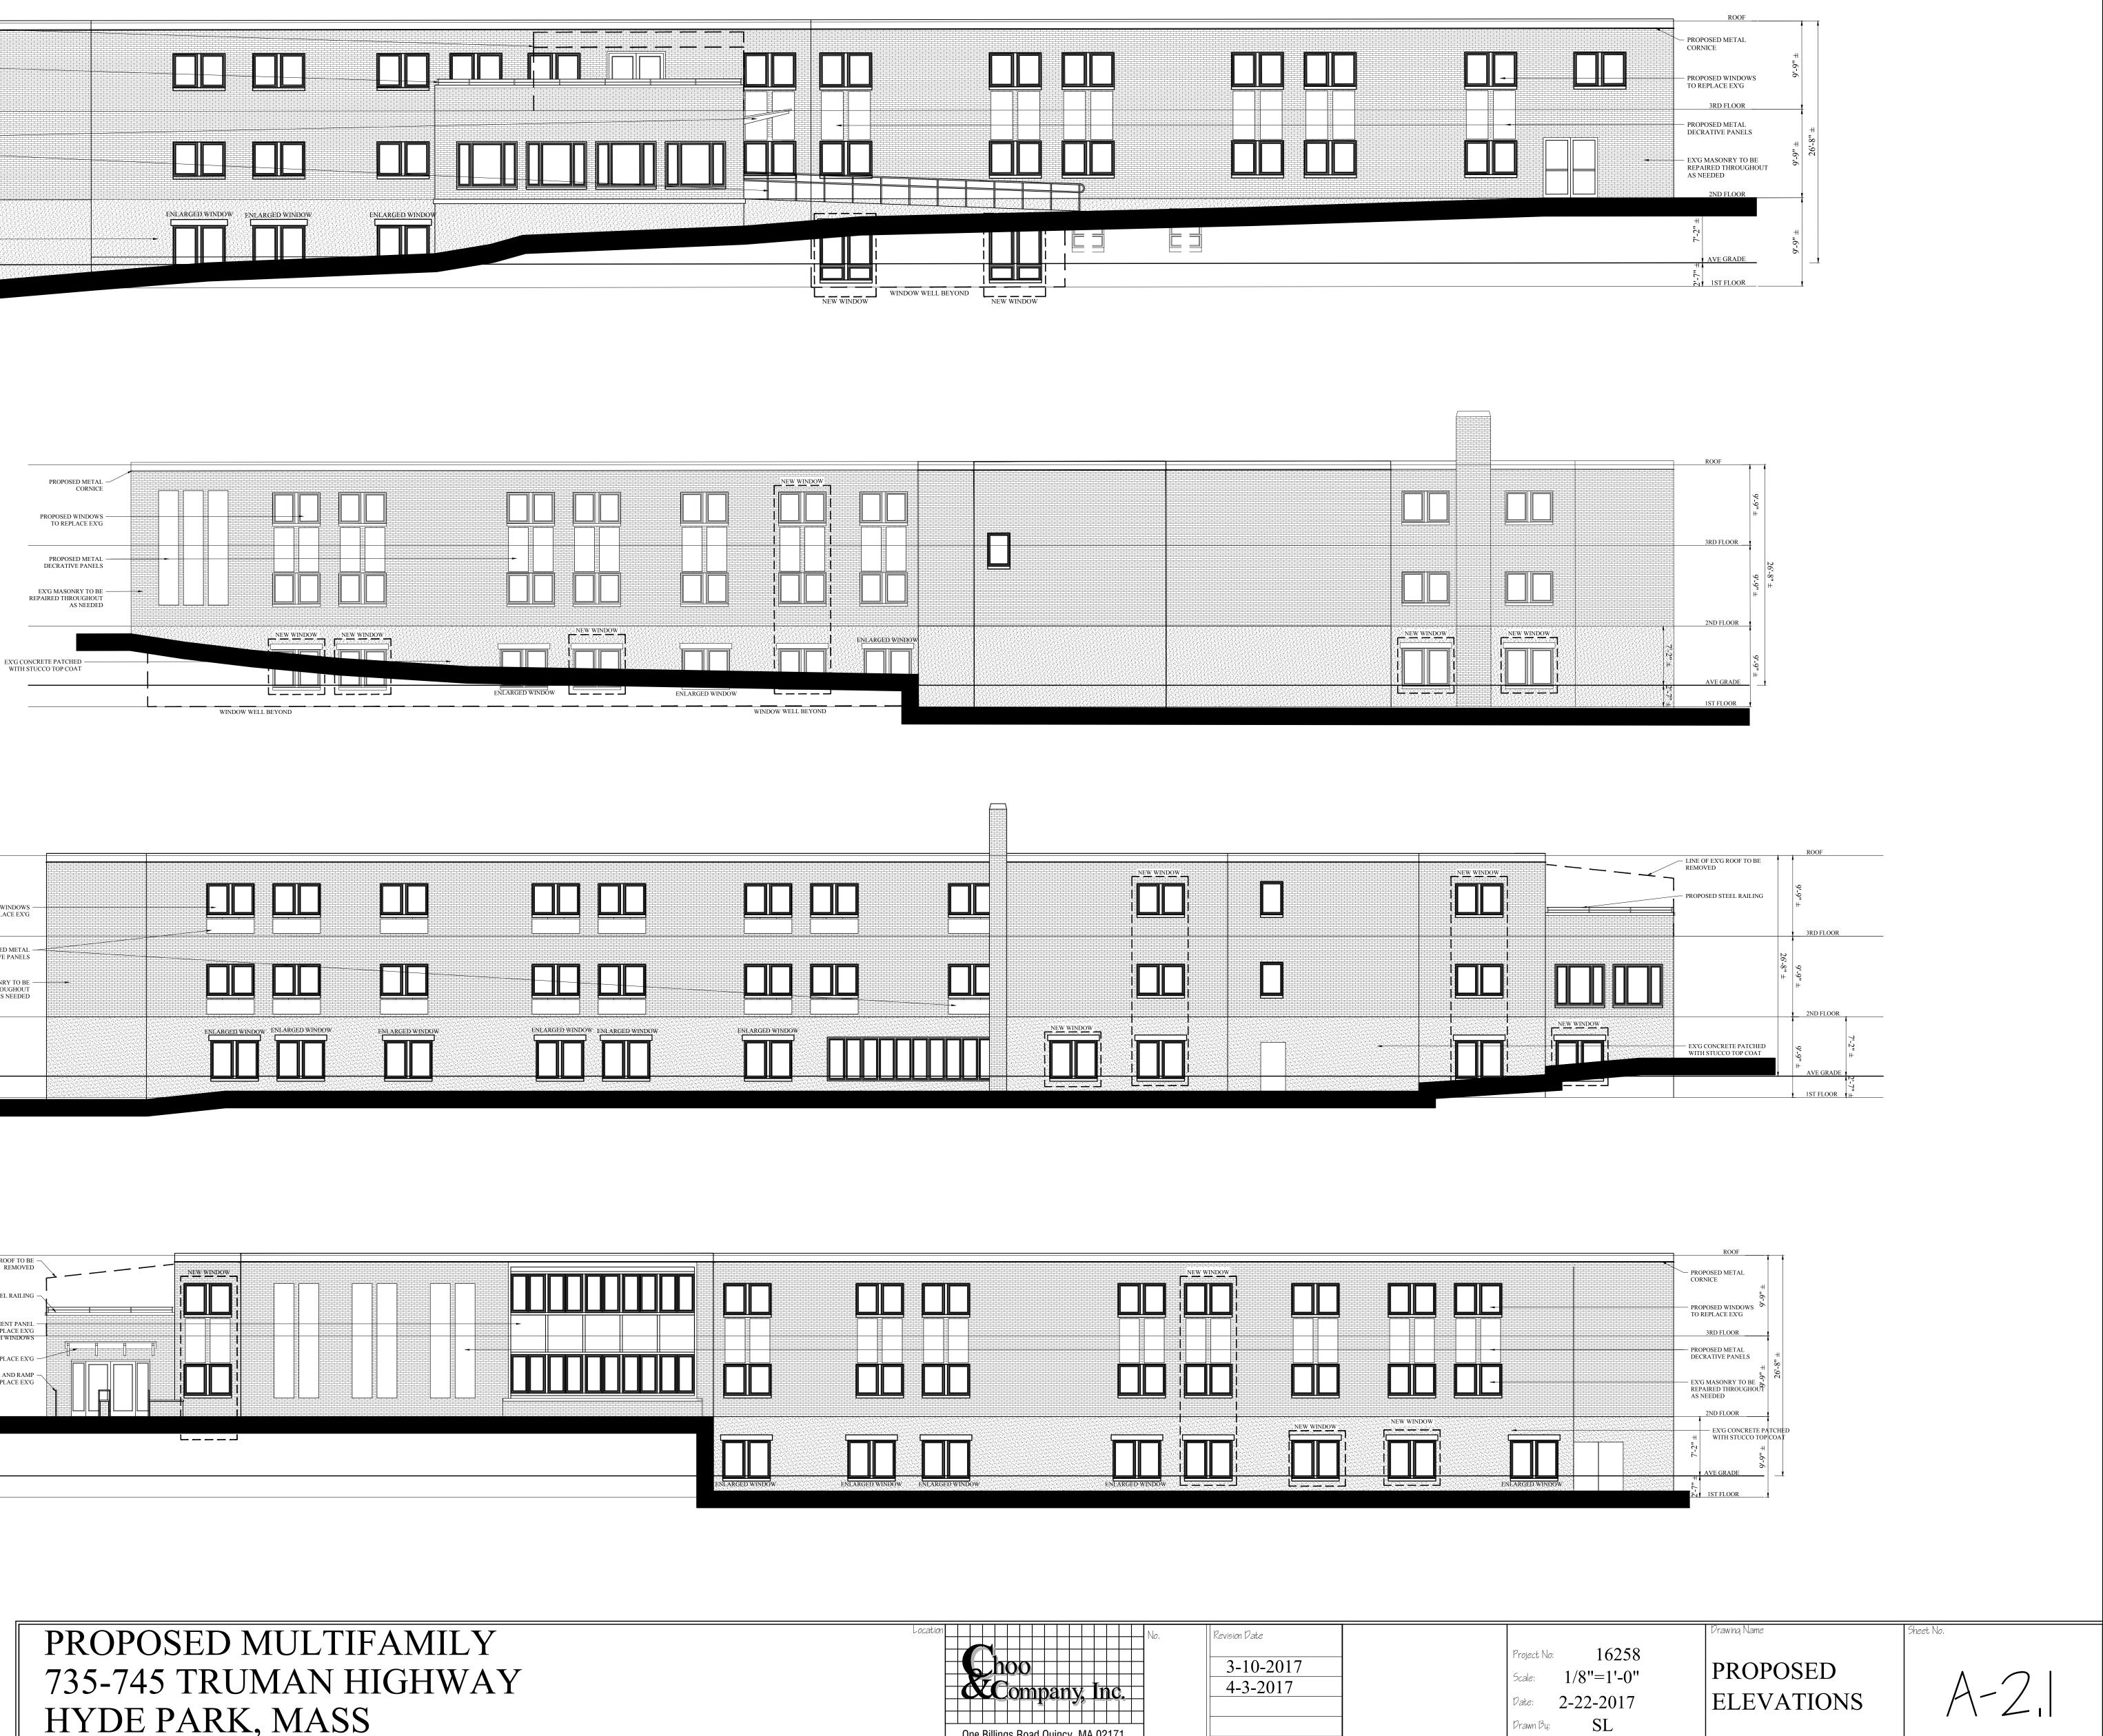

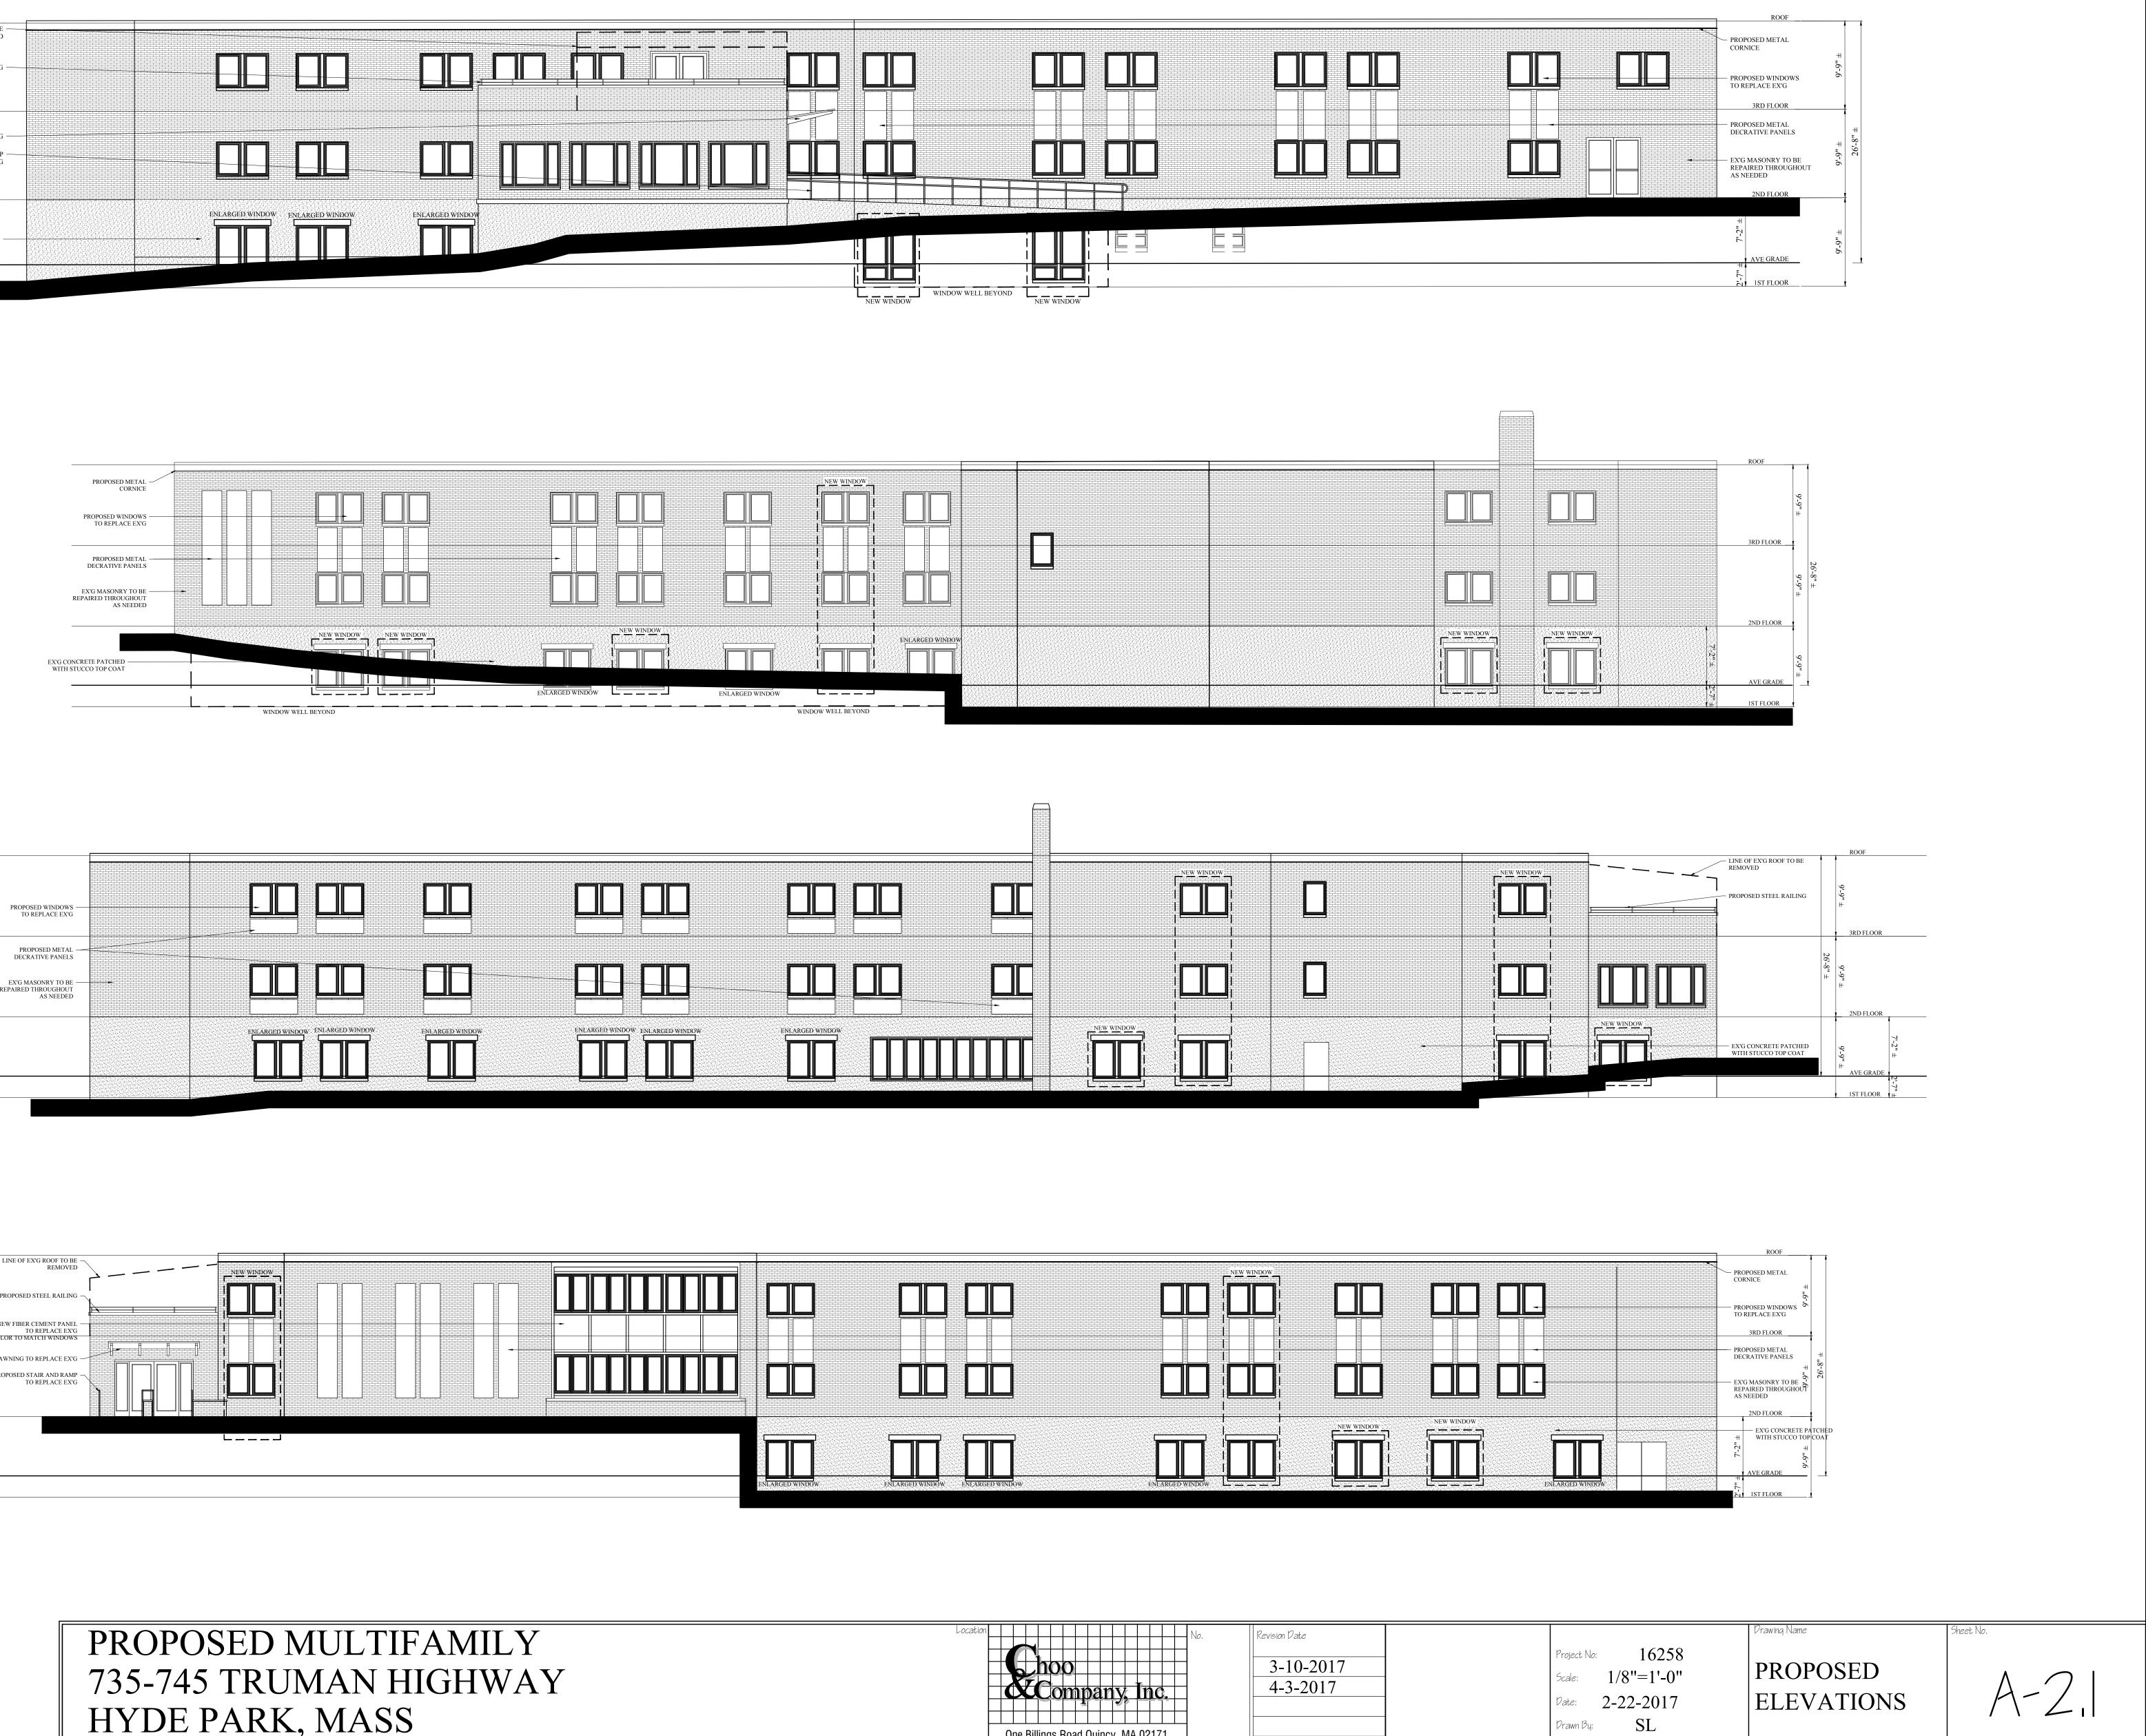

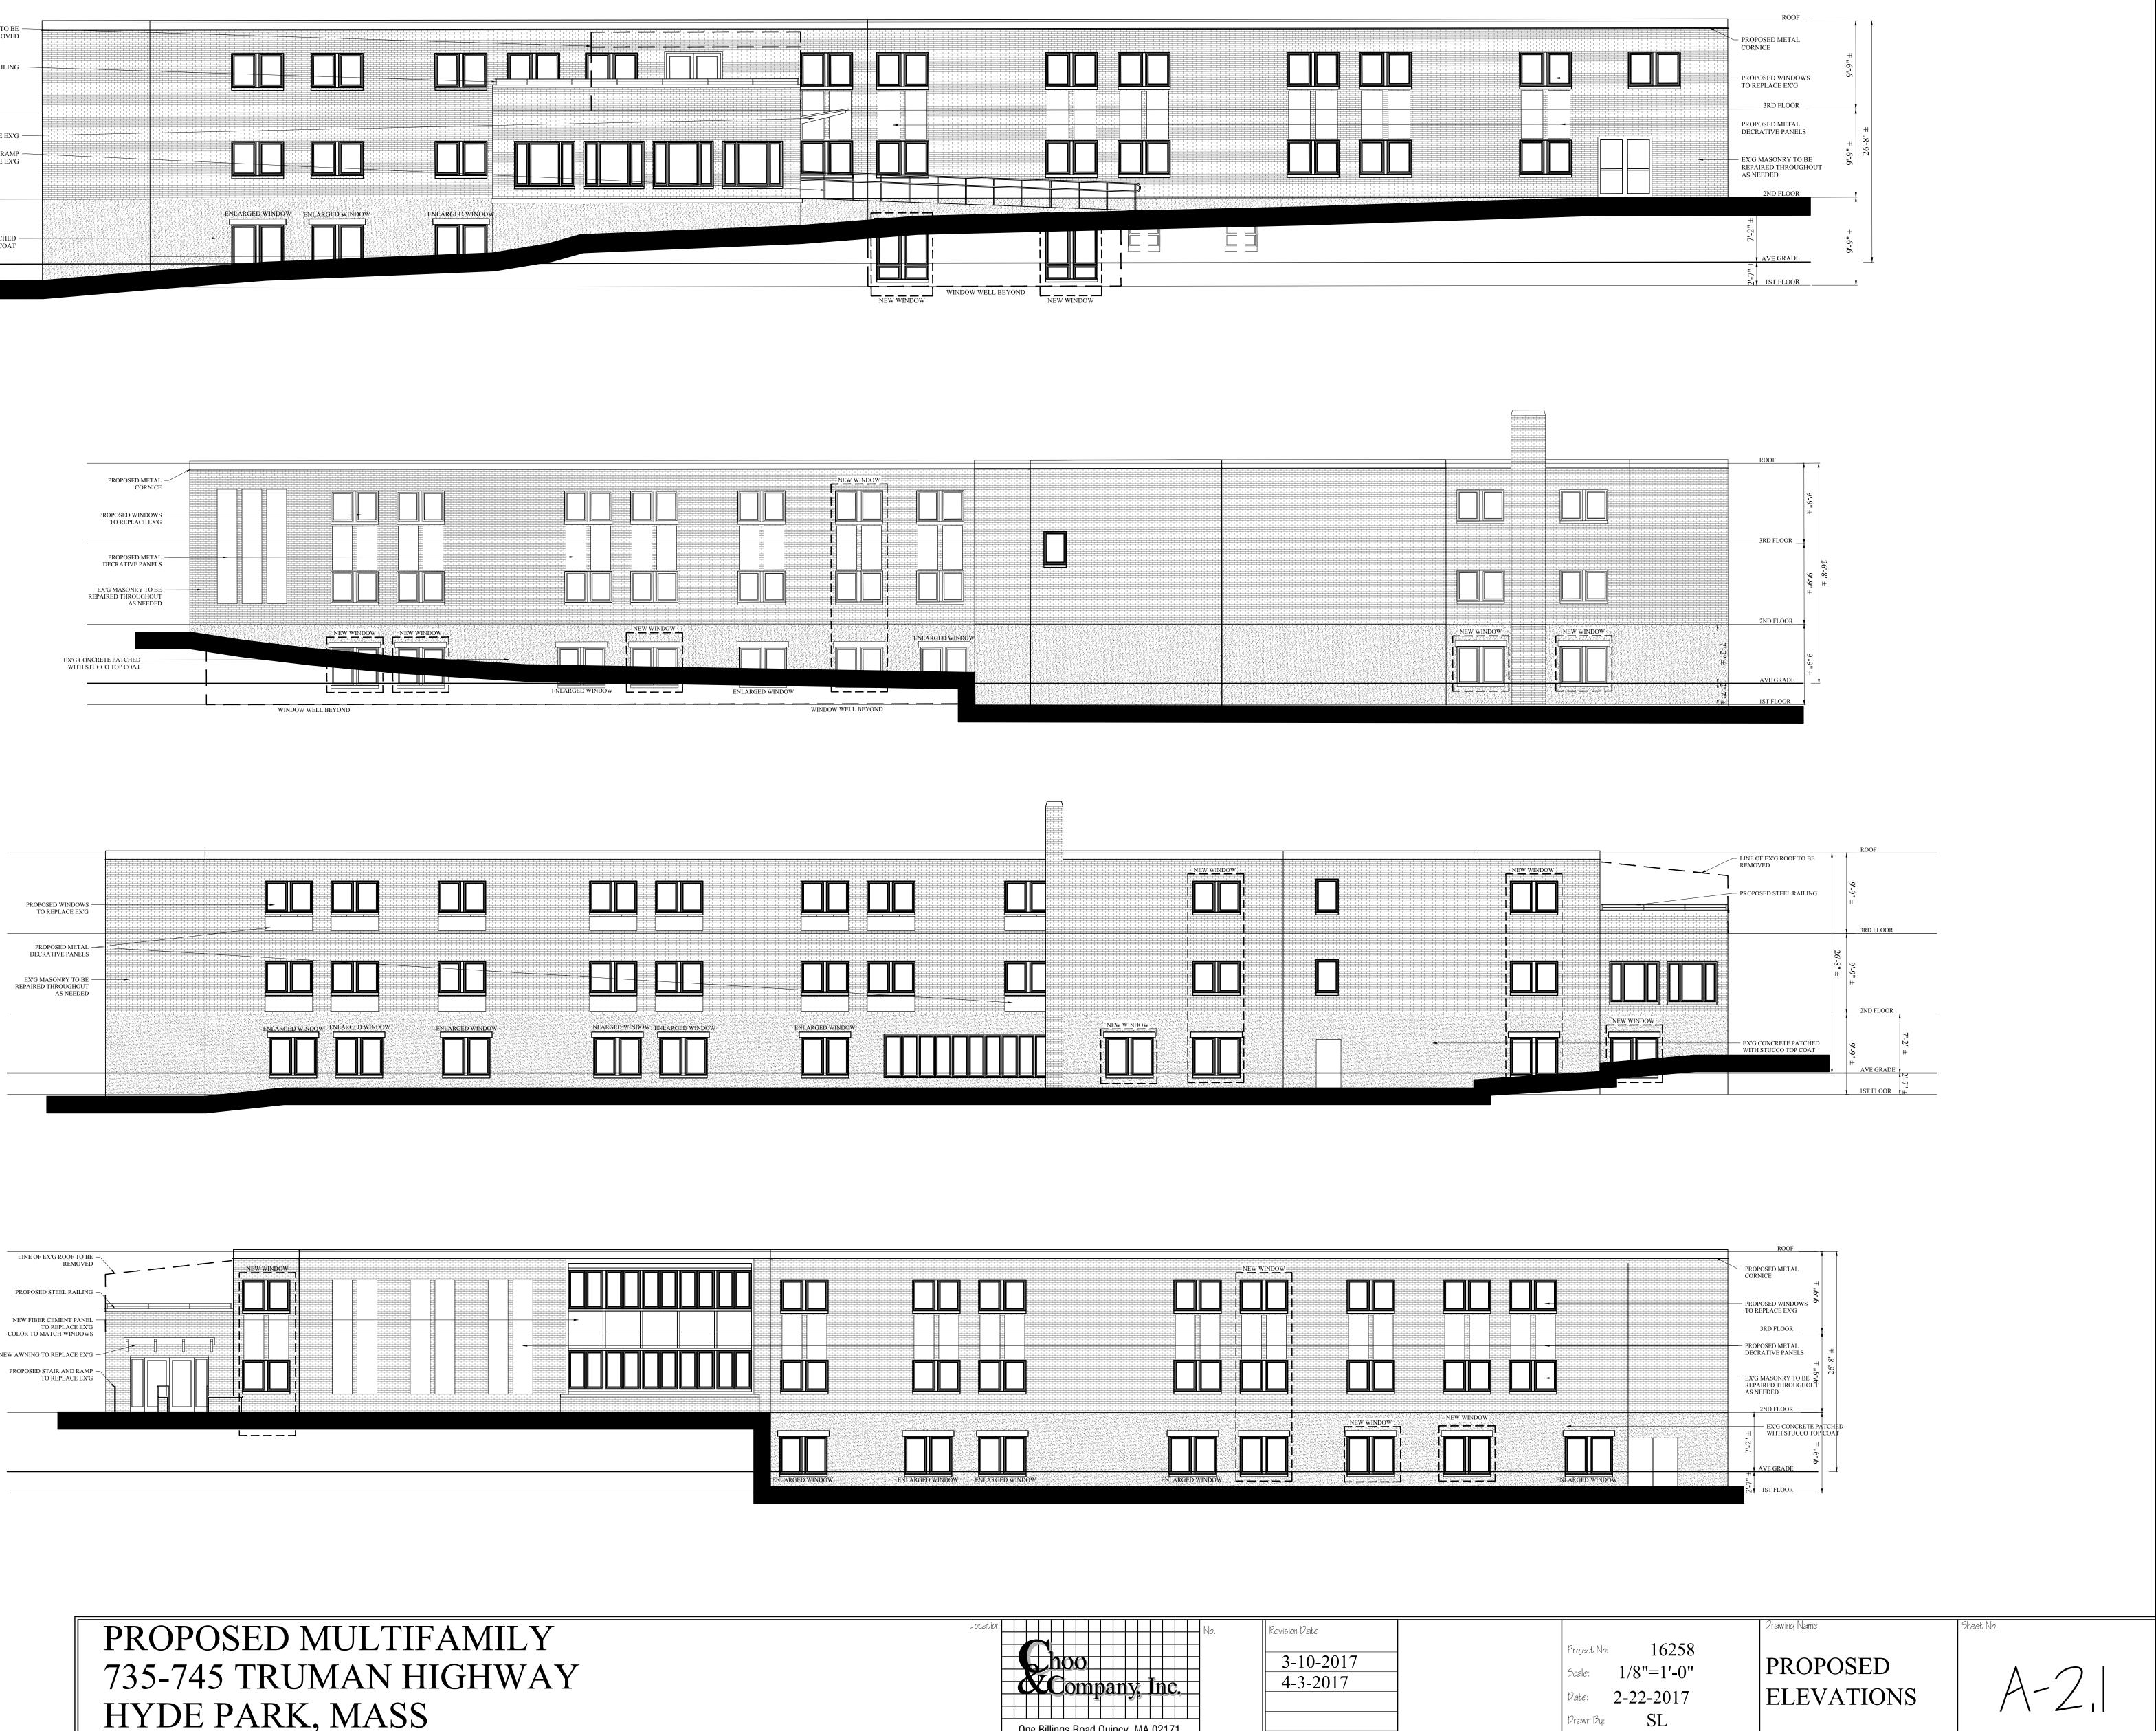





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Article 80 - Accessibility Checklist

A requirement of the Boston Planning & Development Agency (BPDA) Article 80 Development Review Process

The Mayor's Commission for Persons with Disabilities strives to reduce architectural, procedural, attitudinal, and communication barriers that affect persons with disabilities in the City of Boston. In 2009, a Disability Advisory Board was appointed by the Mayor to work alongside the Commission in creating universal access throughout the city's built environment. The Disability Advisory Board is made up of 13 volunteer Boston residents with disabilities who have been tasked with representing the accessibility needs of their neighborhoods and increasing inclusion of people with disabilities.

In conformance with this directive, the BDPA has instituted this Accessibility Checklist as a tool to encourage developers to begin thinking about access and inclusion at the beginning of development projects, and strive to go beyond meeting only minimum MAAB / ADAAG compliance requirements. Instead, our goal is for developers to create ideal design for accessibility which will ensure that the built environment provides equitable experiences for all people, regardless of their abilities. As such, any project subject to Boston Zoning Article 80 Small or Large Project Review, including Institutional Master Plan modifications and updates, must complete this Accessibility Checklist thoroughly to provide specific detail about accessibility and inclusion, including descriptions, diagrams, and data.

For more information on compliance requirements, advancing best practices, and learning about progressive approaches to expand accessibility throughout Boston's built environment. Proponents are highly encouraged to meet with Commission staff, prior to filing.

Accessibility Analysis Information Sources:

- 1. Americans with Disabilities Act 2010 ADA Standards for Accessible Design http://www.ada.gov/2010ADAstandards_index.htm
- 2. Massachusetts Architectural Access Board 521 CMR http://www.mass.gov/eopss/consumer-prot-and-bus-lic/license-type/aab/aab-rules-and-regulations-pdf.html
- 3. Massachusetts State Building Code 780 CMR http://www.mass.gov/eopss/consumer-prot-and-bus-lic/license-type/csl/building-codebbrs.html
- 4. Massachusetts Office of Disability Disabled Parking Regulations <u>http://www.mass.gov/anf/docs/mod/hp-parking-regulations-summary-mod.pdf</u>
- 5. MBTA Fixed Route Accessible Transit Stations <u>http://www.mbta.com/riding_the_t/accessible_services/</u>
- 6. City of Boston Complete Street Guidelines <u>http://bostoncompletestreets.org/</u>
- 7. City of Boston Mayor's Commission for Persons with Disabilities Advisory Board www.boston.gov/disability
- City of Boston Public Works Sidewalk Reconstruction Policy <u>http://www.cityofboston.gov/images_documents/sidewalk%20policy%200114_tcm3-41668.pdf</u>
 Other of Poston – Public Improvement Commission Sidewalk 20fé Policy
- 9. City of Boston Public Improvement Commission Sidewalk Café Policy http://www.cityofboston.gov/images_documents/Sidewalk_cafes_tcm3-1845.pdf

Glossary of Terms:

- 1. *Accessible Route* A continuous and unobstructed path of travel that meets or exceeds the dimensional and inclusionary requirements set forth by MAAB 521 CMR: Section 20
- 2. *Accessible Group 2 Units* Residential units with additional floor space that meet or exceed the dimensional and inclusionary requirements set forth by MAAB 521 CMR: Section 9.4
- 3. *Accessible Guestrooms* Guestrooms with additional floor space, that meet or exceed the dimensional and inclusionary requirements set forth by MAAB 521 CMR: Section 8.4
- 4. *Inclusionary Development Policy (IDP)* Program run by the BPDA that preserves access to affordable housing opportunities, in the City. For more information visit: <u>http://www.bostonplans.org/housing/overview</u>
- 5. *Public Improvement Commission (PIC)* The regulatory body in charge of managing the public right of way. For more information visit: <u>https://www.boston.gov/pic</u>
- 6. *Visitability* A place's ability to be accessed and visited by persons with disabilities that cause functional limitations; where architectural barriers do not inhibit access to entrances/doors and bathrooms.

1. Project Information:

If this is a multi-phased or multi-building project, fill out a separate Checklist for each phase/building.

	Project Name:	735 Truman Parkw	ay				
	Primary Project Address:	735 Truman Parkw	ay, Hyde Park				
	Total Number of Phases/Buildings:	1 (Existing)					
	Primary Contact (Name / Title / Company / Email / Phone):	Todd Fremont Smith / VP-Development / Nordblom Company <u>Tfremont-smith@nordblom.com</u> / 781-272-4000 735 Truman Property Owner C/O Nordblom Company Choo and Company					
	Owner / Developer:						
	Architect:						
	Civil Engineer:	Design Consultants	s, Inc. (DCI)				
Landscape Architect: N/A							
Permitting: Rubin and Rudman							
	Construction Management:	TBD					
	At what stage is the project at time of th	is questionnaire? Se	lect below:				
		PNF / Expanded PNF Submitted	Draft / Final Project Impact Report Submitted	BPDA	Board Approve		
		BPDA Design Approved	Under Construction	Constr Compl			
	Do you anticipate filing for any variances with the Massachusetts Architectural Access Board (MAAB)? <i>If</i> <i>yes,</i> identify and explain.	None anticipated					
-	Building Classification and Description This section identifies preliminary		nation about the project in	cluding	size and uses		
	What are the dimensions of the project?						
	Site Area:	55,329 SF	Building Area:		49,805 GS		
	Building Height:	Max 29'3"	Number of Stories:		3 Fli		

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	Wood Frame	Masonry	Steel Frame	Concrete
What are the principal building uses? (I	BC definitions are be	elow – select all appro	priate that apply	/)
	Residential – One - Three Unit	Residential - Multi-unit, Four +	Institutional	Educational
	Business	Mercantile	Factory	Hospitality
	Laboratory / Medical	Storage, Utility and Other		
List street-level uses of the building:	Residential			
to) hospitals, elderly & disabled ho surrounding the development is ac existing condition of the accessible	cessible for people routes through sid	e with mobility impa dewalk and pedestr	irments and ar ian ramp repor	halyze the ts.
Provide a description of the neighborhood where this development is located and its identifying topographical characteristics:	The property is in the Fairmount Hill Neighborhood of Hyde Park. Located on the side of Fairmount Hill, the property's southern edge is the Truman Parkway and slopes down to the Neponset River on the property's northern edge.			
List the surrounding accessible MBTA transit lines and their proximity to development site: commuter rail / subway stations, bus stops:	The Fairmount MBTA stop is located approximately 0.2 miles for the property. The property is also on the 24 and 24/27 MBTA bus lines which run along Truman Parkway.			
List the surrounding institutions: hospitals, public housing, elderly and disabled housing developments, educational facilities, others:	Boston Renaissance Charter Public School, Boston Preparatory Charter Curry College, Boston Baptist College			
List the surrounding government buildings: libraries, community centers, recreational facilities, and other related facilities:	Boston Police Academy, West Street Park, Smith Pond Playground, Kell Field, Martini Playground			
 Surrounding Site Conditions – Exist This section identifies current con site. 	-	alks and pedestrian	ramps at the o	development
Is the development site within a historic district? <i>If yes,</i> identify which district:	No			
Are there sidewalks and pedestrian	Yes			

ramps existing at the development site?

<i>If yes</i> , list the existing sidewalk and pedestrian ramp dimensions, slopes, materials, and physical condition at the development site:	All sidewalks are concrete. The front entrance ramp will be replaced. Existing dimensions are rise of 28" over a run of 27' with a 49" width.
Are the sidewalks and pedestrian ramps existing-to-remain? <i>If yes,</i> have they been verified as ADA / MAAB compliant (with yellow composite detectable warning surfaces, cast in concrete)? <i>If</i> <i>yes,</i> provide description and photos:	Replacing ramp. Sidewalks to remain.

5. Surrounding Site Conditions – Proposed

This section identifies the proposed condition of the walkways and pedestrian ramps around the development site. Sidewalk width contributes to the degree of comfort walking along a street. Narrow sidewalks do not support lively pedestrian activity, and may create dangerous conditions that force people to walk in the street. Wider sidewalks allow people to walk side by side and pass each other comfortably walking alone, walking in pairs, or using a wheelchair.

Are the proposed sidewalks consistent with the Boston Complete Street Guidelines? <i>If yes</i> , choose which Street Type was applied: Downtown Commercial, Downtown Mixed-use, Neighborhood Main, Connector, Residential, Industrial, Shared Street, Parkway, or Boulevard.	Existing city sidewalk along DCR parkway to remain.
What are the total dimensions and slopes of the proposed sidewalks? List the widths of the proposed zones: Frontage, Pedestrian and Furnishing Zone:	Existing sidewalk to remain on Truman Highway with a 5'-6" pedestrian zone with a 3'-6" wide greenscape/furnishing zone. The existing sidewalks slope as much as 10% due to the existing conditions which slope from Truman Parkway to the Neponset River.
List the proposed materials for each Zone. Will the proposed materials be on private property or will the proposed materials be on the City of Boston pedestrian right-of-way?	No change in material proposed. Existing concrete sidewalk to remain and 3 street trees with grass planting to remain.
Will sidewalk cafes or other furnishings be programmed for the pedestrian right- of-way? <i>If yes,</i> what are the proposed dimensions of the sidewalk café or furnishings and what will the remaining right-of-way clearance be?	No

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If the pedestrian right-of-way is on private property, will the proponent seek a pedestrian easement with the Public Improvement Commission (PIC)?	N/A
Will any portion of the Project be going through the PIC? <i>If yes,</i> identify PIC actions and provide details.	No
	ccess Board Rules and Regulations 521 CMR Section 23.00 rement counts and the Massachusetts Office of Disability –
What is the total number of parking spaces provided at the development site? Will these be in a parking lot or garage?	62 spaces on surface lot
What is the total number of accessible spaces provided at the development site? How many of these are "Van Accessible" spaces with an 8 foot access aisle?	3 spaces on surface lot in a parallel parking configuration. Two of the three spaces are existing. The spaces are on a 5% slope due to the existing conditions which slope from Truman Parkway to the Neponset River.
Will any on-street accessible parking spaces be required? <i>If yes,</i> has the proponent contacted the Commission for Persons with Disabilities regarding this need?	No
Where is the accessible visitor parking located?	At the main building entrance. Two handicap spaces exist from the previous user. A third space will be added at the same location.
Has a drop-off area been identified? <i>If yes,</i> will it be accessible?	No
	smooth and continuous paths of travel is to create universal access which accommodates persons of all abilities and allows for

Describe accessibility at each entryway:	Main Entry – Ramp and stairs
Example: Flush Condition, Stairs, Ramp,	North Entry – on grade
Lift or Elevator:	South Entry – on grade
	Courtyard Entry - stairs

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Are the accessible entrances and standard entrance integrated? <i>If yes, describe. If no,</i> what is the reason?	Yes. The standard main entrance has both an accessible ramp and stairs
<i>If project is subject to Large Project</i> <i>Review/Institutional Master Plan,</i> describe the accessible routes way- finding / signage package.	N/A
	strooms: (If applicable) ing and hospitality, this section addresses the number of for the development site that remove barriers to housing and hotel
What is the total number of proposed housing units or hotel rooms for the development?	46 Units
<i>If a residential development,</i> how many units are for sale? How many are for rent? What is the breakdown of market value units vs. IDP (Inclusionary Development Policy) units?	100% rental
<i>If a residential development,</i> how many accessible Group 2 units are being proposed?	3
<i>If a residential development,</i> how many accessible Group 2 units will also be IDP units? <i>If none</i> , describe reason.	1
<i>If a hospitality development,</i> how many accessible units will feature a wheel-in shower? Will accessible equipment be provided as well? <i>If yes,</i> provide amount and location of equipment.	N/A
Do standard units have architectural barriers that would prevent entry or use of common space for persons with mobility impairments? Example: stairs / thresholds at entry, step to balcony, others. <i>If yes</i> , provide reason.	No
Are there interior elevators, ramps or lifts located in the development for access around architectural barriers	An accessible elevator accesses all floors.

and/or to separate floors? *If yes,* describe:

9. Community Impact:

Accessibility and inclusion extend past required compliance with building codes. Providing an overall scheme that allows full and equal participation of persons with disabilities makes the development an asset to the surrounding community.

Is this project providing any funding or improvements to the surrounding neighborhood? Examples: adding extra street trees, building or refurbishing a local park, or supporting other community-based initiatives?	N/A
What inclusion elements does this development provide for persons with disabilities in common social and open spaces? Example: Indoor seating and TVs in common rooms; outdoor seating and barbeque grills in yard. Will all of these spaces and features provide accessibility?	N/A
Are any restrooms planned in common public spaces? <i>If yes,</i> will any be single- stall, ADA compliant and designated as "Family"/ "Companion" restrooms? <i>If</i> <i>no</i> , explain why not.	No public spaces
Has the proponent reviewed the proposed plan with the City of Boston Disability Commissioner or with their Architectural Access staff? <i>If yes,</i> did they approve? <i>If no,</i> what were their comments?	No presentation has been made.
Has the proponent presented the proposed plan to the Disability Advisory Board at one of their monthly meetings? Did the Advisory Board vote to support this project? <i>If no,</i> what recommendations did the Advisory	No presentation has been made.

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Board give to make this project more accessible?

10. Attachments

Include a list of all documents you are submitting with this Checklist. This may include drawings, diagrams, photos, or any other material that describes the accessible and inclusive elements of this project.

Provide a diagram of the accessible routes to and from the accessible parking lot/garage and drop-off areas to the development entry locations, including route distances.

See attached

Provide a diagram of the accessible route connections through the site, including distances. See attached

Provide a diagram the accessible route to any roof decks or outdoor courtyard space? (if applicable) See attached

Provide a plan and diagram of the accessible Group 2 units, including locations and route from accessible entry. Not selected as of submission

Provide any additional drawings, diagrams, photos, or any other material that describes the inclusive and accessible elements of this project.

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- •
- •


This completes the Article 80 Accessibility Checklist required for your project. Prior to and during the review process, Commission staff are able to provide technical assistance and design review, in order to help achieve ideal accessibility and to ensure that all buildings, sidewalks, parks, and open spaces are usable and welcoming to Boston's diverse residents and visitors, including those with physical, sensory, and other disabilities.


For questions or comments about this checklist, or for more information on best practices for improving accessibility and inclusion, visit <u>www.boston.gov/disability</u>, or our office:

The Mayor's Commission for Persons with Disabilities 1 City Hall Square, Room 967, Boston MA 02201.

Architectural Access staff can be reached at:

accessibility@boston.gov | patricia.mendez@boston.gov | sarah.leung@boston.gov | 617-635-3682

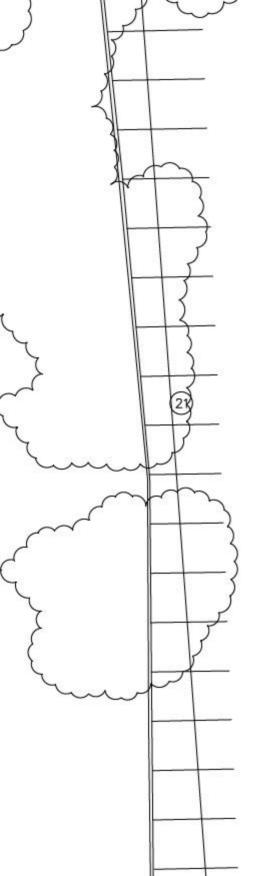

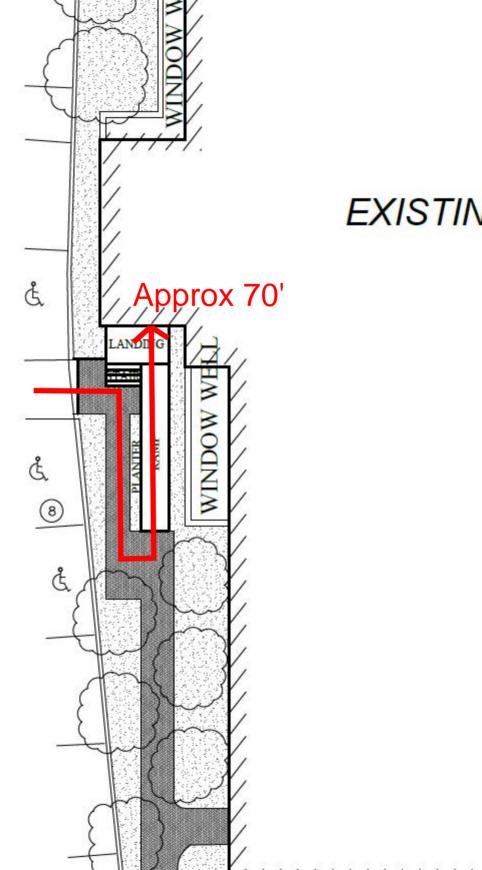



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