# 729 William T. Morrissey Boulevard

Dorchester, Massachusetts





Application for Article 80 Small Project Review Boston Redevelopment Authority d/b/a Boston Planning & Development Agency November 18, 2019

Developer: Floor & Décor Primary Contact: Centerpoint Integrated Solutions Architect: SBLM Civil Engineer: Bohler Engineering Legal Counsel: Hinckley Allen

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### 1.0 PROJECT SUMMARY

#### 1.1 Project Team

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Developer and Applicant Floor & Decor Brandy Crawford, Construction Design Project Manager 2500 Windy Ridge Parkway, SE Atlanta, GA 30339 Phone: 404-471-1634 Email: brandy.crawford@flooranddecor.com

Property Owner New Creek LLC c/o Kimco Realty 3333 New Hyde Park Road New Hyde Park, NY 11042 Phone: 516-869-9000

Legal Counsel Hinckley Allen William J. Squires III, Partner 28 State Street Boston, MA 02109 Phone: 617-378-4212 Email: wsquires@hinckleyallen.com

<u>Civil Engineer</u> Bohler Engineering Austin Turner, Senior Project Manager 352 Turnpike Road Southborough, MA 01772 Phone: 508-480-9900 Email: aturner@bohlereng.com Architecture SBLM 545 West 45<sup>th</sup> Street New York, NY 10036 Phone: 212-995-5600

Surveyor Control Point Associates, Inc. 352 Turnpike Road, Suite 320 Southborough, MA 01772 Phone: 508-948-3000

#### 1.2 Project Summary

This Small Project Review Application ("SPRA") is being submitted by Floor & Decor (the "Proponent") in accordance with Article 80, Section 80E, of the Boston Zoning Code (the "Code" or "Zoning Code"). The Proponent proposes to substantially renovate an existing retail building located at 729 William T. Morrissey Boulevard in Dorchester (the "Property") for use as a Floor & Decor (the "Project"). The Proponent has entered an agreement to lease the Property from New Creek LLC (the "Owner"), an affiliate of Kimco Realty Corporation. The Owner supports the Proponent with respect to the Project. The use of the Property as a Floor & Decor falls within the definition of a General Retail Business Use. This use is conditional within the Neighborhood Shopping Subdistrict. The Property was used by National Wholesale Liquidators for General Retail Business Use until the end of 2018 when it filed for bankruptcy protection.

The Property consists of three parcels of land comprising approximately  $3.68\pm$  acres ( $158,947\pm$  square feet) located on the westerly side of Morrissey Boulevard near the intersection of Victory Road as shown on **Figure 3.12**, titled "Boundary & Topographic Survey", dated June 19, 2019, prepared by Control Point Associates, Inc. The Property is currently developed with an approximate  $82,378\pm$  square foot single story, masonry building which was formerly National Wholesale Liquidators. The Property is surrounded by a mix of retail, office, residential and institutional uses.

The Project includes substantial renovations to the interior and facade of the existing building and reconfiguration of on-site parking to allow the Proponent to use the Property as a Floor & Decor. Although the Proponent anticipates substantial renovations to the building, the Project is currently anticipated to remain within the footprint of the existing structure. The proposed layout of the Project is shown on **Figure 3.14**, titled Concept Plan, dated November 15, 2019, prepared by Bohler Engineering.

The project also includes the addition of enhanced landscaping, where limited landscaping is present today. The Proponent has solicited feedback from BPDA and neighborhood groups, respectively, which has resulted in the introduction of additional landscape features both proximate to Morrissey Boulevard and internal to the parking area. While this will result in a reduction in the matter of parking spaces available to the project, the number of proposed parking spaces will meet the tenant's operational expectations while providing additional green space.

As shown on the Concept Plan, the Project proposes one hundred and eighteen (118) off-street parking spaces. The existing loading area is proposed to be maintained on the northwest side of the building. A new interior customer pick up area will be located on the northern side of the building. This feature is intended to allow customers to facilitate loading of materials into their vehicles. As previously discussed with the BPDA, the project proposes to implement an audio and visual alarm system to alert pedestrians of vehicles entering and exiting the proposed customer pick up area. Additional information relative to the proposed audio-visual equipment is shown on **Figure 3.15**, titled Audible Signal Devices, prepared by WERMA. The anticipated renovations to the building facade are shown on **Figures 3.18**, titled Exterior Elevations Colored, dated June 17, 2019, prepared by SBLM Architects. The anticipated floor plan of the building is shown on **Figure 3.21**, titled Proposed Floor Plan, dated June 17, 2019, prepared by SBLM Architects. A bicycle rack is proposed to accommodate pedestrian access and is located within the vicinity of the building, as shown on the enclosed Concept Plan.

The Proponent is aware of the improvements being considered by the Massachusetts Department of Conservation and Recreation (DCR) with respect to Morrissey Boulevard and is continuing to coordinate with these respective agencies to determine what impact, if any, this project may have on the Floor and Décor proposal and how these projects can continue to work together. An Exhibit, titled Morrissey Boulevard Improvements Exhibit, is included with this document to provide context as to how this project relates to the Morrissey Boulevard improvements.

The Proponent and Owner believe that the Project will benefit the City of Boston, Dorchester and the NS Subdistrict by, among other things: dramatically improving a dilapidated building and occupying same with a new long-term tenant; adding landscaping features; properly sizing parking spaces; providing goods and services to the larger neighborhood; and improving security and public safety.

#### 1.3 Community Benefits

The Project is anticipated to result in a number of public benefits for the Dorchester community, as well as for the City of Boston. These benefits include, among others:

- Improvements to the perimeter of the Property including enhanced landscape buffering and associated streetscape improvements;
- Providing interior landscape and parking improvements;
- Providing additional property tax revenue to the City;
- Substantial improvements to the existing dilapidated building and parking area;
- Improving public safety and security by providing twenty-four (24) hour surveillance of the Property with security cameras and signage specifying same;
- Upgrades to the stormwater management system by way of a new subsurface detention/infiltration system, where none exists today;
- Contributing to community involvement, including local charities
- Construction jobs over the length of the Project; and
- New full-time and part-time jobs within the local Dorchester community.

#### 2.0 DETAILED PROJECT INFORMATION

#### 2.1 **Project Description**

The Property is identified in the public records of the City of Boston (the "City") as 729 William T. Morrissey Boulevard, Dorchester, Suffolk County, Massachusetts with Parcel No. 1600247000, 1600245020, and 1600244000. In particular, according to a review of the public records on file with the City, the Property consists of approximately  $3.68\pm$  acres (158,947 square feet) of land, with an existing single-story retail structure of approximately 82,378 square feet and last recorded legal use and occupancies as National Wholesale Liquidators. See **Figure 3.11** for Project locus and **Figure 3.13** for Project aerial.

#### 2.2 Proposed Program, Data, and Dimensions

Lot Area:  $158,947 \pm SF$ Maximum Building Height/Stories:  $32\pm$  feet, 1 Story Total Building Square Footage:  $82,378\pm SF$ Floor Area Ratio:  $0.51\pm$ Proposed Parking Spaces: 118

#### 2.3 Design Approach

The Project includes substantial renovations to the interior and facade of the existing building and reconfiguration of on-site parking to allow the Proponent to use the Property as a Floor & Decor. Although the Proponent anticipates substantial renovations to the building, the Project is currently anticipated to remain within the footprint of the existing building. The proposed layout of the Project is shown on **Figure 3.14**, titled Concept Plan, dated November 15, 2019, prepared by Bohler Engineering.

The Proponent has previously met with BPDA on September 16, 2019 and received comments regarding accessible sidewalk connections from the adjacent roadways. Although not reflected on the current conceptual plans, the Proponent is continuing to work with the Owner relative to same.

#### 2.4 Parking and Access

There are one hundred and twenty-six (126) existing parking spaces on-site. The dimensions of the existing parking spaces do not meet minimum Boston Zoning requirements. The Project proposes to restripe the existing parking area to meet those requirements. Restriping the parking spaces – the previously described landscaping improvements – will reduce the total number of parking spaces for the Project to one hundred and eighteen (118). As explained in Section 3.2 of this SPRA, the Proponent anticipates the potential need for zoning relief from the Board of Appeal

with respect to the number of parking spaces for the Project. Based on the Proponent's previous discussions with the BPDA and neighborhood groups, it is believed that this relief will be supported.

The existing loading area will be maintained on the northwest side of the building. A new interior customer pick up area will be located on the northern side of the building as shown on **Figure 3.18**. The project is intended to be accessed via existing driveways proximate to Victory Road and Morrissey Boulevard.

#### 2.5 Preliminary List of Permits and Approvals

At this time, the Proponent anticipates that the Project will require the following permits and approvals. Please note that this is a preliminary list based on currently available information. Not all of the following permits and approvals may ultimately be required and additional permits and approvals may be needed.

PERMITTING AUTHORITY	PERMIT OR APPROVAL
U.S. Environmental Protection Agency	Notice of Intent for Coverage under NPDES Construction General Permit and SWPPP, if required
BPDA	Article 80E Small Project Review Certificate of Compliance
Boston Zoning Board of Appeal	Variances, Exceptions and/or Conditional Use Permit
Boston Fire Department	Approval of Fire Safety Equipment
Boston Water and Sewer Commission	Stormwater Permit; General Service Application
Boston Department of Inspectional Services	Building Permits; Certificates of Occupancy; Potentially Other Construction-Related Permits
Boston Parks & Recreation Department	Parks Approval for Building Permit
Boston Department of Conservation and Recreation	Construction Access Permit

#### Table 2.5 Preliminary List of Permits and Approvals

Boston Conservation Commission	Notice of Intent		
Boston Landmarks Commission	Dorchester Pottery Works – Historic Designation		

#### 2.6 Public Outreach

The Proponent and Owner have met with neighborhood groups, representatives of the City of Boston, and other stakeholders in support of the Project prior to filing this SPRA.

The Proponent and Owner had productive and positive meetings with the Clam Point Civic Association on October 21, 2019 and Pope's Hill Neighborhood Association on October 23, 2019 and the project was well received. The Proponent has also discussed the Project with representatives of the BPDA and other representatives of the City of Boston, including during meetings at the BPDA on July 9, 2019 and September 16, 2019. This application is reflective of the feedback received to date and the Proponent is continuing to work with these groups and the BPDA as the Project continues to evolve.

The Proponent has discussed the Project with representatives of the Boston Water and Sewer Commission (BWSC) to determine the anticipated permitting requirements and to solicit feedback such that it can be incorporated into the design plans, as appropriate.

The Proponent and Owner will continue to meet with public agencies, neighborhood representatives, local business organizations, abutting property owners, and other stakeholders, and will follow the requirements of Article 80 pertaining to the public review process.

### 3.0 BOSTON ZONING CODE ANALYSIS

#### 3.1 Zoning District and Project Use

The Property is located in the Dorchester Neighborhood District, Neighborhood Shopping ("NS") Subdistrict, which is one of three Neighborhood Business Districts in the Dorchester Neighborhood District. A small portion of the eastern side of the Property is located within the Greenbelt Protection Overlay District ("GPOD"). Consequently, the Project is also subject to Article 29 and the Proponent must demonstrate to the BPDA that the Project complies with the standards set forth in Section 29-6.

Section 65-15 provides that any use of a location in a Neighborhood Business Subdistrict must be identified as "A" (allowed) or "C" (conditional) on Table B of Article 65. As noted above, the Proponent's proposed use of the Property as a Floor & Decor falls within the definition of a General Retail Business Use, which is identified as "C" (conditional) for the NS Subdistrict under Table B of Article 65. Based on previous discussions with the Boston Landmarks Commission (BLC), a portion of the existing building is located within a designated landmark property and is subject to BLC review.

#### 3.2 Scope of BPDA Review

Section 80E-2.1(b)(iv) provides that Small Project Review is required for any project for which the underlying zoning requires design review by the BPDA. Section 65-37.1(b) expressly requires Small Project Review for any project within a Neighborhood Business Subdistrict that proposes exterior alterations affecting 300 or more square feet of a building facade if visible from any public street. The anticipated exterior alterations to the building – which are shown on the **Figure 3.18** – will affect more than 300 square feet of the building facade and will be visible from Morrissey Boulevard. Consequently, the Project is subject to Small Project Review under Sections 65-37.1(b) and 80E-2.1(b)(iv).

The Proponent anticipates that Small Project Review for the Project will include the Design Component under Section 80E-2.1, the Site Plan Component under Section 80E-2.2 and the Comprehensive Sign Design Component under Section 80E-2.3. Additional information relative to the Comprehensive Sign Design Package is shown on **Figure 3.20**.

#### 3.3 Applicable Dimensional Regulations

The site consists of three (3) parcels of land comprising a total of  $158,947\pm$  square feet, providing a floor area ratio (FAR) of approximately 0.51. The NS Subdistrict establishes a maximum FAR of 1.0. The applicable dimensional regulations under NS Subdistrict require No Minimum Lot Size , No Lot Width Minimum and No Front or Side Yard Minimum. The applicable

dimensional regulations require a maximum building height of forty (40) feet, and a Rear Yard Setback Minimum of twenty (20) feet. The Project, as proposed, conforms to the dimensional regulations of the Code as follows:

Dimensional Regulation	Neighborhood Shopping (NS) Subdistrict	Existing Conditions	Proposed Conditions	Zoning Relief Required
Minimum Lot Size	None	$158,947 \pm SF$	No Change	None
Minimum Lot Width	None	95.0± FT	No Change	None
Minimum Frontage	None	95.0± FT	No Change	None
Maximum Floor Area Ratio (FAR)	1.0	0.51±	No Change	None
Maximum Building Height	40 ft	22.3± FT	32± FT	None
Minimum Front Yard	None	166.8± FT	No Change	None
Minimum Side Yard	None	4.1± FT	No Change	None
Minimum Rear Yard	20 ft	N/A	N/A	None
Minimum Number of Parking Spaces	2 spaces per 1,000 SF Gross Area; 165 spaces required	126 Spaces	118 Spaces	Yes, Zoning Board of Appeal

**Table 3.1 Zoning Analysis Table** 

#### 3.4 Zoning Relief Required

As noted above, the anticipated use of the Property as a Floor & Decor constitutes a General Retail Business Use which is allowed as a conditional use in the NS Subdistrict under Table B of Article 65. In addition, a portion of the Property is located in the GPOD, making the Project subject to the provisions of Article 29. Consequently, the Proponent anticipates the need to file an appeal for a conditional use with the Board of Appeal after completion of Small Project Review.

The Proponent anticipates that the Project may require zoning relief from the Zoning Board of Appeal with respect to the total number of parking spaces for the Project and for screening requirements under Article 65. As noted above, the Proponent anticipates that the BPDA's Small Project Review will include the Comprehensive Sign Design Component under Section 80E-2.3.

Pursuant to Table F of Article 65, retail uses require two (2) parking spaces per one thousand (1,000) square feet of gross floor area. Therefore, the Project would require 165 parking spaces. There are one hundred and twenty-six (126) existing parking spaces on-site. As noted above, the Proponent proposes one hundred and eighteen (118) parking spaces for the Project, including 5 accessible parking spaces. During the July 9, 2019 meeting, BPDA staff expressed an interest in providing additional landscaping islands within the existing parking lot in an effort to reduce impervious surfaces and provide opportunities for new plantings. This would, however, reduce the number of proposed parking spaces that can be accommodated as part of the project and would further reinforce the project's need to seek relief from the parking requirement. The Proponent welcomes further discussions with BPDA staff with respect to parking.

The Project may also require zoning relief from certain screening and buffering requirements under Section 65-39. Boston Zoning Code requires interior landscaping of parking areas to consist of a minimum of five (5) by ten (10) feet provided after every ten (10) contiguous parking spaces. As previously mentioned, the Proponent is willing to consider the addition of other landscape features, but such additions would further decrease the number of parking spaces available thereby increasing the zoning nonconformity. The Proponent is continuing to work with BPDA to strike a balance between the available parking and the additional landscaping such that the Proponent's operations needs can be met while also bettering the property.

As part of the Comprehensive Sign Design Component of Small Project Review, the Proponent seeks relief from the BPDA for certain sign regulations in the Boston Zoning Code, potentially including, among other things: (i) relief from certain dimensional requirements for signs parallel to the building wall under Section 65-40.1 and (ii) relief from the prohibition of free-standing signs under Section 65-40.3. The proposed sign package prepared by ID. Associates is shown on **Figure 3.20**.

#### 3.5 Building Code Analysis

Applicable Codes:

**Building:** Massachusetts Building Code, Ninth Edition - 780 CMR, (Adopts with Amendments – IBC 2015)

**Mechanical:** Mechanical Code 2009 of Massachusetts - 271 CMR, (Adopts without Amendments – IMC 2009)

Plumbing: Uniform State Plumbing Code - 248 CMR

**Electrical:** Massachusetts electrical code – 527 CMR 12.00, (Adopts with Amendments - NFPA 70, 2017 edition)

**Energy:** Energy Conservation Code 2009 of Massachusetts- 780 CMR 13.0, (Adopts with Amendments - IECC 2009)

**Fire:** Massachusetts Fire code – 527 CMR 1.00, (Adopts with Amendments - NFPA 1, 2015 Edition)

Accessibility: 521 CMR / 2010 ADA Standards

#### Code Analysis:

**Construction Type:** II-A (1-Hr fire Rated Structure)

Occupancy: M-Mercantile

Fully Sprinkled: Yes

**Travel Distance:** 250'-0 Maximum to Exit.

#### Occupancy Load:

Mercantile:	61,053 sq. ft.	1,018 Occupants
Storage:	16,316 sq. ft.	55 Occupants
Total:	80,119 sq. ft.	1,099 Occupants

#### 3.6 Design Submission and Project Drawings

**Figures 3-1** through **3-21** more fully illustrate the design and include the following figures and photographs:

- Figure 3.1 Site Photograph
- Figure 3.2 Site Photograph Figure 3.3 Site Photograph
- Figure 3.4 Site Photograph
- Figure 3.5 Site Photograph
- Figure 3.6 Site Photograph
- Figure 3.7 Site Photograph
- Figure 3.8 Site Photograph
- Figure 3.9 Site Photograph
- Figure 3.10 Site Photograph
- Figure 3.11 Assessor's Map
- Figure 3.12 Existing Conditions Plan
- Figure 3.13 Aerial Exhibit
- Figure 3.14 Concept Plan
- Figure 3.15 Visual-Audible Signal Devices Overview
- Figure 3.16 Conceptual Rendering Looking South on William T. Morrissey Boulevard
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- Figure 3.18 Exterior Elevations Rendering
- Figure 3.19 Morrissey Boulevard Improvements Exhibit
- Figure 3.20 Comprehensive Sign Design Package
- Figure 3.21 Floor Plan



Figure 3.1: Existing Parking Area and Existing Building



Figure 3.2: Existing ADA Spaces and Existing Main Entrance Location



Figure 3.3: Existing Sidewalk with 2.5% Cross-Slope (2.0% Max. Allowed)



Figure 3.4: Existing ADA Spaces with 3.4% Cross-Slope (2.0% Max. Allowed)



Figure 3.5: Existing Compactor Location (Rear)



Figure 3.6: Existing Compactor Location (Left)



Figure 3.7: Existing Sign Location and Parking Area





Figure 3.9: Existing Southeast Building Façade



Figure 3.10: Existing Catch Basin in Parking Area

Figure 3.11 Assessor's Map

#### 729 William T. Morrissey Boulevard, Dorchester, City of Boston, Massachusetts

Map 5E, Parcel 1600247000 (729 William T. Morrissey Boulevard) Map 5E, Parcel 1600245020 (Victory Road) Map 5E, Parcel 1600244000 (Victory Road)



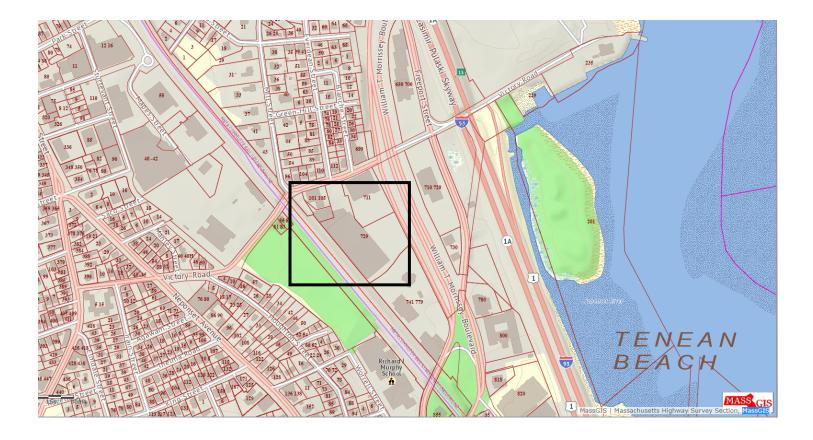


Figure 3.12 Existing Conditions Plan

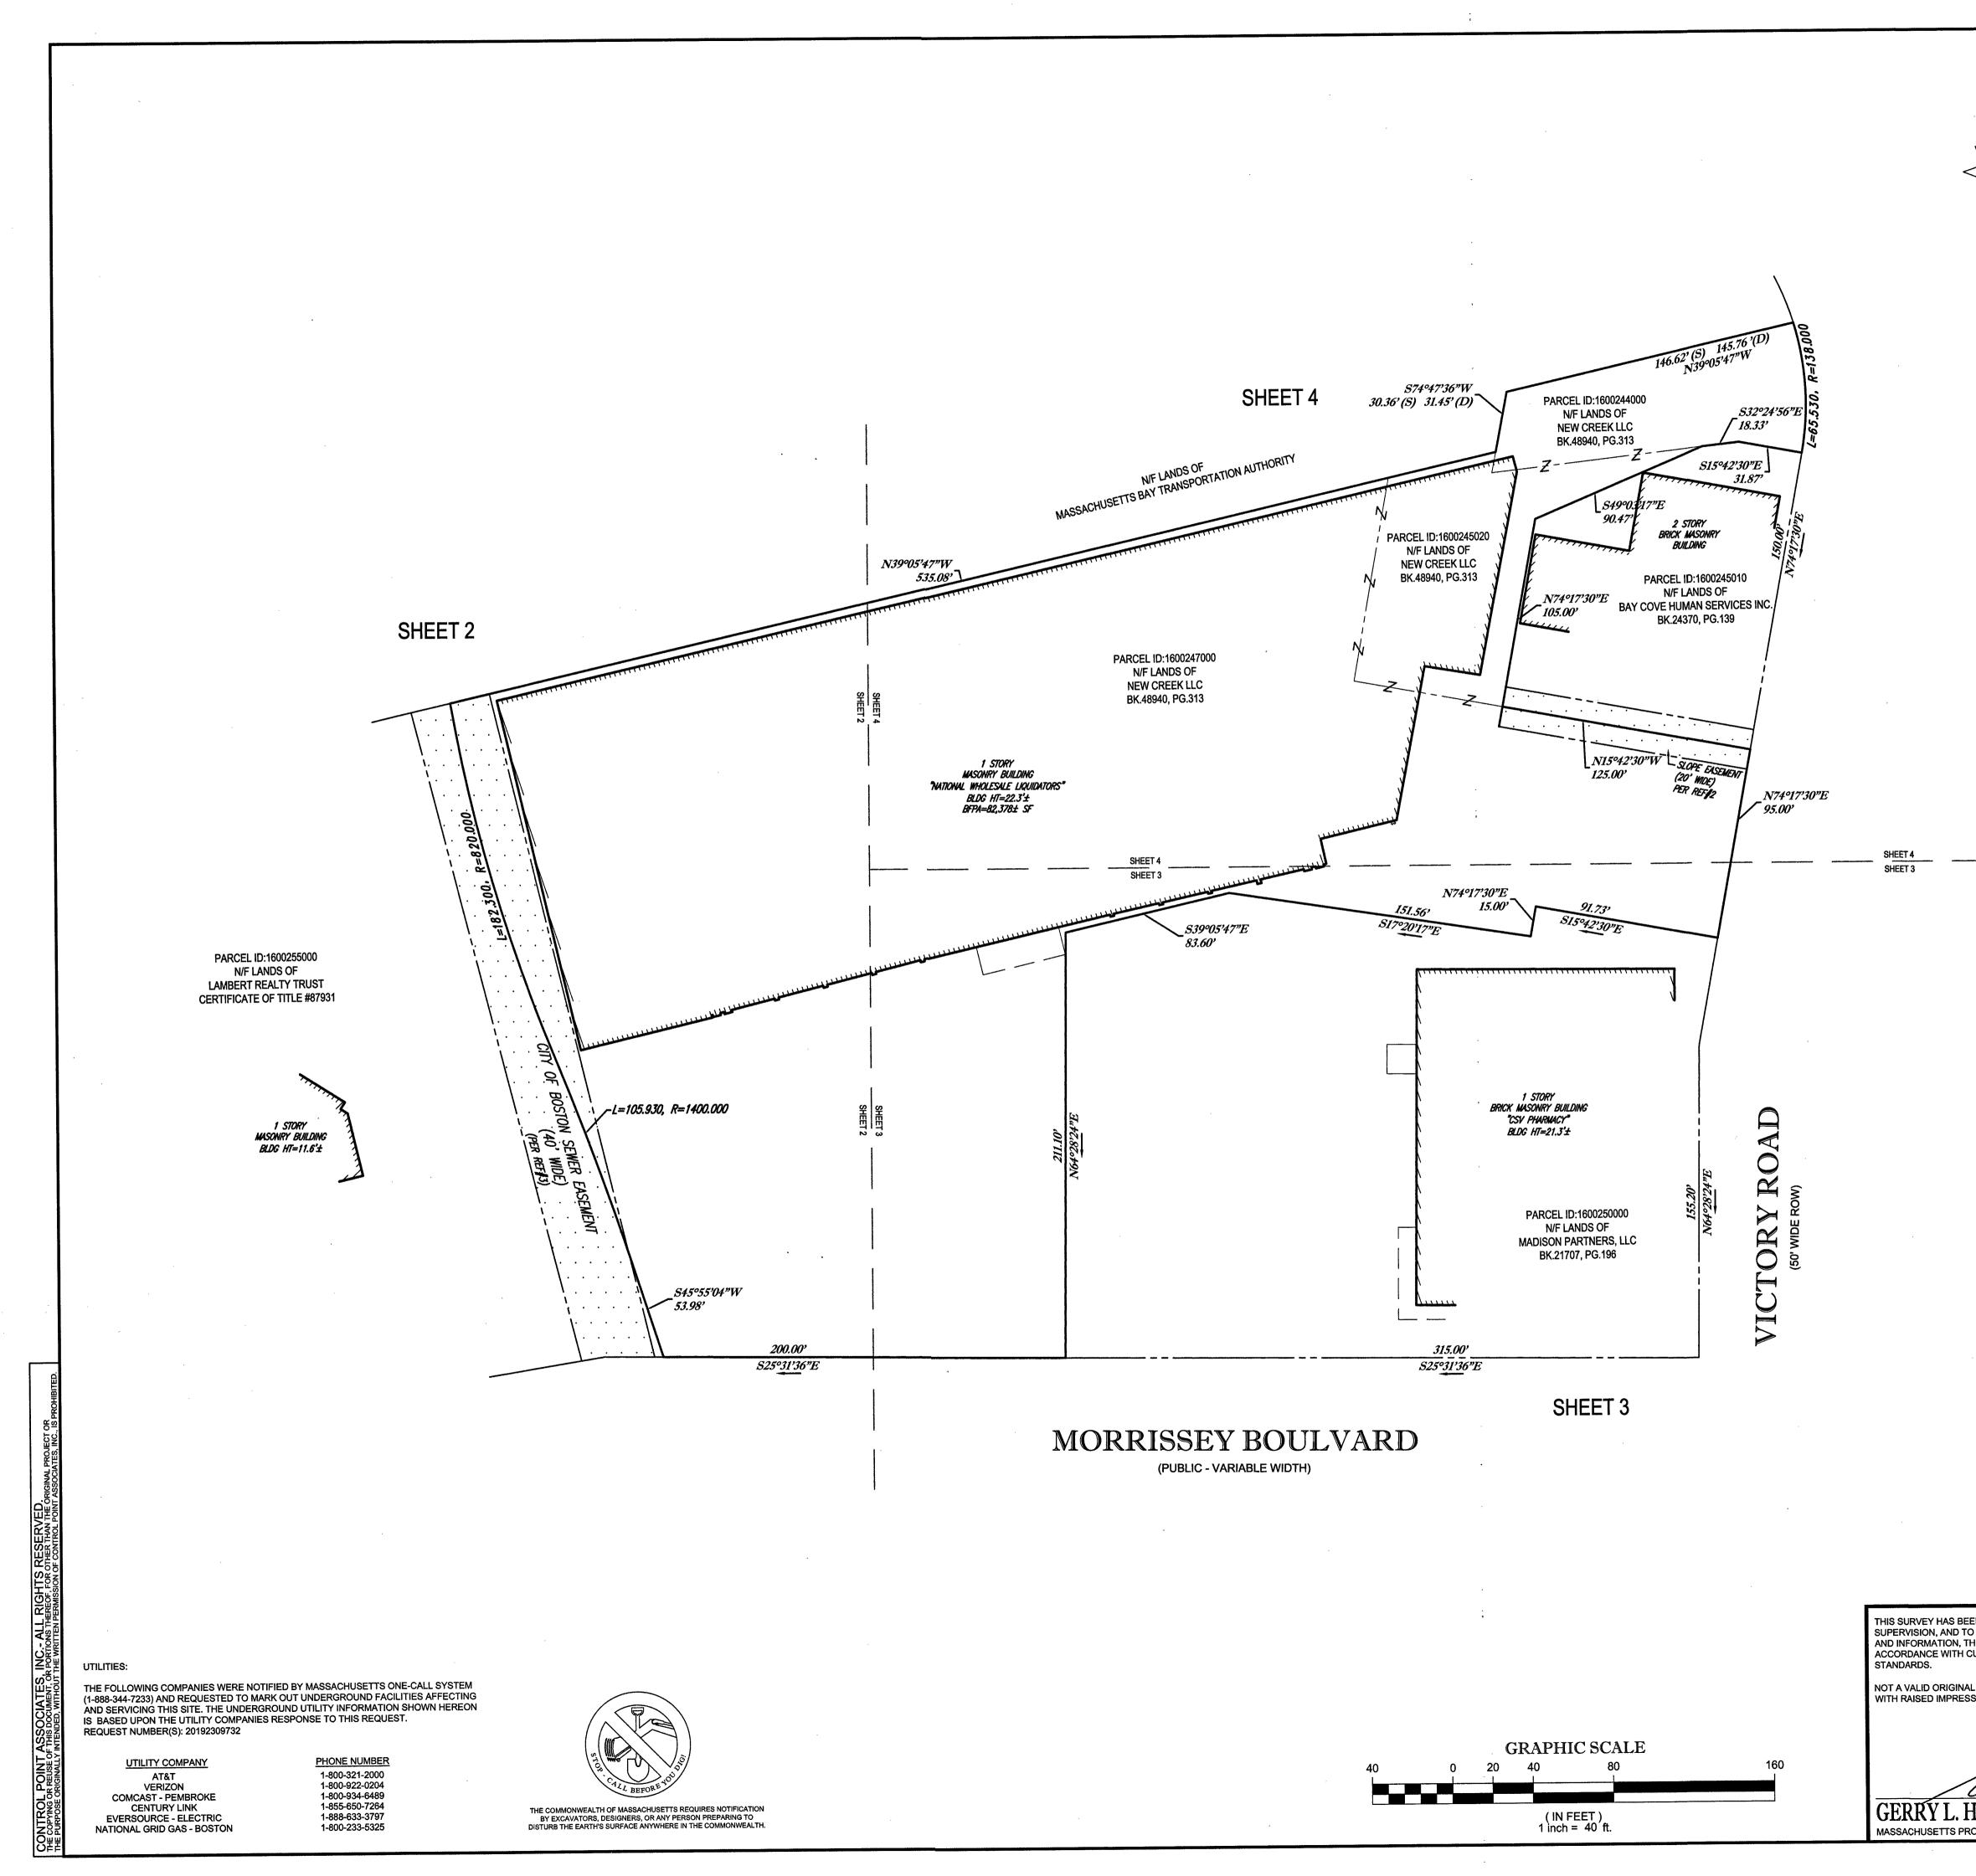

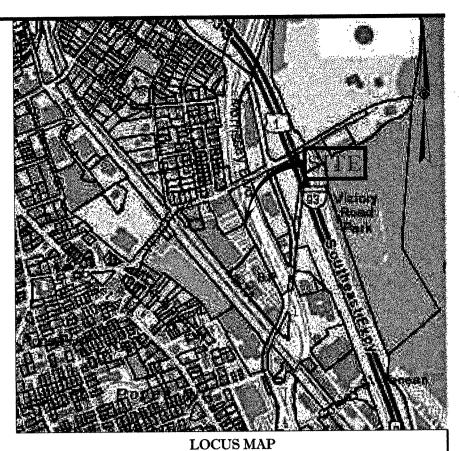

© 2013 ESRI WORLD STREET MAPS

### NOTES:

- PROPERTY KNOWN AS PARCEL ID'S 1600247000, 1600245020, & 1600244000 AS SHOWN ON THE CITY OF BOSTON (DORCHESTER DISTRICT), SUFFOLK COUNTY, COMMONWEALTH OF MASSACHUSETTS
- AREA: PARCEL ID: 1600247000 = 142,055± S.F. PARCEL ID: 1600245020 = 9,503± S.F. PARCEL ID: 1600244000 = 7,389± S.F. TOTAL AREA = 3.68± ACRES (DEED)
- 3. LOCATION OF UNDERGROUND UTILITIES ARE APPROXIMATE. LOCATIONS AND SIZES ARE BASED ON UTILITY MARK-OUTS, ABOVE GROUND STRUCTURES THAT WERE VISIBLE & ACCESSIBLE IN THE FIELD, AND THE MAPS AS LISTED IN THE REFERENCES AVAILABLE AT THE TIME OF THE SURVEY. AVAILABLE AS-BUILT PLANS AND UTILITY MARKOUT DOES NOT ENSURE MAPPING OF ALL UNDERGROUND UTILITIES AND STRUCTURES. BEFORE ANY EXCAVATION IS TO BEGIN, ALL UNDERGROUND UTILITIES SHOULD BE VERIFIED AS TO THEIR LOCATION, SIZE AND TYPE BY THE PROPER UTILITY COMPANIES. CONTROL POINT ASSOCIATES, INC. DOES NOT GUARANTEE THE UTILITIES SHOWN COMPRISE ALL SUCH UTILITIES IN THE AREA EITHER IN SERVICE OR ABANDONED.
- THIS PLAN IS BASED ON INFORMATION PROVIDED BY A SURVEY PREPARED IN THE FIELD BY CONTROL POINT ASSOCIATES, INC. AND OTHER REFERENCE MATERIAL AS LISTED HEREON.
- 5. THIS SURVEY WAS PREPARED WITHOUT THE BENEFIT OF A TITLE REPORT AND IS SUBJECT TO THE RESTRICTIONS, COVENANTS AND/OR EASEMENTS THAT MAY BE CONTAINED THEREIN.
- 6. ELEVATIONS REFER TO THE NORTH AMERICAN VERTICAL DATUM OF 1988 (NAVD88), BASED ON GPS OBSERVATIONS UTILIZING THE KEYSTONE VRS NETWORK (KEYNETGPS).
- TEMPORARY BENCH MARKS SET:

   TBM-A:
   -- NORTHWEST BOLT OF FIRE HYDRANT

   ELEVATION = 8.61

   TBM-B:
   -- MAG NAIL IN ASPHALT PAVEMENT

   ELEVATION = 8.34

PRIOR TO CONSTRUCTION IT IS THE CONTRACTOR'S RESPONSIBILITY TO VERIFY THAT THE BENCHMARKS ILLUSTRATED ON THIS SKETCH HAVE NOT BEEN DISTURBED AND THEIR ELEVATIONS HAVE BEEN CONFIRMED. ANY CONFLICTS MUST BE REPORTED PRIOR TO CONSTRUCTION.

### **REFERENCES:**

- 1. THE TAX ASSESSOR'S MAP OF THE CITY OF BOSTON, SUFFOLK COUNTY, COMMONWEALTH OF MASSACHUSETTS
- MAP ENTITLED "PLAN OF LAND BOSTON (DORCHESTER DISTRICT) MASS", DATED JANUARY 28, 1959, REVISED APRIL, 1964, PREPARED BY FRANCIS A CASS, RECORDED IN BOOK 7922 PAGE 580.
- MAP ENTITLED "CITY OF BOSTON PLAN NO 1295 SEWERAGE WORKS TENEAN CREEK DORCHESTER" DATED MARCH 11, 1947, PREPARED BY THOMAS McGOVERN, RECORDED IN BOOK 6314 PAGE 353.
- 4. DEED OF NEW CREEK II LLC, RECORDED IN BOOK 48940 PAGE 313.

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×BW 122.95	EXISTING BOTTOM OF WALL ELEVATION	EOP	EDGE OF PAVEMENT
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RUFEGGIONAL LAND GURVETUR #40211								

PARCEL ID:1600255000 N/F LANDS OF LAMBERT REALTY TRUST **CERTIFICATE OF TITLE #87931** 

> MASONRY BUILDING BLDG HT=11.6'±

> > \*\*\*\* ~

LEGEND --- 124 ----مج کے محکمہ PAINTED ARROWS EXISTING CONTOUR --- 125 ----UNDER GROUND EXISTING SPOT ELEVATION UG × 123.45 EXISTING TOP OF CURB ELEVATION X TC 123.45 CHAIN LINK FENCE × C 122.95 EXISTING GUTTER ELEVATION DEPRESSED CURB DC ×TW 123.45 EXISTING TOP OF WALL ELEVATION EDGE OF CONCRETE EOC ×BW 122.95 EXISTING BOTTOM OF WALL ELEVATION EDGE OF PAVEMENT FOP ×FF 123.45 EXISTING FINISHED FLOOR ELEVATION LANDSCAPED AREA LSA  $\mathbf{\nabla}$ HYDRANT METAL COVER WATER VALVE TYPICAL (TYP) GAS VALVE ELECTRIC MANHOLE (F) FMH OVERHEAD WIRES ----- OH -----SANITARY/SEWER MANHOLE S SMH APPROX. LOC. UNDERGROUND SANITARY / SEWER LINE UNKNOWN MANHOLE MA MH UP 🗍 🔶 UTILITY POLE CATCH BASIN OR INLET СВ STREET LIGH TREE & TRUNK SIZE AREA LIGH PARKING SPACE COUNT C/O • CLEAN OUT \_\_\_\_\_ DEPRESSED CURB SIGN -----SURVEY DIMENSION (S) BOLLARD DEED DIMENSION Po POST (D)


THE FOLLOWING COMPANIES WERE NOTIFIED BY MASSACHUSETTS ONE-CALL SYSTEM (1-888-344-7233) AND REQUESTED TO MARK OUT UNDERGROUND FACILITIES AFFECTING AND SERVICING THIS SITE. THE UNDERGROUND UTILITY INFORMATION SHOWN HEREON IS BASED UPON THE UTILITY COMPANIES RESPONSE TO THIS REQUEST. REQUEST NUMBER(S): 20192309732


UTILITY COMPANY AT&T VERIZON COMCAST - PEMBROKE CENTURY LINK EVERSOURCE - ELECTRIC NATIONAL GRID GAS - BOSTON


UTILITIES:






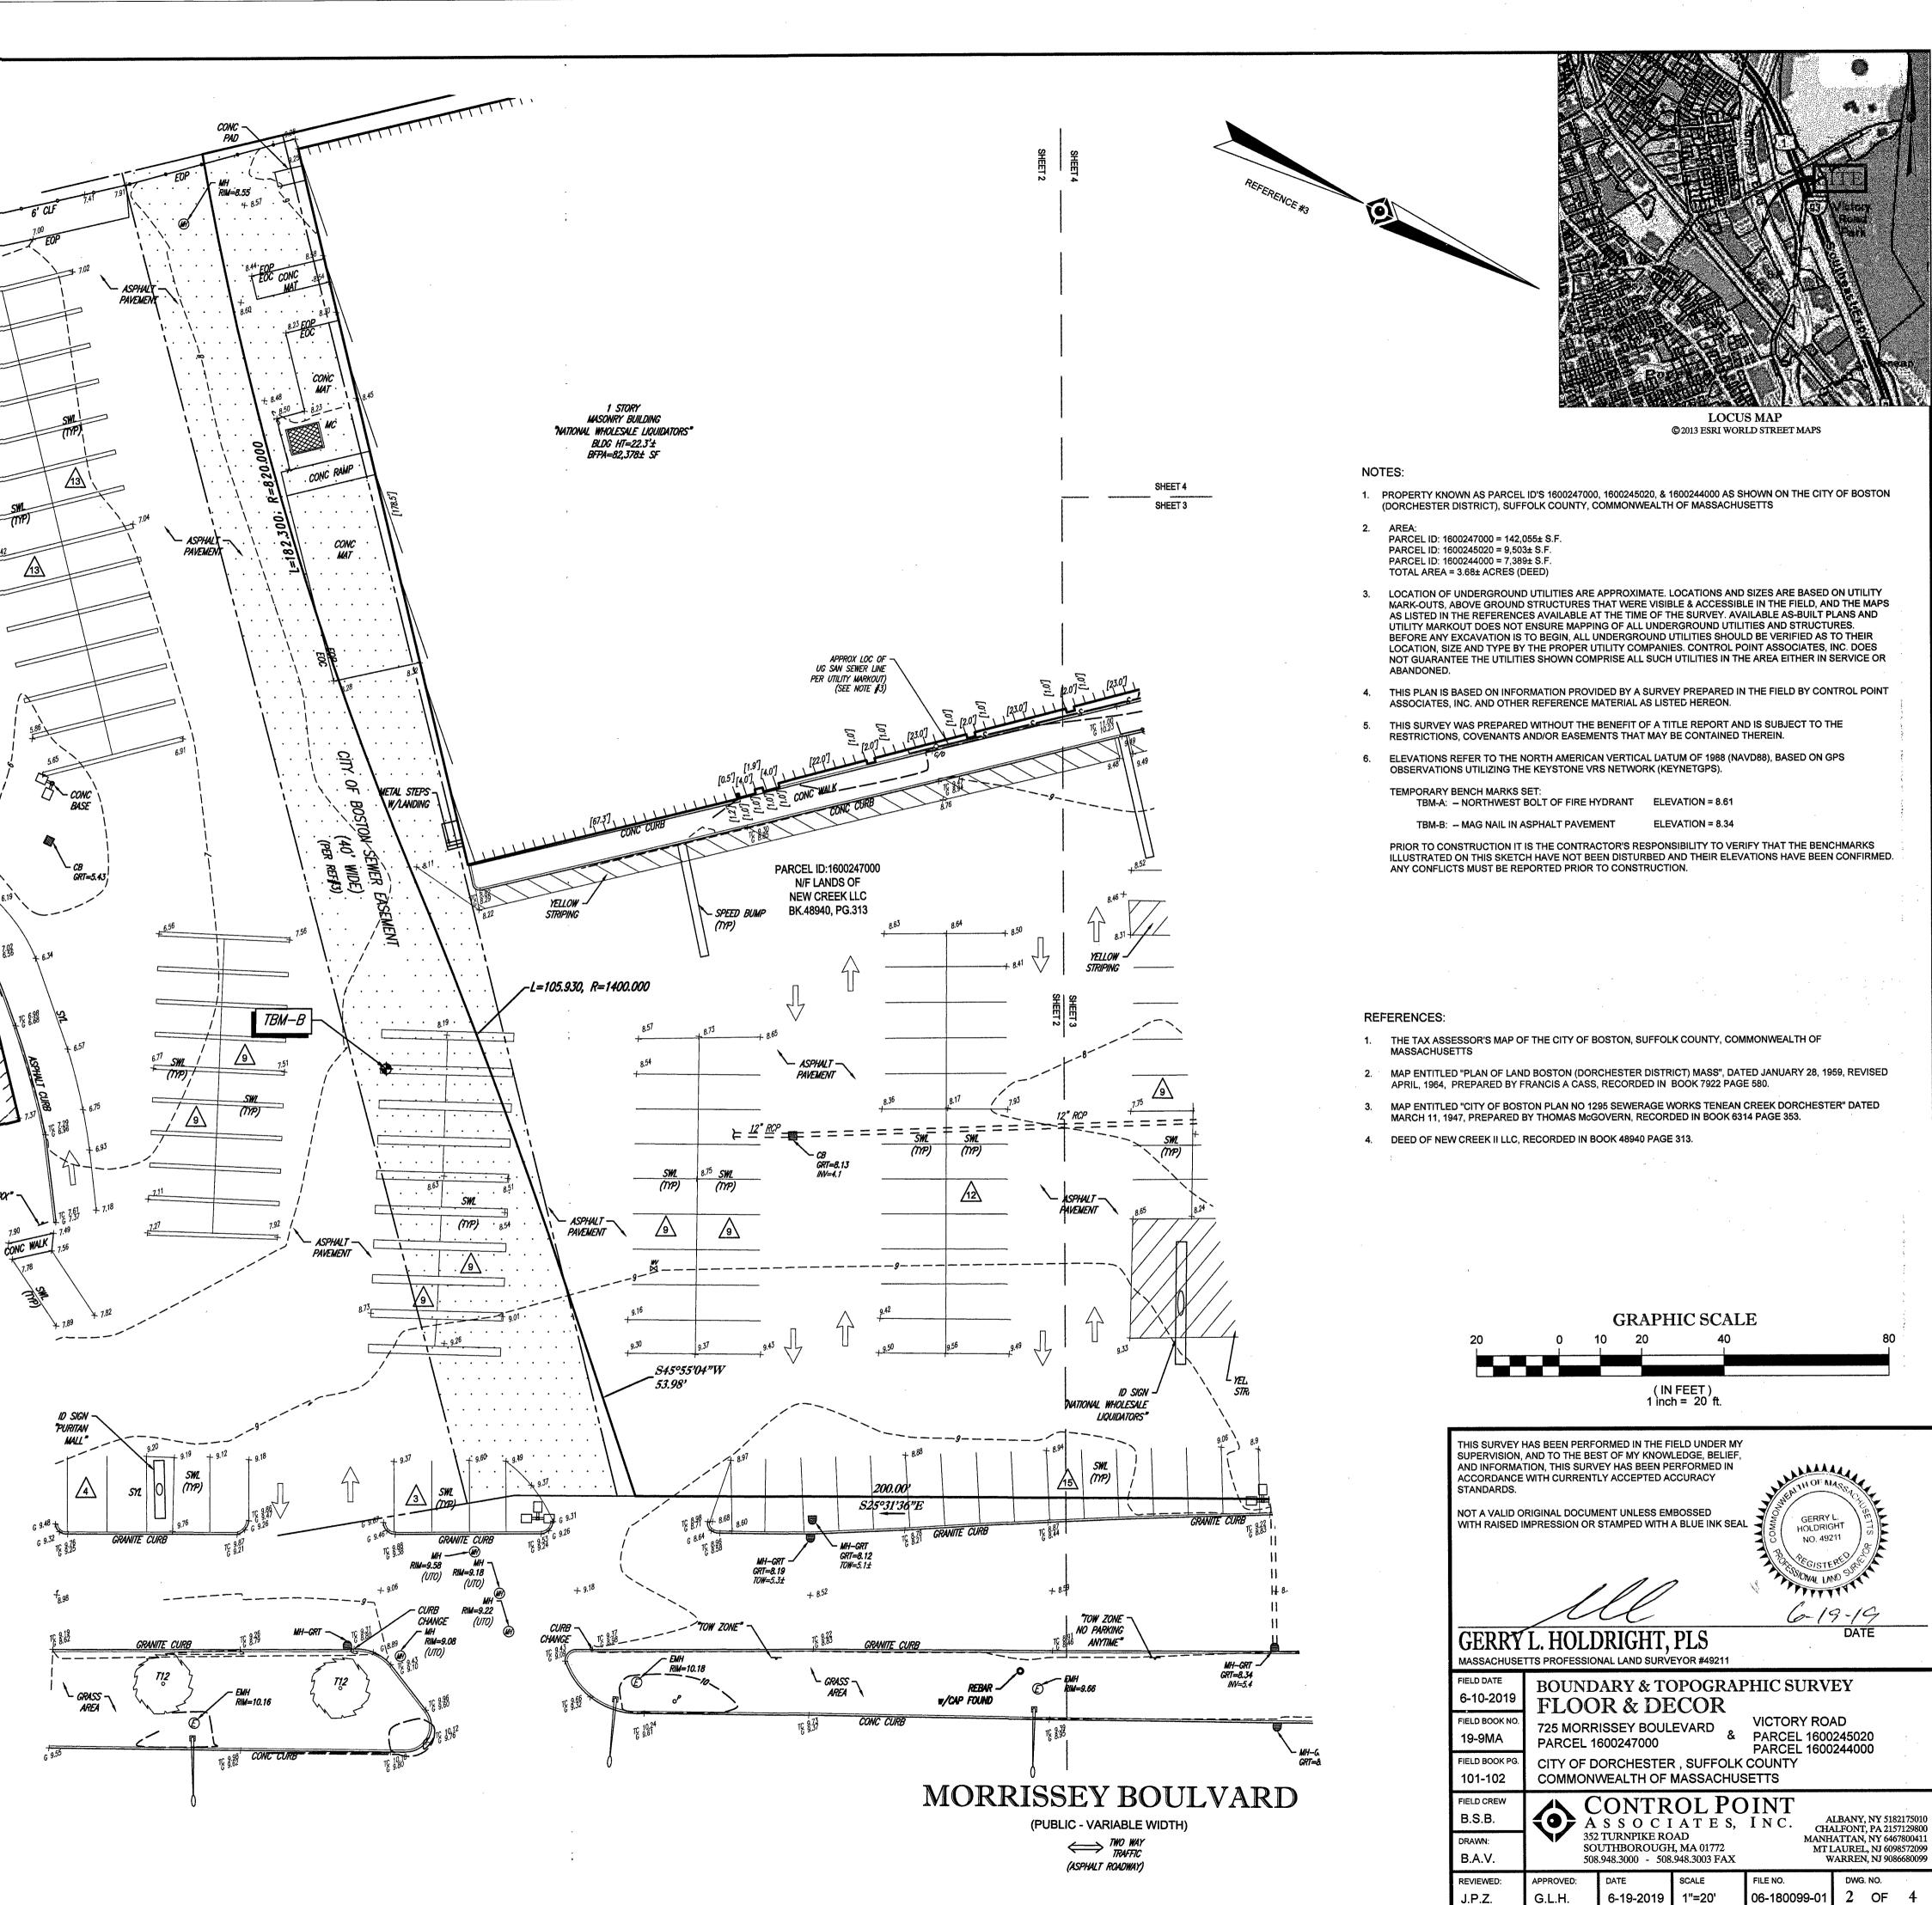

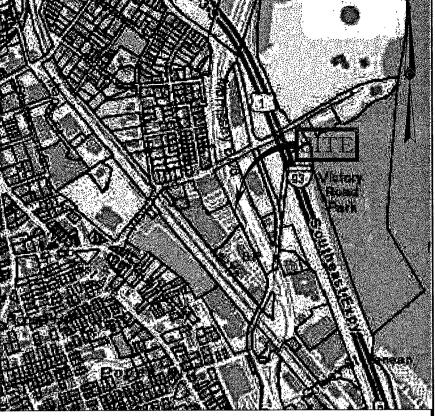

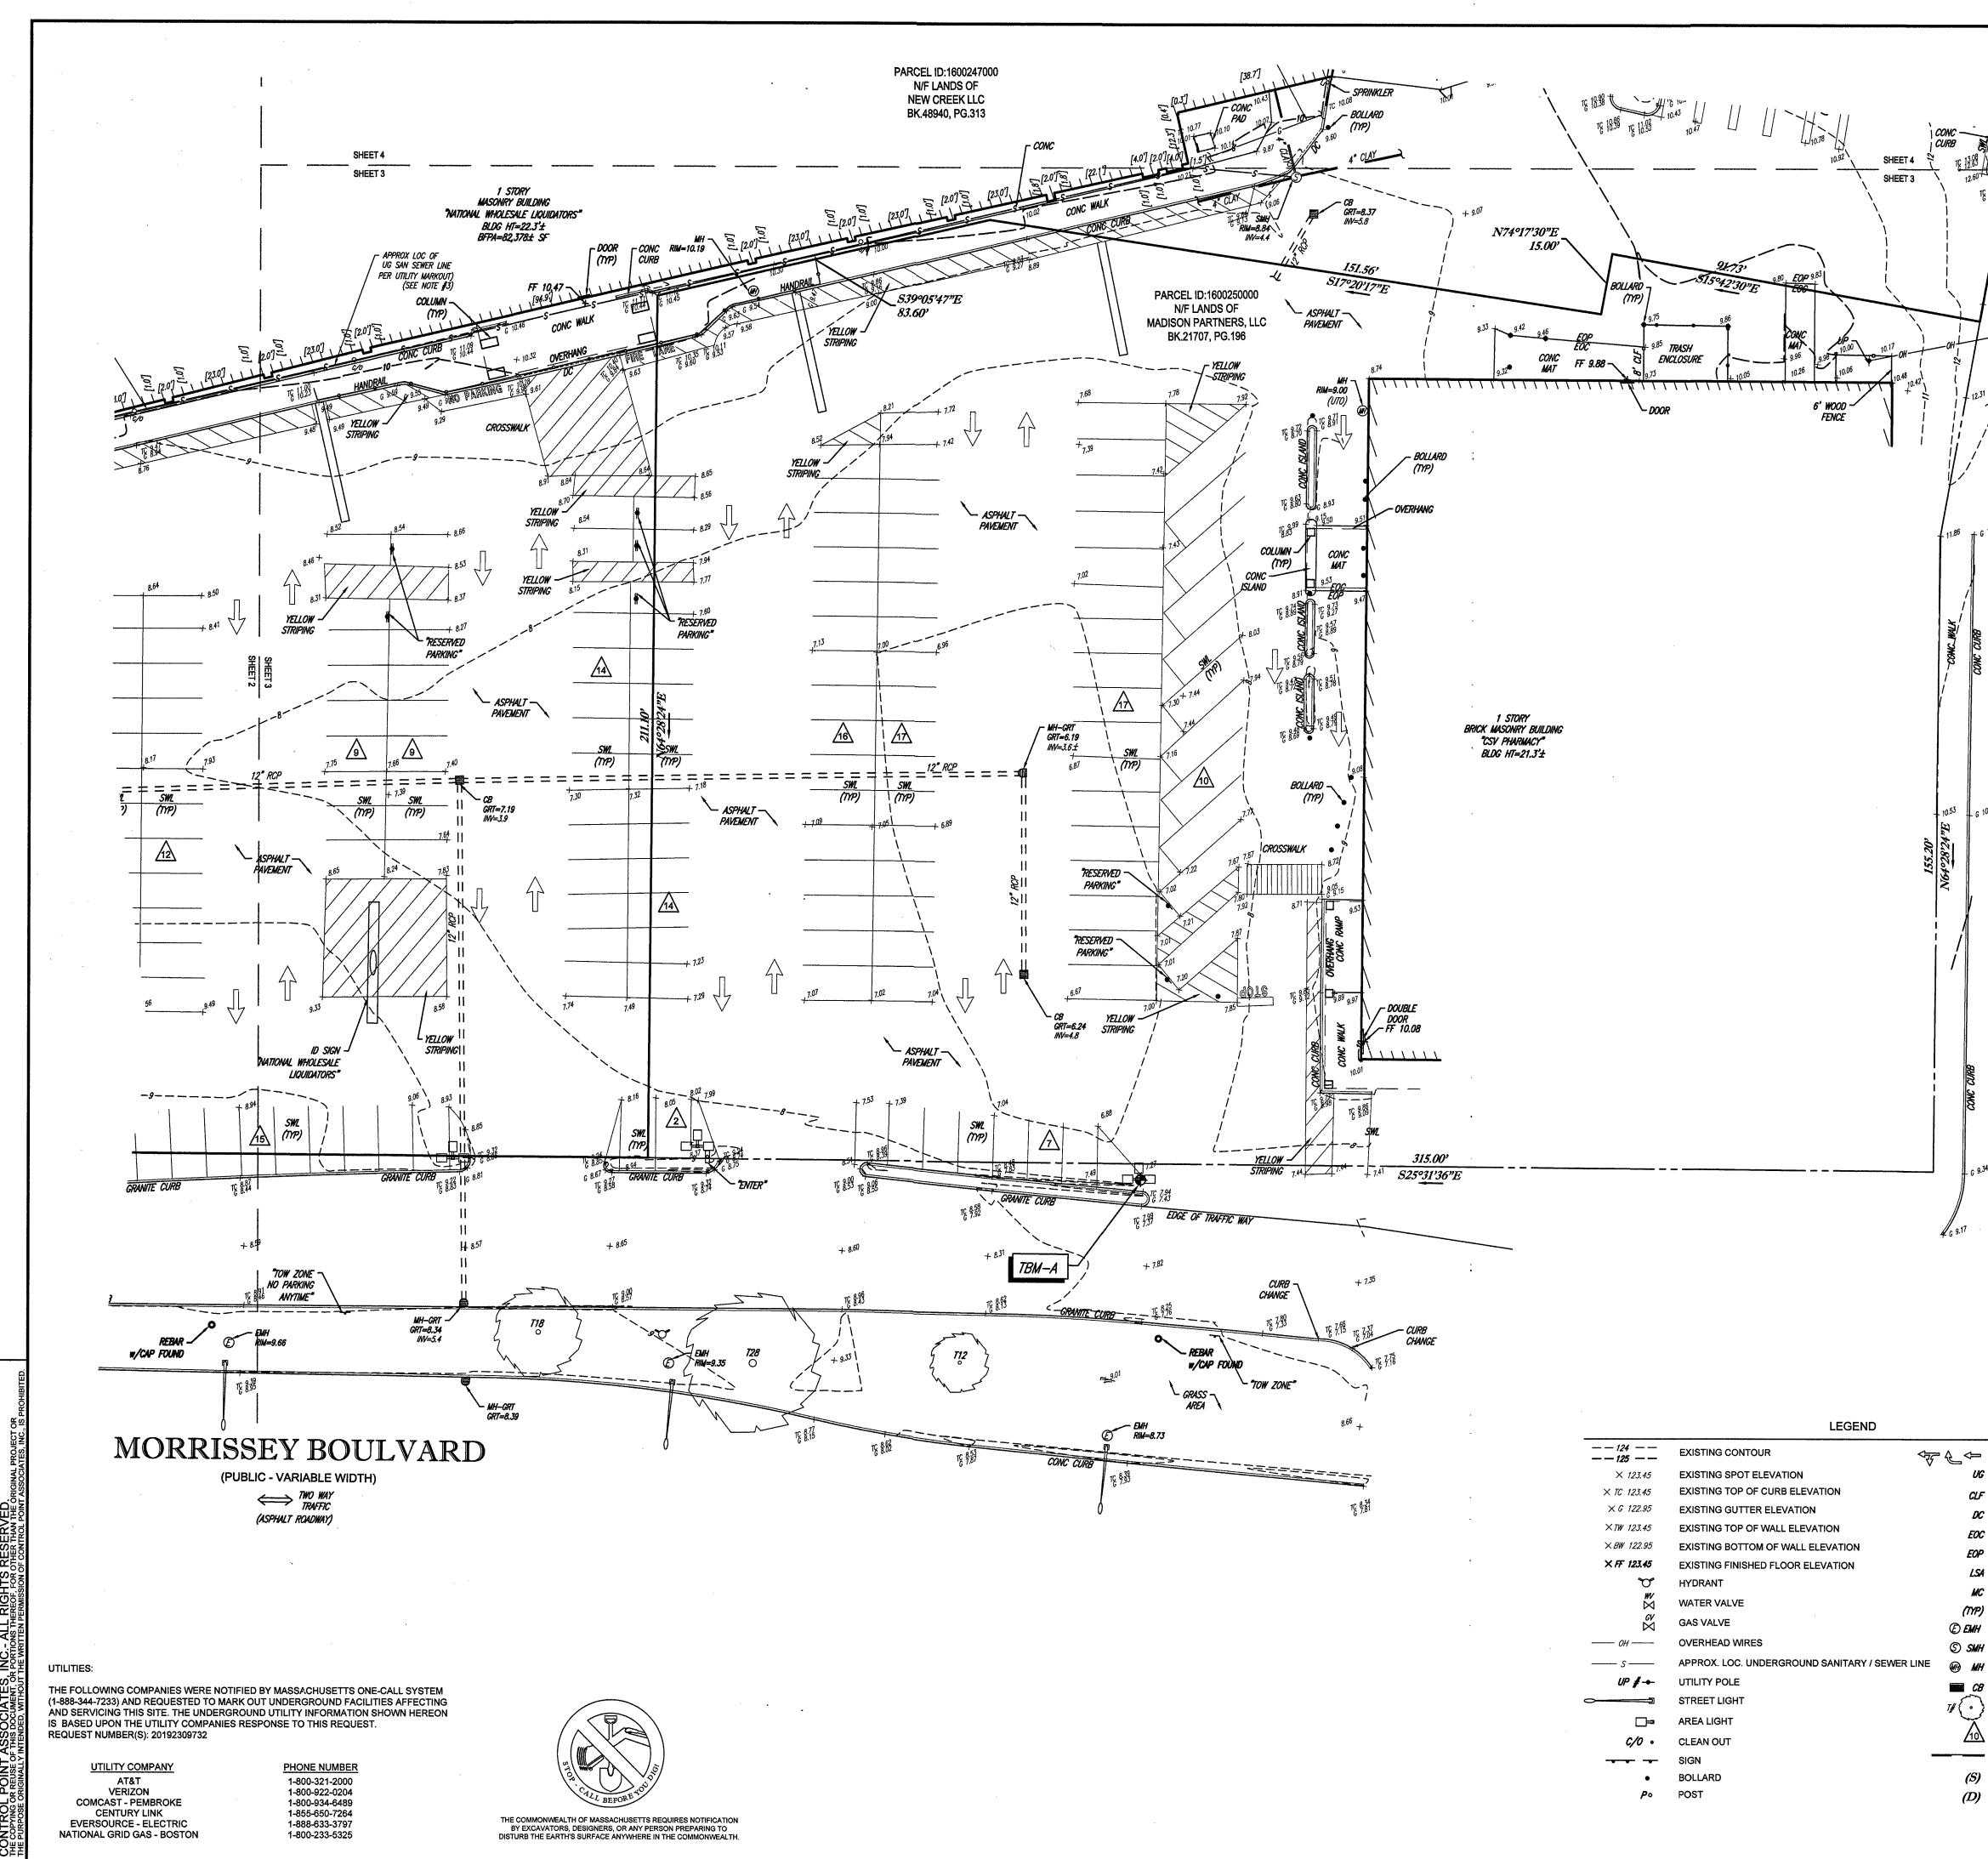

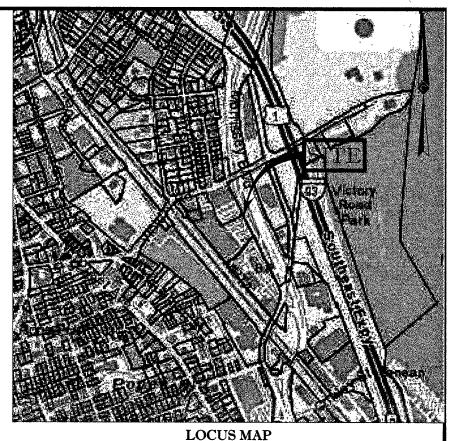

©2013 ESRI WORLD STREET MAPS

NOTES:

- 1. PROPERTY KNOWN AS PARCEL ID'S 1600247000, 1600245020, & 1600244000 AS SHOWN ON THE CITY OF BOSTON (DORCHESTER DISTRICT), SUFFOLK COUNTY, COMMONWEALTH OF MASSACHUSETTS
- 2. AREA: PARCEL ID: 1600247000 = 142,055± S.F. PARCEL ID: 1600245020 = 9,503± S.F. PARCEL ID: 1600244000 = 7,389± S.F. TOTAL AREA = 3.68± ACRES (DEED)
- 3. LOCATION OF UNDERGROUND UTILITIES ARE APPROXIMATE. LOCATIONS AND SIZES ARE BASED ON UTILITY MARK-OUTS, ABOVE GROUND STRUCTURES THAT WERE VISIBLE & ACCESSIBLE IN THE FIELD, AND THE MAPS AS LISTED IN THE REFERENCES AVAILABLE AT THE TIME OF THE SURVEY. AVAILABLE AS-BUILT PLANS AND UTILITY MARKOUT DOES NOT ENSURE MAPPING OF ALL UNDERGROUND UTILITIES AND STRUCTURES. BEFORE ANY EXCAVATION IS TO BEGIN, ALL UNDERGROUND UTILITIES SHOULD BE VERIFIED AS TO THEIR LOCATION, SIZE AND TYPE BY THE PROPER UTILITY COMPANIES. CONTROL POINT ASSOCIATES, INC. DOES NOT GUARANTEE THE UTILITIES SHOWN COMPRISE ALL SUCH UTILITIES IN THE AREA EITHER IN SERVICE OR ABANDONED.
- 4. THIS PLAN IS BASED ON INFORMATION PROVIDED BY A SURVEY PREPARED IN THE FIELD BY CONTROL POINT ASSOCIATES, INC. AND OTHER REFERENCE MATERIAL AS LISTED HEREON.
- 5. THIS SURVEY WAS PREPARED WITHOUT THE BENEFIT OF A TITLE REPORT AND IS SUBJECT TO THE RESTRICTIONS, COVENANTS AND/OR EASEMENTS THAT MAY BE CONTAINED THEREIN.
- 6. ELEVATIONS REFER TO THE NORTH AMERICAN VERTICAL DATUM OF 1988 (NAVD88), BASED ON GPS OBSERVATIONS UTILIZING THE KEYSTONE VRS NETWORK (KEYNETGPS).
  - TEMPORARY BENCH MARKS SET:
     TBM-A: NORTHWEST BOLT OF FIRE HYDRANT
     ELEVATION = 8.61

     TBM-B: MAG NAIL IN ASPHALT PAVEMENT
     ELEVATION = 8.34

PRIOR TO CONSTRUCTION IT IS THE CONTRACTOR'S RESPONSIBILITY TO VERIFY THAT THE BENCHMARKS ILLUSTRATED ON THIS SKETCH HAVE NOT BEEN DISTURBED AND THEIR ELEVATIONS HAVE BEEN CONFIRMED. ANY CONFLICTS MUST BE REPORTED PRIOR TO CONSTRUCTION.

REFERENCES:

1. THE TAX ASSESSOR'S MAP OF THE CITY OF BOSTON, SUFFOLK COUNTY, COMMONWEALTH OF MASSACHUSETTS

MARCH 11, 1947, PREPARED BY THOMAS McGOVERN, RECORDED IN BOOK 6314 PAGE 353.

- 2. MAP ENTITLED "PLAN OF LAND BOSTON (DORCHESTER DISTRICT) MASS", DATED JANUARY 28, 1959, REVISED APRIL, 1964, PREPARED BY FRANCIS A CASS, RECORDED IN BOOK 7922 PAGE 580.
- 3. MAP ENTITLED "CITY OF BOSTON PLAN NO 1295 SEWERAGE WORKS TENEAN CREEK DORCHESTER" DATED
- 4. DEED OF NEW CREEK II LLC, RECORDED IN BOOK 48940 PAGE 313.


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SUPERVISION AND INFORMA ACCORDANCE STANDARDS. NOT A VALID C	THIS SURVEY HAS BEEN PERFORMED IN THE FIELD UNDER MY SUPERVISION, AND TO THE BEST OF MY KNOWLEDGE, BELIEF, AND INFORMATION, THIS SURVEY HAS BEEN PERFORMED IN ACCORDANCE WITH CURRENTLY ACCEPTED ACCURACY STANDARDS. NOT A VALID ORIGINAL DOCUMENT UNLESS EMBOSSED WITH RAISED IMPRESSION OR STAMPED WITH A BLUE INK SEAL							
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	L. HOLI		,		DATE			
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FIELD BOOK PG.			R , SUFFOLK	COUNTY				
101-102	COMMON	WEALTH OF	MASSACHUS	SETTS	-			
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B.A.V.			8.948.3003 FAX		VARREN, NJ 9086680099			
REVIEWED:	APPROVED:	DATE	SCALE	FILE NO.	DWG. NO.			
J.P.Z.	G.L.H.	6-19-2019	1"=20'	06-180099-01	3 OF 4			


A PAINTED ARROWS UNDER GROUND CLF CHAIN LINK FENCE DEPRESSED CURB EDGE OF CONCRETE EDGE OF PAVEMENT EOP LSA LANDSCAPED AREA METAL COVER MC (TYP) TYPICAL ELECTRIC MANHOLE SANITARY/SEWER MANHOLE MH UNKNOWN MANHOLE CATCH BASIN OR INLET CR TREE & TRUNK SIZE PARKING SPACE COUNT DEPRESSED CURB SURVEY DIMENSION *(S)* (D) DEED DIMENSION


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OR





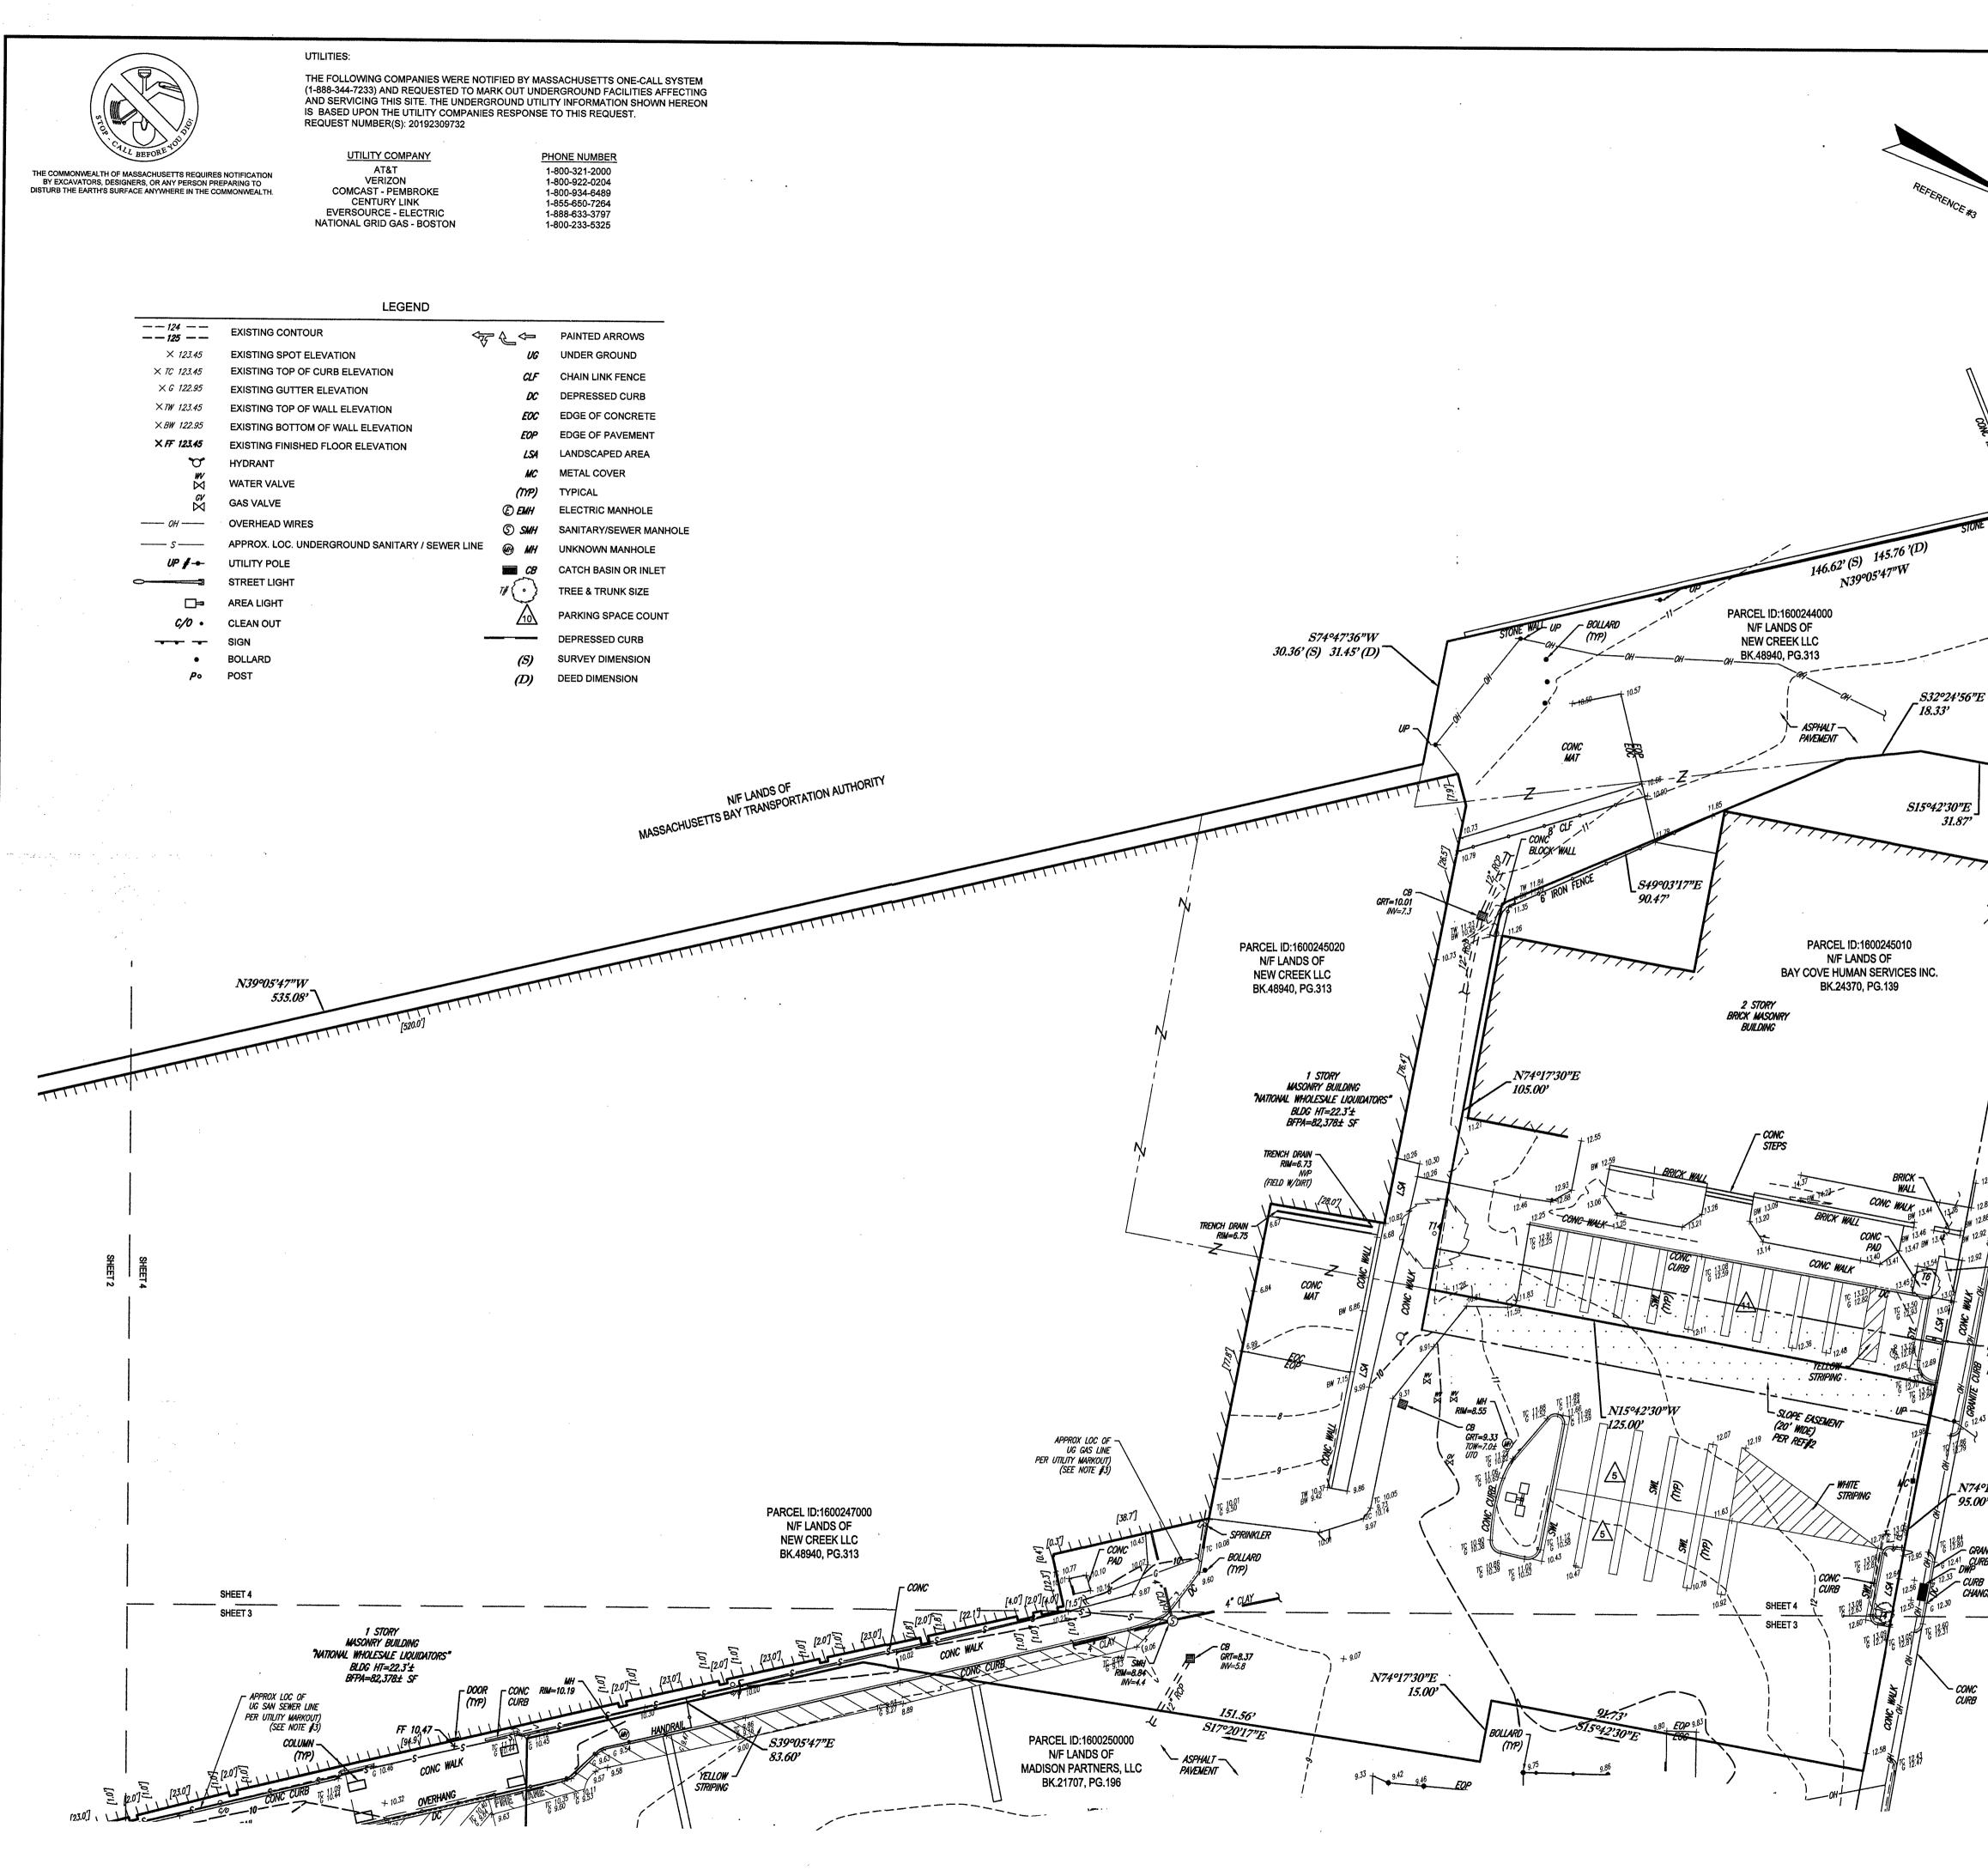

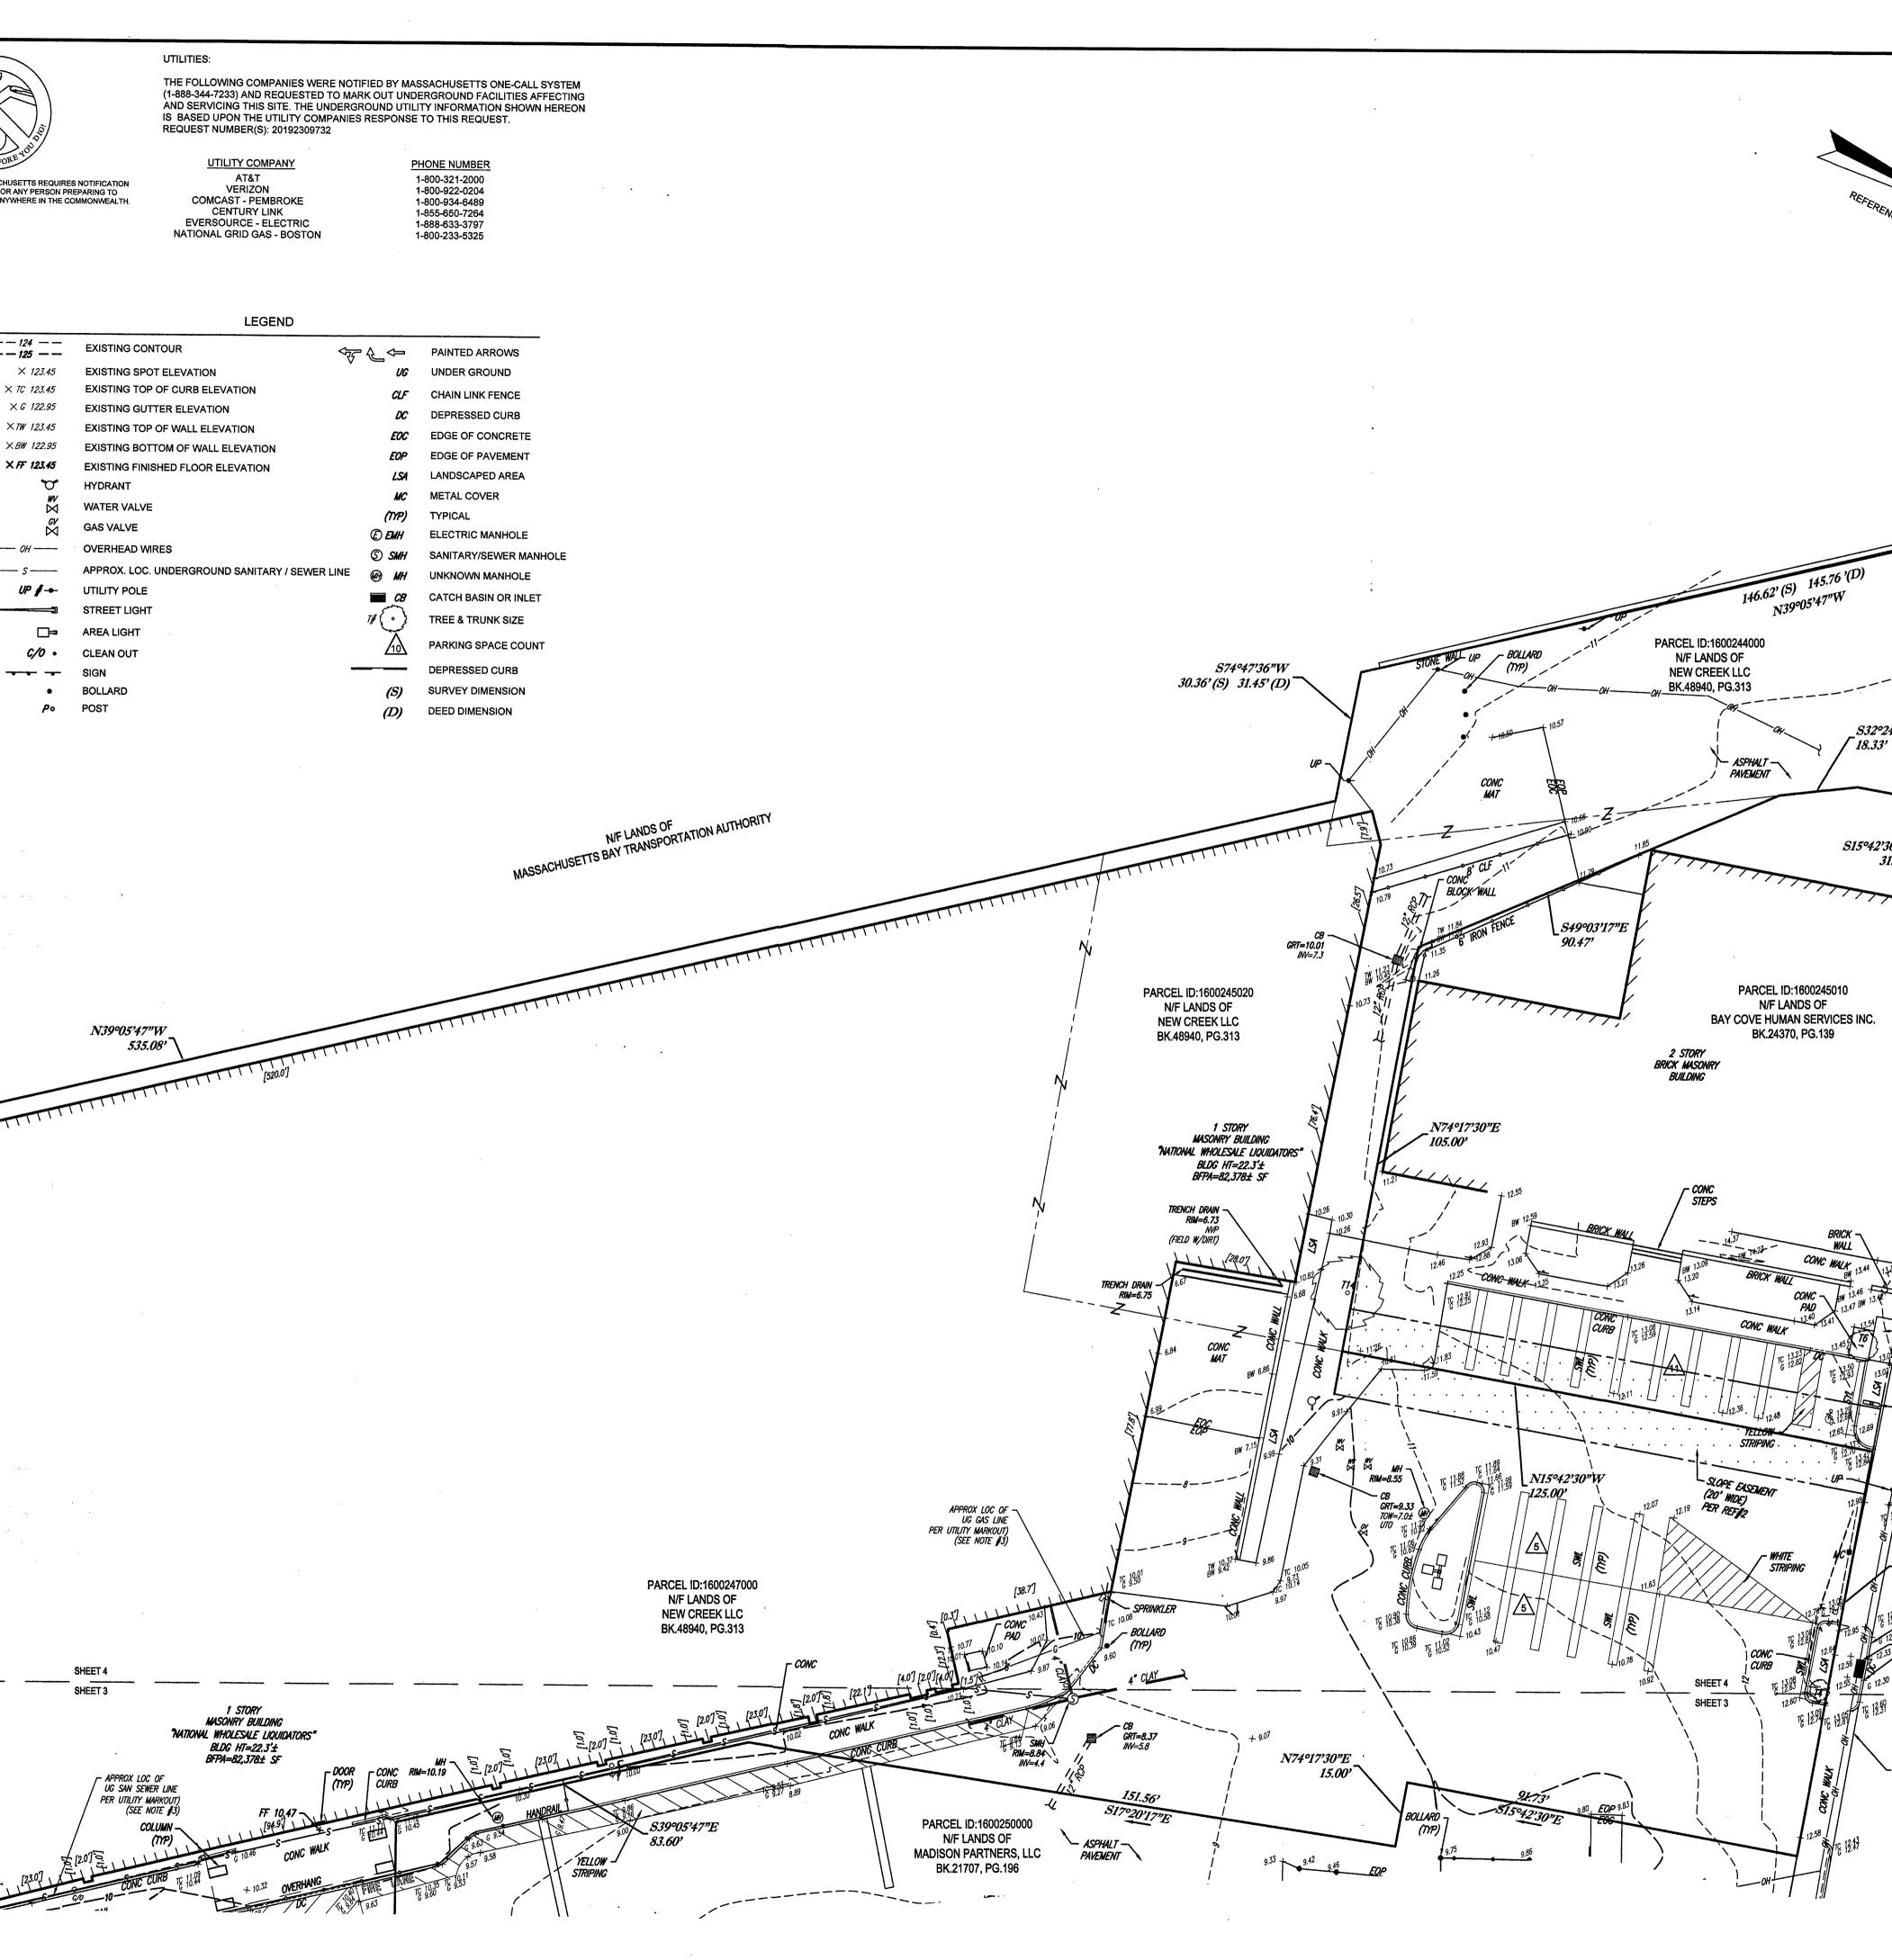LOCUS MAP © 2013 ESRI WORLD STREET MAPS
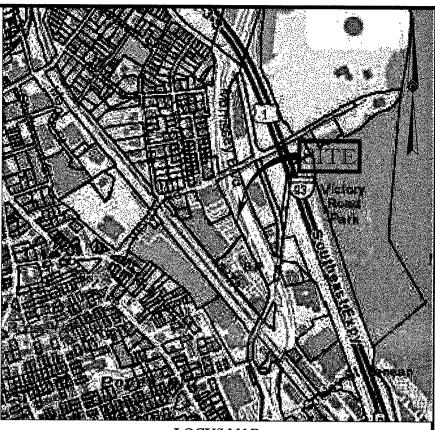
### NOTES:

E\*?

"SMALL WONDERS NURSERY SCHOOL"

N74°17'30"E

95.00°

GRANITE CURB

- 1. PROPERTY KNOWN AS PARCEL ID'S 1600247000, 1600245020, & 1600244000 AS SHOWN ON THE CITY OF BOSTON (DORCHESTER DISTRICT), SUFFOLK COUNTY, COMMONWEALTH OF MASSACHUSETTS 2. AREA:
- PARCEL ID: 1600247000 = 142,055± S.F. PARCEL ID: 1600245020 = 9,503± S.F. PARCEL ID: 1600244000 = 7,389± S.F.
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- 3. MAP ENTITLED "CITY OF BOSTON PLAN NO 1295 SEWERAGE WORKS TENEAN CREEK DORCHESTER" DATED
- MARCH 11, 1947, PREPARED BY THOMAS McGOVERN, RECORDED IN BOOK 6314 PAGE 353.
- 4. DEED OF NEW CREEK II LLC, RECORDED IN BOOK 48940 PAGE 313.

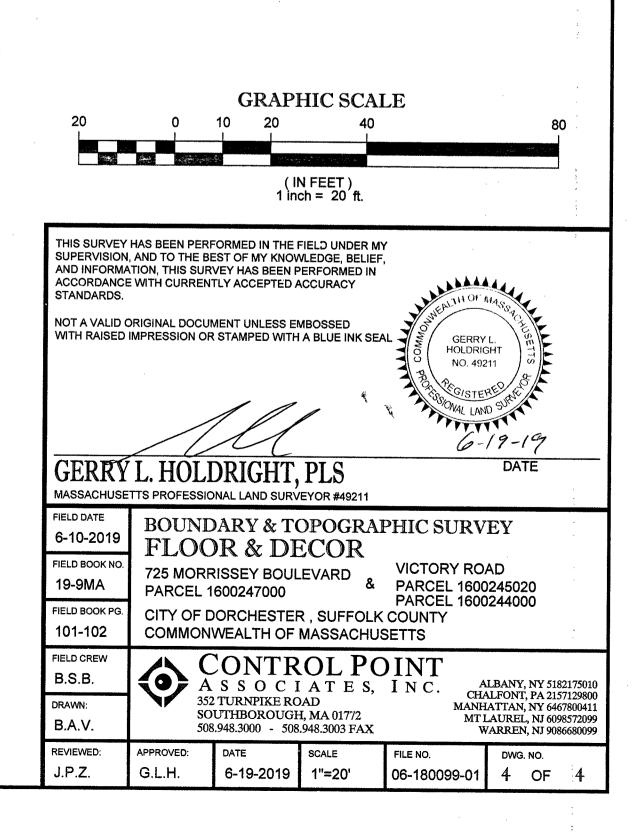


Figure 3.13 Aerial Exhibit



Figure 3.14 Concept Plan



Figure 3.15 Visual-Audible Signal Devices Overview

# **Audible Signal Devices**

# 


# 22.5 mm Panel-mount Electrical Buzzers

- Mount in 22.5 mm hole
- Fourteen models available
- Continuous and pulse-tone models
- 80 to 100 decibels
- Buzzer without sound output holes
- Low current consumption
- High IP 65 protection rating



#### DIMENSIONS mm [in]

#### **107 Series**

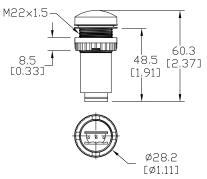


107 Series Buzzer Specifications							
Part Number	10700075	10700077	10701075	10701077			
Price	\$30.50	\$34.00	\$30.50	\$34.00			
Description		Buz	zer				
Voltage	24V AC/DC	115V AC/DC	24V AC/DC	115V AC/DC			
Current Consumption		≤ 8	mA				
Tone Frequency	ne Frequency 2.4 kHz						
Maximum Volume		80dB @	2 10cm				
Tone Type	Contir	nuous	Pulse, ap	prox.1Hz			
Life Duration		> 50	00h				
<b>Operating Temperature</b>		-4°F to 122°F [	-20°C to 50°C]				
Protection		IP	65				
Weight		30g [1	.06 oz]				
Housing Material	Polyamide-Fiberglass						
Connection	Connector with max. wire 1.5 mm <sup>2</sup> (16AWG), 0.3 N torque						
Agency Approvals		cULus file E164	1155, CE, RoHS				

To obtain the most current agency approval information, see the Agency Approval Checklist section on the specific part number's web page at www.AutomationDirect.com



#### DIMENSIONS mm [in]

#### **109 Series**

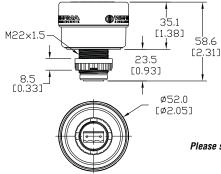

109 Series Buzzer Specifications								
Part Number	10900075	10900077	10901075	10901077				
Price	\$62.00	\$69.00	\$62.00	\$69.00				
Description		Buz	zzer					
Voltage	24V AC/DC	115V AC/DC	24V AC/DC	115V AC/DC				
Current Consumption		≤ 25	5mA					
Tone Frequency	2.1 kHz							
Maximum Volume	80dB @ 1m							
Tone Type	Conti	nuous	Pulse, ap	approx. 1Hz				
Life Duration		> 50	000h					
Operating Temperature	-4°F to 122°F [-20°C to 50°C]							
Protection		IP65						
Weight	44g [1.55 oz]	47g [1.66 oz]	44g [1.55 oz]	47g [1.66 oz]				
Housing Material		Polycarbonate (F	PC)/ABS, (black)					
Connection	Connector with max. wire 1.5 mm <sup>2</sup> (16AWG), 0.3 N torque							
Agency Approvals		cULus file E164	1155, CE, RoHS					

Please see our website www.AutomationDirect.com for complete engineering drawings.

SIGNALTECHNIK

# **Audible Signal Devices**

# 22.5 mm Panel-mount Electrical Buzzers




#### Buzzer without sound output holes

- Mount in 22.5 mm hole
- 8 selectable tones
- Adjustable volume, 100 decibels
   maximum at one meter

#### DIMENSIONS mm [inches]

#### **110 Series**

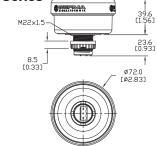




- Mount in 22.5 mm hole
- LED permanent light indicator
- Continuous tone
- Simple con with connector plug
- 80 decibels volume at one meter

#### **DIMENSIONS** mm [inches]

#### **150 Series**

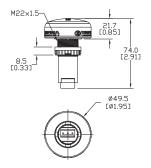




110 Series Buzzer Specifications					
Part Number	11000067	11000075			
Price	\$104.00	\$94.00			
Description	Buzzer Element with selectable tones				
Voltage	115VAC	24V AC/DC			
Current Consumption	$\leq$ 40mA	$\leq$ 80mA			
Tone Frequency	1.6 and 3.4 kHz				
Maximum Volume	100dB @ 1m				
Tone Type	Multi-tonal, 8 selectable tones				
Life Duration	> 5000h				
<b>Operating Temperature</b>	-4°F to 122°F [-20°C to 50°C]				
Protection	IP65				
Weight	79g [2.79 oz]	64g [2.26 oz]			
Housing Material	Polycarbonate (PC)/ABS				
Connection	Connector with max. wire 1.5 mm <sup>2</sup> (16AWG), 0.3 N torque				
Agency Approvals	cULus file E164155, CE, RoHS				

Note: Refer to insert for available tones.

To obtain the most current agency approval information, see the Agency Approval Checklist section on the specific part number's web page at www.AutomationDirect.com

150 Series Buzzer with LED Indicator Specifications					
Part Number	15010055	15010067	15030055	15030067	
Price	\$73.00	\$80.00	\$73.00	\$80.00	
Description	Buzzer element with LED indicator				
LED Indicator	Red		Yellow		
Voltage	24VDC	115VAC	24VDC	115VAC	
Current Consumption	$\leq$ 50mA	$\leq$ 20mA	$\leq$ 50mA	$\leq$ 20mA	
Tone Frequency	2.8 kHz				
Maximum Volume	80dB @ 1m				
Tone Type	Continuous				
Life Duration	Up to 50,000h				
<b>Operating Temperature</b>	-4°F to 122°F [-20°C to 50°C]				
Protection	IP65				
Weight	30g [1.06 oz]	30g [1.06 oz]	30g [1.06 oz]	30g [1.06 oz]	
Housing Material	Cap: Polycarbonate. Base: Polycarbonate (PC)ABS - black				
Connection	Connector with max. wire 1.5 mm <sup>2</sup> (16AWG), 0.3 N torque				
Agency Approvals	cULus file E164155, CE, RoHS				

#### Wiring Diagram

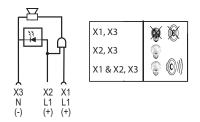

Please see our website www.AutomationDirect.com for complete engineering drawings.

Note: Buzzer will not sound without light energized.

Figure 3.16 Conceptual Rendering Looking South on William T. Morrissey Boulevard



# EXTERIOR FINISH LEGEND




(P-8) STO COLOR: SW-7044 AMAZING GRAY PAINT: #80217 STOCOLOR LOTUSAN LOW VOC (P-9) STO COLOR: NA17-0030 URBANE BRONZE PAINT: #80217 STOCOLOR LOTUSAN LOW VOC (P-10) SHERWIN WILLIAMS 6868 "REAL RED" METAL TO BE PAINTED WITH "DIRECT TO METAL" (DMT) PAINT

SIGNAGE SHOWN FOR REFERENCE ONLY. SIGNAGE SIZE AND LOCATIONS SUBJECT TO CODE REVIEW.

DOOR LOCATIONS SUBJECT TO FIRE MARSHAL APPROVAL.



Figure 3.17 Exterior Elevations Plan

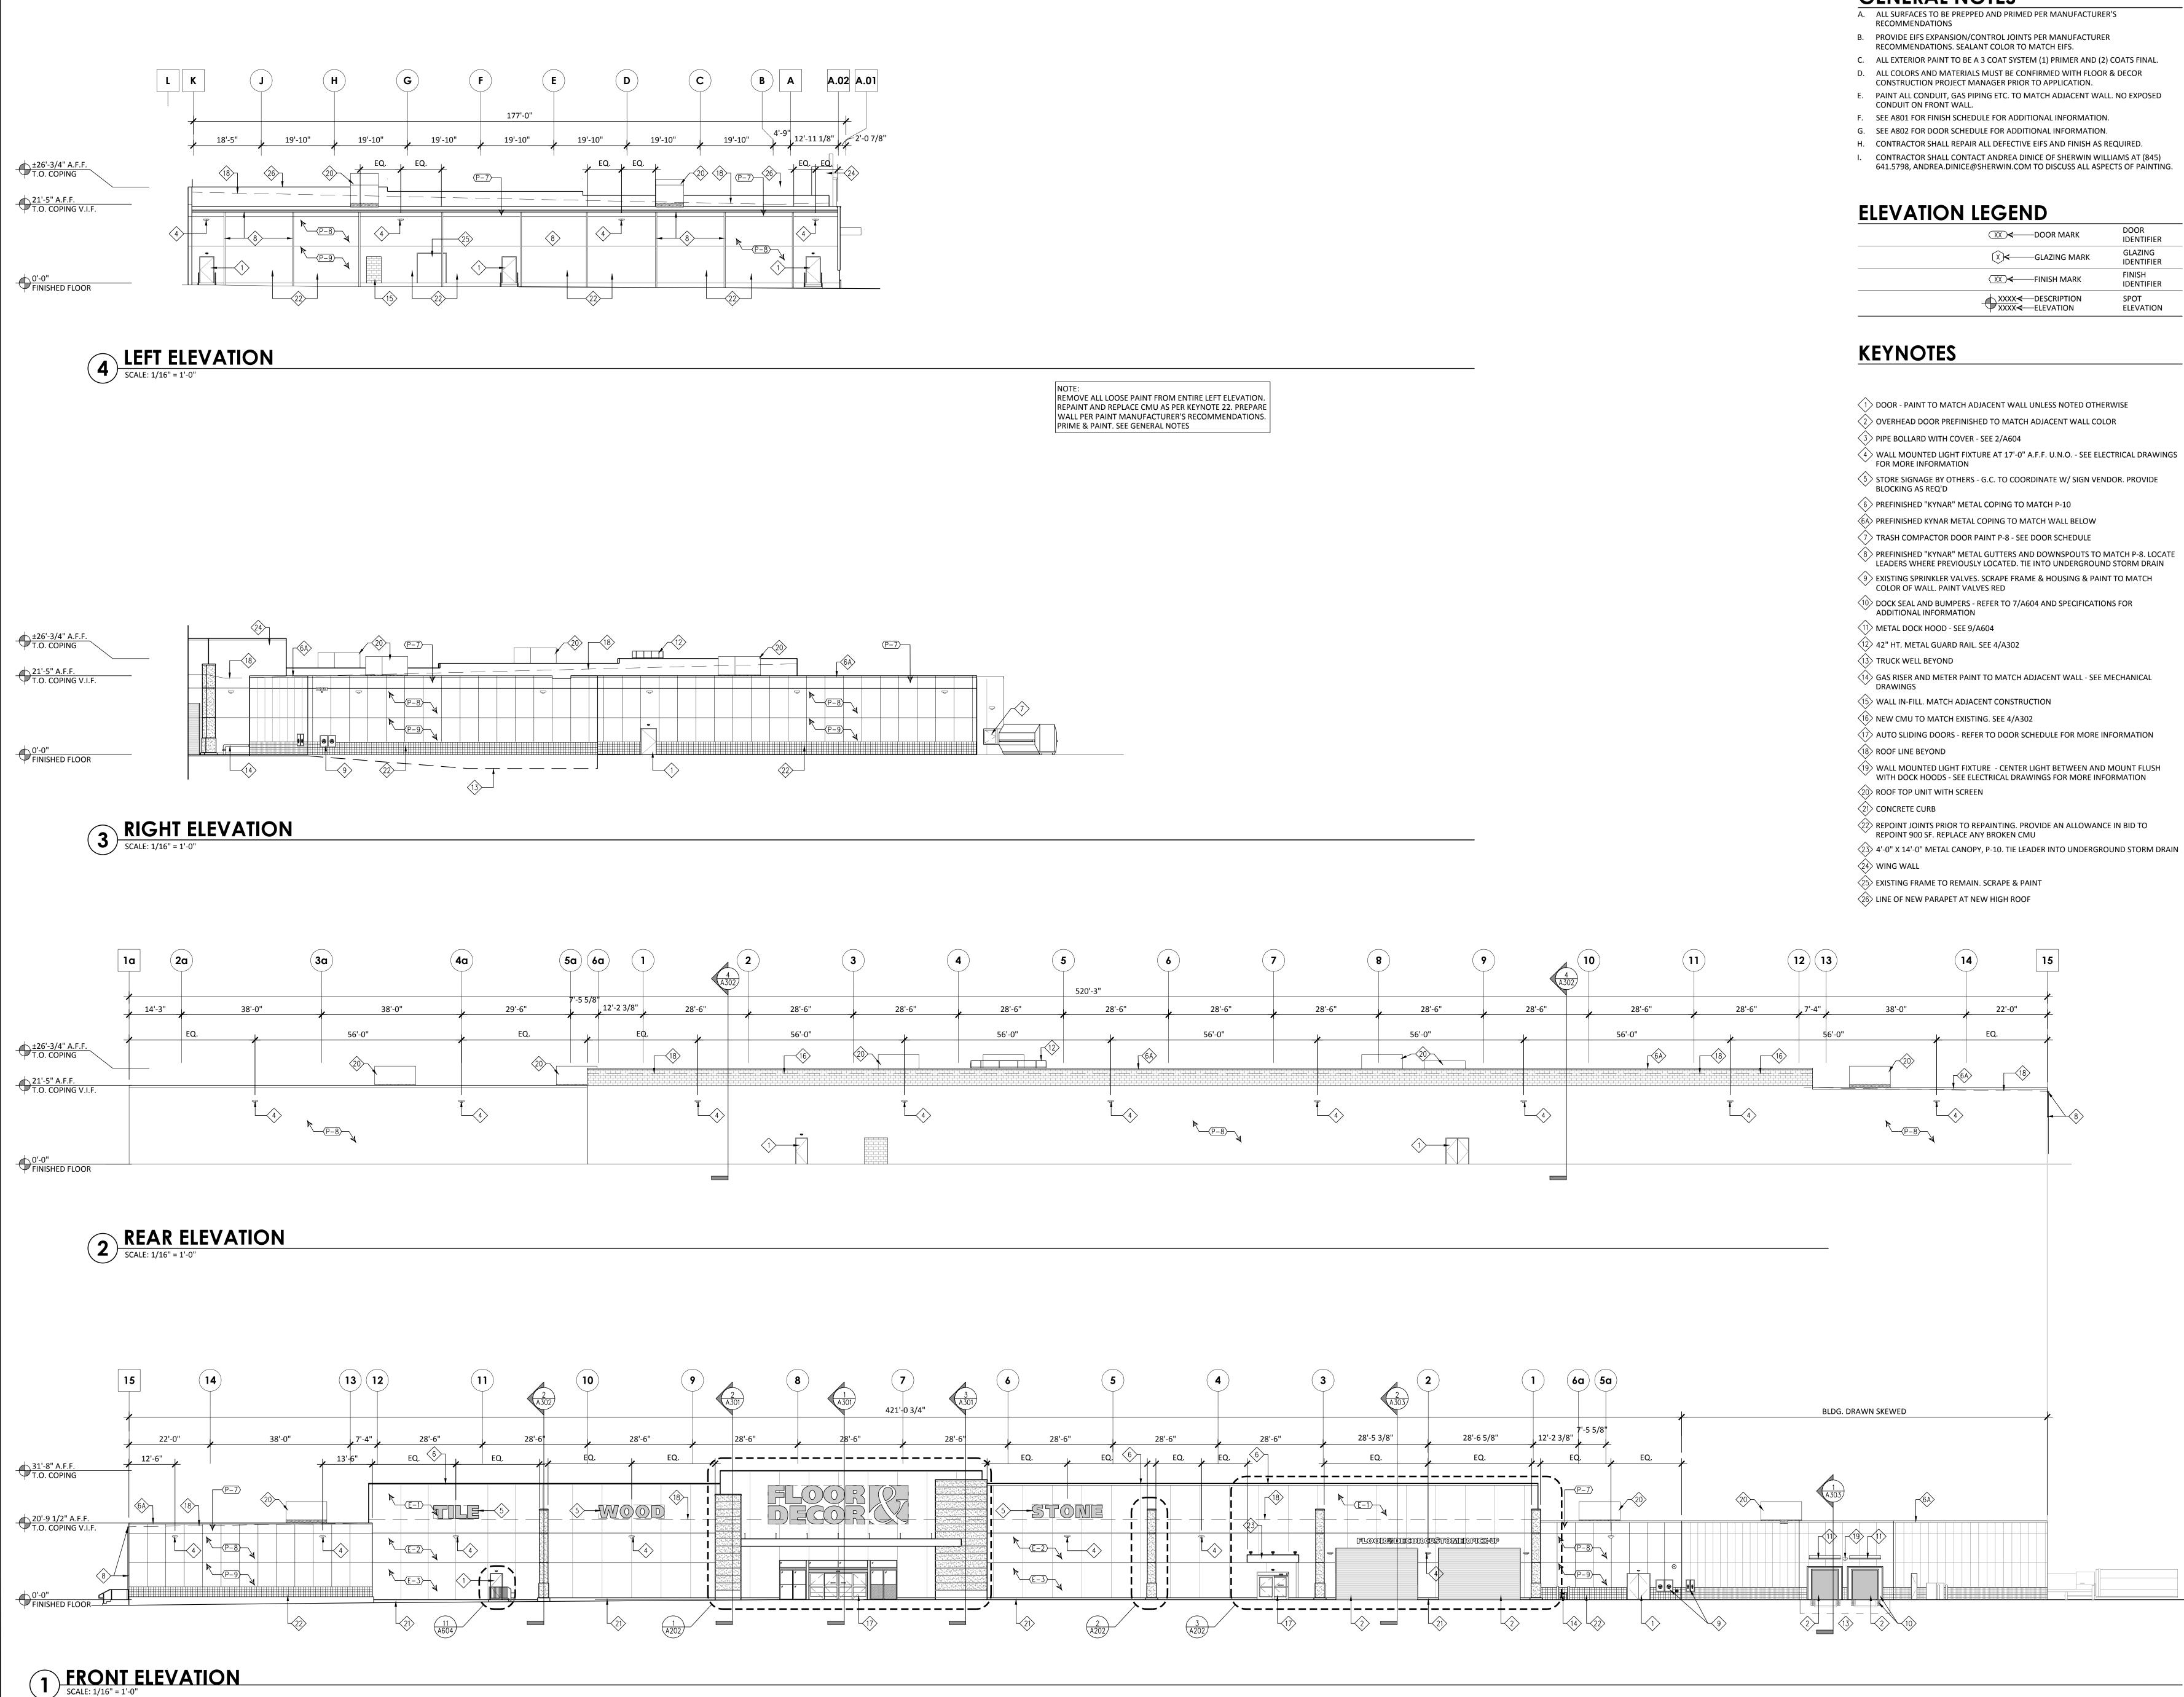

## **GENERAL NOTES**

- A. ALL SURFACES TO BE PREPPED AND PRIMED PER MANUFACTURER'S
- B. PROVIDE EIFS EXPANSION/CONTROL JOINTS PER MANUFACTURER
- D. ALL COLORS AND MATERIALS MUST BE CONFIRMED WITH FLOOR & DECOR
- F. SEE A801 FOR FINISH SCHEDULE FOR ADDITIONAL INFORMATION.
- I. CONTRACTOR SHALL CONTACT ANDREA DINICE OF SHERWIN WILLIAMS AT (845)

(XX) ← FINISH MARK	
→ XXXX → XXXX → DESCRIPTION XXXX ← ELEVATION	

- (1) DOOR PAINT TO MATCH ADJACENT WALL UNLESS NOTED OTHERWISE
- 4 WALL MOUNTED LIGHT FIXTURE AT 17'-0" A.F.F. U.N.O. SEE ELECTRICAL DRAWINGS

- LEADERS WHERE PREVIOUSLY LOCATED. TIE INTO UNDERGROUND STORM DRAIN
- 0 DOCK SEAL AND BUMPERS REFER TO 7/A604 AND SPECIFICATIONS FOR

- (14) GAS RISER AND METER PAINT TO MATCH ADJACENT WALL SEE MECHANICAL

- 22 REPOINT JOINTS PRIOR TO REPAINTING. PROVIDE AN ALLOWANCE IN BID TO


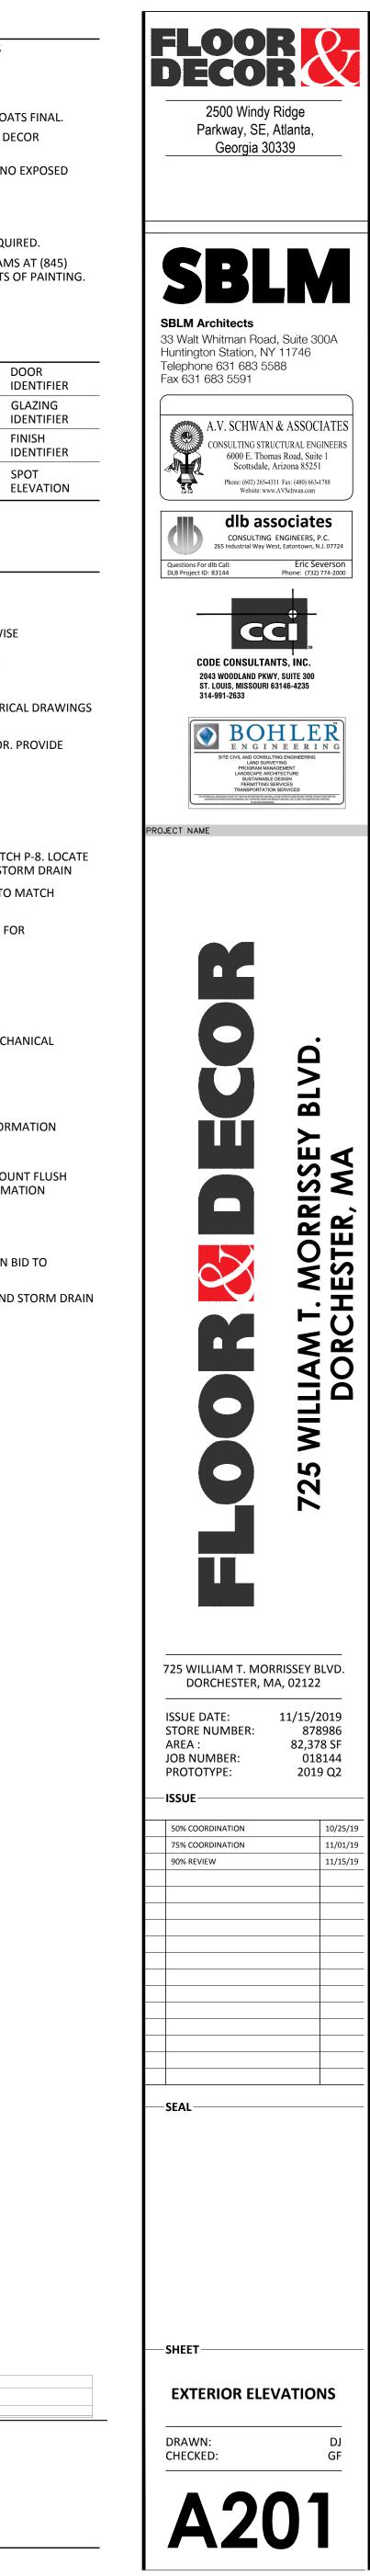


Figure 3.18 Exterior Elevations Rendering



STOME			
	FLOORADEGORGUE	TOMERRICKUP	

# EXTERIOR FINISH LEGEND

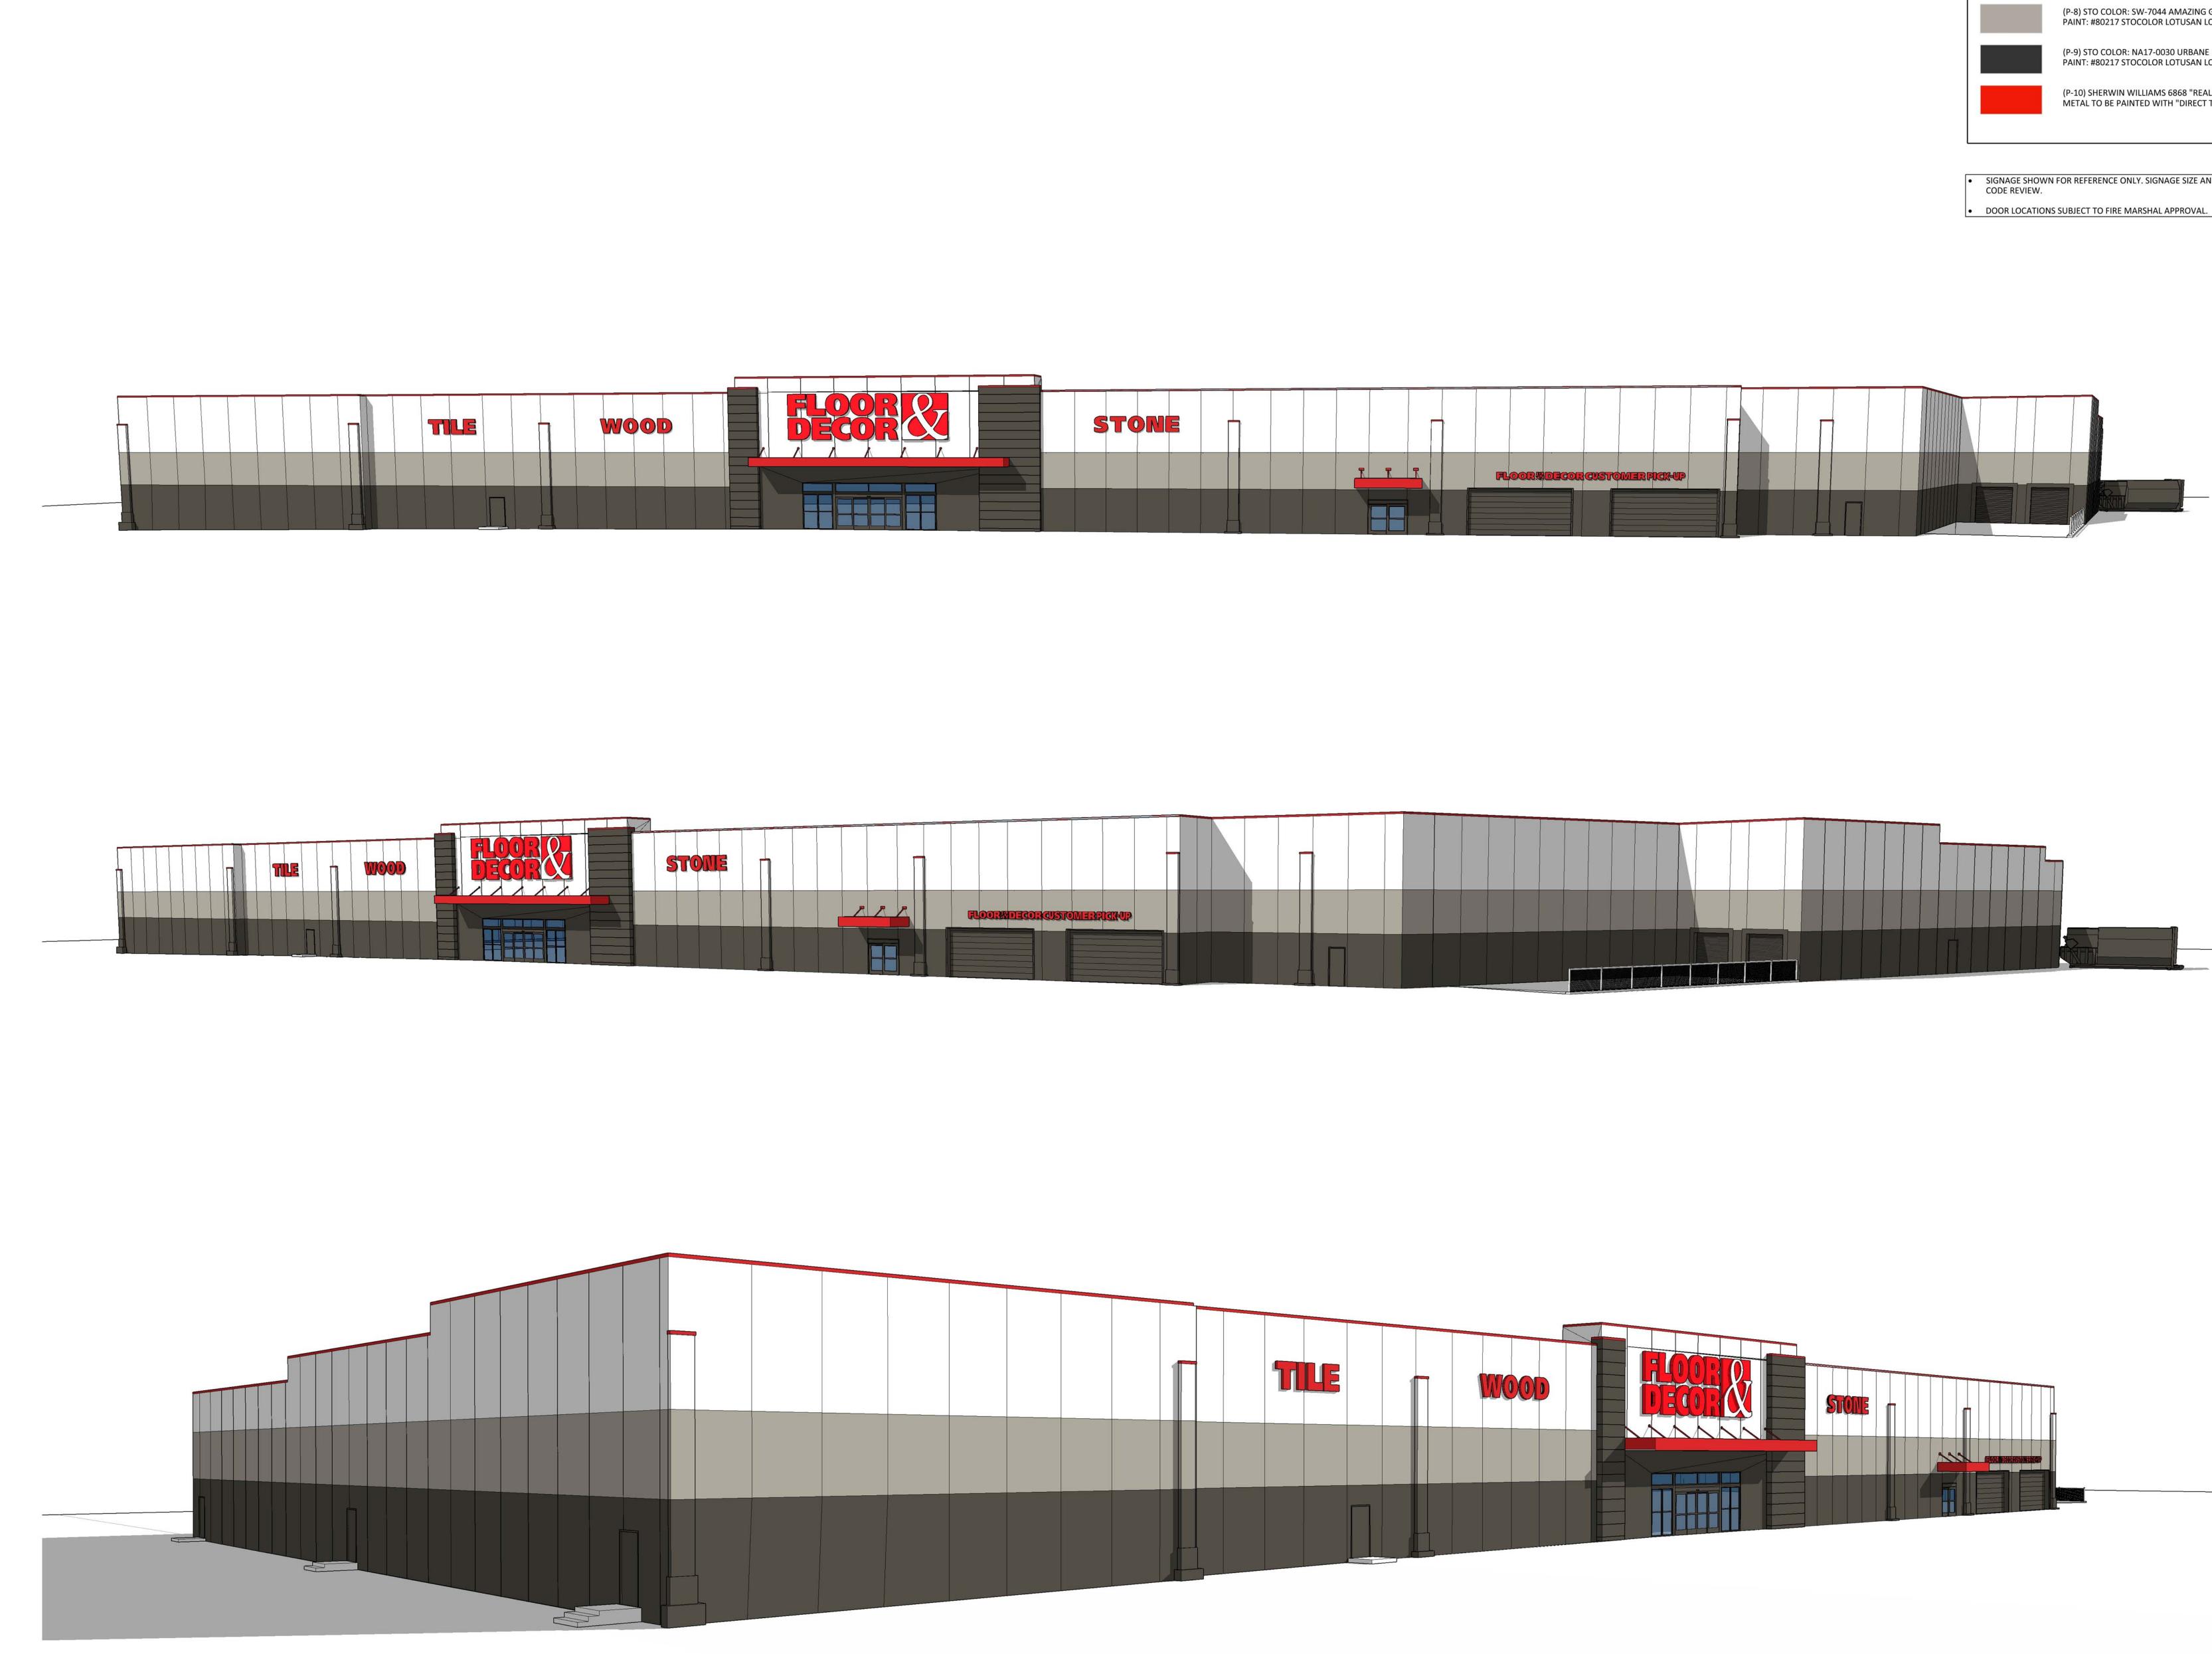


(P-8) STO COLOR: SW-7044 AMAZING GRAY PAINT: #80217 STOCOLOR LOTUSAN LOW VOC (P-9) STO COLOR: NA17-0030 URBANE BRONZE PAINT: #80217 STOCOLOR LOTUSAN LOW VOC

(P-10) SHERWIN WILLIAMS 6868 "REAL RED" METAL TO BE PAINTED WITH "DIRECT TO METAL" (DMT) PAINT

SIGNAGE SHOWN FOR REFERENCE ONLY. SIGNAGE SIZE AND LOCATIONS SUBJECT TO CODE REVIEW.



Figure 3.19 Morrissey Boulevard Improvements Exhibit

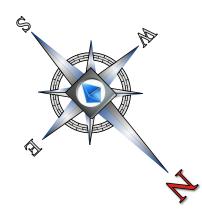

J. (They ALL STREET THE PULLING



REVISIONS         REV       DATE       COMMENT       BY         1					
2					
3					
4					
5					
7					
8					
9					
11       11         12       13         13       14         15       15         PROJECT NO.:         W191100         DRAWN BY:         CHECKED BY:         AFT         DATE:         OTHER CONCEPT         PROJECT NO.:         W191106         DRAWN BY:         SCALE:         OTHER         OTHER         OTHER         DEVELOPMENT         PROJECT:         SITE         DEVELOPMENT         PLANS         FOR					
12       13         13       14         15       15         PROJECT NO.:         W191106         DRAWN BY:         EKR         CHECKED BY:         AFT         DATE:         DATE:         SCALE:         STEE         DEVELOPMENT         PROJECT:         SITE         DEVELOPMENT         PLANS         FOR					
13       14         14       15         15       14         15       15         DRAWN BY:       EKR         CHECKED BY:       AFT         DATE:       11/13/2019         SCALE:       AS NOTED         CAD I.D.:       W191106 MORRISSEY CONCEPT         PROJECT:       SITE         DEVELOPMENT       PLANS         FOR       FOR					
14       15         15       15         PROJECT NO.: W191106         DRAWN BY:       EKR         CHECKED BY:       AFT         DATE:       11/13/2019         SCALE:       AS NOTED         CAD I.D.:       W191106 MORRISSEY CONCEPT         PROJECT:       SITE         DEVELOPMENT         PLANS         FOR					
PROJECT NO.: W191100 DRAWN BY: EKR CHECKED BY: AFT DATE: 11/13/2019 SCALE: AS NOTED CAD I.D.: W191106 MORRISSEY CONCEPT PROJECT: SITE DEVELOPMENT PLANS FOR					
PROJECT No.: W191106 DRAWN BY: EKR CHECKED BY: AFT DATE: 11/13/2019 SCALE: AS NOTED CAD I.D.: W191106 MORRISSEY CONCEPT PROJECT: SITE DEVELOPMENT PLANS FOR-					
PROJECT No.: W191106 DRAWN BY: EKR CHECKED BY: AFT DATE: 11/13/2019 SCALE: AS NOTED CAD I.D.: W191106 MORRISSEY CONCEPT PROJECT: SITE DEVELOPMENT PLANS FOR-					
DRAWN BY: EKR CHECKED BY: AFT DATE: 11/13/2019 SCALE: AS NOTED CAD I.D.: W191106 MORRISSEY CONCEPT PROJECT: SITE DEVELOPMENT PLANS FOR-					
DATE: 11/13/2019 SCALE: AS NOTED CAD I.D.: W191106 MORRISSEY CONCEPT PROJECT: SITE DEVELOPMENT PLANS FOR- FOR-					
PROJECT: SITE DEVELOPMENT PLANS FOR FOR					
DEVELOPMENT PLANS FOR					
INTEGRATED SOLUTIONS					
INTEGRATED SOLUTIONS					
FLOOR CON OF SITE					
LOCATION OF SITE PARCEL ID: 1600247000 & 160024502 725 WILLIAM T. MORRISSEY BOULEVARD CITY OF BOSTON DORCHESTER SUFFOLK COUNTY, MASSACHUSETTS					
<b>BOHLER</b> <b>352 TURNPIKE ROAD</b> <b>SOUTHBOROUGH, MA 01772</b> Phone: (508) 480-9900 Fax: (508) 480-9080 <i>www.BohlerEngineering.com</i>					
SHEET TITLE: MORRISSEY BOULEVARD IMPROVEMENTS EXHIBIT					
OF 1 REV 0 - 11/13/2019					


Figure 3.20 Comprehensive Sign Design Package

#### **<u>CODE:</u>** Variance required for proposed.





THIS DRAWING IS FOR CONCEPTUAL PURPOSES ONLY. DUE TO CONSTRUCTION CONSTRAINTS, SIZES AND OR LAYOUTS MAY CHANGE SLIGHTLY.									
	CLIENT	FLOOR & DECOR	STORE NO:	REV:	R1 8/26/19 MKB	REV:	REV.	lev.	Underwriters Laboratories Inc. ®
BRINGING THE WORLD'S BRANDS TO LIFE	LOCATION:	DORCHESTER, MA	06/26/19	REV:		REV:	REV.	EV:	Laboratories Inc.
1771 INDUSTRIAL ROAD · DOTHAN, ALABAMA · 36303	ACCOUNT REP:	C. CARPENTER	MKB	REV:		REV:	REV.	EXHIBIT APPROVED BY:	
PH (888) 303-5534 · FAX (334) 836-1401 www.idassociatesinc.com	DRAWING NO:	FD-DORCHESTER MA-VARIANC	E	REV:		REV:	REY		

#### **<u>CODE:</u>** Variance required for proposed.

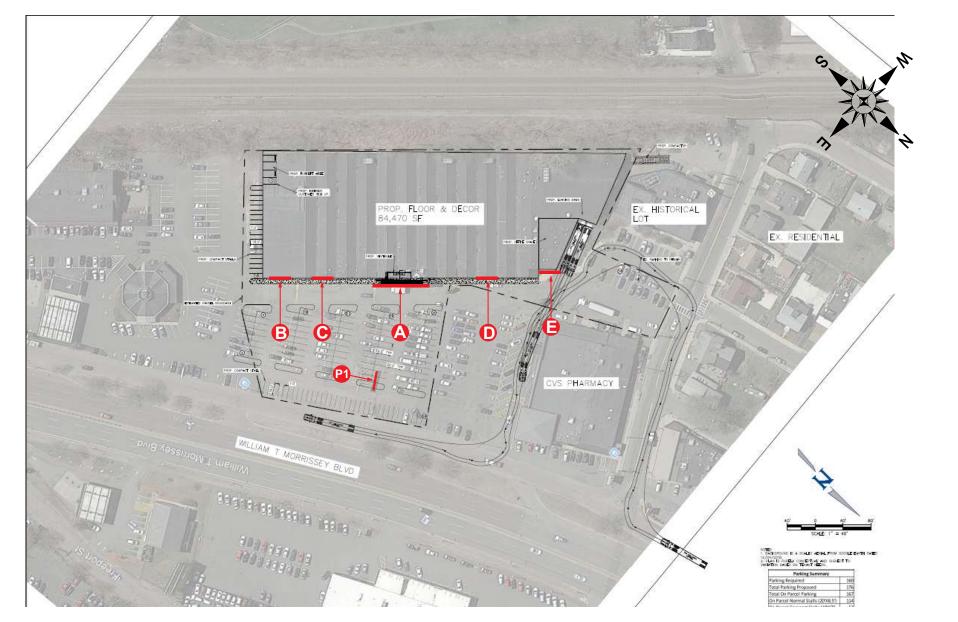

THIS DRAWING IS FOR CONCEPTUAL PURPOSES ONLY. DUE TO CONSTRUCTION CONSTRAINTS, SIZES AND OR LAYOUTS MAY CHANGE SLIGHTLY.								
	CLIENT	FLOOR & DECOR	STORE NO:	R1 8/26/19 MKB	REV:	REV.	REV.	Underwriters Laboratories Inc
BRINGING THE WORLD'S BRANDS TO LIFE	LOCATION:	DORCHESTER, MA	06/26/19	REV:	REV:	REV.	REV.	
1771 INDUSTRIAL ROAD • DOTHAN, ALABAMA • 36303	ACCOUNT REP:	C. CARPENTER	MKB	REV.	REV	REV.	EXHIBIT APPROVED BY:	
PH (888) 303-5534 · FAX (334) 836-1401 www.idassociatesinc.com	DRAWING NO:	FD-DORCHESTER MA-VARIANC	E	REV:	REV	REV.		

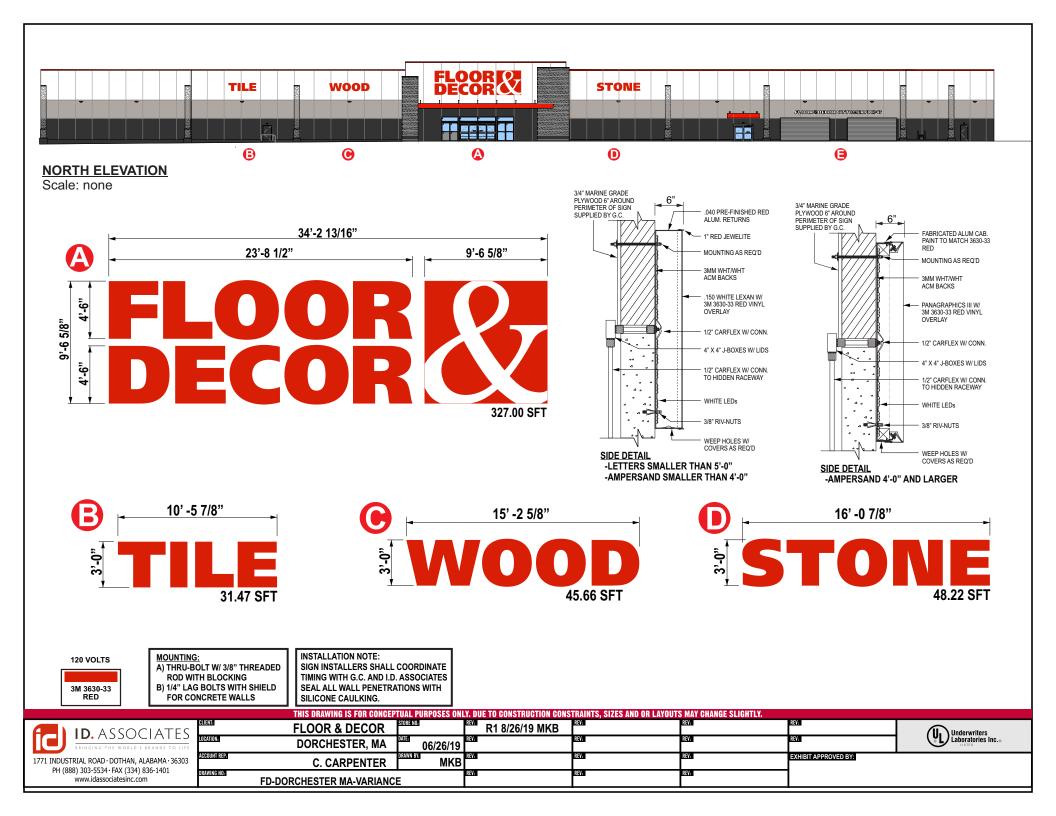

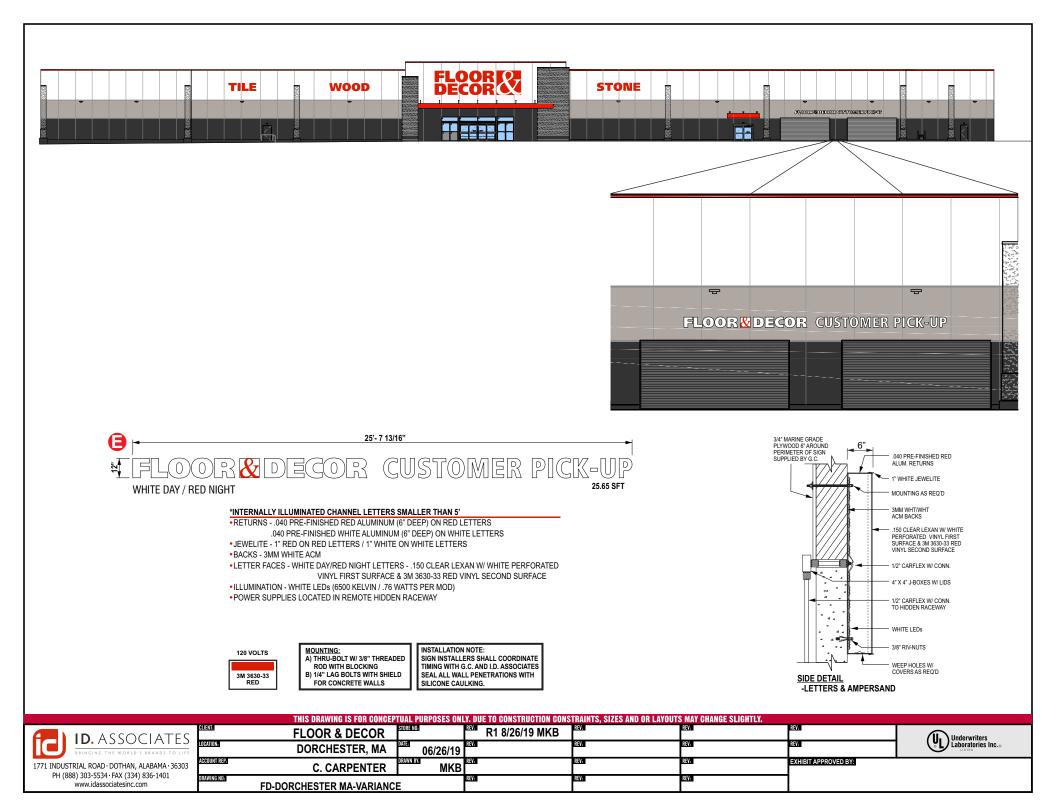



**P1** 

TBD



TBD

# FLOOR & DECOR TILE • WOOD • STONE

#### NOTES:


Replacement faces for existing tenant panel. Sizes, Retainers and materials TBD.

#### COLORS:

Background - 3630-33 red vinyl Copy - white

THIS DRAWING IS FOR CONCEPTUAL PURPOSES ONLY. DUE TO CONSTRUCTION CONSTRAINTS, SIZES AND OR LAYOUTS MAY GHANGE SLIGHTLY.									
	CLIENT	FLOOR & DECOR	STORE NO:	REV:	R1 8/26/19 MKB	REV.	REV.	REV:	Underwriters
BRINGING THE WORLD'S BRANDS TO LIFE	LOCATION:	DORCHESTER, MA	06/26/19	REV:		REV:	REV.	REV:	Laboratories Inc.®
1//1 INDUSTRIAL ROAD+DOTHAN, ALABAMA+36303	ACCOUNT REP:	C. CARPENTER	DRAWN BY: MKB	REV:		REV:	REV.	EXHIBIT APPROVED BY:	
PH (888) 303-5534 · FAX (334) 836-1401 www.idassociatesinc.com	DRAWING NO:	FD-DORCHESTER MA-VARIANCE	E	REV:		REV:	REV.		

Figure 3.21 Floor Plan

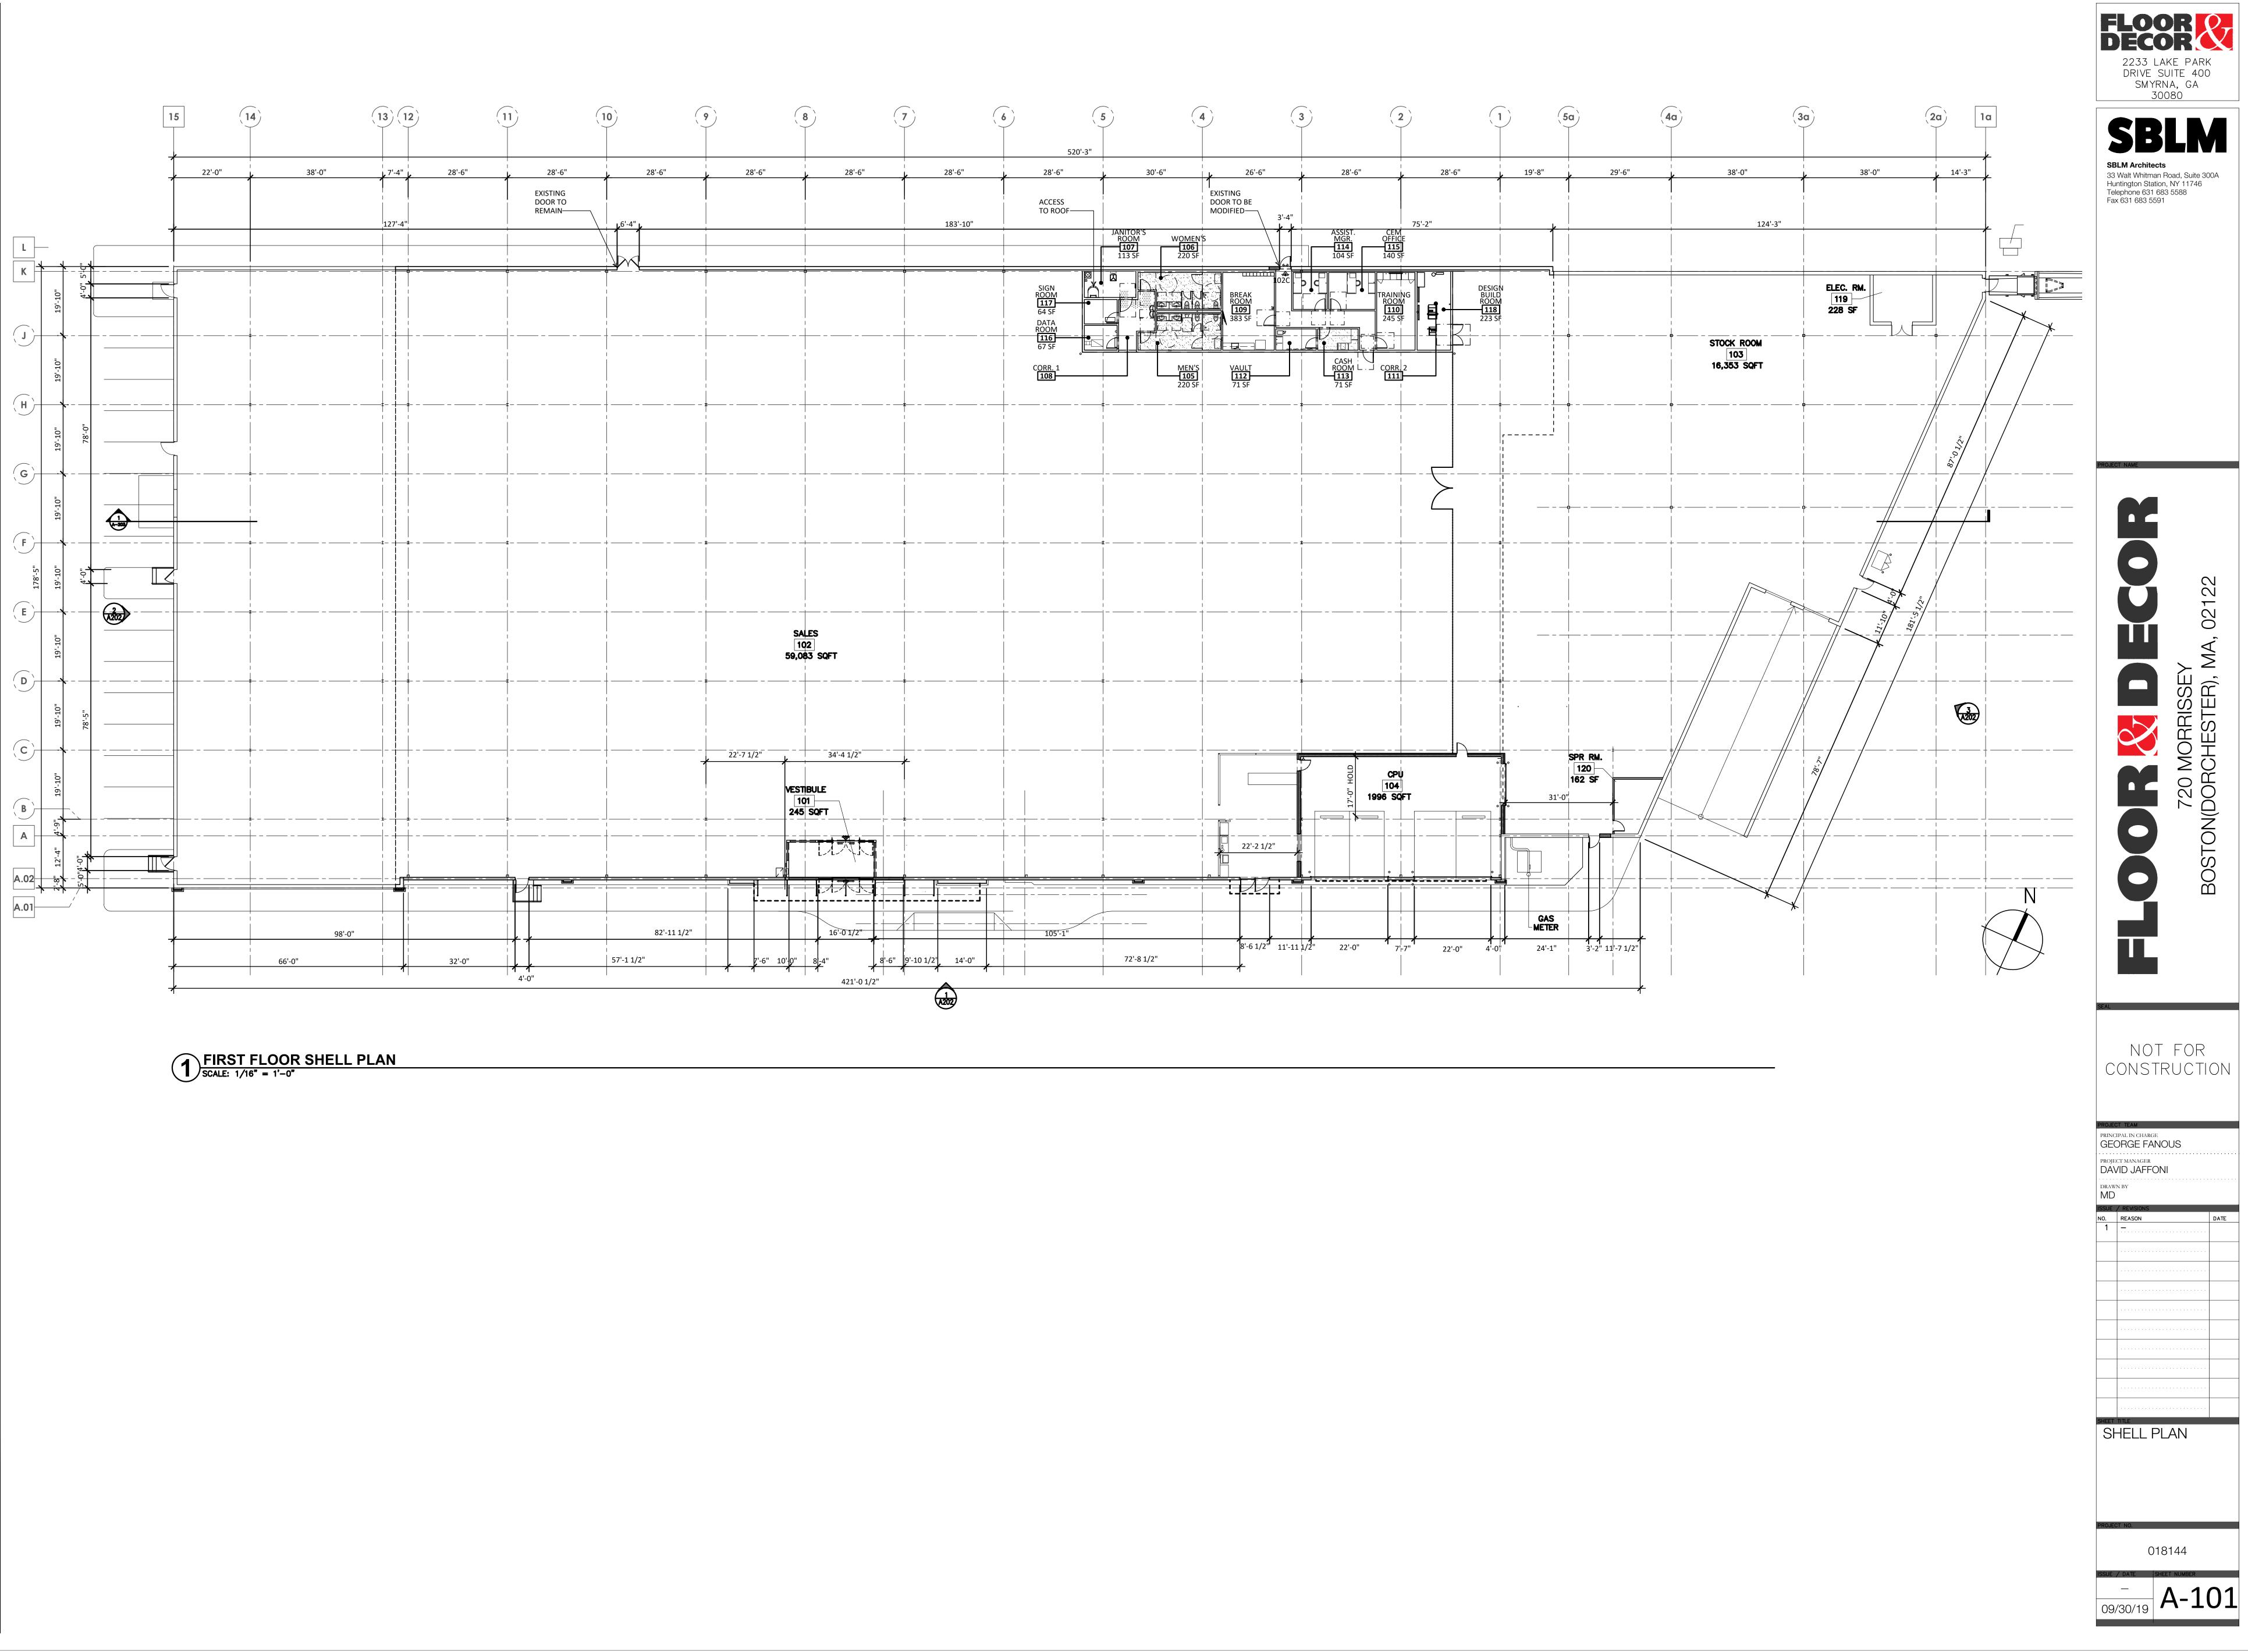

## 4.0 ACCESSIBILITY CHECKLIST

## Article 80 - Accessibility Checklist

#### A requirement of the Boston Planning & Development Agency (BPDA) Article 80 Development Review Process

The Mayor's Commission for Persons with Disabilities strives to reduce architectural, procedural, attitudinal, and communication barriers that affect persons with disabilities in the City of Boston. In 2009, a Disability Advisory Board was appointed by the Mayor to work alongside the Commission in creating universal access throughout the city's built environment. The Disability Advisory Board is made up of 13 volunteer Boston residents with disabilities who have been tasked with representing the accessibility needs of their neighborhoods and increasing inclusion of people with disabilities.

In conformance with this directive, the BDPA has instituted this Accessibility Checklist as a tool to encourage developers to begin thinking about access and inclusion at the beginning of development projects, and strive to go beyond meeting only minimum MAAB / ADAAG compliance requirements. Instead, our goal is for developers to create ideal design for accessibility which will ensure that the built environment provides equitable experiences for all people, regardless of their abilities. As such, any project subject to Boston Zoning Article 80 Small or Large Project Review, including Institutional Master Plan modifications and updates, must complete this Accessibility Checklist thoroughly to provide specific detail about accessibility and inclusion, including descriptions, diagrams, and data.

For more information on compliance requirements, advancing best practices, and learning about progressive approaches to expand accessibility throughout Boston's built environment. Proponents are highly encouraged to meet with Commission staff, prior to filing.

#### Accessibility Analysis Information Sources:

- 1. Americans with Disabilities Act 2010 ADA Standards for Accessible Design http://www.ada.gov/2010ADAstandards\_index.htm
- 2. Massachusetts Architectural Access Board 521 CMR http://www.mass.gov/eopss/consumer-prot-and-bus-lic/license-type/aab/aab-rules-and-regulations-pdf.html
- 3. Massachusetts State Building Code 780 CMR http://www.mass.gov/eopss/consumer-prot-and-bus-lic/license-type/csl/building-codebbrs.html
- 4. Massachusetts Office of Disability Disabled Parking Regulations <u>http://www.mass.gov/anf/docs/mod/hp-parking-regulations-summary-mod.pdf</u>
- 5. MBTA Fixed Route Accessible Transit Stations <u>http://www.mbta.com/riding\_the\_t/accessible\_services/</u>
- 6. City of Boston Complete Street Guidelines <u>http://bostoncompletestreets.org/</u>
- 7. City of Boston Mayor's Commission for Persons with Disabilities Advisory Board www.boston.gov/disability
- City of Boston Public Works Sidewalk Reconstruction Policy <u>http://www.cityofboston.gov/images\_documents/sidewalk%20policy%200114\_tcm3-41668.pdf</u>
   Other of Poston – Public Improvement Commission Sidewalk 20fé Policy
- 9. City of Boston Public Improvement Commission Sidewalk Café Policy http://www.cityofboston.gov/images\_documents/Sidewalk\_cafes\_tcm3-1845.pdf

#### **Glossary of Terms:**

- 1. *Accessible Route* A continuous and unobstructed path of travel that meets or exceeds the dimensional and inclusionary requirements set forth by MAAB 521 CMR: Section 20
- 2. *Accessible Group 2 Units* Residential units with additional floor space that meet or exceed the dimensional and inclusionary requirements set forth by MAAB 521 CMR: Section 9.4
- 3. *Accessible Guestrooms* Guestrooms with additional floor space, that meet or exceed the dimensional and inclusionary requirements set forth by MAAB 521 CMR: Section 8.4
- 4. *Inclusionary Development Policy (IDP)* Program run by the BPDA that preserves access to affordable housing opportunities, in the City. For more information visit: <u>http://www.bostonplans.org/housing/overview</u>
- 5. *Public Improvement Commission (PIC)* The regulatory body in charge of managing the public right of way. For more information visit: <u>https://www.boston.gov/pic</u>
- 6. *Visitability* A place's ability to be accessed and visited by persons with disabilities that cause functional limitations; where architectural barriers do not inhibit access to entrances/doors and bathrooms.

#### 1. Project Information:

If this is a multi-phased or multi-building project, fill out a separate Checklist for each phase/building.

Project Name:	Floor & Decor – Dor	chester, MA				
Primary Project Address:	729 Morrissey Blvd,	729 Morrissey Blvd, Dorchester, MA 02122				
Total Number of Phases/Buildings:	1					
Primary Contact (Name / Title / Company / Email / Phone):	Vanessa Masell, Development Manager Centerpoint Integrated Solutions vmasell@centerpoint-is.com 720-445-4387					
Owner / Developer:	Floor & Decor – Brandy N. Crawford					
Architect:	SBLM Architects - George Fanous					
Civil Engineer:	Bohler Engineering – Austin Turner					
Landscape Architect:	Bohler Engineering – Matthew Mrva					
Permitting:	CenterPoint Integrat	ted Solutions – Vanessa Masel	1			
Construction Management:	N/A					
At what stage is the project at time	of this questionnaire?	' Select below:				
	PNF / Expanded PNF Submitted	Draft / Final Project Impact Report Submitted	BPDA Board Approve			
	BPDA Design Approved	Under Construction	Construction Completed:			
Do you anticipate filing for any variances with the Massachusetts Architectural Access Board (MAAB)? <i>If yes,</i> identify and explain.	No variances are an	iticipated at this time.				

#### 2. Building Classification and Description:

This section identifies preliminary construction information about the project including size and uses.

What are the dimensions of the project? $471.0' \pm x 179.0' \pm$ (average building length)						
Site Area:	158,947± SF	Building Area:	82,378± GSF			

Building Height:	+/- 32'-0 FT.	Number of Storie	s:	One	
First Floor Elevation:	+/- 10.47'	Is there below gra	ade space:	Yes / <b>No</b>	
What is the Construction Type? (Se	lect most appropriate	type)			
	Wood Frame	Masonry	Steel Frame	Concrete	
What are the principal building use	s? (IBC definitions are	below – select all appi	ropriate that app	ly)	
	Residential – One - Three Unit	Residential - Multi- unit, Four +	Institutional	Educational	
	Business	Mercantile	Factory	Hospitality	
	Laboratory / Medical	Storage, Utility and Other			
List street-level uses of the building:	Mercantile				
neighborhood where this development is located and its identifying topographical characteristics:	The Site is located in the Dorchester Neighborhood District and the Neighborhood Shopping (NS) Subdistrict on the southeast side of Morrissey Boulevard. The site is relatively flat and generally slopes towards Morrissey Boulevard.				
List the surrounding accessible MBTA transit lines and their proximity to development site: commuter rail / subway stations, bus stops:	The MBTA track is located directly southeast of the subject property. There are two existing Puritan Mall bus stops located along Victory Road and Morrissey Boulevard proximate to the Site.				
	The Property is surrounded by a mix of retail, office, residential and institutional uses. These include CVS Pharmacy, Bay Cove Early Intervention, Citizen's Bank, CITGO Gas Station, Puritan Pizza, Herb Chambers Honda in Boston, and multiple residential properties along Victory Road.				
List the surrounding institutions: hospitals, public housing, elderly and disabled housing developments, educational facilities, others:	institutional uses. Th Citizen's Bank, CITG	nese include CVS Phan 0 Gas Station, Puritan	macy, Bay Cove I Pizza, Herb Cha	Early Intervention, mbers Honda in	

#### 4. Surrounding Site Conditions – Existing:

This section identifies current condition of the sidewalks and pedestrian ramps at the development site.

Is the development site within a historic district? <i>If yes,</i> identify which district:	Yes, Parcel No. 160024000 is within the Landmarks Designation District.			
Are there sidewalks and pedestrian ramps existing at the development site? <i>If yes</i> , list the existing sidewalk and pedestrian ramp dimensions, slopes, materials, and physical condition at the development site:	The existing concrete sidewalk along the front of the existing building is approximately seven (7) feet in width with a cross-slope of approximately 2.5%±. There is an existing concrete ramp at the main entrance of the existing building with a slope of approximately 6.2%±.			
Are the sidewalks and pedestrian ramps existing-to-remain? <i>If yes,</i> have they been verified as ADA / MAAB compliant (with yellow composite detectable warning surfaces, cast in concrete)? <i>If yes,</i> provide description and photos:	The existing main entrance is proposed to be removed and relocated in support of the proposed Floor & Decor facility. The cross-slope of the existing sidewalk surrounding the building was observed to exceed the maximum allowed cross-slope indicated in the current Americans with Disabilities Act (ADA) and Architectural Access Board (AAB) requirements. The existing accessible ramps and sidewalks proximate to the building are expected to be reconstructed on account of same.			
5. Surrounding Site Conditions – Proposed This section identifies the proposed condition of the walkways and pedestrian ramps around the development site. Sidewalk width contributes to the degree of comfort walking along a street. Narrow sidewalks do not support lively pedestrian activity, and may create dangerous conditions that force people to walk in the street. Wider sidewalks allow people to walk side by side and pass each other comfortably walking alone, walking in pairs, or using a wheelchair.				
Are the proposed sidewalks consistent with the Boston Complete Street Guidelines? <i>If yes</i> , choose which Street Type was applied: Downtown Commercial, Downtown Mixed-use, Neighborhood Main, Connector, Residential, Industrial, Shared Street, Parkway, or Boulevard.	Yes, the proposed sidewalks are intended to be consistent with the minimum Boston Complete Street Guidelines for Downtown Commercial.			
What are the total dimensions and	The proposed sidewalk width is 7'-6" and slopes are proposed to be less			

slopes of the proposed sidewalks? If than two (2%) percent in all directions to meet ADA and AAB requirements.

List the widths of the proposed zones: Frontage, Pedestrian and Furnishing Zone:	No new sidewalks are proposed along Morrissey Boulevard or Victory Road.
List the proposed materials for each Zone. Will the proposed materials be on private property or will the proposed materials be on the City of Boston pedestrian right-of-way?	The proposed sidewalk is intended to be concrete. The proposed materials will be on the subject Site.
Will sidewalk cafes or other furnishings be programmed for the pedestrian right-of-way? <i>If yes,</i> what are the proposed dimensions of the sidewalk café or furnishings and what will the remaining right-of-way clearance be?	None anticipated.
If the pedestrian right-of-way is on private property, will the proponent seek a pedestrian easement with the Public Improvement Commission (PIC)?	N/A
Will any portion of the Project be going through the PIC? <i>If yes,</i> identify PIC actions and provide details.	N/A

#### 6. Accessible Parking:

See Massachusetts Architectural Access Board Rules and Regulations 521 CMR Section 23.00 regarding accessible parking requirement counts and the Massachusetts Office of Disability – Disabled Parking Regulations.

What is the total number of parking spaces provided at the development site? Will these be in a parking lot or garage?	There are one hundred and twenty-six (126) existing parking spaces on-site in an existing parking lot. The existing dimensions of the parking stalls do not meet minimum Boston Zoning requirements. The Project proposes to restripe the existing parking area to meet Code. This will inevitably result in a reduction of parking, for a total of one hundred and eighteen (118) parking spaces to be proposed. The Proponent anticipates that the Project may seek relief from the Board of Appeal with respect to parking requirements.
What is the total number of accessible spaces provided at the development site? How many of	Five (5) accessible spaces are proposed on-site, including one (1) Van Accessible space.

proposed housing units or hotel rooms for the development?

these are "Van Accessible" spaces with an 8 foot access aisle?	
Will any on-street accessible parking spaces be required? <i>If yes,</i> has the proponent contacted the Commission for Persons with Disabilities regarding this need?	No on-street parking spaces are proposed.
Where is the accessible visitor parking located?	The proposed accessible parking is located proximate to the proposed main entrance to the building.
Has a drop-off area been identified? <i>If yes,</i> will it be accessible?	No drop-off area is proposed.
	es: ing smooth and continuous paths of travel is to create universal access ces, which accommodates persons of all abilities and allows for
Describe accessibility at each entryway: Example: Flush Condition, Stairs, Ramp, Lift or Elevator:	An accessible ramp is proposed to be located at the proposed main entrance to the building. A proposed crosswalk is also provided to facilitate pedestrian crossing to the accessible parking spaces.
Are the accessible entrances and standard entrance integrated? <i>If</i> <i>yes,</i> describe. <i>If no</i> , what is the reason?	Yes, the main building entrance is designed to be accessible.
<i>If project is subject to Large Project</i> <i>Review/Institutional Master Plan,</i> describe the accessible routes way- finding / signage package.	N/A
	Guestrooms: (If applicable) nousing and hospitality, this section addresses the number of sed for the development site that remove barriers to housing and hotel
What is the total number of	N/A

<i>If a residential development,</i> how many units are for sale? How many are for rent? What is the breakdown of market value units vs. IDP (Inclusionary Development Policy) units?	N/A
<i>If a residential development,</i> how many accessible Group 2 units are being proposed?	N/A
<i>If a residential development,</i> how many accessible Group 2 units will also be IDP units? <i>If none</i> , describe reason.	N/A
If a hospitality development, how many accessible units will feature a wheel-in shower? Will accessible equipment be provided as well? If yes, provide amount and location of equipment.	N/A
Do standard units have architectural barriers that would prevent entry or use of common space for persons with mobility impairments? Example: stairs / thresholds at entry, step to balcony, others. <i>If yes</i> , provide reason.	N/A
Are there interior elevators, ramps or lifts located in the development for access around architectural barriers and/or to separate floors? <i>If yes</i> , describe:	N/A

#### 9. Community Impact:

Accessibility and inclusion extend past required compliance with building codes. Providing an overall scheme that allows full and equal participation of persons with disabilities makes the development an asset to the surrounding community.

Is this project providing any funding	The Proponent and Owner believe that the Project will benefit the City of
or improvements to the surrounding	Boston, Dorchester, and the NS Subdistrict by dramatically improving a
neighborhood? Examples: adding	dilapidated building and by providing goods and services to the larger
extra street trees, building or	neighborhood. Additional interior landscaping and limited site improvements
refurbishing a local park, or	are proposed to improve the aesthetic of the existing conditions.

supporting other community-based initiatives?	
What inclusion elements does this development provide for persons with disabilities in common social and open spaces? Example: Indoor seating and TVs in common rooms; outdoor seating and barbeque grills in yard. Will all of these spaces and features provide accessibility?	N/A
Are any restrooms planned in common public spaces? <i>If yes,</i> will any be single-stall, ADA compliant and designated as "Family"/ "Companion" restrooms? <i>If no</i> , explain why not.	Restrooms are proposed to be available in common public spaces. Companion restrooms will not be provided, as they are not required.
Has the proponent reviewed the proposed plan with the City of Boston Disability Commissioner or with their Architectural Access staff? <i>If yes,</i> did they approve? <i>If no,</i> what were their comments?	In progress.
Has the proponent presented the proposed plan to the Disability Advisory Board at one of their monthly meetings? Did the Advisory Board vote to support this project? <i>If no,</i> what recommendations did the Advisory Board give to make this project more accessible?	In progress.

#### 10. Attachments

Include a list of all documents you are submitting with this Checklist. This may include drawings, diagrams, photos, or any other material that describes the accessible and inclusive elements of this project.

Provide a diagram of the accessible routes to and from the accessible parking lot/garage and drop-off areas to the development entry locations, including route distances.

Please see attached.

Provide a diagram of the accessible route connections through the site, including distances.

Please see attached.

Provide a diagram the accessible route to any roof decks or outdoor courtyard space? (if applicable)

N/A

Provide a plan and diagram of the accessible Group 2 units, including locations and route from accessible entry.

N/A

Provide any additional drawings, diagrams, photos, or any other material that describes the inclusive and accessible elements of this project.

This completes the Article 80 Accessibility Checklist required for your project. Prior to and during the review process, Commission staff are able to provide technical assistance and design review, in order to help achieve ideal accessibility and to ensure that all buildings, sidewalks, parks, and open spaces are usable and welcoming to Boston's diverse residents and visitors, including those with physical, sensory, and other disabilities.

For questions or comments about this checklist, or for more information on best practices for improving accessibility and inclusion, visit <u>www.boston.gov/disability</u>, or our office:

The Mayor's Commission for Persons with Disabilities 1 City Hall Square, Room 967, Boston MA 02201.

Architectural Access staff can be reached at:

accessibility@boston.gov | patricia.mendez@boston.gov | sarah.leung@boston.gov | 617-635-3682

Figure 4.1 Exterior Accessibility Plan Diagram


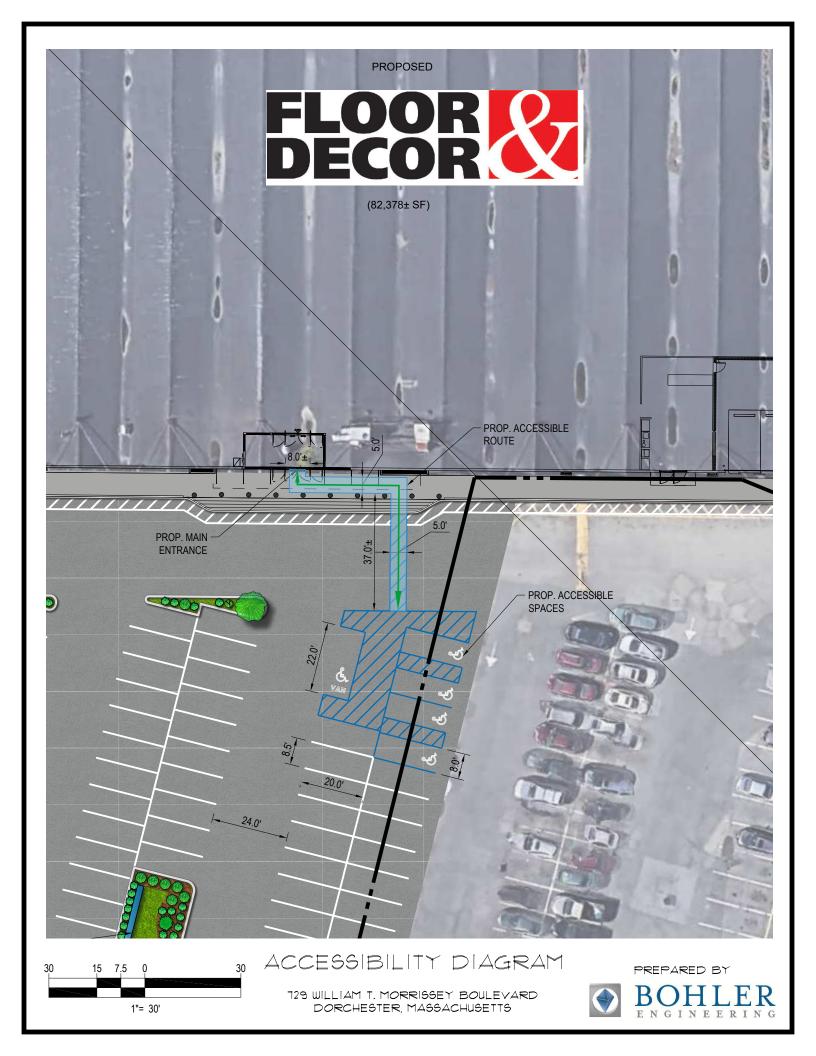


Figure 4.2 Interior Accessibility Plan Diagram

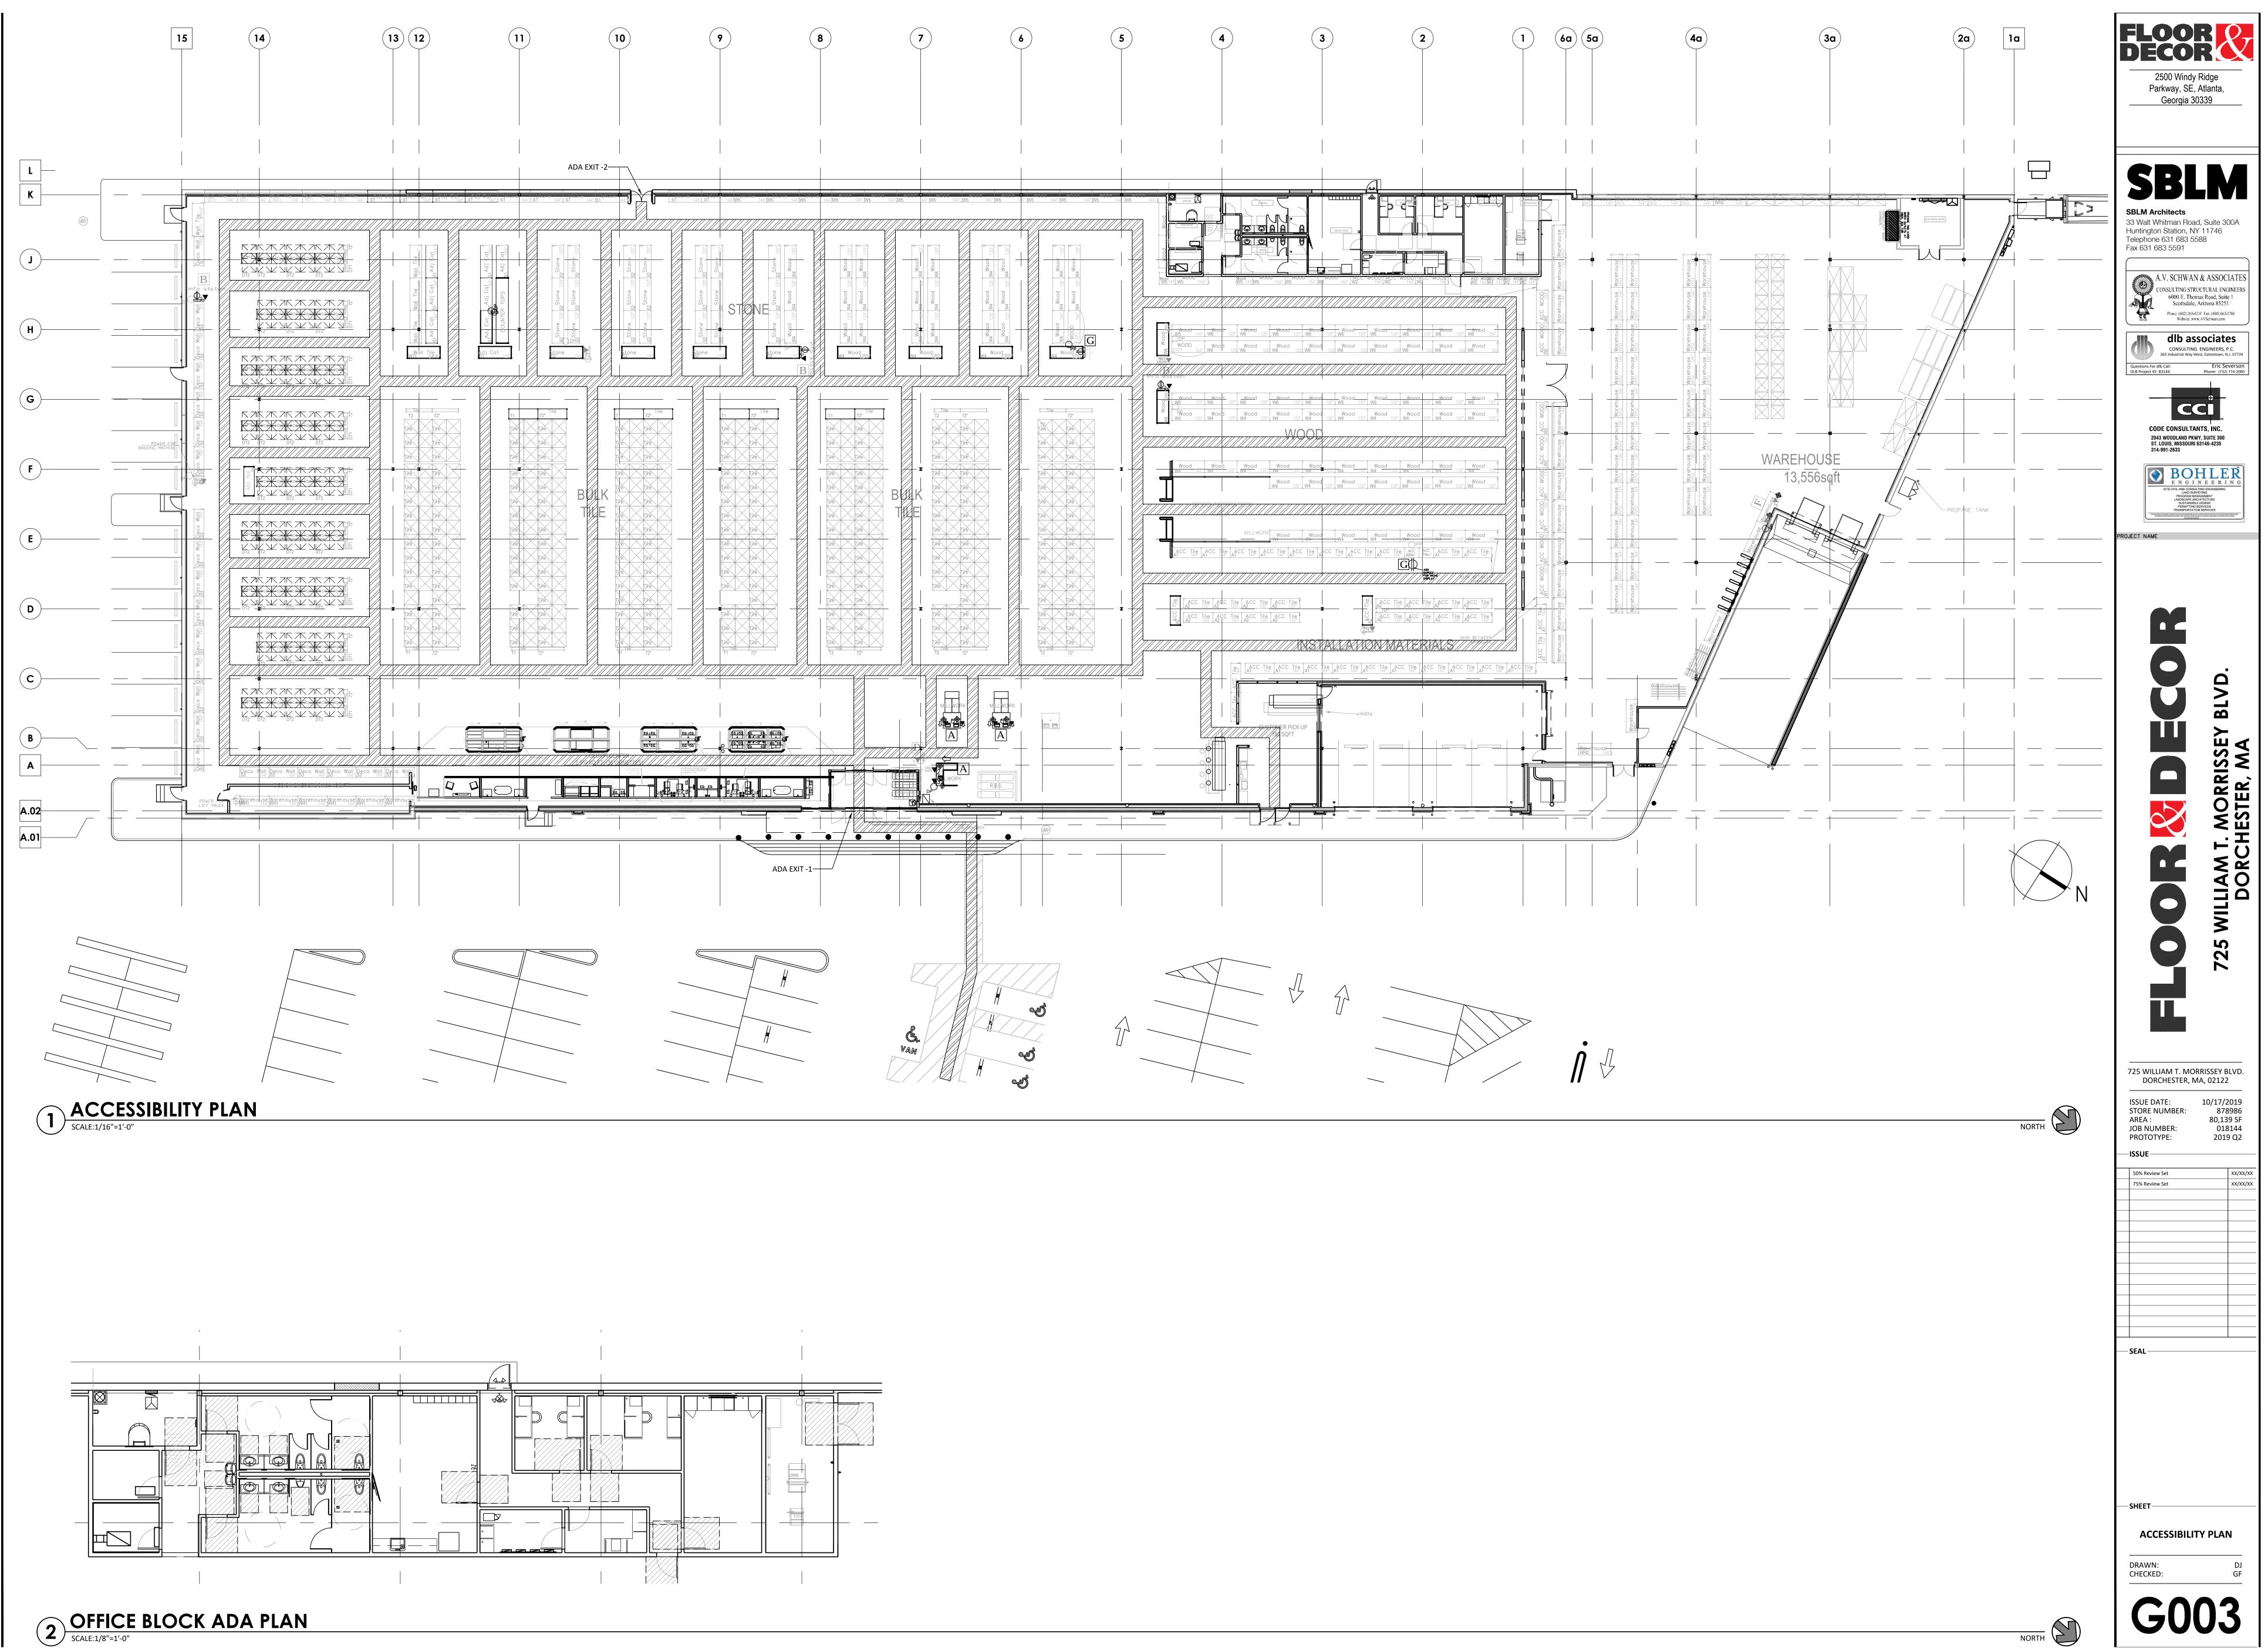

## 5.0 **PROJECT CERTIFICATION**

This SPRA has been circulated to the Boston Planning and Development Agency as required by Article 80E of the Boston Zoning Code.

Signature of Proponent

Date

Brandy Crawford, Construction Design Project Manager Floor & Decor

Signature of Proponent's Representative

11/15/19

Date

Austin F. Turner, Associate Bohler Engineering