450 Cambridge Street Development 446-450 Cambridge Street, Allston



Application for Article 80 Small Project Review Boston Redevelopment Authority March 17, 2014

Developer: The Arcand Family/Allston LLC

442R Cambridge Street

P.O.Box 216 Allston, MA 02134 T: 617.783.2469

Architect: Neshamkin French Architects, INC

5 Monument Square Charlestown, Ma 02129 T: 617.242.7422

Legal Counsel: J. Kevin Leary

50 Franklin Street Boston, MA 02110 T: 617.542.8905

450 Cambridge Street Development 446-450 Cambridge Street, Allston

Table of Contents

Application Letter	Pg. 1
Zoning Analysis	
446-450 Cambridge Street	Pg.2
7-9 Craftsman Street	Pg.3
Project Team	Pg.4
Project Description	Pg.5
Traffic, Parking and Vehicular and Pedestrian Access	Pg.5
Landscaping and Screening	Pg.6
Zoning Refusal Letter	Pg. 7
Architectural Drawings	
Cover Sheet	Pg. 8
Existing Plot Plan	Pg. 9
Proposed Plot Plan	Pg. 10
Neighborhood Context	Pg. 11-12
Site/Landscape Plan	Pg. 13
Plans	Pg. 14-19
Section	Pg. 20
Elevations	Pg. 21-22
Photo Montage/ Renderings	Pg. 23-25
Transportation Fact Sheet	Pg. 26-27

NESHAMKIN FRENCH ARCHITECTS, INC.

5 MONUMENT SQUARE CHARLESTOWN, MA 02129

John W. French, AIA tel. 617-242-7422

Linda C. Neshamkin, AIA fax. 617-242-7424

March 17, 2014

Mr. Lance Campbell Senior Project Manager 1 City Hall Plaza Boston, MA 02201

RE: Request for Article 80: Small Project Review 446-450 Cambridge Street Allston
NFA #1043

Dear Mr. Campbell:

This letter is intended to serve as the application for small project development review pursuant to Article 80 of the City of Boston Zoning Code, as amended as described in Section 80 E-5: "Procedures For Small Project Review." Attached to this application are site plans, building plans with elevations and a landscaping plan. A synopsis of the proposed Project is as follows:

The development entity is The Arcand Family/Allston LLC, its manager and primary contact is Eugene J. Arcand, a businessman and developer with extensive experience in the Allston neighborhood. The design team consists of Neshamkin French Architects, Howard/Stein-Hudson Associates, Inc. traffic consultants, and T.F. Moran, Inc. Structural Engineers. The proposed \$7,000,000 development is a new four story building containing forty (40) residential units to be offered as rentals (including five (5) affordable units and two (2) handicapped accessible units), ground level commercial space containing approximately 1630 square feet of commercial space fronting on Cambridge Street, an underground parking garage, and newly created green space. The project will reconfigure the existing lot lines of 442 Cambridge Street, 450 Cambridge Street and 7-9 Craftsman Street, while maintaining the existing two level commercial building and seventeen (17) parking space area.

Parking will be provided on site in an underground parking garage as well as in the existing surface parking area. Access to the parking garage is by a ramp off Cambridge Street, while the surface parking maintains its existing access off 7-9 Craftsman Street and Cambridge Street. A total of fifty-seven (57) parking spaces will be provided for the entire project site. Additionally, provision for forty (40) bicycles will be provided in a secure area on site.

Sincerely,

John W. French A.I.A Neshamkin French Architects, Inc.

cc: Eugene J. Arcand J. Kevin Leary

Z ESHAMKIN FRENC I ARCHITECTS, Z O

U

0

Z

≤ m z

S

0

D

0 I AR

N N

John Linda 8 C French, Neshamkin, AIA AIA m Т О < ∠ t e | fax. 617-242-7424 617-242-7422 1 2 9

ZONING COMPUTATION FORM COVERING ALL NEW BUILDINGS, CHANGES OF OCCUPANCY, ALTERATIONS, ETC.

(1) USE ITEM: ARTICLE 51 ALLSTON-BRIGHTON
(2) DIMENSIONAL REQUIREMENTS: ARTICLE 51-17 Table D ZONE: CC-1 446-450 Cambridge St Multi-Residential

(4) OFF STREET LOADING: ARTICLE 24			(3) OFF-STREET PARKING: ARTICLE 51-56 Dwelling Units X factor = s	Total GSA	R TOTAL	4	ω	2	<u> </u>	Level		PROPOSED CONDITION	EXISTING CONDITION	REQU'D BY CODE	ZONE		
ADING: ARTICLE 24 NONE NONE NONE (only required for uses other than 1 through 10, 26, 27, 28, 31, 32, 39, 40, 50, 52, 53, 58, 59)	Floor Areafactor = spaces (for offices, stores, factories, etc.	and	RKING: ARTICLE 51-56 76.5 required/ 40 provided (p: Dwelling Units X factor = spaces (for houses, apartments, hotels, etc.)	49,810	1781 49810	12026	12026	12026	11951	new		16238.00		none	MIN. LOT SIZE X DWELLING UNIT	ARTICLE 51-17 TABLE E CC-1	ARTICLE AND SECTION
24 es other than 1 thro	baces (for offices,		51-56 or = spaces (for ho	10								.00		N/A	MIN. LOT AREA FOR ADDIT.	ARTICLE 51-8	E AND ION
NONE ough 10, 26, 27	stores, factories		76.5 required/ ouses, apartme							F.A.R. =		16238.00		none	TOTAL LOT SIZE (SF)	ARTICLE 51-17	
. 28. 31. 32. 39, 40	s, etc.		76.5 required/40 provided (parking garage) uses, apartments, hotels, etc.)									109'-0"		none	MIN. LOT WIDTH	ARTICLE 51- 17 CC-1	
), 50, 52, 53, 58, 5			ing garage)							GROS		3.07		1.00	MAX. FLOOR AREA RATIO	ARTICLE 51-17 TABLE E CC-1	
9)	1631 SF x(2/1000) SF	ioaines ned a	5 affordable x.7 = 3.5 spaces 35 x 2 = 70 spaces		1631 sf new commercial	40 units new construction				GROSS FLOOR AREA LOT AREA		45.8'		35'	MAX. HEIGHT OF BUILD.	ARTICLE 51-17 TABLE E CC-1	
	<u>ယ</u> ယ	73.5	73 5			on				49810.00 16238.00		33.00		50.00	USABLE OPEN MIN. SPACE PER YAR DWELL. UNIT	ARTICLE 51-17 TABLE E CC-1	TABLE
* *	3 New Commercial		New Affordable Units New Market Rate Units							3.07		0		none	MIN. FRONT YARD	ARTICLE 51-17 TABLE E CC-1	
			nits Units								•	0'		none	MIN. SIDE YARD	ARTICLE 51- 17 TABLE E CC-1	
NOTES:												3'		20	MIN. REAR YARD	ARTICLE 51- 17 TABLE E CC-1	
															MIN. SETBACK OF PARAPET		
															MAX. USE OF REAR YARD	ARTICLE 51-9	

NOTE: All of above data is to be attached to, or incorporated into, the Plot Plan Signed by Certified Land Surveyor or Certified Engineer (only required for uses other than 1 through 10, 26, 27, 28, 31, 32, 39, 40, 50, 52, 53, 58, 59)

NESHAMKIN П RENC I ARCHITECTS,

John Linda 8 0 z \subset French, Neshamkin, AIA 3 > -> 0 C D R 0 I 0 5 tel. ax. z 617-242-7424 617 -242-7422 2 9

BD 531

ZONING COMPUTATION FORM COVERING ALL NEW BUILDINGS, CHANGES OF OCCUPANCY, ALTERATIONS, ETC.

(1) USE ITEM: ARTICLE 51 ALLSTON-BRIGHTON
(2) DIMENSIONAL REQUIREMENTS: ARTICLE 51-17 Table D ZONE: CC-1 7-9 Craftsman St Multi-Residential

(4) OFF STREET LO			(3) OFF-STREET PARKING: ARTICLE 51-56 Dwelling Units X factor = sp	Total GSA	1 2 TOTAL	Level	PROPOSED CONDITION	EXISTING CONDITION	REQU'D BY CODE	ZONE		
OFF STREET LOADING: ARTICLE 24 NONE (only required for uses other than 1 through 10, 26, 27, 28, 31, 32, 39, 40, 50, 52, 53, 58, 59)		and Floor Area/factor = spaces (for offices, stores, factories, etc.	RKING: ARTICLE 51-56 [17 required/ 17 provided Dwelling Units X factor = spaces (for houses, apartments, hotels, etc.)	8,708			13048.00		none	MIN. LOT SIZE X DWELLING UNIT	ARTICLE 51-17 TABLE E CC-1	ARTICLE AND SECTION
24 s other than 1 thro		paces (for offices, s	51-56 or = spaces (for ho	38	4354 4354 8708	Proposed	3.00		N/A	MIN. LOT AREA FOR ADDIT.	ARTICLE 51-8	E AND ION
NONE bugh 10, 26, 27,		stores, factories	17 required/ 17 provided uses, apartments, hotels,			F.A.R. =	13048.00 118.20		none	TOTAL LOT MIN. LO	ARTICLE 51-17	
28, 31, 32, 39, 40		, etc.	rprovided ts, hotels, etc.)				118.20'		none	MIN. LOT WIDTH	ARTICLE 51- 17 CC-1	
, 50, 52, 53, 58, 59)				•		GROS	0.67		1.00	MAX. FLOOR AREA RATIO	ARTICLE 51- 17 TABLE E CC-1	
Total Com Req'd	4354 SF x(2/1000) SF		4 x 2 = 8 spaces Total Res Req'd		4354 sf of remaining commercial 4 units existing	GROSS FLOOR AREA LOT AREA	28'-5"	28'-5"	35'	MAX. HEIGHT OF BUILD.	ARTICLE 51-17 TABLE E CC-1	
17	9		8		ercial	8708.00 13048.00	217.00		50.00	USABLE OPEN SPACE PER DWELL.	ARTICLE 51- 17 TABLE E CC-1	TABLE
* *	9 Existing Commercial	*	Existing Market Rate Units			0.67	0		none	MIN. FRONT YARD	ARTICLE 51-17 TABLE E CC-1	
	a a		te Units				0'		none	MIN. SIDE YARD	ARTICLE 51- 17 TABLE E CC-1	
NOTES:							17'	0.00	20	MIN. REAR YARD	ARTICLE 51- 17 TABLE E CC-1	
										MIN. SETBACK OF PARAPET		
										MAX. USE OF REAR YARD	ARTICLE 51-9	

4 NOTE: All of above data is to be attached to, or incorporated into, the Plot Plan Signed by Certified Land Surveyor or Certified Engineer

450 Cambridge Street Development 446-450 Cambridge Street, Allston

Project Team

Developer: The Arcand Family/Allston LLC

442R Cambridge Street Allston, MA 02134 T: 617.783.2469 C: 617.510.3928

Eugene J Arcand, President Email: jayarc@comcast.net

Architect: Neshamkin French Architects, INC.

5 Monument Square Charlestown, Ma 02129

T: 617.242.7422 F: 617.242.7424 Jack French, Principal

Email: jwfrench@nfarchitects.com

Legal Counsel: J. Kevin Leary

50 Franklin Street Boston, MA 02110 T: 617.542.8905

Email: leary50@aol.com

Surveyors: Harry R. Feldman, INC.

112 Shawmut Avenue Boston, MA, 02118 T: 617.357.9740 F: 617.357.1829

Karl McCarthy, Senior Vice President Email: kam@harryfeldman.com

Structural Engineers: TF Moran, INC.

48 Constitution Drive Bedford, NH 03110 T: 603.472.4488 F: 603.472.9747

Paul Sbacchi, Vice President/ Chief Structural Engineer

Email: psbacchi@tfmoran.com

Traffic Engineers: Howard/Stein-Hudson Associates, INC.

38 Chauncy Street, 9th Floor

Boston, MA 02111 T: 617.482.7080 Guy Buso, Principal

Email: gbuso@hshassoc.com

450 Cambridge Street Development 446-450 Cambridge Street, Allston

Existing Site Conditions

The proposed development lot in Allston is bounded by Cambridge Street to the north, Suspension Specialists automotive repair shop on Brighton Avenue to the south, a driveway to the Action Bearing Company to the east, and Craftsman Street to the west. The project will reconfigure the existing lot lines of 442 Cambridge Street, 450 Cambridge Street and 7-9 Craftsman Street. Currently built at 7-9 Craftsman Street, and to remain on site, is an existing two (2) story masonry building. The existing building has retail shops on the ground level and four (4) residential units above. The existing surface parking lot, currently located at 450 Cambridge Street, will also remain, providing surface parking for seventeen (17) cars. The proposed development will demolish an existing one (1) story building at 442 Cambridge Street; currently the place of business of Do Re Mi Karaoke Studio and a small house behind, currently used as an office, and construct a new four (4) story mixed-use building in its place.

Project Description

This development will consist of a newly constructed four story building housing 40 residential rental units and commercial space. The ground floor provides 1631 SF of commercial space and the main residential lobby fronting Cambridge Street. Seven (7) residential units and common areas, including a fitness center and small management office, comprise the remainder of the ground floor. An additional three levels provide another thirty-three (33) residential units. Six (6) of the units on the fourth floor extend to the roof and provide access to individual roof decks. As noted in the first paragraph, an existing 2 story commercial building with 4 residential units above will remain on the site.

Traffic, Parking and Vehicular and Pedestrian Access

Parking for the proposed 40 residential units is provided on site in an underground parking garage. Access to the parking garage is located off Cambridge Street and provides a total of 40 parking spaces. An existing surface parking lot provides an additional 17 parking spaces for the

existing 2 story building and commercial space in the new building. Howard/Stein-Hudson Associates, Inc. has provided a study of the traffic impacts of the new project to the neighborhood (See pages 26-27). The proposed design provides the main entrance to the residential floors on Cambridge Street. Additional egress from the residential levels is provided to both the side and rear yards.

Landscaping and Screening

A new green space with bench seating will be provided between the existing two (2) story building and the proposed four (4) story building, at the rear of the site. Screening trees and planting beds will be provided between the existing surface parking lot and a new pedestrian walkway connecting Cambridge Street and the proposed green space. Planting beds will be provided along the perimeter of the existing surface parking lot. Plantings on site will include white birch, honey locust, and Japanese weeping cherry trees; in addition to seasonal planting beds.



Boston Inspectional Services Department Planning and Zoning Division

1010 Massachusetts Avenue Boston, MA 02118 Telephone: (617) 635-5300

Thomas M. Menino Mayor

ZONING CODE REFUSAL

Gary P. Moccia Inspector of Buildings

LINDA NESHAMKIN 5 MONUMENT SQUARE CHARLESTOWN, MA 02129

November 13, 2013

Location:

446-450 CAMBRIDGE ST ALLSTON MA 02134

Ward:

21

Zoning District:

Allston Brighton N.D

Zoning Subdistrict:

CC - 1

Appl.#:

ERT229524

Date Filed: Purpose:

March 22, 2013

Iviai cii 22, 201

Erect 4 story 40 residential unit building with commercial spaces at ground floor on new lot created

from combining and subdividing 7-9 Crafstman St.,442 Cambridge St. and vacant land at 450

Cambridge St. this new lot to be known as 446-450 Cambridge St. as per plans

YOUR APPLICATION REQUIRES RELIEF FROM THE BOARD OF APPEAL AS SAME WOULD BE IN VIOLATION OF THE BOSTON ZONING CODE TO WIT: CHAPTER 665, ACTS OF 1956 AS AMENDED:

Violation	Violation Description	Violation Comments
Article 51, Section 16 **	Use Regulations	Use: Multifamily Dwelling: Conditional
Article 51, Section 17 **	Dimensional Regulations	Floor Area Ratio Excessive
Article 51, Section 17 **	Dimensional Regulations	Building Height Excessive
Article 51, Section 17 **	Dimensional Regulations	Usable Open Space Insufficient
Article 51, Section 17 **	Dimensional Regulations	Rear Yard Insufficient
Article 51, Section 56 **	Off-Street Parking Insufficient	Off-Street Parking Insufficient

THIS DECISION MAY BE APPEALED TO THE BOARD OF APPEAL WITHIN FORTY-FIVE (45) DAYS PURSUANT TO CHAPTER 665 OF THE ACTS OF 1956, AS AMENDED. APPLICATIONS NOT APPEALED WITHIN THAT TIME PERIOD WILL BE DEEMED ABANDONED. IF YOU HAVE INQUIRIES REGARDING THE NEIGHBORHOOD PROCESS AND PUBLIC PARTICIPATION, PLEASE CONTACT THE MAYOR'S OFFICE OF NEIGHBORHOOD SERVICES AT 617-635-3485.

Thomas White (617)961-3275

for the Commissioner

Refusal of a permit may be appealed to the Board of Appeal within 45 days. Chapter 802, Acts of 1972, and Chapter 656, Acts of 1956, Section 19.

450 CAMBRIDGE STREET DEVELOPMENT 446-450 CAMBRIDGE STREET

ALLSTON, MA

PROJECT TEAM

DEVELOPER THE ARCAND FAMILY/ALLSTON LLC.

442R CAMBRIDGE STREET

P.O. BOX 216

ALLSTON, MA 02134

CONTACT: EUGENE J. ARCAND JAYARC@COMCAST.NET

ARCHITECT NESHAMKIN FRENCH ARCHITECTS, INC.

5 MONUMENT SQUARE CHARLESTOWN, MA 02129

617-242-7422 CONTACT: JACK FRENCH

JWFRENCH@NFARCHITECTS.COM

STRUCTURAL TEMORAN INC.

ENGINEER 48 CONSTITUTION DRIVE BEDFORD, NH 03110

603-472-4488

CONTACT: PAUL SBACCHI PSBACCHI@TFMORAN.COM

SURVEYOR HARRY R. FELDMAN, INC. 112 SHAWMUT AVENUE

BOSTON MA

PHONE: (617)357-9740



DRAWING LIST

ARCHITECTURAL

PLOT PLAN SITE SURVEY

A-003 SITE PLAN

A-100 GARAGE PLAN

A-102 SECOND FLOOR PLAN

A-103 THIRD FLOOR PLAN

A-104 FOURTH FLOOR PLAN

A-301 BUILDING SECTIONS

ARCHITECTURAL



A-021 LANDSCAPE PLAN

A-101 FIRST FLOOR PLAN


A-105 ROOF PLAN


A-401 BUILDING ELEVATIONS

A-402 BUILDING ELEVATIONS



LOCUS PLAN

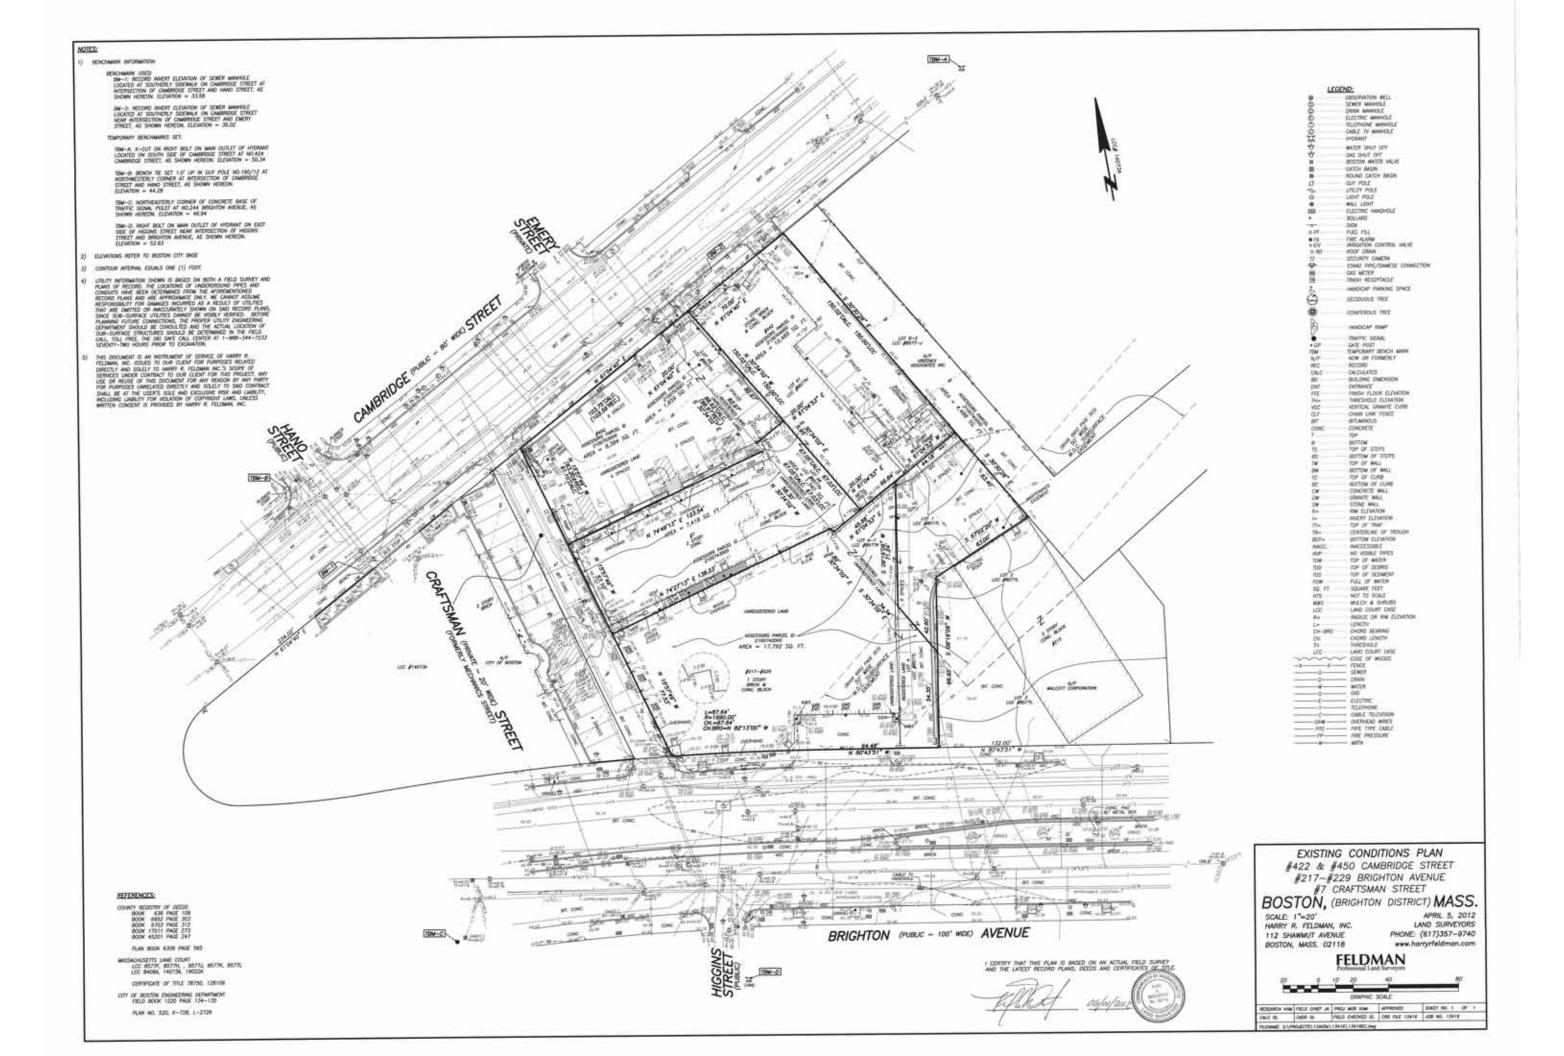

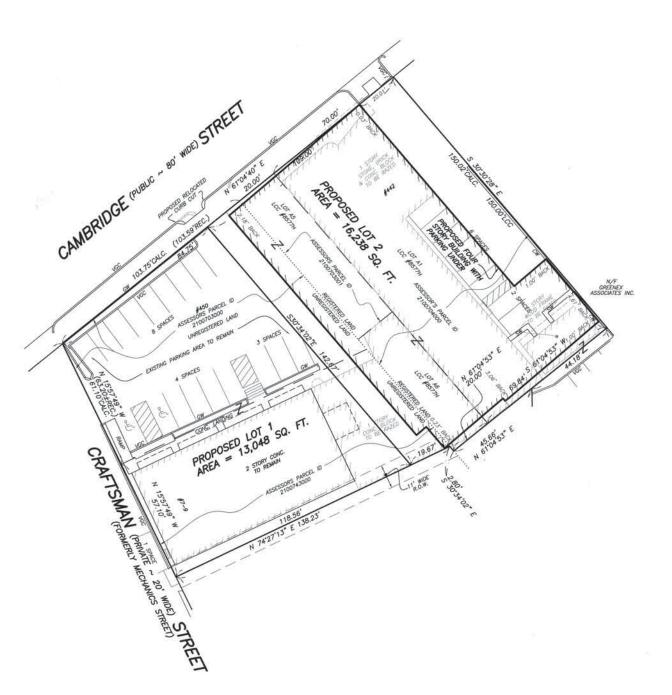



LEGEND:

NOW OR FORMERLY CALC CALCULATED SQUARE FEET RADIUS OR RIM ELEVATION
LENGTH CH.BRG -CHORD BEARING CHORD LENGTH -- LAND COURT CASE

08/01/2013 PROPERTY LINE REVISED & SITE FEATURES ADDED


PLOT PLAN 450 CAMBRIDGE STREET

BOSTON, (BRIGHTON DISTRICT) MASS.

SCALE: 1"=20' HARRY R. FELDMAN, INC. 112 SHAWMUT AVENUE

APRIL 3, 2013 LAND SURVEYORS PHONE: (617)357-9740 www.harryrfeldman.com

BOSTON, MASS. 02118 **FELDMAN**

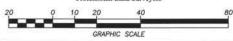

RESEARCH KAM FIELD CHIEF JA PROJ MGR KAM APPROVED SHEET NO. 1 OF 1 CALC GL CADD GL/SCH FIELD CHECKED GL CRD FILE 13416 JOB NO. 13416 FILENAME: S:\PROJECTS\13400a\13416\13416-PP1.dwg

REFERENCES:

COUNTY REGISTRY OF DEEDS BOOK 636 PAGE 109 BOOK 6952 PAGE 303 BOOK 9703 PAGE 312 BOOK 17011 PAGE 273 BOOK 45201 PAGE 247

PLAN BOOK 6306 PAGE 565

MASSACHUSETTS LAND COURT LCC 8577F, 8577H, , 8577J, 8577K, 8577L LCC 8406A, 14073A, 19022A

CERTIFICATE OF TITLE 78750, 128109

CITY OF BOSTON ENGINEERING DEPARTMENT FIELD BOOK 1220 PAGE 134-135


PLAN NO. 520, K-728, L-2726

NOTES:


- PROPERTY LINES AND EXISTING BUILDINGS SHOWN HEREON ARE TAKEN FROM A PLAN ENTITLED "EXISTING CONDITIONS PLAN, #422 & #450 CAMBRIDGE STREET, #217-#229 BRIGHTON AVENUE, #7 CRAFTSMAN STREET BOSTON (BRIGHTON DISTRICT) MASS." PREPARED BY HARRY R. FELDMAN INC. DATED APRIL 5, 2012.
- PROPOSED BUILDING SHOWN HEREON WAS PROVIDED BY NESHAMKIN FRENCH ARCHITECTS.
- 3) LOT 101 AND LOT 102 ARE SHOWN ON A PLAN ENTITLED "PLAN OF LAND, 422 & 450 CAMBRIDGE STREET, 7 CRAFTSMAN STREET, BOSTON (BRIGHTON DISTRICT), MASS." DAIED APRIL 18, 2013, AND ARE INTENDED TO BE CREATED ONCE ASSESSOR'S PARCELS 2100703000, 2100703001 & 2100704000 ARE UNDER COMMON OWNERSHIP.

I CERTIFY THAT THIS PLAN IS BASED ON AN ACTUAL FIELD SURVEY AND THE LATEST RECORD PLANS, DEEDS AND CERTIFICATES OF TITLE.




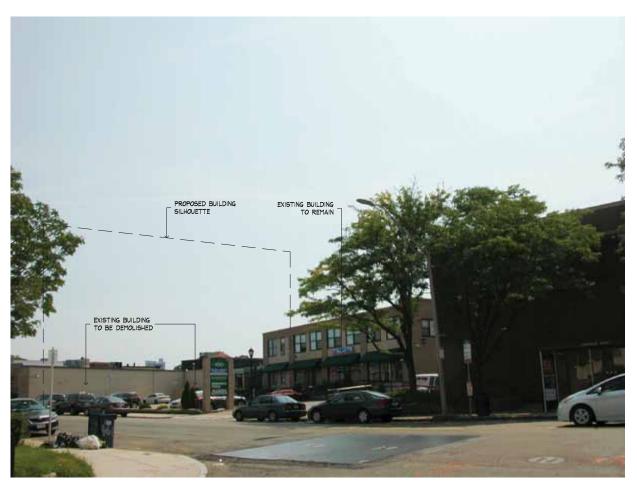



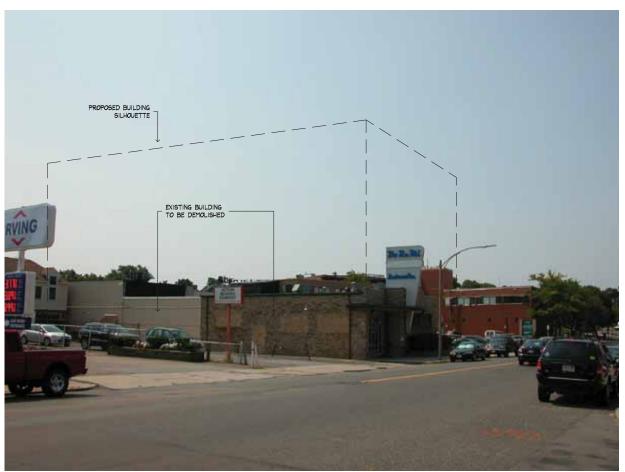

Allston, MA

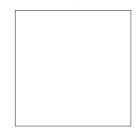



Stamped By:

Drawn By:

Checked By:

Date:

02/12/2014

Revisions

Project No.


1043

File Name:

Drawing Titte:

CONTEXT PHOTOS 2

Scale:

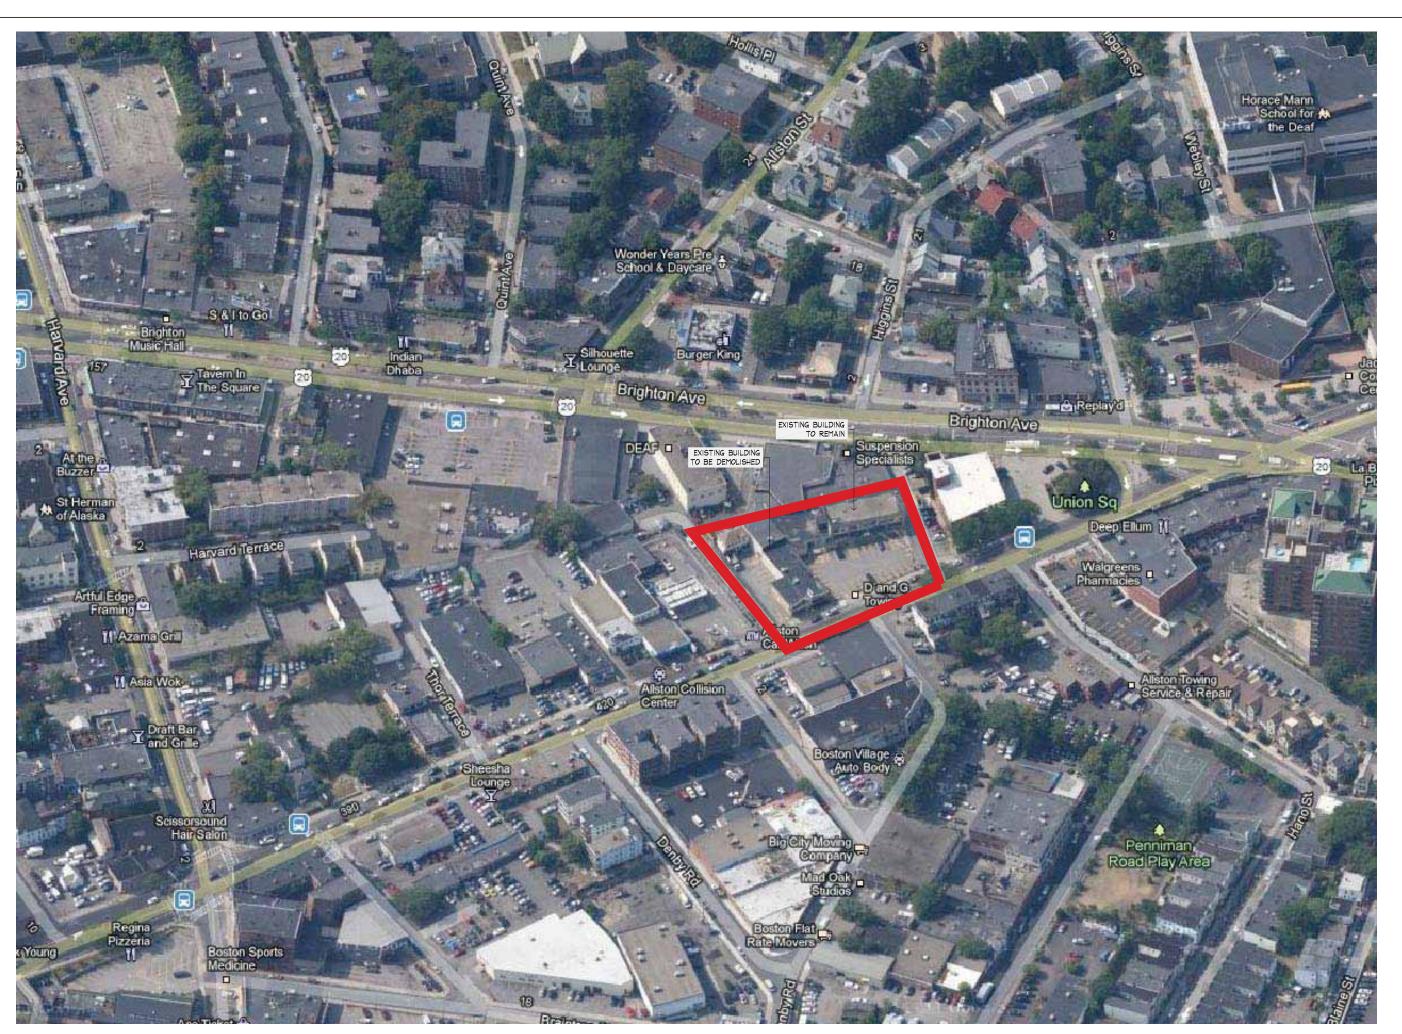

Allston, MA






Stamped By:	
Drawn By:	
Checked By:	
Date:	02/12/
Revisions	
Project No.	
File Name:	
Drawing Title:	

CONTEXT PHOTO 1


Charl No.

Scale:

NT:

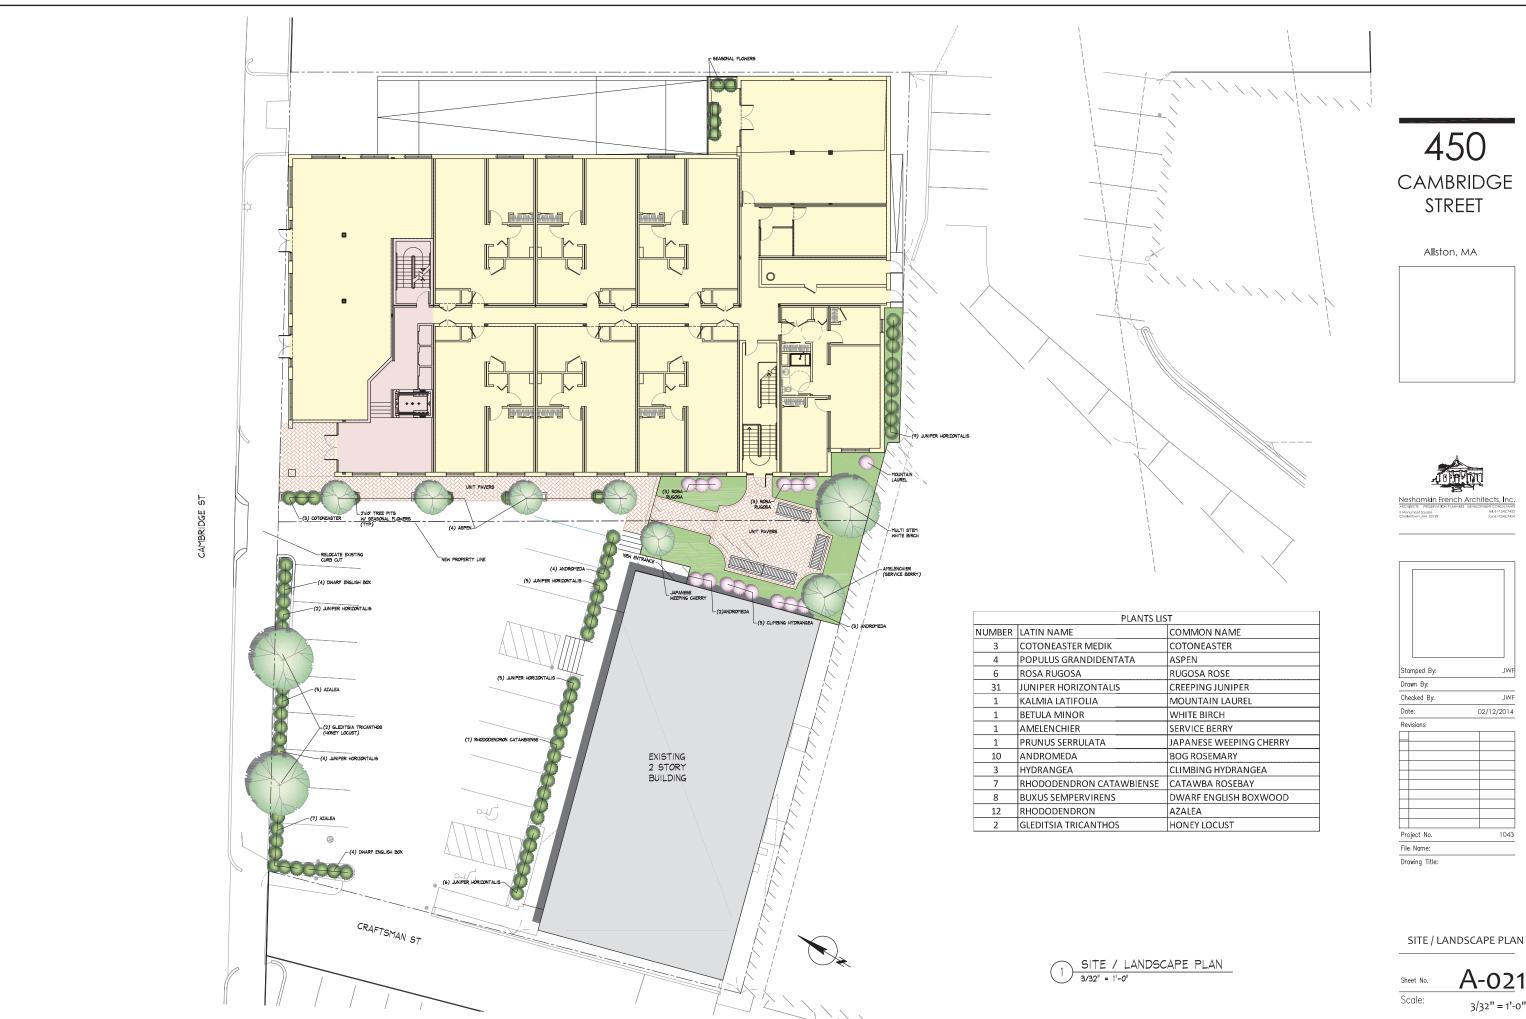




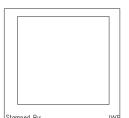

A-021


3/32" = 1'-0"

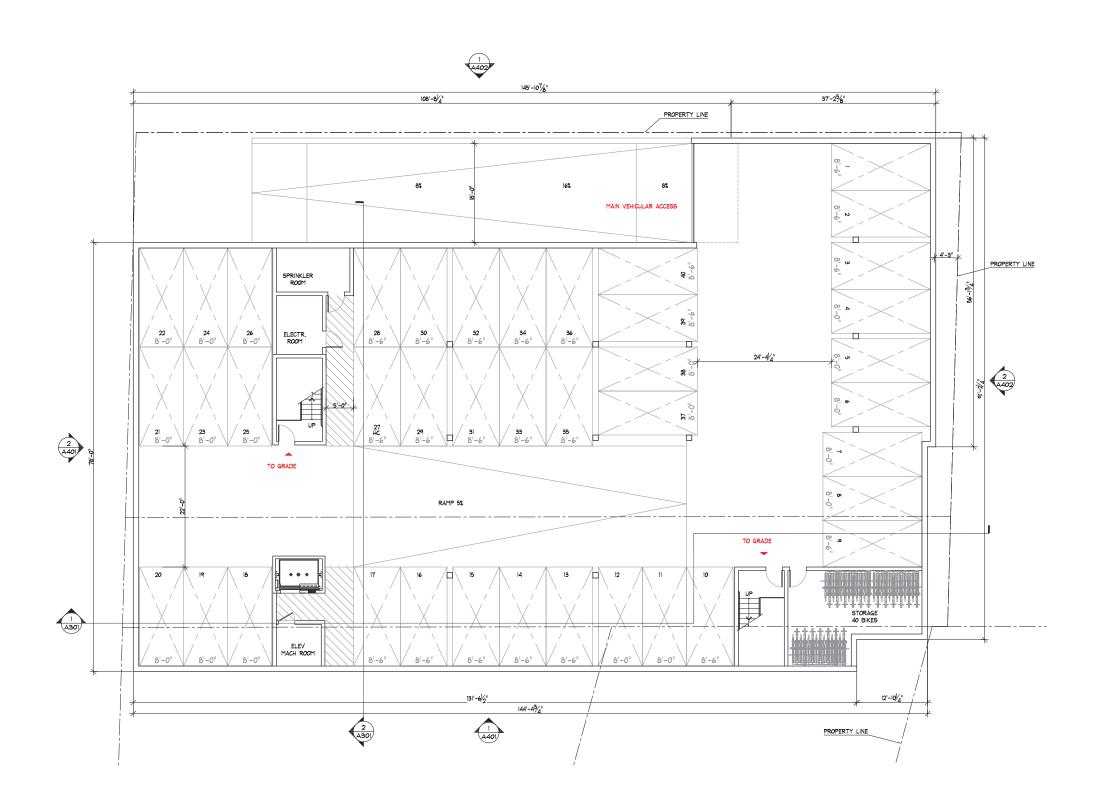

Allston, MA





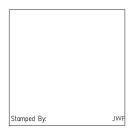

Stamped By:	J۷
Drawn By:	
Checked By:	J۷
Date:	02/12/201
Revisions	
Project No.	104
File Name:	
Drawing Title:	

BASEMENT PLAN


Sheet No.

GARAGE PLAN


1/8" = 1'-0"

A-100

1/8" = 1'-0"

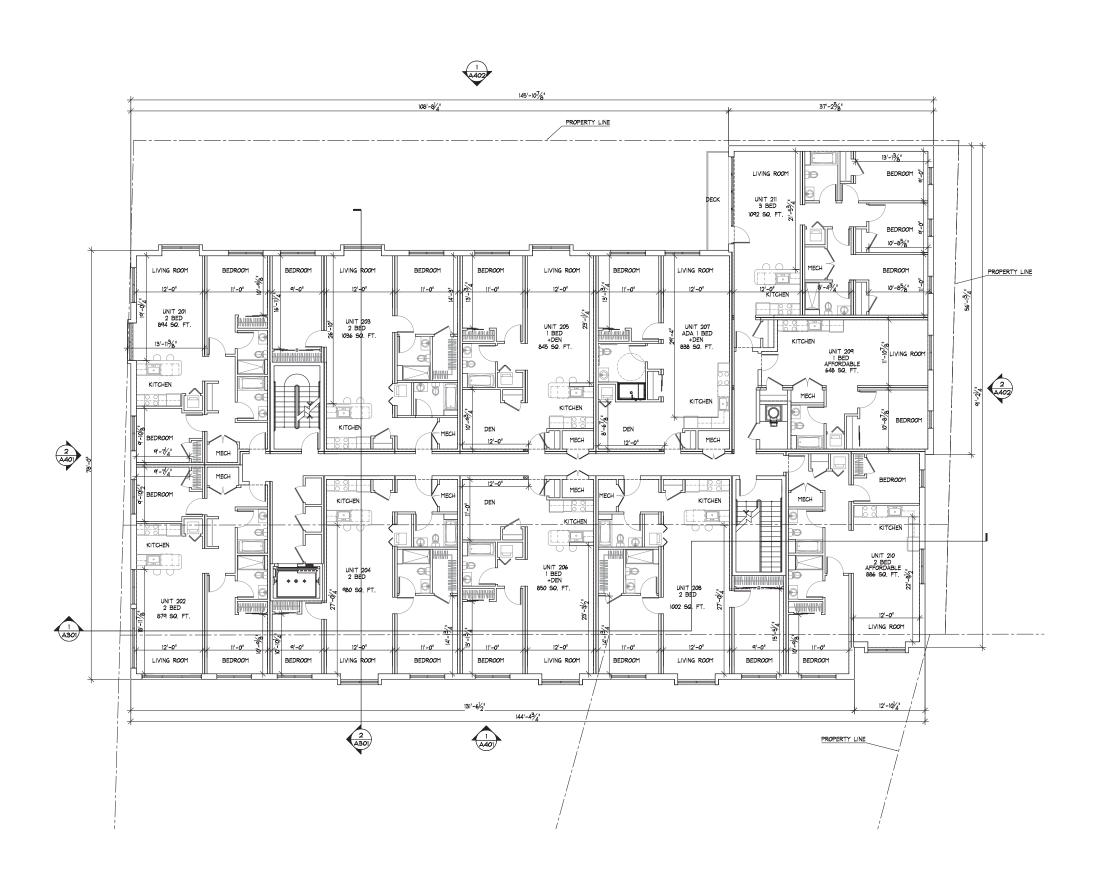

Allston, MA

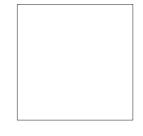





SECOND FLOOR PLAN


Sheet No.

A-102


Scale:

SECOND FLOOR PLAN

1/8" = 1'-0"

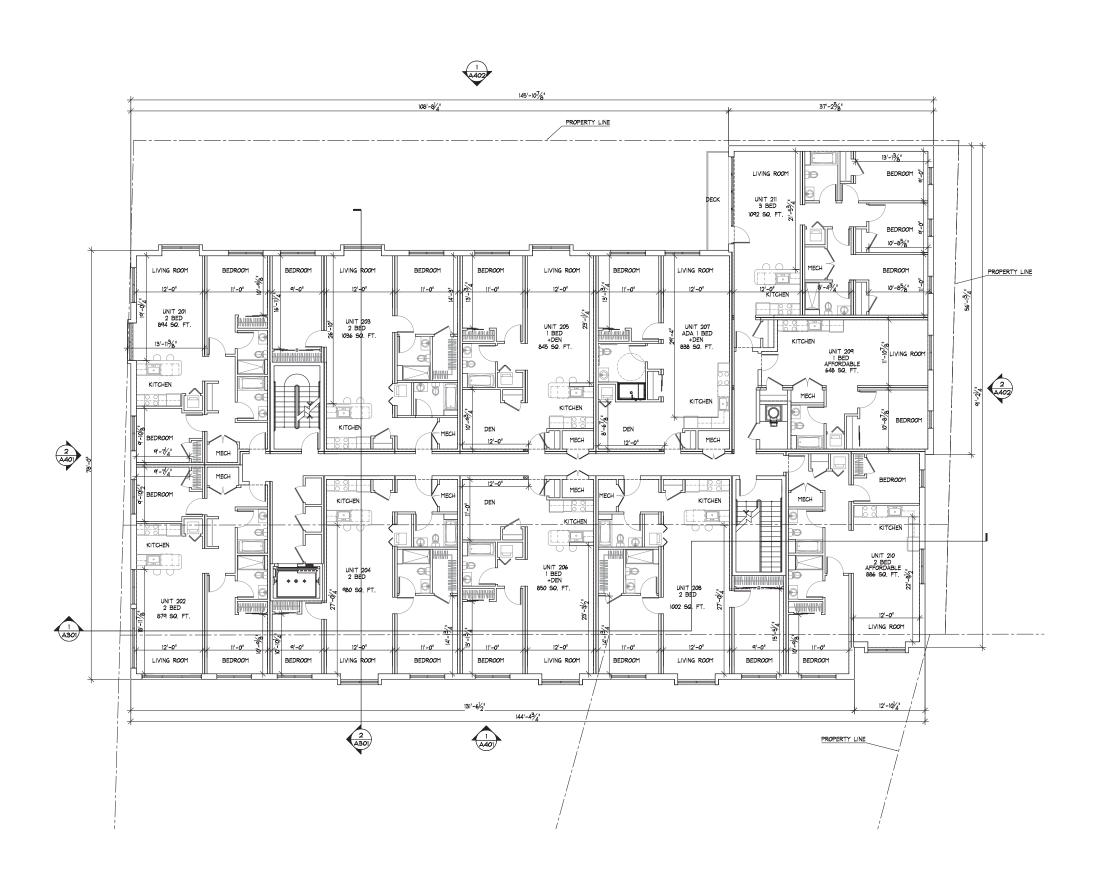

Allston, MA

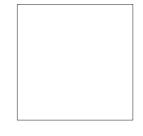





SECOND FLOOR PLAN


Sheet No.

A-102

Scale:

SECOND FLOOR PLAN


1/8" = 1'-0"

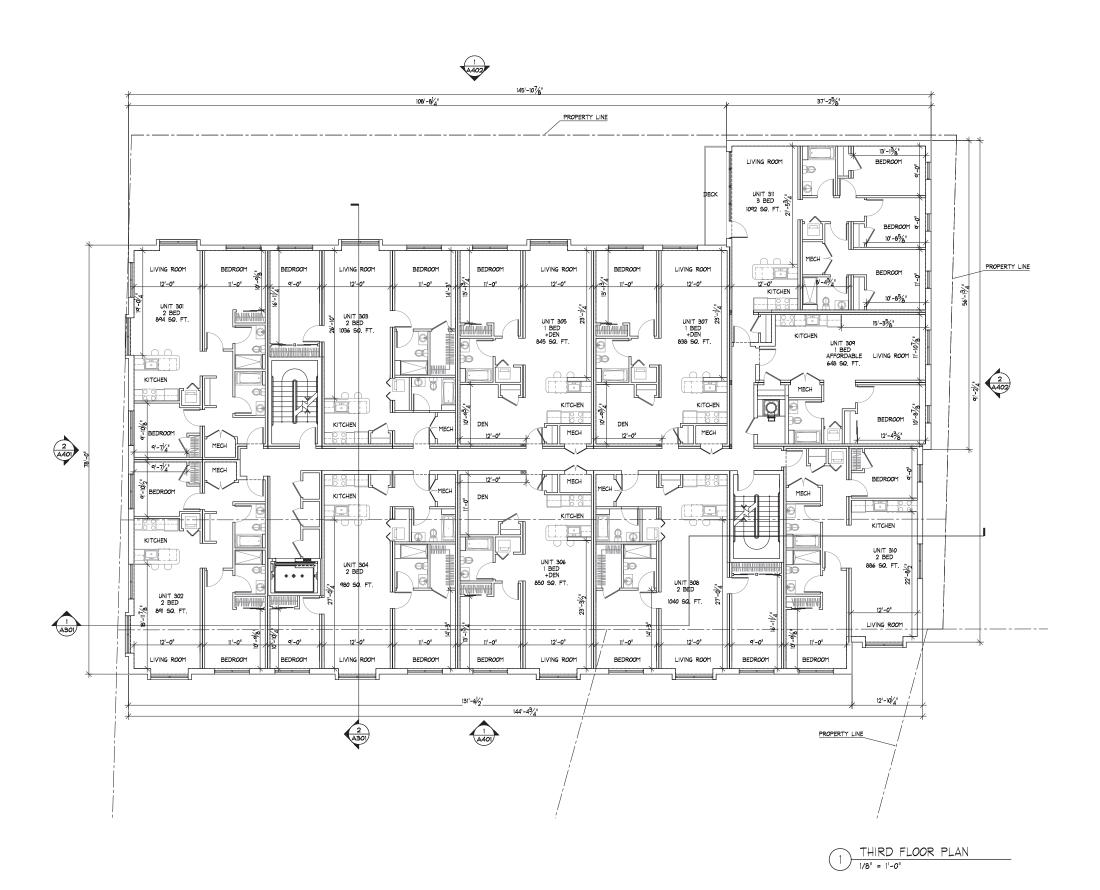

Allston, MA





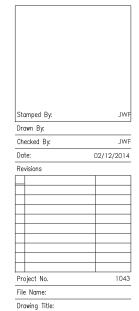


THIRD FLOOR PLAN

Sheet No.

A-103

1/8" = 1'-0"

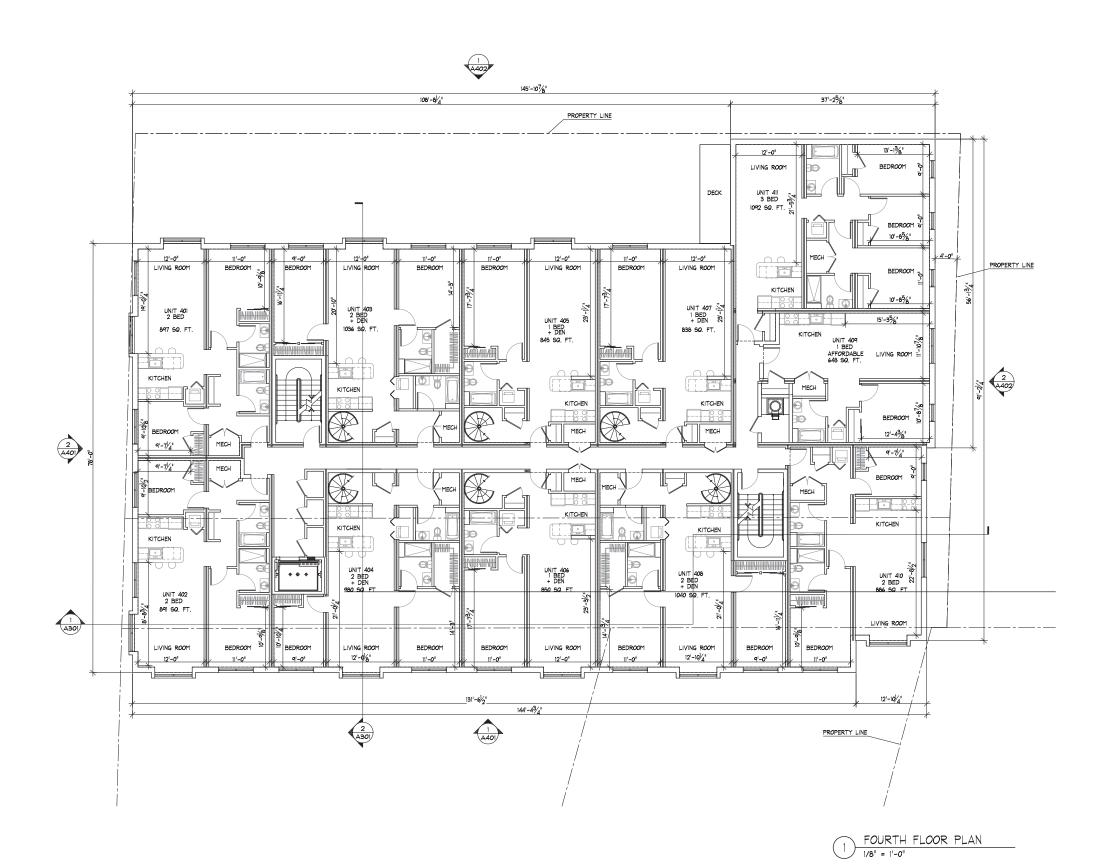

Allston, MA








FOURTH FLOOR PLAN

Sheet No

A-104

1/8" = 1'-0"

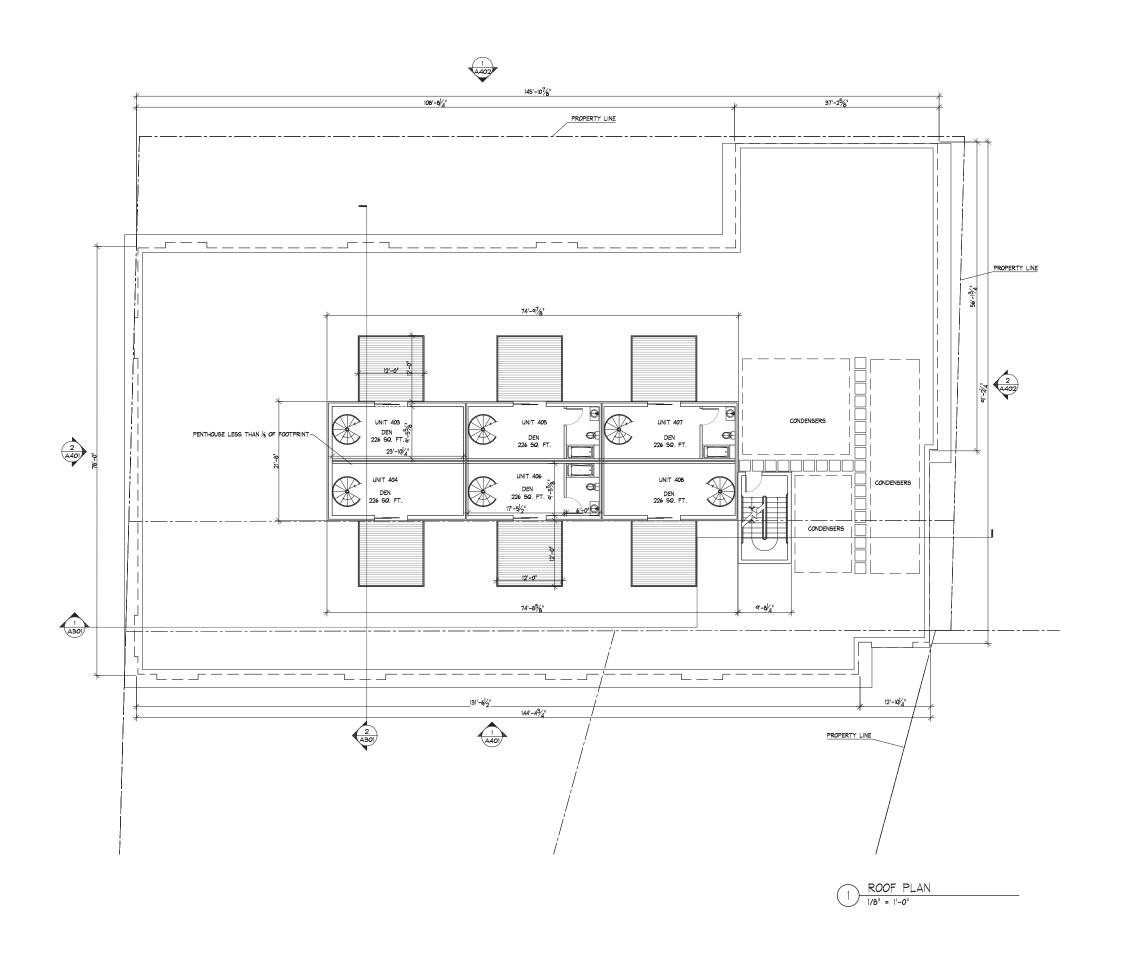

Allston, MA








ROOF PLAN


et No.

A-105

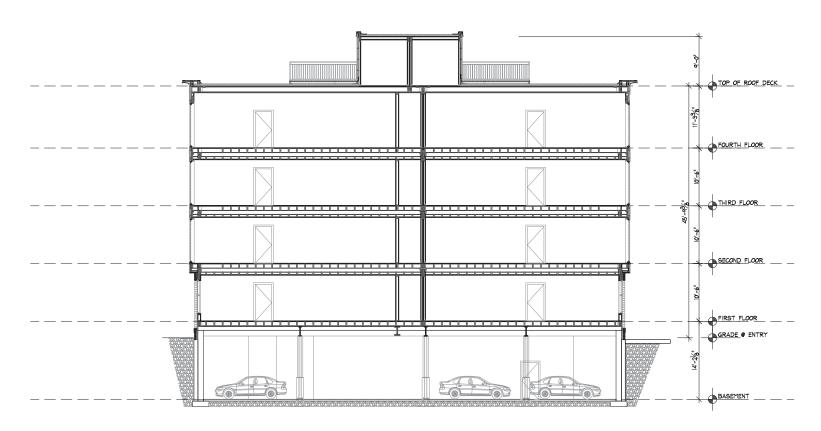


2 CROSS SECTION

1/8" = 1'-0"

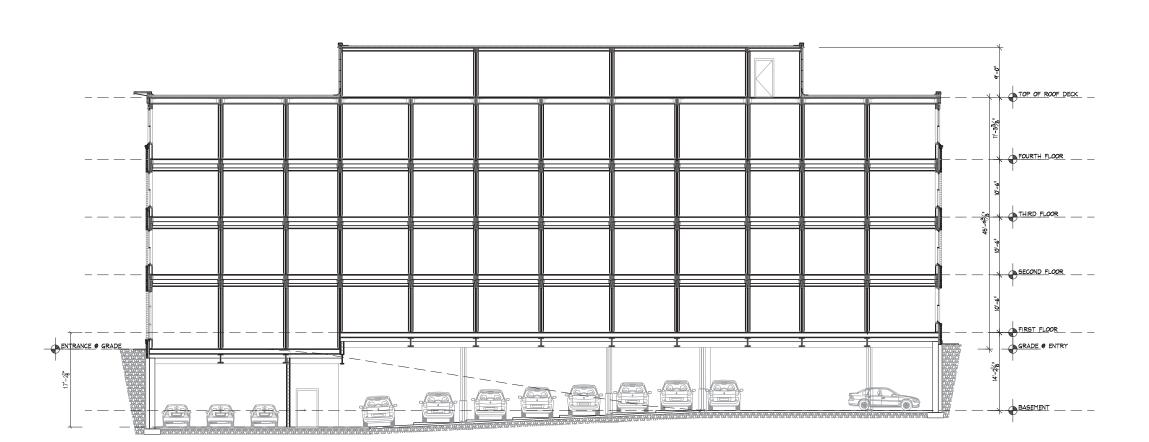

450 CAMBRIDGE STREET

Allston, MA

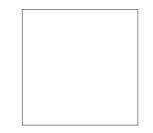



Stamped By:	JWF
Drawn By:	
Checked By:	JWF
Date:	02/12/2014
Revisions	
_	
	\rightarrow
Project No.	1043
File Name:	
Drawing Title:	

BUILDING SECTIONS

1/8" = 1'

Sheet No. A-301

Scale:

LONGITUDINAL SECTION

1/8" = 1'-0"





Allston, MA





Stamped By:	J
Drawn By:	
Checked By:	J
Date:	02/12/20
Revisions	
Project No.	10
File Name:	


BUILDING ELEVATIONS

Sheet No.
Scale:


A-401

2 NORTH ELEVATION
1/8" = 1'-0"



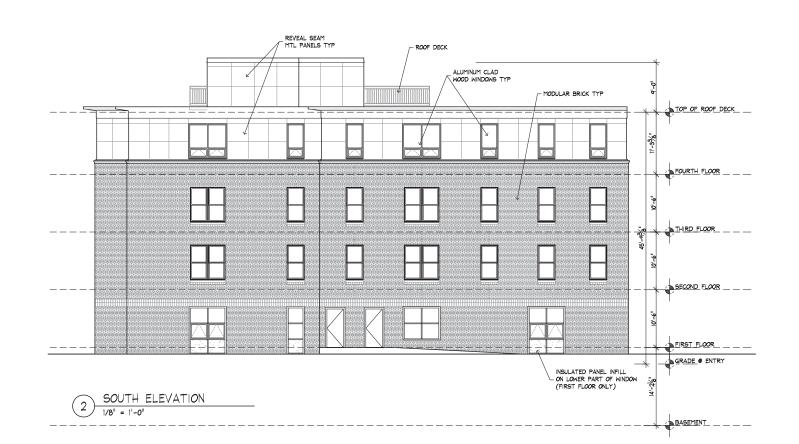

Allston, MA

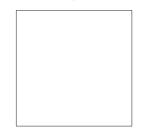



Stamped By:	JV		
Drawn By:			
Checked By:	JV		
Date:	02/12/201		
Revisions			
Project No.	104		
File Name:			

BUILDING ELEVATIONS

Sheet No.

A-402

1/8" = 1'



Allston, MA





Stamped By:	JV
Drawn By:	
Checked By:	JV
Date:	02/12/201
Revisions	
Project No.	104

RENDERING 1

Sheet No

Scale.



Allston, MA





Neshamkin French Architects, Inc Architects Preservation Planners Development Consultation Support Inc. 1812/42742 Challetown, MA, 02129 (ox. 617.242742

Stamped By: JWF Drawn Bv:

Project No.

Project No.
File Name:
Drawing Title:

RENDERING 2

Sheet No

Scale:



Allston, MA





Neshamkin French Architects, Inc Architects Preservation Planners Development Consultation Support Inc. 1812/42742 Challetown, MA, 02129 (ox. 617.242742

> tomped By: JWF rown By:

Drawn By:

Checked By:

Date:

02/12/2014

Revisions

Project No.

1043

File Name:

Drawing Title:

RENDERING 3

Sheet No

Scale:

TRANSPORTATION FACT SHEET

446-450 Cambridge Street

Allston, Massachusetts

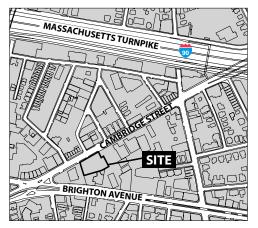


Figure 1. Site Location

Project Description

As shown in **Figure 1**, the Project site is located at 446-450 Cambridge Street in the Allston/Brighton neighborhood of Boston. The Project will create 40 residential apartments and 1,630 sf of retail space. The site is bounded by Cambridge Street to the north, Suspension Specialists automobile repair shop on Brighton Avenue to the south, a driveway to the adjacent Action Bearing Company to the east, and Craftsman Street to the west. There are currently three buildings located on the total site: one main building housing a Domino's Pizza, Ora Catering Company, and four residences; one lower building housing Paperworks and DoReMi; and a small house currently being used as an office by the owner. The main building will remain on the site while the lower building and house will be demolished for the Project.

Parking and Loading

The 17 existing surface spaces will remain for the retail and food service customers of the main and proposed buildings. The Project will also have 40 parking spaces in an underground parking garage, to accommodate the parking demand generated by the 40 new residential units. The proposed parking supply, at 1.0 spaces per residential unit, is within the Boston Transportation Department (BTD) guidelines for the Allston/Brighton neighborhood.

On-site secure bicycle storage for residents will be provided for 40 bicycles.

Residential deliveries will be infrequent and generally involve overnight delivery service and postal delivery as well as the occasional furniture delivery, all of which will be accommodated in the surface parking lot. Move-in and move-out activity will occur in the surface lot but scheduled by advance arrangement. Trash and recycle pick-up will be provided by a private service in the alley just south (behind) the site. This alley can be accessed from Brighton Avenue between the Suspension Specialists

automobile repair shop and the Deaf-Blind Contact Center. This area is currently used for trash and recycling and will remain usable for this purpose in the future.

Site Access

The proposed site plan is provided in **Figure 2**. Current site access is provided by two curb cuts on Cambridge Street (one to access the surface lot located on the northwest corner of the site and one to access the small house located on the northeast corner of the site) and one curb cut on Craftsman Street to access the surface lot for customers of the main and lower buildings. This surface lot and all three curb cuts will continue to be provided in the proposed project. The curb cut to access the small house will become the access and egress for the project's underground garage. Primary pedestrian access to the residential lobby will be provided on Cambridge Street. There will be a secondary residential entrance/egress located on the western side of the site, between the existing main building and the proposed residential building.




Figure 2. Site Plan

Public Transportation

The MBTA provides bus service in the area and most routes connect to the Green Line, the Orange Line, or the Red Line. The Green Line B Branch is located approximately a half mile from the site. As shown in Figure 3, MBTA bus routes operating near the site include routes #57, #57A, #64, and #66.

The Green Line B Branch connects Boston College with Government Center. Route #57/#57A operate along Brighton Avenue with service between Watertown Yard and Kenmore Square. Route #64 operates on Cambridge and North Beacon Streets with service between Oak Square and Kendall Square. Route #66, connecting Harvard Square to Dudley Square operates along Cambridge Street and Brighton Avenue.

Figure 3. Public Transportation

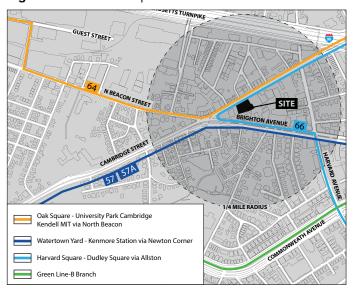

Travel Mode Split

Travel Mode split data for the area was provided by the BTD (area 17). Peak hour travel mode split expected for residents and retail customers of the project is shown in **Table 1**.

Table 1. Travel Mode Split

Mode	Apartment	Retail
Transit	22%	13%
Bicycle/Walk	31%	32%
Auto	47%	55%

Trip Generation

Trip generation for the existing buildings (to be demolished) and the Project are based on the Institute of Transportation Engineer's (ITE) trip generation handbook, 9th edition and travel mode splits for the Allston/Brighton neighborhood as provided by BTD. The existing buildings, to be demolished, consists of approximately 1,000 sf of office space and 9,700 sf of retail space. The existing buildings generate a total of 22 vehicle trips during the AM peak hour and 65 trips during the PM peak hour.

The Project's 40 residential units and 1,630 sf of retail space will generate approximately 17 vehicle trips during the AM peak hour and 35 vehicle trips during the PM peak hour. A summary of trips, by travel mode, is shown in **Table 2**.

Table 2. Project Trip Generation

	Transit Trips	Bicycle/ Walk Trips	Vehicle Trips
Daily			
Entering	100	198	215
Exiting	100	198	215
Total	200	396	430
AM Peak Hour			
Entering	4	6	7
Exiting	7	11	10
Total	11	17	17
PM Peak Hour			
Entering	13	23	19
Exiting	11	16	16
Total	24	39	35

The Project will generate fewer vehicle trips during peak hours than the existing office and retail space and, therefore, will not increase traffic volumes on the surrounding roadways.

Summary

For the proposed 446-450 Cambridge Street project, the total peak hour vehicle activity will be less than the existing peak hour vehicle activity. Typical of small to medium sized urban residential developments, overall vehicle trip generation is not substantial because many residents will use transit, ride bicycles, or walk. The streets and intersections in the immediate vicinity will not have to serve additional vehicular traffic due to this project.

The Project's vehicle parking supply will be adequate to meet the BTD guidelines and the expected parking demand for the residential/retail development.