

PROPOSED NEW MULTUNIU RESIDENTIAL BUILDING

GENERAL NOTES

APPLICABLE CODES AND LAWS.

- 1. THE CONTRACTOR IS RESPONSIBLE FOR OBTAINING AND PAYING FOR ALL PERMITS REQUIRED FOR THIS PROJECT.
- 2. THE CONTRACTOR IS SOLELY RESPONSIBLE FOR MEANS, METHODS, TECHNIQUES, SEQUENCING, SCHEDULING AND SAFETY FOR THIS
- MASSACHUSETTS STATE BUILDING CODE AND ALL OTHER
- 4. THE CONTRACTOR SHALL VISIT THE SITE AND BE THOROUGHLY AQUATINTED WITH THE PROJECT PRIOR TO SUBMITTING A PRICE ADDITIONAL MONEY WILL NOT BE GRANTED FOR WORK NOT CLARIFIED PRIOR TO BIDDING. SPECIFICATIONS OR FIELD CONDITIONS TO THE ARCHITECT IMMEDIATELY.
- 5. THE CONTRACTOR SHALL REPORT ANY DISCREPANCIES BETWEEN DRAWINGS SPECIFICATIONS OR FIELD CONDITIONS TO THE ARCHITECT IMMEDIATELY.
- 6. THE CONTRACTOR IS RESPONSIBLE FOR REPAIRING ANY WORK DAMAGED BY HIS FORCES WHILE PERFORMING THIS CONTRACT. 7. THE CONTRACTOR SHALL WARRANTEE HIS WORK FOR A PERIOD OF ONE YEAR FROM THE DATE OF FINAL COMPLETION.

- 1. ALL FOUNDATION FOOTINGS SHALL BE CARRIED DOWN TO A MINIMUM OF 4'-0" BELOW FINISH GRADE, OR DEEPER, IF NECESSARY, TO OBTAIN A SAFE SOIL BEARING PRESSURE OF 2 TONS PER SQUARE FOOT, 2 TONS PER SQUARE FOOT.
- 2. ALL FOOTINGS SHALL BE PLACED ON UNDISTURBED SOIL; OR, ON ENGINEERED BANK RUN GRAVEL FILL MATERIAL WITH A MINIMUM DRY
- 3. ALL FOOTING SHALL BE POURED IN THE DRY ONLY.
- 4. NO FOOTING SHALL BE POURED ON FROZEN GROUND. 5. THE MINIMUM REINFORCING FOR ALL FOUNDATION WALLS SHALL BE 2-#6 BARS AT THE TOP AND BOTTOM, CONTINUOUS; OR, AS SHOWN ON DRAWINGS.
- 6. LAP ALL BARS 40 DIAMETERS AND PROVIDE CORNER BARS. 7. ALL REINFORCEMENT: ASTM A615-60, WWF A185.

CONCRETE NOTES:

- 1. ALL CONCRETE SHALL ATTAIN A MINIMUM COMPRESSIVE STRENGTH
- 2. MAXIMUM SLUMP SHALL NOT EXCEED 3"; AND MAXIMUM; COARSE AGGREGATE SIZE SHALL NOT EXCEED 3/4" IN DIAMETER.
- 3. ALL CONCRETE SLABS SHALL BE POURED IN 900 SQUARE FOOT PANELS, MAXIMUM; OR, PROVIDE CONTROL JOINTS BY SAW CUTTING THE SLAB WHILE THE CONCRETE IS STILL GREEN.

WOOD LINTEL SCHEDULE:

Lintels over openings in bearing walls shall be as follows; or as noted on drawings.

Span of opening:	Size: 2x6 studs	Size: 2x4 studs			
less than 4'-0"	3 - 2x4	2 - 2x4			
up to 6'-0"	3 - 2x6	2 - 2x6			
up to 8'-0"	3 - 2x8	2 - 2x8			
up to 10'-0"	3 - 2x10	2 - 2x10			

DESIGN CRITERIA:

ALL WORK PERFORMED UNDER THIS CONTRACT SHALL CONFORM TO THE **EIGHTH EDITION** OF THE MASSACHUSETTS BUILDING CODE.

DESIGN LIVE LOAD =40 POUNDS PER SQUARE FOOT

= 100 POUNDS PER SQUARE FOOT - DECK AND STAIRS

WIND LOAD

SEISMIC:

= 105 MILES PER HOUR

 $S_S = 0.29$ S1 = 0.068

FLOORS

DESIGN SNOW LOAD = 45 POUNDS PER SQUARE FOOT

WITH SNOW DRIFT WHERE APPLICABLE

244 HUMBOLDU AVENUE DORCHESTER, MASSACHUSETTS

REINFORCING NOTES:

- 1. ALL REINFORCEMENT, EXCEPT FOR TIES AND STIRRUPS, SHALL CONFORM TO ASTM 615-60.
- 2. ALL REINFORCEMENT FOR TIES AND STIRRUPS SHALL CONFORM TO ASTM 615-40.
- 3. ALL WELDED WIRE FABRIC SHALL CONFORM TO ASTM A185-70 SPECIFICATIONS.
- 4. ALL REINFORCEMENT SHALL BE INSPECTED AND APPROVED BY THE ARCHITECT OF HIS ENGINEER PRIOR TO THE PLACEMENT OF ANY CONCRETE.
- 5. THE CONTRACTOR SHALL SUBMIT A REPRODUCIBLE SEPIA AND FOUR PRINTS OF SHOP DRAWINGS: SHOWING ALL REINFORCING DETAILS, CHAIR BARS, HIGH CHAIRS, SLAB BOLSTERS, ETC. TO THE ARCHITECT FOR HIS APPROVAL. THE CONTRACTOR SHALL RECEIVE WRITTEN APPROVED SHOP DRAWINGS FROM THE ARCHITECT OR HIS ENGINEER PRIOR TO THE FABRICATION OF REINFORCEMENT
- 6. CLEARANCES OF MAIN REINFORCING FROM ADJACENT CONCRETE SURFACES

SHALL BE AS FOLLOWS:

A. FOOTINGS 3 INCHES

B. SIDES OF FOUNDATIONS WALLS. EXPOSED FACES OF FOUNDATIONS. SIDES OF COLUMNS/PIERS, SLABS

ON GRADE FROM TOP SURFACE

2 INCHES

C. INTERIOR FACES OF FOUNDATIONS, TOP REINFORCING IN SLABS EXPOSED

TO THE WEATHER

1-1/2 INCHES D. TOP STEEL OF INTERIOR SLABS 1 INCHES

7. MAXIMUM DEVIATION FROM THESE REQUIREMENTS SHALL BE 1/4" OF SECTIONS 10" OR LESS. 1/2" FOR SECTIONS GREATER THAN 10"

WOOD NOTES:

- 1. ALL LUMBER SHALL HAVE A MOISTURE CONTENT OF NOT MORE THAN 19%.
- 2. ALL FRAMING LUMBER SHALL BE #2 HEM-FIR, OR BETTER, HAVING A MINIMUM: FB=1,200 PSI, FV=70 PSI, E=1,300,000 PSI.
- 3. ALL L.V.L. LUMBER DENOTED ON PLANS SHALL HAVE A MINIMUM: FB=2,600 PSI, FV=285 PSI, E=1,900,000 PSI.
- 4. ALL JOIST SPANS SHALL HAVE ONE ROW OF 1" X 3: CROSS BRIDGING AT MID SPAN AND NOT MORE THAN 8'-O" O.C.
- 5. ALL STUD BEARING WALLS SHALL HAVE ONE ROW OF 2X HORIZONTAL BLOCKING AT 1/2 STUD HEIGHT. AND NOT MORE THAN 6'-O" O.C. MAXIMUM.
- PROVIDE AND INSTALL ALL NECESSARY TIMBER CONNECTORS WITH ADEQUATE STRENGTH.
- PROVIDE DOUBLE JOIST BELOW PARTITIONS PARALLEL TO JOIST FRAMING.
- PROVIDE SOLID BRIDGING BELOW PARTITIONS PERPENDICULAR TO JOIST FRAMING.
- 9. PROVIDE SOLID BRIDGING BETWEEN JOIST FRAMING MEMBERS WHEN BEARING ON STUD PARTITIONS OR BEAMS.
- 10. PROVIDE A CONTINUOUS BAND JOIST AT EXTERIOR STUD WALLS.
- 11. PROVIDE DIAGONAL METAL STRAP BRACING AT ALL CORNERS AND WALL INTERSECTIONS, AT THE INSIDE FACE OF STUDS, FROM TOP PLATE TO FLOOR PLATE AT 45°, SIMPSON TYPE "CWB", OR EQUAL.
- 12. ALL BUILT-UP BEAMS SHALL BE BOLTED WITH 1/2" DIAMETER BOLTS, MEETING A307 STANDARDS, OR, AS NOTED ON DRAWINGS.

ZONING SUMMARY

ROXBURY NEIGHBORHOOD - ARTICLE 50 MFR - MULTIFAMILY RESIDENTIAL SUBDISTRICT

ANY OTHER DWELLING	LOT SIZE	LOT AREA PER ADD. UNIT	LOT WIDTH/ FRONTAGE	F.A.R	BLDG HEIGHT	OPEN SPACE PER UNIT	FRONT SETBACK	SIDE SETBACK	REAR SETBACK	PARKING REQUIREMENT
REQUIRED BY ZONING	4,000 SF FOR FIRST 3 UNITS	1,000 SF	40'	1.0	4 STORIES 45'-0"	200 SF	20'-0"	10'	25'	1 SPACE PER UNIT
EXISTING SINGLE FAMILY	4,000 SF FOR FIRST 3 UNITS	1,000 SF	65'	1.0	2.5 STORIES	6609 SF± PER UNIT	32.9'	L: 14.3' R: 8.6'	144'±	1 SPACE PER UNIT
PROPOSED MULTI-UNIT	4,000 SF FOR FIRST 3 UNITS	15401 - 4000 = 11401/11 1,036 SF PER ADD. UNIT	65'	$\frac{\frac{15347}{15401}}{0.99}$	4 STORIES 41'-0"	428 SF± PER UNIT	20.2'	L: 11.8' R: 10.2'	114.9'	14 PARKING SPACES PROVIDED

KEY

(510)

(0)

(c-)

SMOKE DETECTOR CARBON MONOXIDE DETECTOR WALL TYPE (SEE A-3.1)

FAN \boxtimes

45 MIN. DOOR 1 HOUR CLG. ABOVE (A-3.1)

NEW WALL


EX'G WALL TO REMAIN

WALL TO BE REMOVED

CODE SUMMARY

PROP. TYPE 5A CONSTRUCTION PROP. 4 STORY PROP. R-2 USE GROUP PROP.FULLY SPRINKLED & ALARMED



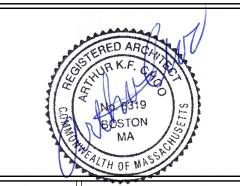

Revision Date

18245 Project No: AS NOTED 12-05-18

DRM

Orawing Name

rawn By:


COVER SHEET

heet No.







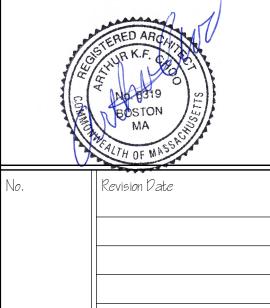


18245 Project No: AS NOTED Date: 12-05-18

DRM Drawn By: Drawing Name

PROPOSED FLOOR PLANS

Sheet No.

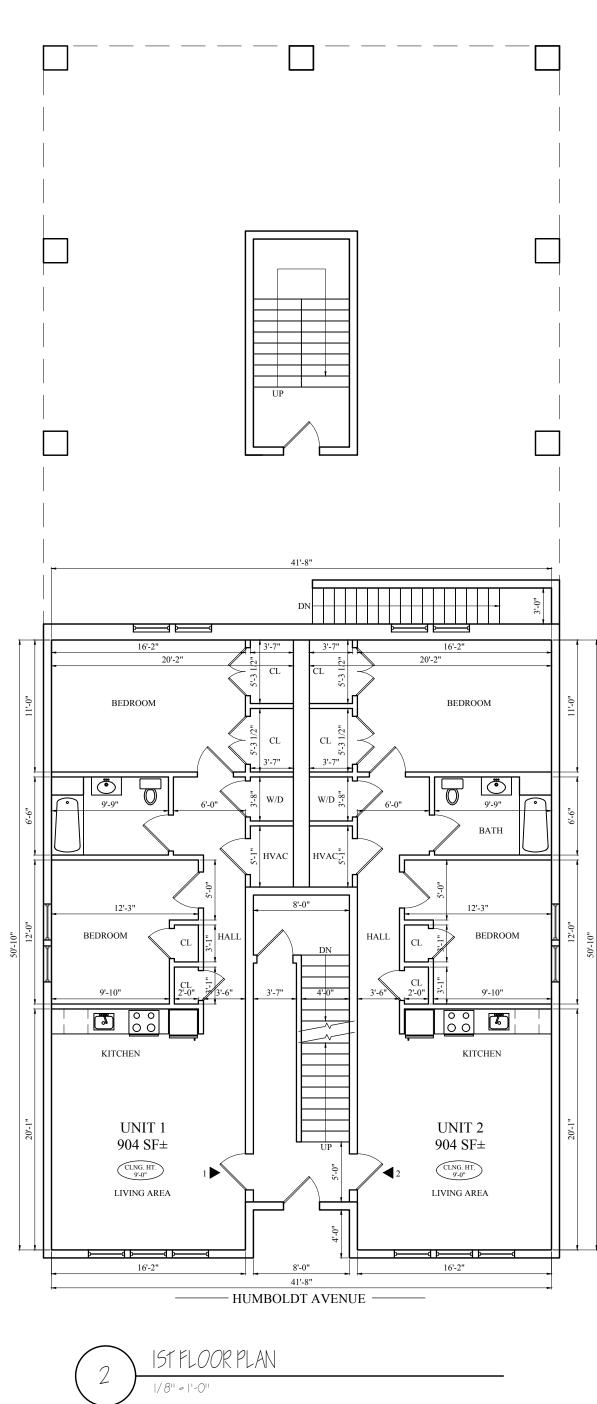

16'-2"

10'-0" 1'-10" 3'-6"
UNIT 5
855 SF±

LIVING AREA

UNIT 3 893 SF±

CLNG. HT. 9'-0"

UNIT 6 $855~\mathrm{SF}\pm$


LIVING AREA

UNIT 4 893 SF±

BEDROOM

▶

——— HUMBOLDT AVENUE ———

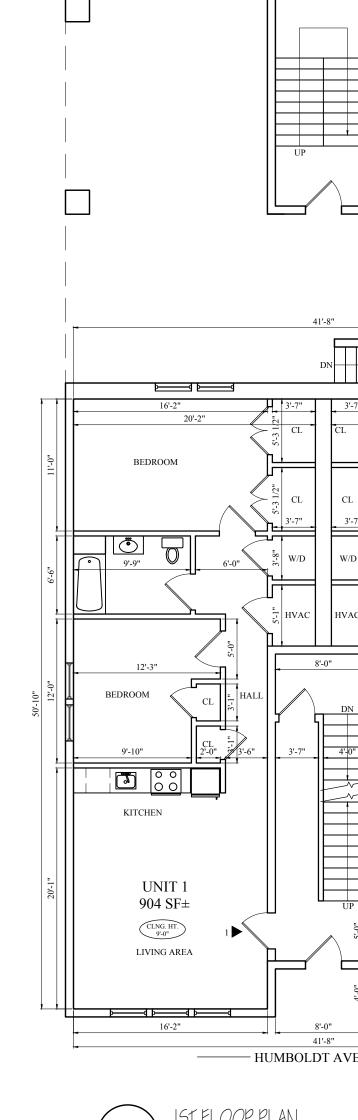

BASEMENT FLOOR PLAN

——— HUMBOLDT AVENUE ———

COMMON BASEMENT / MECHANICAL

SED MULTI-UNIT NG MBOLDT AVENUE





Project No: 18245
Scale: AS NOTED
Date: 12-05-18

Drawn By: DRM
Drawing Name

PROPOSED FLOOR PLANS

Sheet No.

A-| |

