





	Window Schedule														
		Qty	Clear Opening	Nominal Size		Rough Opening		Туре	Glass	U-Factor	SHG	Sq. Ft. Glass	Window Data		
	W1	22	5.96 sf	2'- 8''	5'- 2''	2'- 10 1/4"	5'- 6 1/4"	Double Hung	Low E	0.34	0.3	11.15	Silverline - American Craftsman	3000 Series	
	W2	1	5.96 sf	2'- 10"	5'- 2''	5'- 8''	5'- 6 1/4"	Double Hung x 2	Low E	0.34	0.3	22.3	Silverline - American Craftsman	3000 Series	Factory Mulled
$\Box$	W3	4	4.08 sf	2'- 4''	4'- 2"	2'- 6 1/4"	4'- 5 1/4"	Double Hung	Low E	0.34	0.3	7.57	Silverline - American Craftsman	3000 Series	

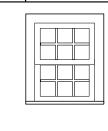

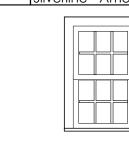

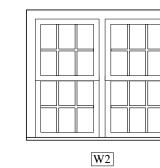

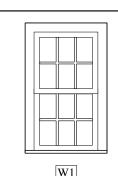


## New Single Family Home


## Hyde Park, Massachusetts

Cover Sheet

- A1 Basement Plan &1st Floor Plan
- A2 2nd Floor Plan & Attic Floor Plan
- A3 1st Floor & 2nd Floor Framing Plans
- A4 Attic Floor & Roof Framing Plans
- A5 Elevations
- A6 Section & Details Site Plan

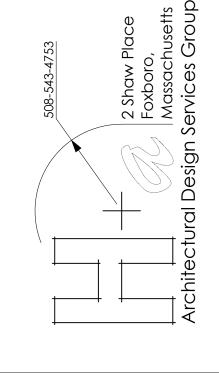

PROJECT:
New Single
Family Home
63 Vallaro Road
Hyde Park, MA

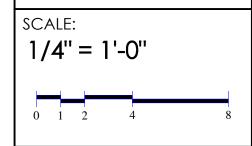


DATE: **4 March 2014** 


REVISIONS:

SHEET TITLE:

SHEET NUMBER:

4 March 2014

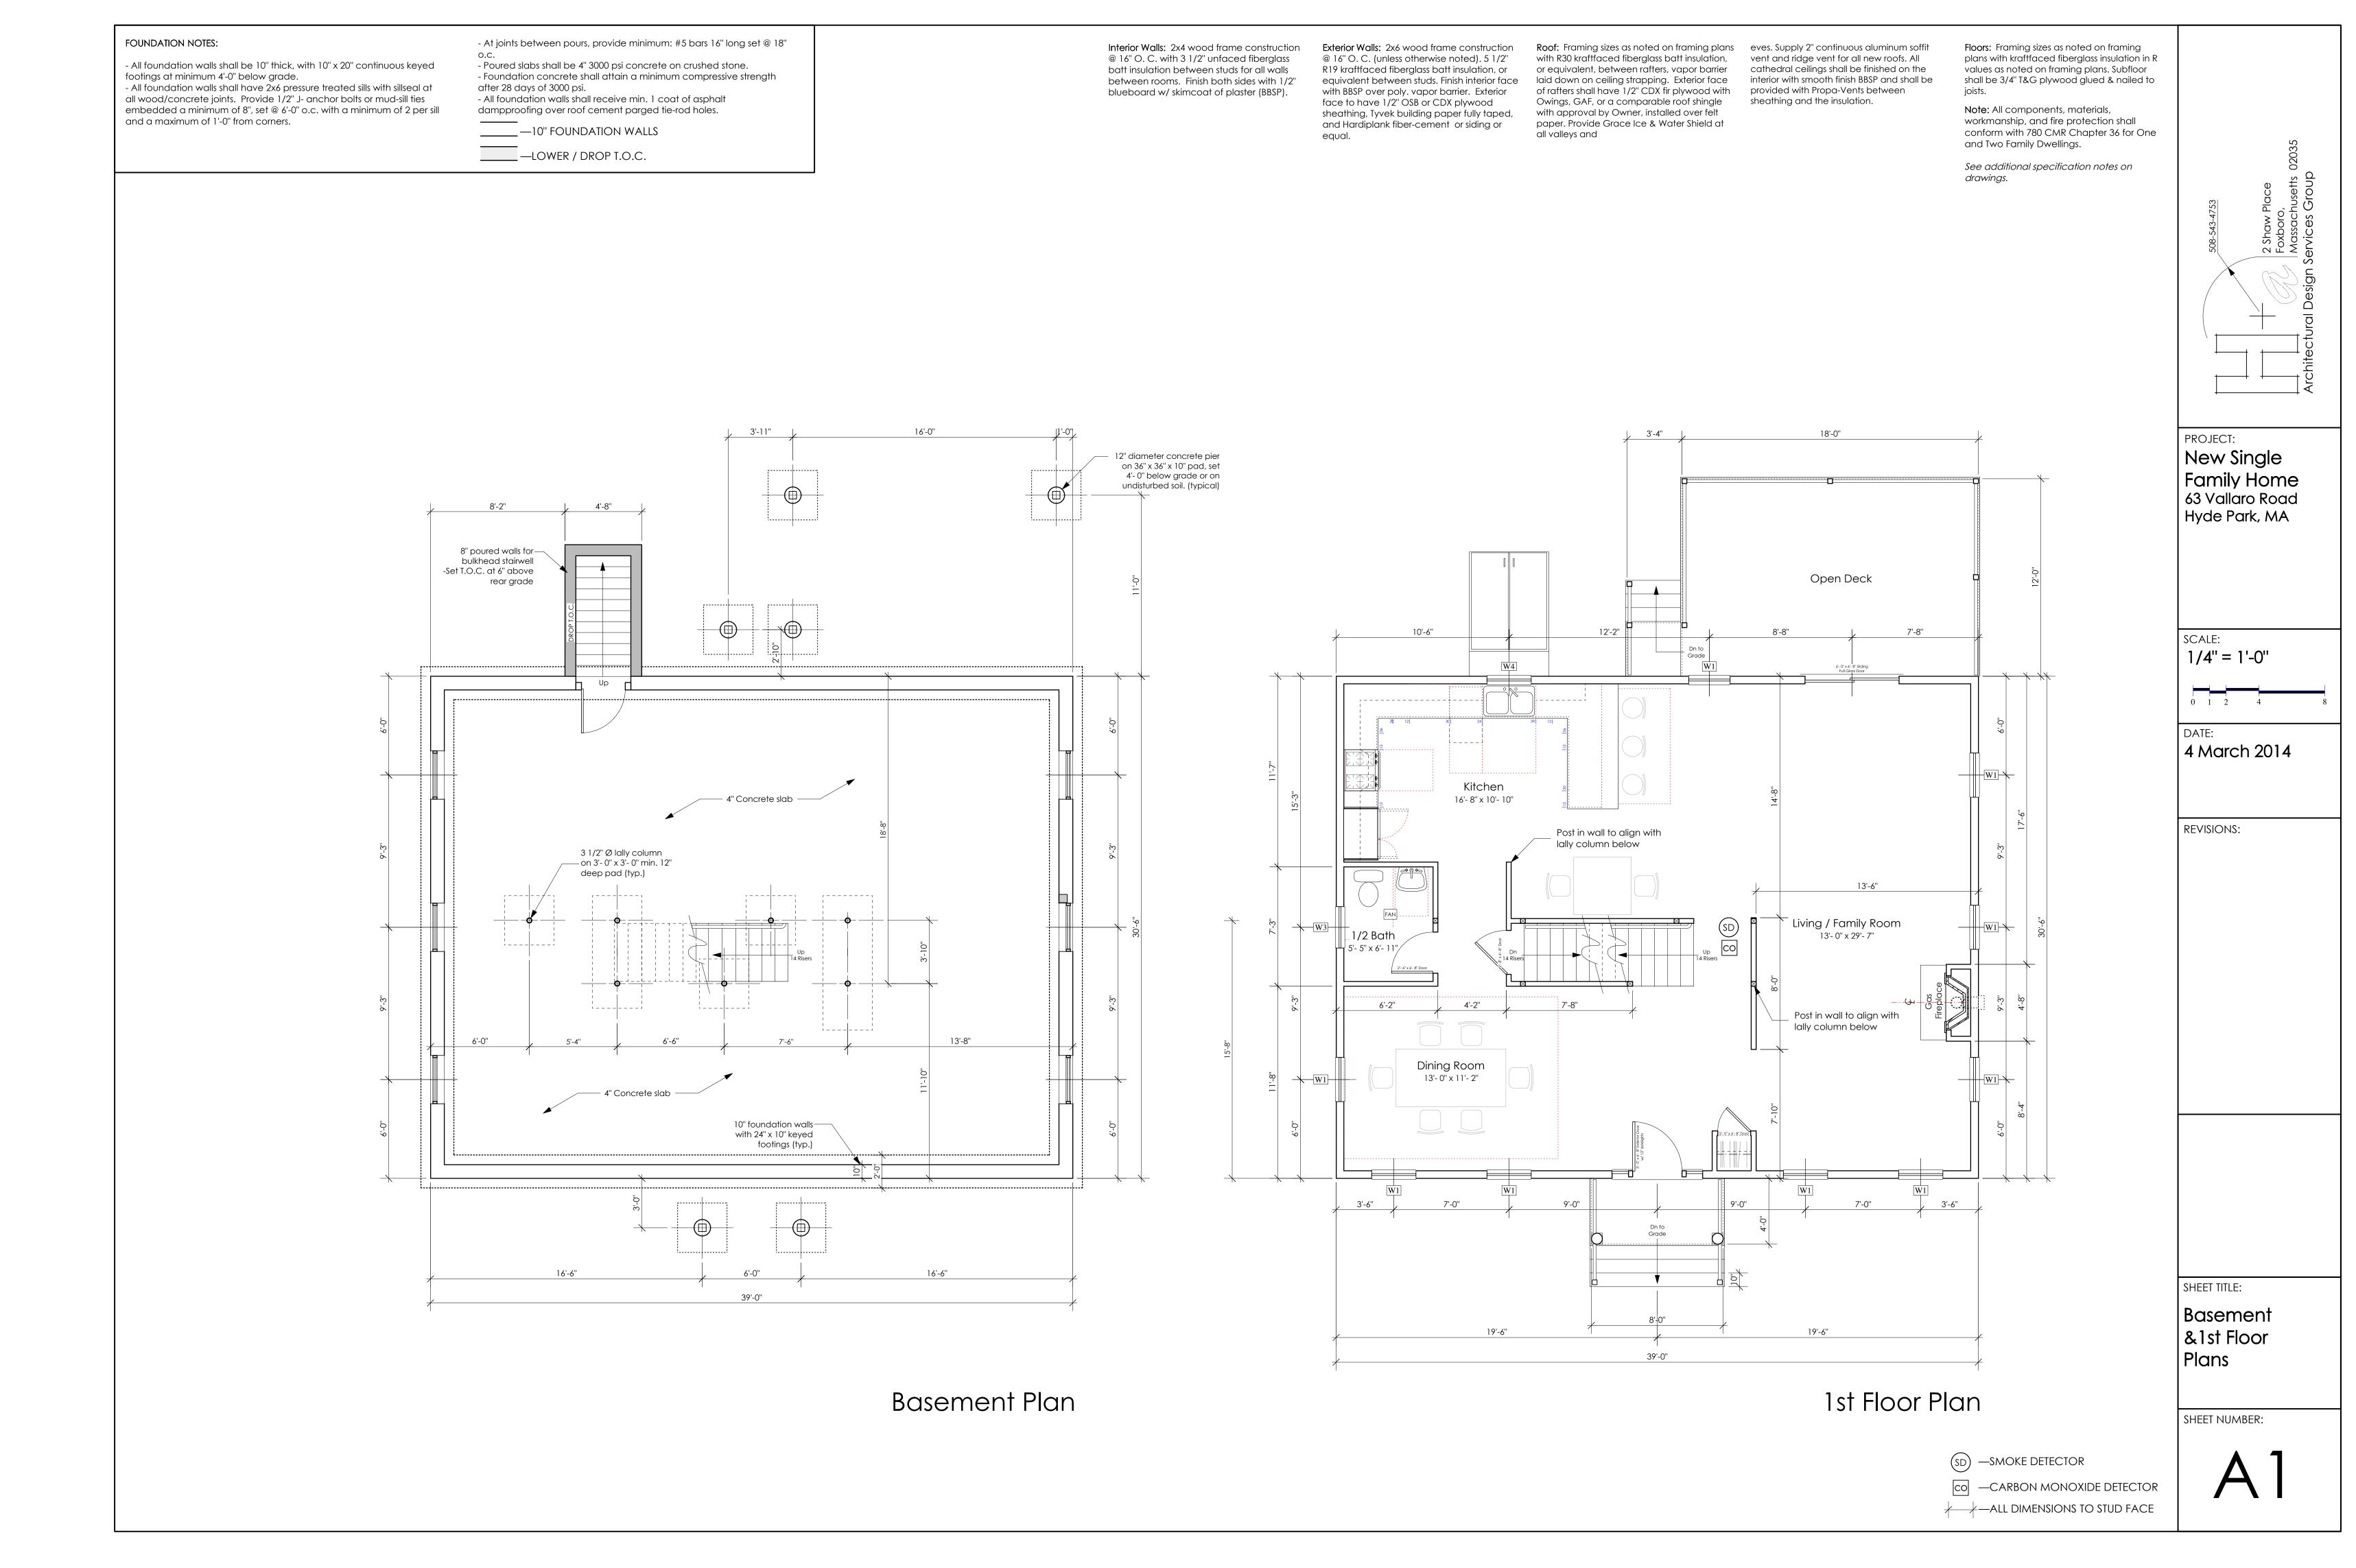

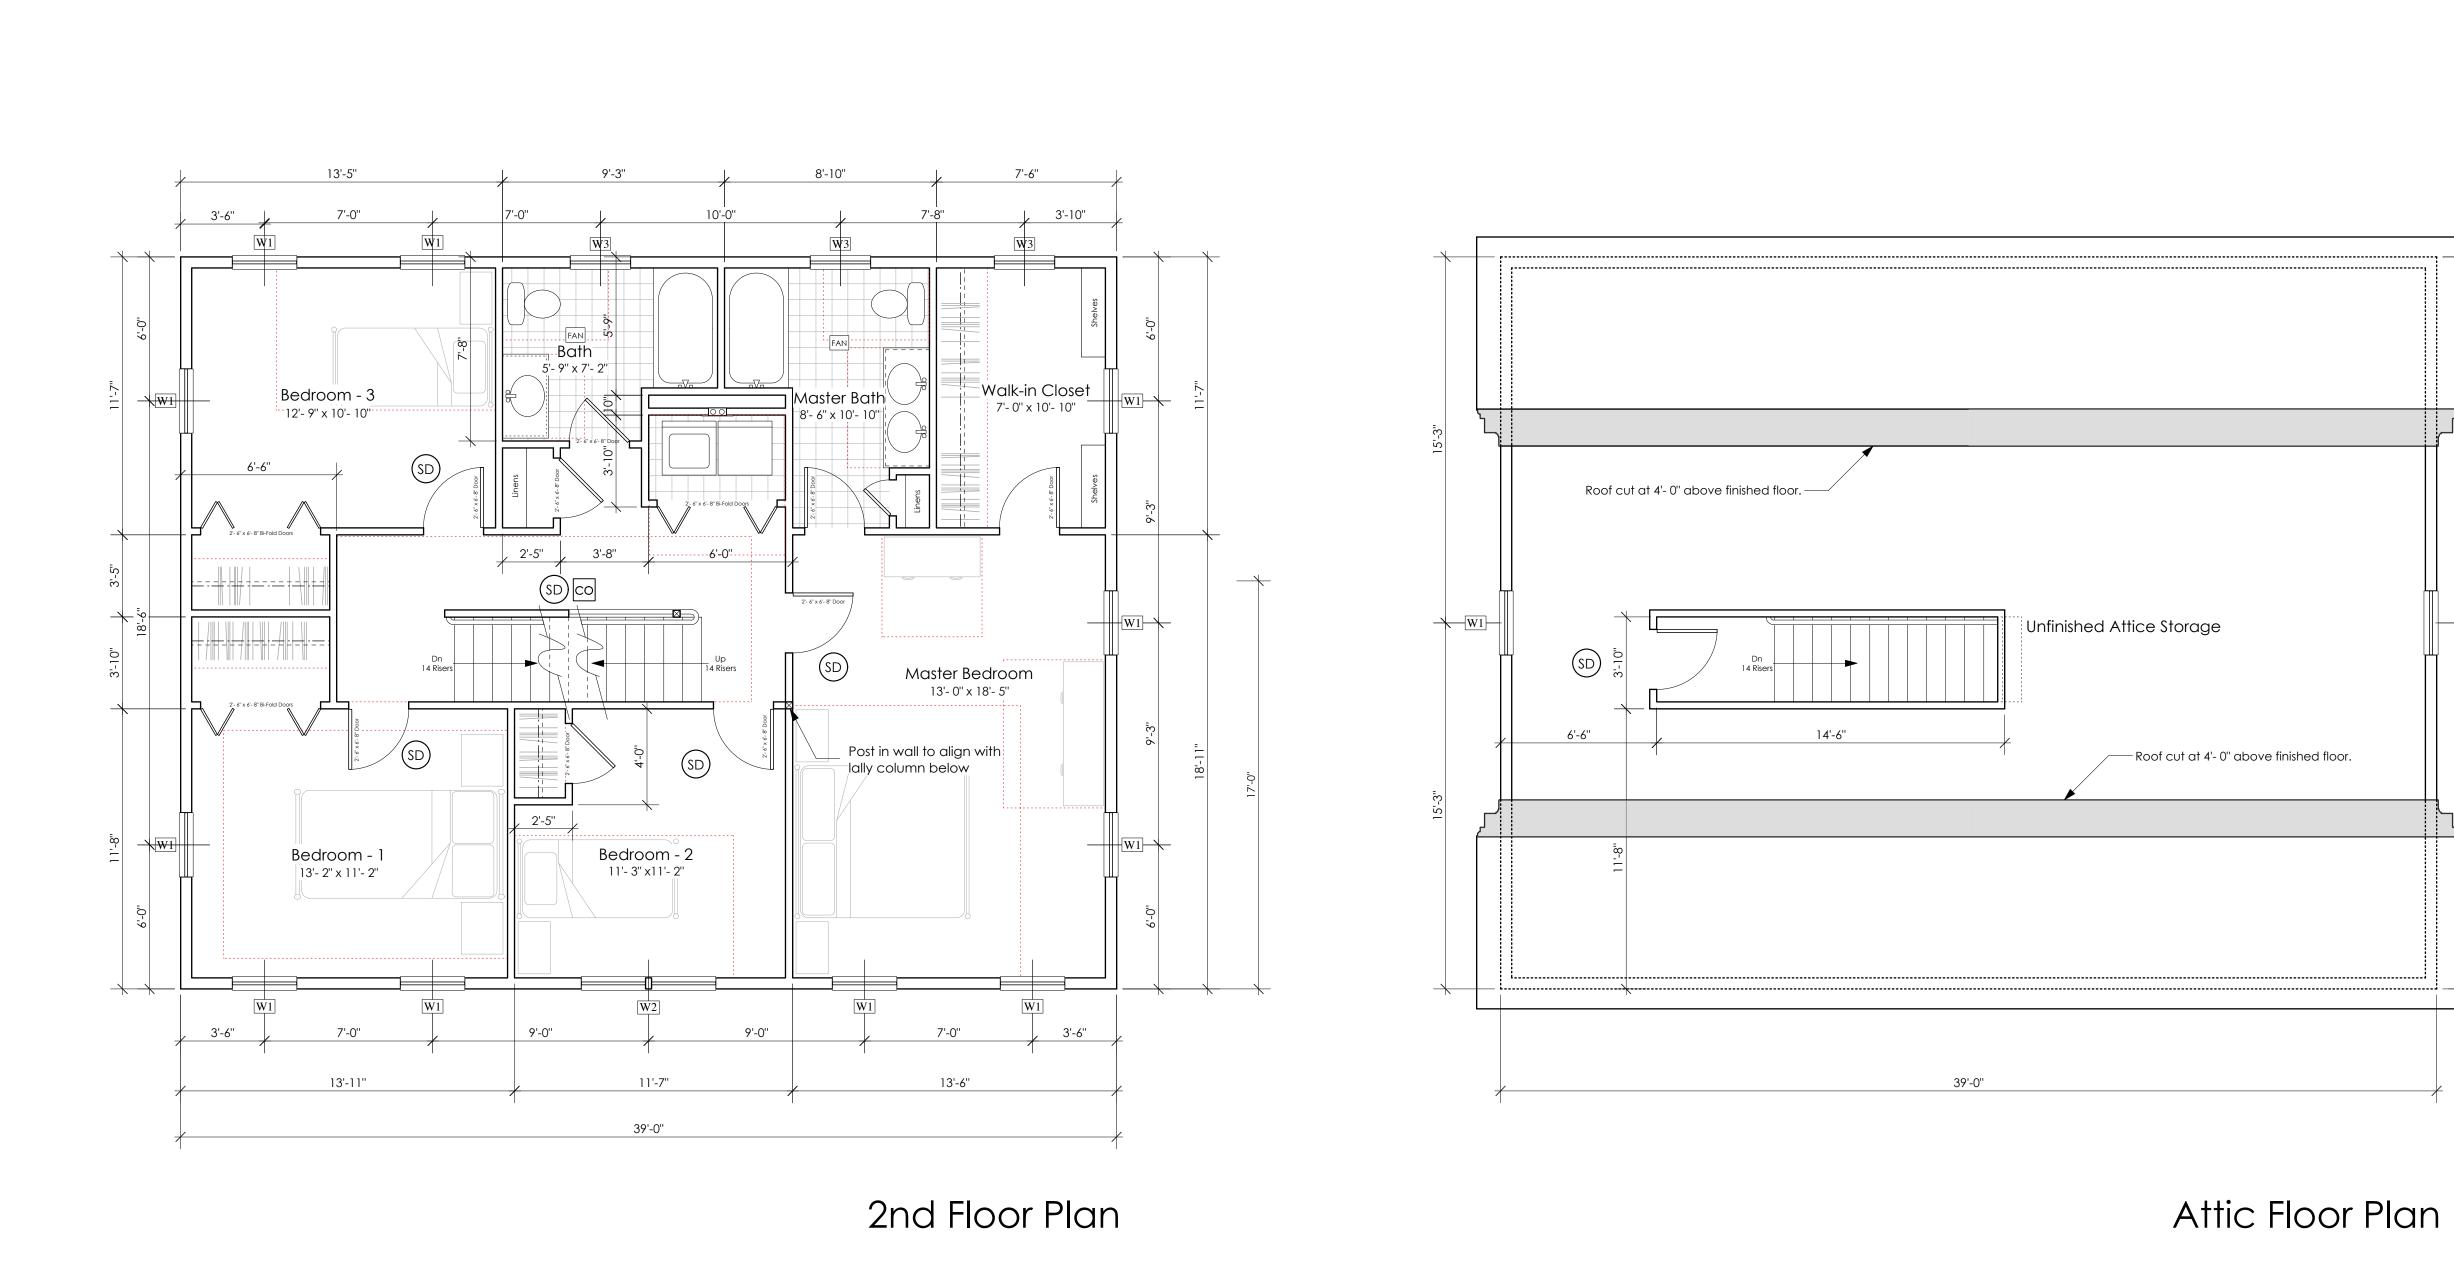

508-543-4753

2 Shaw Place
Foxboro,
Massachusetts 02035

Architectural Design Services Group

PROJECT:
New Single
Family Home
63 Vallaro Road
Hyde Park, MA

SCALE: 1/4" = 1'-0"

DATE: 17 October 2012

REVISIONS:

W1 — W1

SHEET TITLE:

2nd & 3rd Floor Plans

SHEET NUMBER:

A2


STRUCTURAL NOTES: - Follow all manufacturer's specifications and requirements for TJI (I-joist) framing procedures. Including, the use of web fillers, rim joists, bridging, and joist hangers. See additional TJI notes on framing plans by ALL JOIST. - Apply double and triple joists where drawn or noted. at top and bottom. - Microlam LVL multiple member beams shall be glued and spiked according to manufacturer's specifications for nails and nailing pattern. - PSLs may be substitued for multiple LVLs. PSL sizes must be equal or greater to that of the combined - Framing lumber shall be min. #2 Spruce Pine Fir. - Notching of any beams shall be prohibited, notching of joists only as permitted per MA code.

- All sub-floors: 3/4" T&G plywood or 3/4 OSB glued and nailed 8 o.c.

-Exterior sheathing to be 1/2" CDX or OSB 4x8 sheets nailed w/ 6d common @ 8" o.c. - All 1st & 2nd floor window and door headers to be min. 2- 2x10s unless otherwise noted. - Post all engineered lumber beams continuous to - Lally columns shall be 3 1/2" Ø with steel plates set load transfer beams or lally columns & foundation


-ALL ROOF RAFTERS: 2x10s @ 16" o.c. -DOUBLES WHERE DRAWN OR NOTED -ALL 3rd FLOOR CEILING JOISTS / ATTIC FLOOR: 2x10s @ 16" o.c. -SEE FIRST AND SECOND FLOOR


FRAMING PLANS BY ALL-JOIST

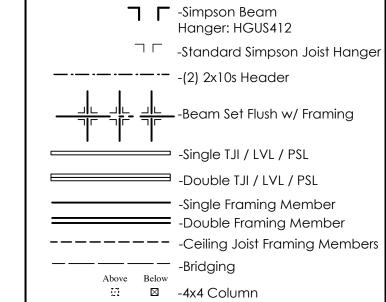


 ⊠ -4x6 Column • • Lally Column

**LEGEND:** 

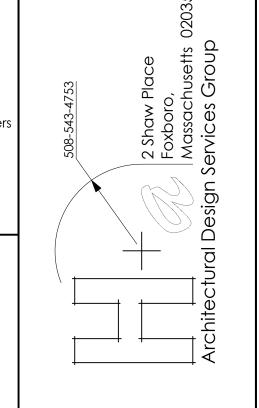

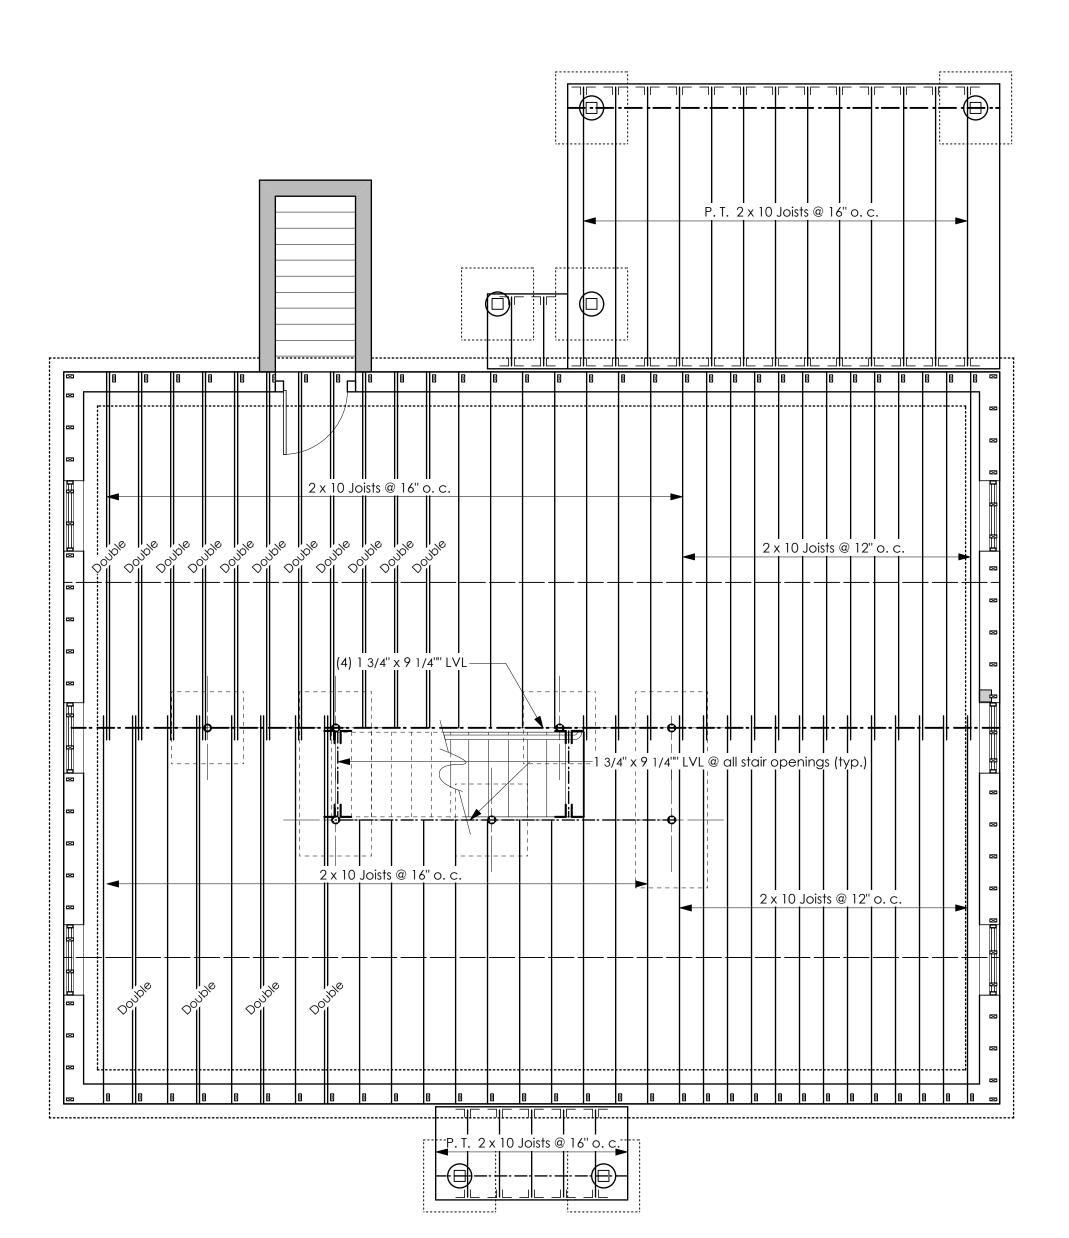

1st Floor Framing Plan

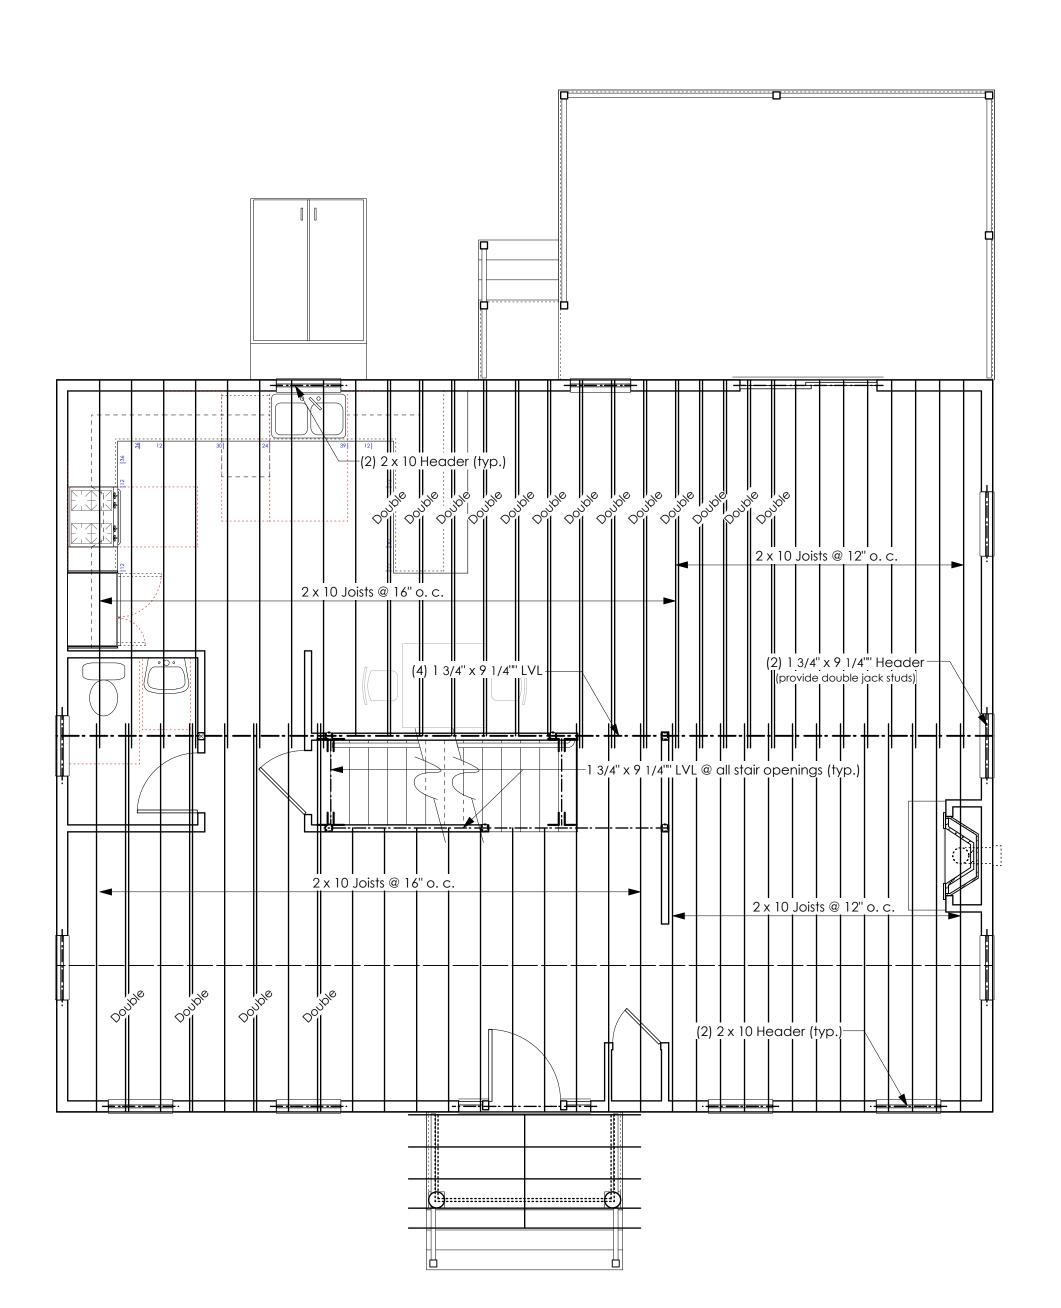

2nd Floor Framing Plan

PROJECT: New Single Family Home 63 Vallaro Road Hyde Park, MA

1/4" = 1'-0"


4 March 2014

REVISIONS:


SHEET TITLE:

1st & 2nd Floor Framing Plans


SHEET NUMBER:

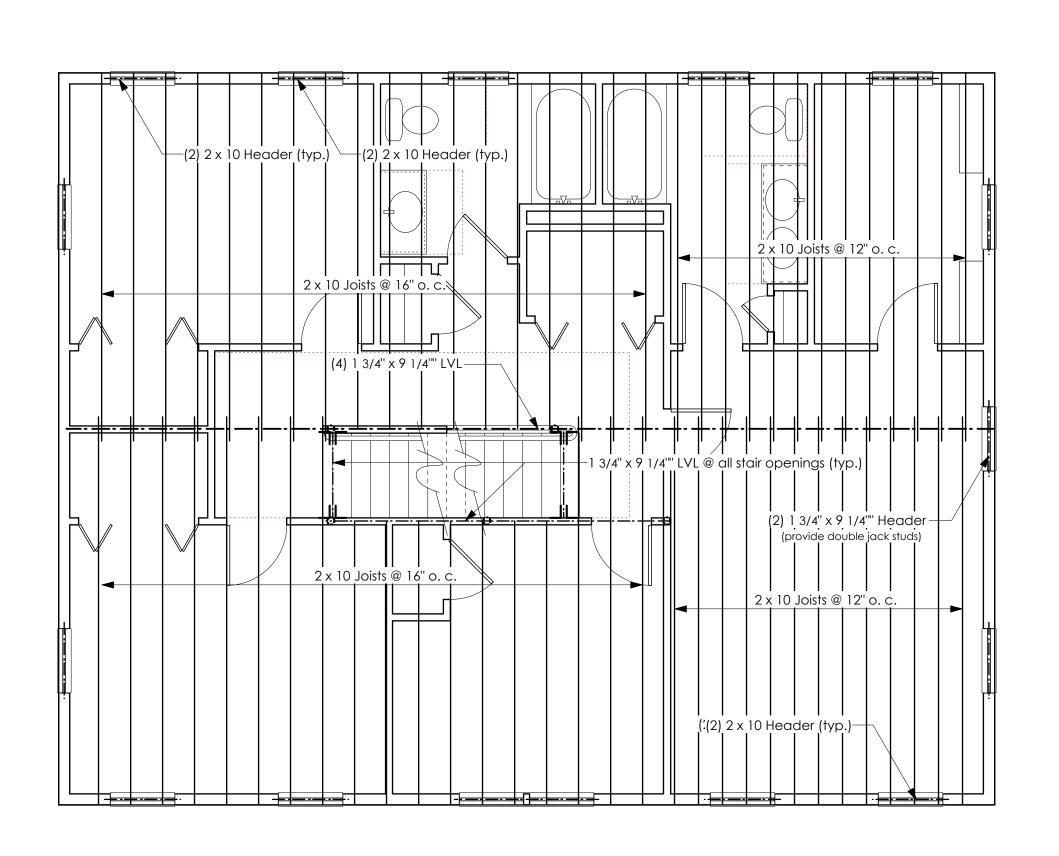

Attic Floor Framing Plan

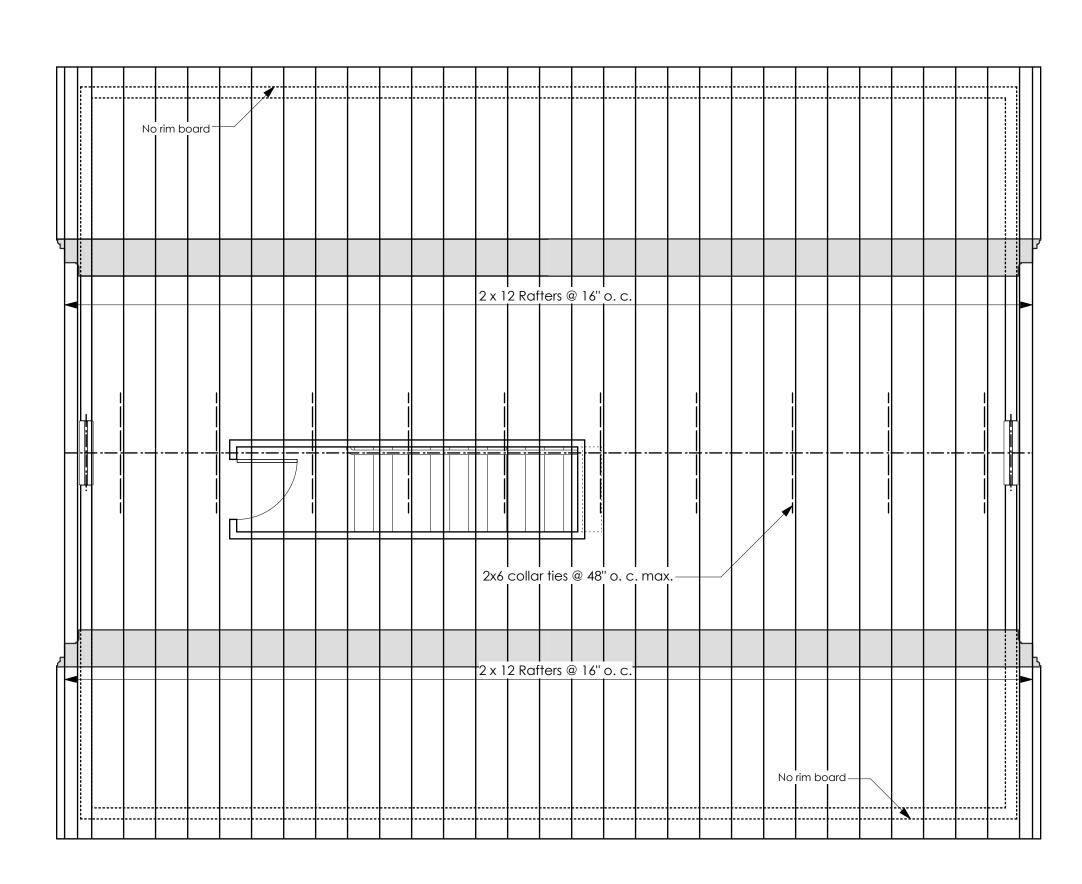

Roof Framing Plan

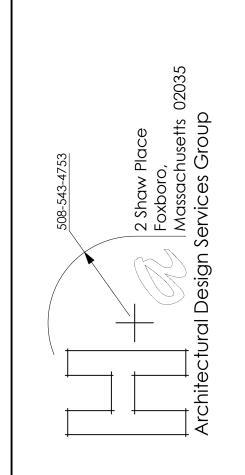

PROJECT:
New Single
Family Home
63 Vallaro Road
Hyde Park, MA

SCALE: 1/4" = 1'-0"

DATE: 17 October 2012

REVISIONS:

SHEET TITLE:

Attic Floor & Roof Framing Plans

SHEET NUMBER:



