

### **GENERAL NOTES**

1. ALL WORK SHALL BE PERFORMED IN CONFORMANCE TO THE LATEST EDITION OF THE MASSACHUSETTS STATE BUILDING CODE AND ALL OTHER APPLICABLE CODES AND LAWS.

2. THE CONTRACTOR IS RESPONSIBLE FOR OBTAINING AND PAYING FOR ALL PERMITS

TECHNIQUES, SEQUENCING, SCHEDULING AND SAFETY FOR THIS PROJECT

5. THE CONTRACTOR SHALL REPORT ANY DISCREPANCIES BETWEEN DRAWINGS

6. THE CONTRACTOR IS RESPONSIBLE FOR REPAIRING ANY WORK DAMAGED BY HIS

FORCES WHILE PERFORMING THIS CONTRACT

7. THE CONTRACTOR SHALL GIVE A WARRANTY FOR HIS WORK FOR A PERIOD OF ONE YEAR FROM THE DATE OF FINAL COMPLETION.

### FOUNDATION NOTES:

- 1. ALL FOUNDATION FOOTINGS SHALL BE CARRIED DOWN TO A MINIMUM OF 4'-0" BELOW FINISH GRADE, OR DEEPER, IF NECESSARY, TO OBTAIN A SAFE SOIL BEARING PRESSURE OF 2 TONS PER SQUARE FOOT, FOUNDATION DESIGN IS BASED ON ASSUMED SOIL BEARING CAPACITY OF 2 TONS PER SQUARE FOOT.
- 2. ALL FOOTINGS SHALL BE PLACED ON UNDISTURBED SOIL; OR, ON ENGINEERED BANK RUN GRAVEL FILL MATERIAL WITH A MINIMUM DRY DENSITY OF 95%.
- 3. ALL FOOTING SHALL BE POURED IN THE DRY ONLY. WATER SHALL NOT BE ALLOWED TO FLOW THROUGH THE DEPOSITED CONCRETE.
- 4. NO FOOTING SHALL BE POURED ON FROZEN GROUND. FOUNDATIONS NEED TO BE PROTECTED FROM FREEZING FOR A MIN OF 5 DAYS AFTER THEY WERE POURED.
- 5. THE MINIMUM REINFORCING FOR ALL FOUNDATION WALLS SHALL BE 2-#6 BARS AT THE TOP AND BOTTOM, CONTINUOUS; OR, AS SHOWN ON DRAWINGS.
- 6. LAP ALL BARS 40 DIAMETERS AND PROVIDE CORNER BARS.
- 7. ALL REINFORCEMENT: ASTM A615-60, WWF A185.

### **CONCRETE NOTES:**

1. ALL CONCRETE SHALL ATTAIN A MINIMUM COMPRESSIVE STRENGTH

**3000 PSI** 

FOR BASEMENT SLABS, FOUNDATION WALL, EXTERIOR WALLS AND OTHER VERTICAL CONCRETE SURFACES EXPOSED TO THE WEATHER FOR DRIVEWAYS, CURBS, WALKS, PATIOS, PORCHES, CARPORT SLAB STEPS AND OTHER FLATWORK EXPOSED TO WEATHER AND GARAGE FLOOR SLABS

2. MAXIMUM SLUMP SHALL NOT EXCEED 3"; AND MAXIMUM; COARSE

AGGREGATE SIZE SHALL NOT EXCEED 3/4" IN DIAMETER. 3. ALL CONCRETE SLABS ON GRADE SHALL BE POURED IN 900 SQUARE FOOT

PANELS, MAXIMUM; OR, PROVIDE CONTROL JOINTS BY SAW CUTTING THE SLAB WHILE THE CONCRETE IS STILL GREEN.

### **REINFORCING NOTES:**

- 1. ALL REINFORCEMENT, EXCEPT FOR TIES AND STIRRUPS, SHALL CONFORM TO ASTM 615-60.
- 2. ALL REINFORCEMENT FOR TIES AND STIRRUPS SHALL CONFORM TO ASTM 615-40.
- 3. ALL WELDED WIRE FABRIC SHALL CONFORM TO ASTM A185-70 SPECIFICATIONS.
- 4. ALL REINFORCEMENT SHALL BE INSPECTED AND APPROVED BY THE ARCHITECT OR HIS ENGINEER PRIOR TO THE PLACEMENT OF ANY CONCRETE.

5. THE CONTRACTOR SHALL SUBMIT FOUR PRINTS OF SHOP DRAWINGS: SHOWING ALL

- REINFORCING DETAILS, CHAIR BARS, HIGH CHAIRS, SLAB BOLSTERS, ETC. TO THE ARCHITECT FOR HIS APPROVAL. THE CONTRACTOR SHALL RECEIVE WRITTEN APPROVED SHOP DRAWINGS FROM THE ARCHITECT OR HIS ENGINEER PRIOR TO THE FABRICATION OF REINFORCEMENT.
- 6. CLEARANCES OF MAIN REINFORCING FROM ADJACENT CONCRETE SURFACES

SHALL BE AS FOLLOWS: A. FOOTINGS

3 INCHES

B. SIDES OF FOUNDATIONS WALLS.

EXPOSED FACES OF FOUNDATIONS. SIDES OF COLUMNS/PIERS, SLABS

2 INCHES ON GRADE FROM TOP SURFACE

C. INTERIOR FACES OF FOUNDATIONS, TOP REINFORCING IN SLABS EXPOSED

TO THE WEATHER 1-1/2 INCHES

D. TOP STEEL OF INTERIOR SLABS 1 INCHES 7. MAXIMUM DEVIATION FROM THESE REQUIREMENTS SHALL BE 1/4" OF SECTIONS 10" OR LESS,

### 1/2" FOR SECTIONS GREATER THAN 10". **EPOXY ANCHORS:**

- EXPANSION BOLTS USED IN CONCRETE SHALL BE SIMPSON STRONG BOLT 2 OR EQUAL. BOLTS NEED TO BE INSTALLED IN ACCORDANCE WITH ICC-REPORT ESR-3037.
- EPOXY ANCHORS AND DOWELS INSTALLED INTO CONCRETE SHALL BE A THREADED ROD OR REINFORCING BAR DOWEL WITH THE HILTI "RE-500SD" ADHESIVE SYSTEM AND BE INSTALLED ACCORDING TO ICC-REPORT ESR-2322.
- CONTRACTOR MAY SUBSTITUTE EXPANSION BOLTS OR EPOXY ADHESIVES OF EQUAL VALUE IN THE SPECIFIED MATERIAL WITH A CURRENT ICC-REPORT FOR REVIEW. EXPANSION BOLTS SHALL NOT BE USED IN MASONRY.

### **WOOD NOTES:**

- 1. ALL LUMBER SHALL HAVE A MOISTURE CONTENT OF NOT MORE THAN 19%.
- 2. ALL FRAMING LUMBER SHALL BE #2 HEM-FIR, OR BETTER, HAVING A MINIMUM
- FB=1,200 PSI, FV=70 PSI, E=1,300,000 PSI.
- 3. ALL L.V.L. LUMBER DENOTED ON PLANS SHALL HAVE A MINIMUM:

- FB=2,650 PSI, FV=285 PSI, E=1,900,000 PSI - FOR STUDS

- FB-3100 PSI, FV=285 PSI, E=2,000,000 PSI - FOR BEAMS 4. ALL JOIST SPANS SHALL HAVE ONE ROW OF 1" X 3: CROSS

BRIDGING AT MID SPAN

- AND NOT MORE THAN 8'-O" O.C. 5. ALL STUD BEARING WALLS SHALL HAVE ONE ROW OF 2X
- HORIZONTAL BLOCKING AT 1/2 STUD HEIGHT, AND NOT MORE THAN 6'-O" O.C. MAXIMUM
- 6. PROVIDE AND INSTALL ALL NECESSARY TIMBER CONNECTORS

- 9. PROVIDE SOLID BRIDGING BETWEEN JOIST FRAMING MEMBERS

up to 8'-0"

up to 10'-0"

- STUD PARTITIONS OR BEAMS. 10. PROVIDE A CONTINUOUS BAND JOIST AT EXTERIOR STUD
- TOP PLATE TO FLOOR PLATE AT A 45 DEGREE ANGLE WITH A SIMPSON TYPE "RCWB" STRAP, OR EQUAL
- 12. ALL BUILT-UP BEAMS SHALL BE BOLTED WITH ½" Ø THRU BOLTS, MEETING A307 STANDARDS, OR, AS NOTED ON DRAWINGS.

### WOOD LINTEL SCHEDULE:

3 - 2x8

3 - 2x10

Lintels over openings in bearing walls shall be as follows; or as noted on drawings. Size: 2x4 studs Size: 2x6 studs 2 - 2x4 3 - 2x4 3 - 2x6 2 - 2x6

2 - 2x8

2 - 2x10

# PROPOSED

# ALD DIVION 57 BLUE HILL AVE ROXBURY,

## MASSACHUSEUS

### MODIFICATION SUMMARY

-No changes (only repairs) have been made to the front of the existing building within the 20' front yard thus the existing front yard encroachment remain as existing non conforming as allowed per code. The walls at the first floor entry have been returned to their original location and the stairs from grade to the second floor porch have been reintroduced.

- -All additions have been made greater than 20' from the front lot line.
- -All trees over 5' have been removed from the front yard area.
- -All changes from the previous set are clouded in this design set.

#### MODIFICATION SUMMARY (6-01-2021)

-It was determined from an updated site plan that there was a non buildable passageway to the left of the building so the addition was adjusted accordingly to maintain as of right setbacks as well as be moved out of the boundary of the passageway.

### ZONING SUMMARY

ARTICLE 50 MFR/ SUBDISTRICT PROPOSED 10 FAMILY

ANY OTHER DWELLING		MIN. LOT AREA PER ADD. UNIT	TOTAL LOT SIZE	LOT WIDTH/ FRONTAGE FA	BLDG. AR HEIGHT	USABLE OPEN SPACE	SETBACK FRONT	SETBACK SIDE	SETBACK REAR	MAX USE REAR YARD
REQUIRED BY ZONING	4000 S.F. FOR 3 UNITS	1000 S.F.	11000 S.F.	40	.0 4 STORIES 45)	200/UNIT (	1'±/MODA	L 10'	20'	25%
EXISTING	NA EX'G	NA EX'G	11216 S.F.	106.7'  ightharpoonup 5205, 46	/11216 4 STORIES 43.00'	469/UNIT	1' BLUEHILL AVE	8'-0"	65'-0"	0 %
PROPOSED PROJECT	4000 S.F. FOR 3 UNITS	1031 S.F.	11216 S.F.	$ \begin{array}{c} 106.7' + 0.8414 \\ 0.844 \end{array} $	/11216 4 STORIES 4 43.00' NO CHANGE	458/UNIT 4587/10 UNITS	20'-0"	10.5'	48'-8" AT ADDITION	0 %
PARKING REQUIREMENT RESIDENTIAL USE: 1.00 S	PACE PER UI	NIT		KEY						

PARKING REOUIREMENT RESIDENTIAL USE: 1.00 SPACE PER UNIT

**REQUIRED 10 SPACES** 

PROPOSED 10 SPACES 5 Spaces 8.5' x 20' 5 Spaces 8' x 18'

NOTE: THERE HAS BEEN NO SOIL TESTING PROVIDED TO THIS OFFICE FOR THIS

OF THIS FOUNDATION SYSTEM IS DESIGNED BASED ON A 2 TON MINIMUM SOIL

RESPONSIBILITY TO DETERMINE SUITABLE SOIL CONDITIONS AND VERIFY THE

BEARING CAPACITY IS NOT AVAILABLE, THIS OFFICE SHOULD BE CONTACTED BY

BEARING PRESSURE. IF A SUITABLE SOIL THAT CAN WITHSTAND A 2 TON

BEARING CAPACITY. IT SHALL BE THE CONTRACTORS OR OWNERS'

THE CONTRACTOR OR OWNER FOR A FOUNDATION REDESIGN

PROJECT. THE DESIGNING ARCHITECT OR STRUCTURAL ENGINEER ACCEPTS NO

RESPONSIBILITY FOR EXISTING SOIL CONDITIONS. ANY SOIL BEARING CAPACITY

SMOKE DETECTOR HEAT DETECTOR **(** CARBON MONOXIDE DETECTOR **EMERGENCY LIGHT** P HORN/ STROBE/ PULL STATION HORN/STROBE  $\langle - \rangle$ 1 HOUR WALL(SEE W.T.1/A-3.1) 2 HOUR WALL(SEE W.T.2/A-3.1) \(\sigma\_1\) 45 MIN. DOOR 1-1/2 HOUR DOOR  $^{\odot}$ FIRE ALARM CONTROL PANEL ? WINDOW TYPE 1 HOUR CLG. ABOVE (SEE C.T.1/A-3.1) 2 2 HOUR CLG. WALL(SEE C.T.2/A-3.1) FE FIRE EXTINGUISHER **NEW WALL** 

EX'G WALL TO REMAIN

WALL TO BE REMOVED

CODE SUMMARY EX'G TYPE 5 CONSTRUCTION

4 STORIES R-2 / A MIXED USE PROP R-2

EX'G NON SPRINKLED PROP. FULLY SPRINKLED

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Revision Date 11-15-2021

2020113 Project No: AS NOTED


10-15-2020 ST/GA/SL


Drawing Name

**COVER** SHEET

heet No.



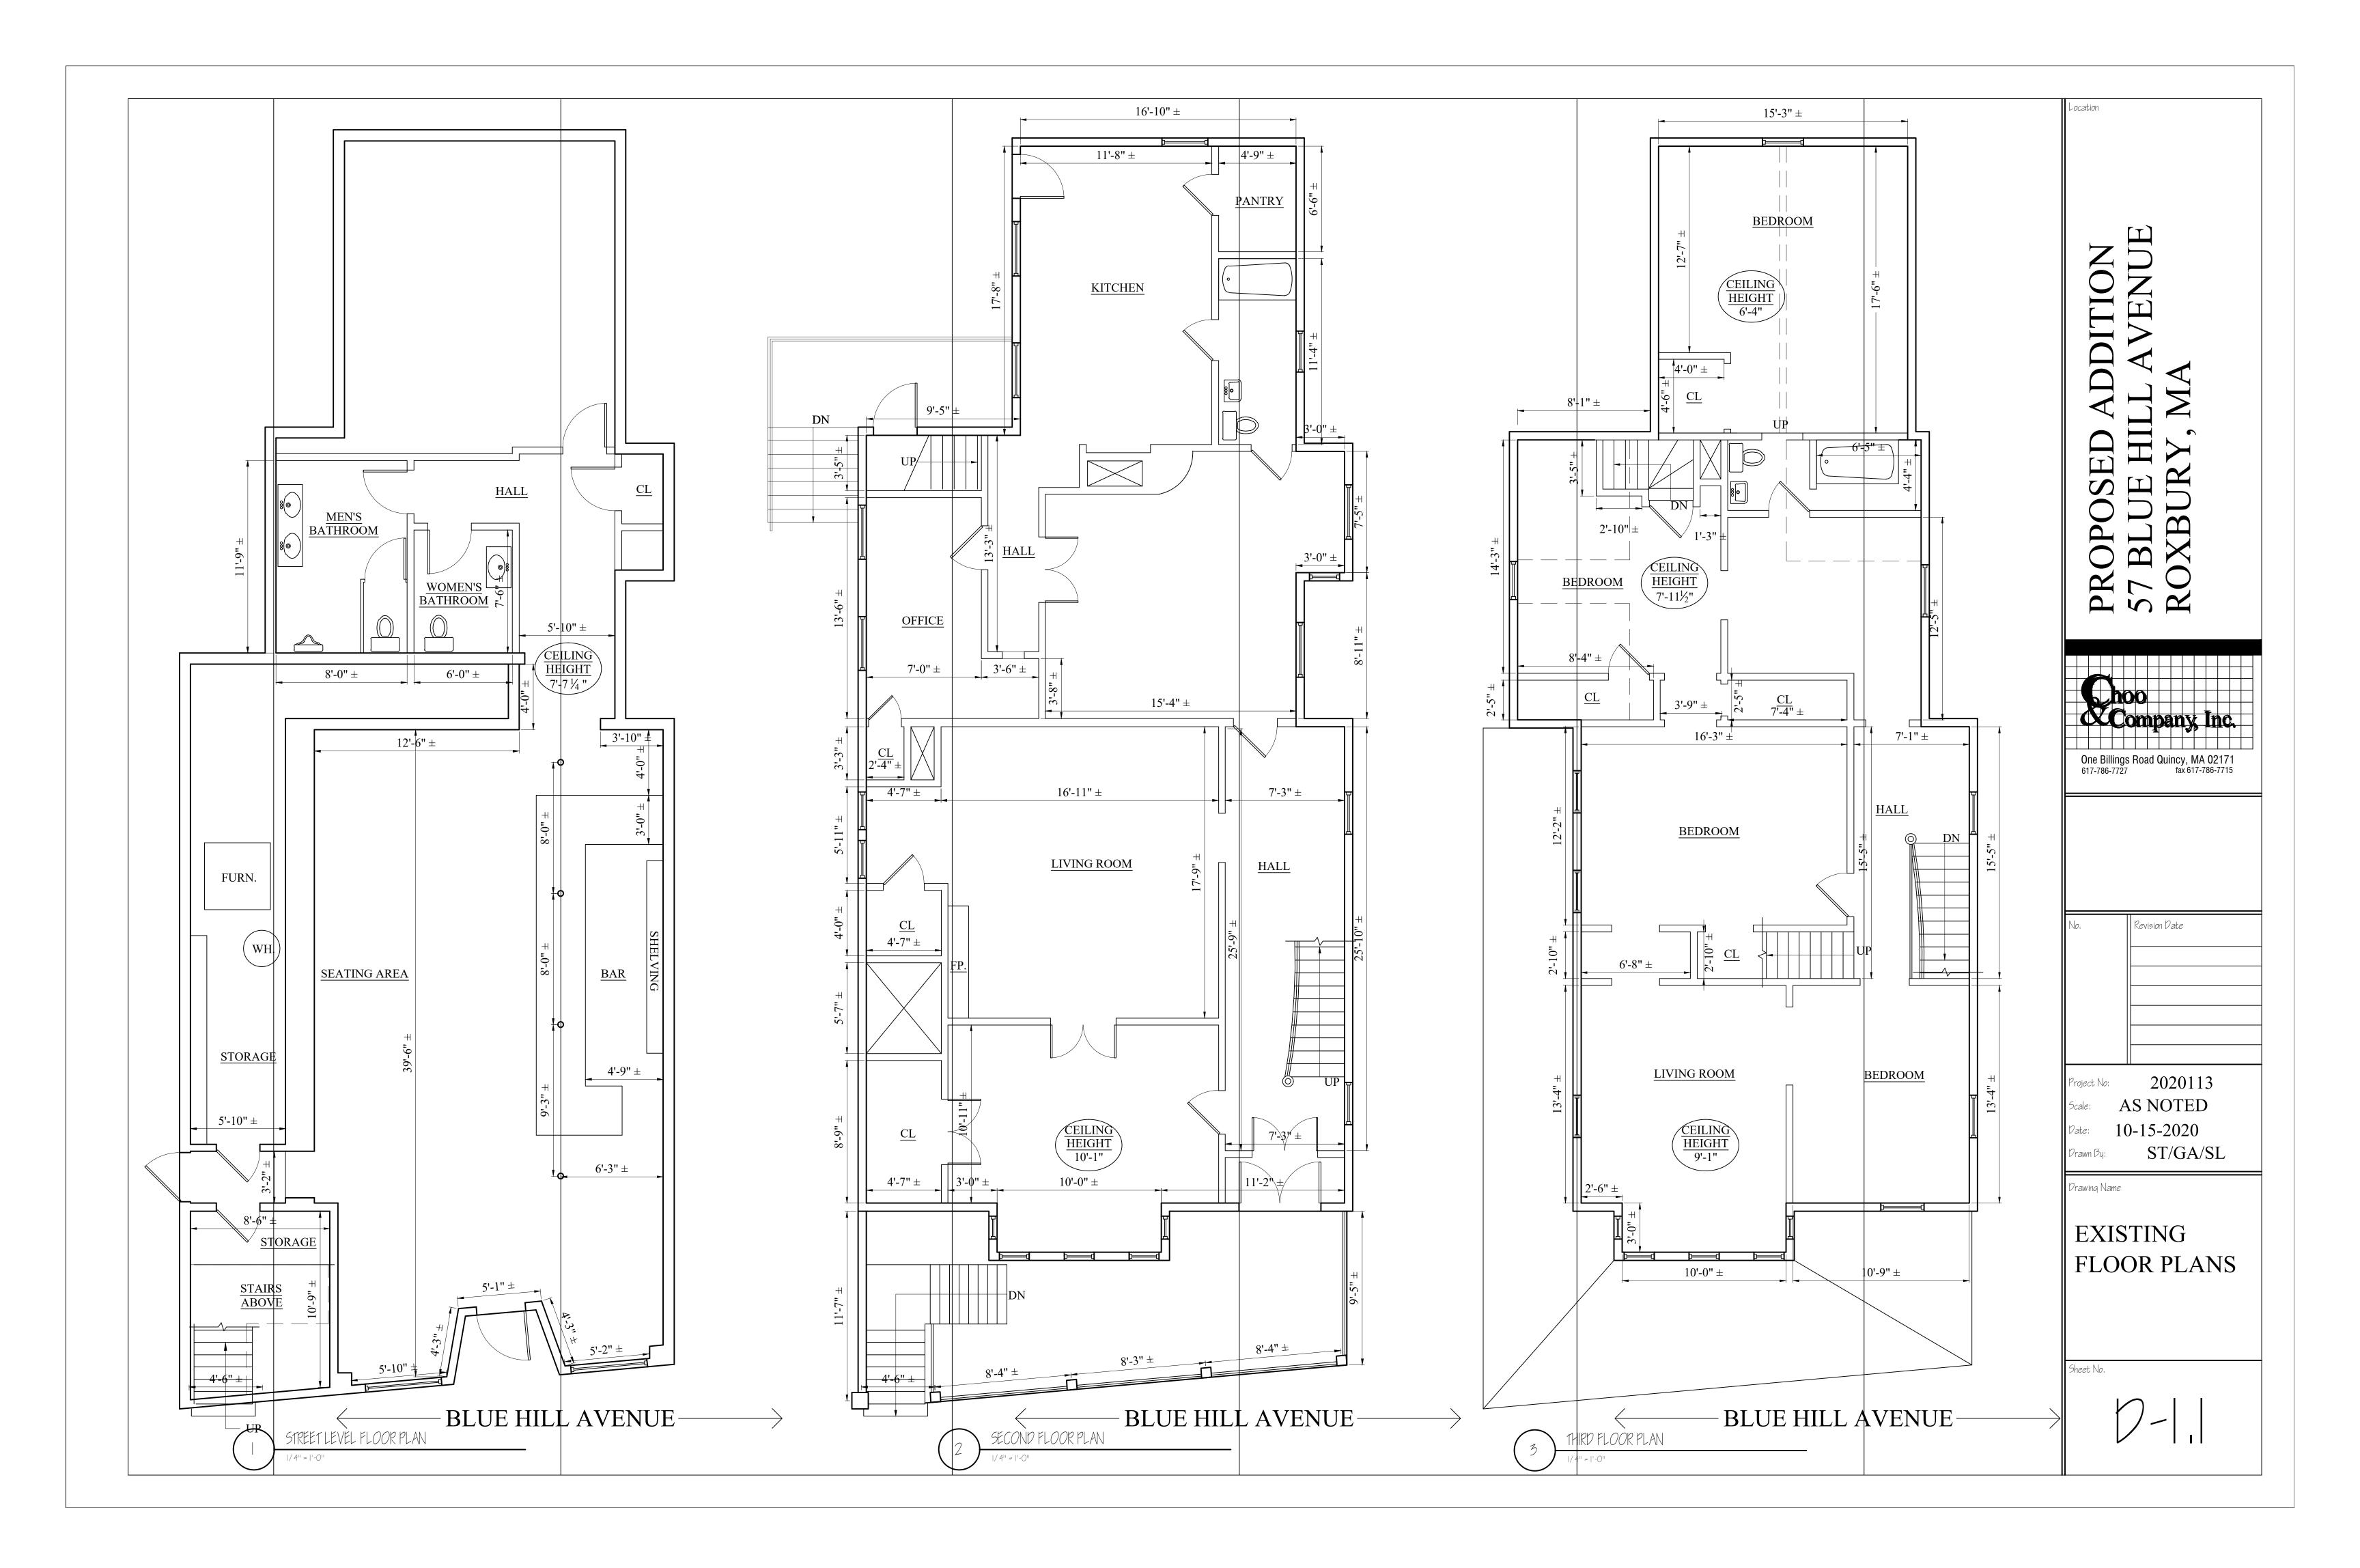

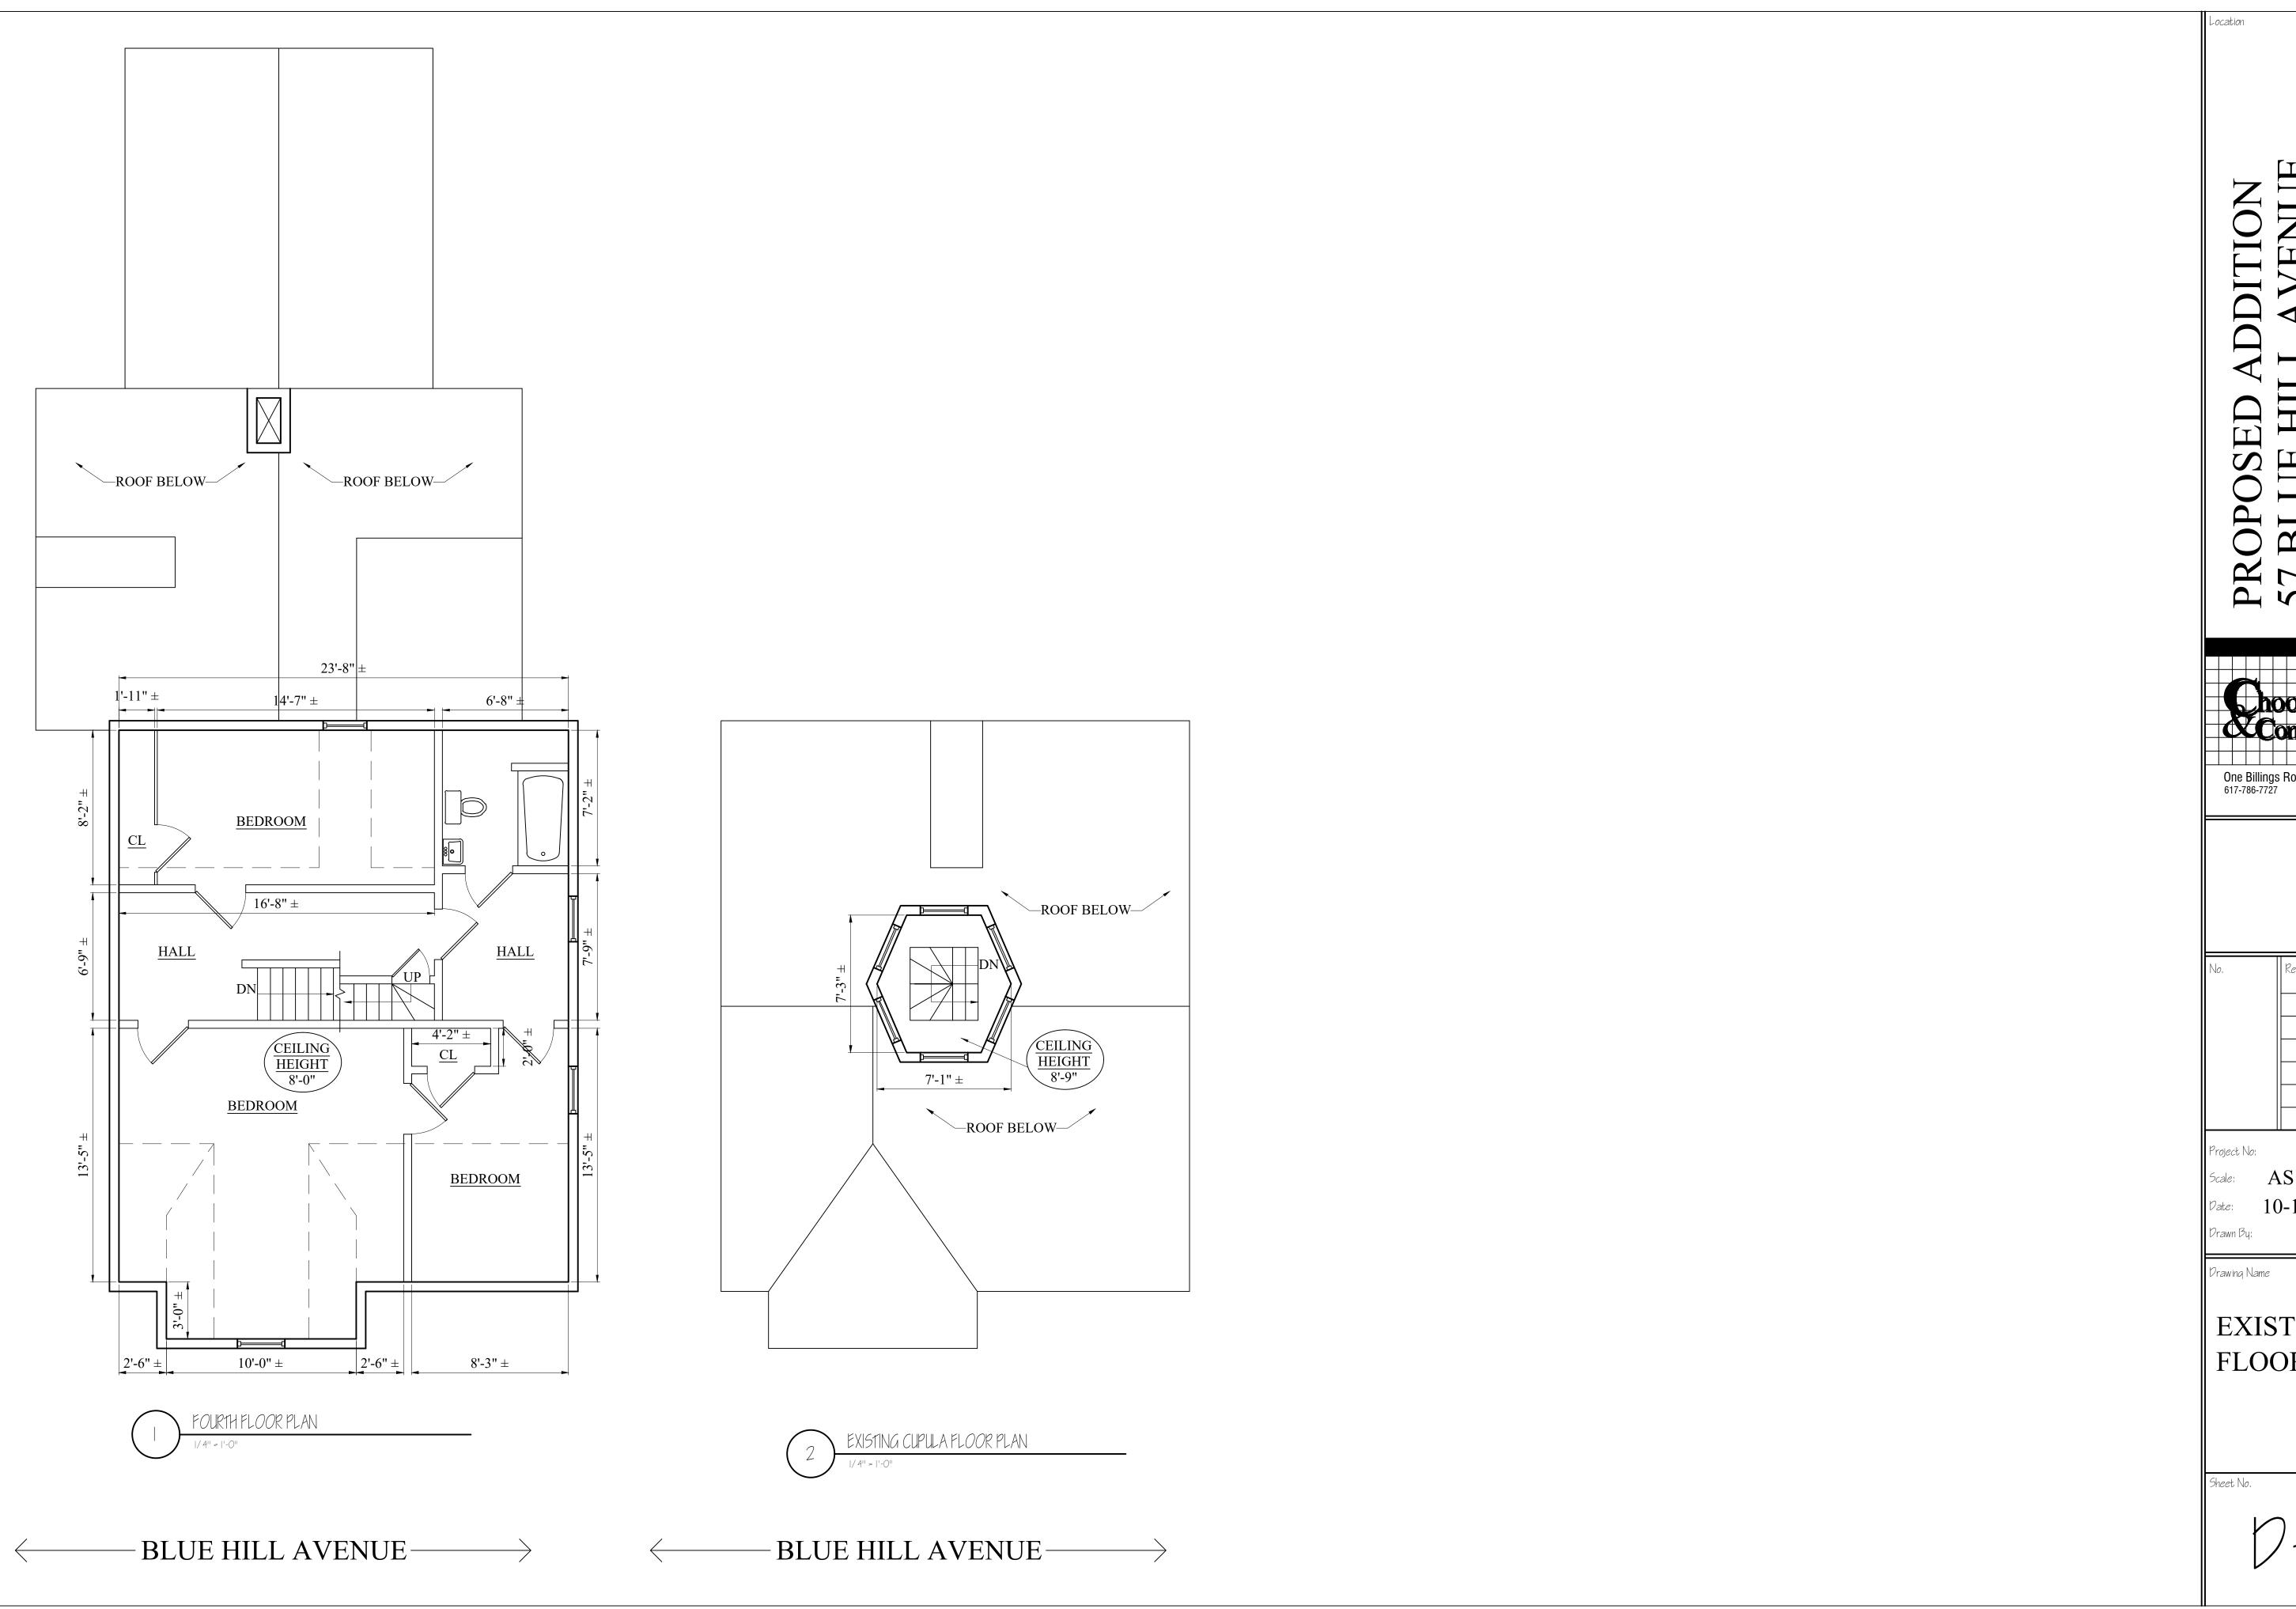



One Billings Road Quincy, MA 02171 617-786-7727 fax 617-786-7715


Revision Date

2020113 Scale: AS NOTED Pate: 10-15-2020 Drawn By: ST/GA/SL

EXISTING FLOOR PLANS

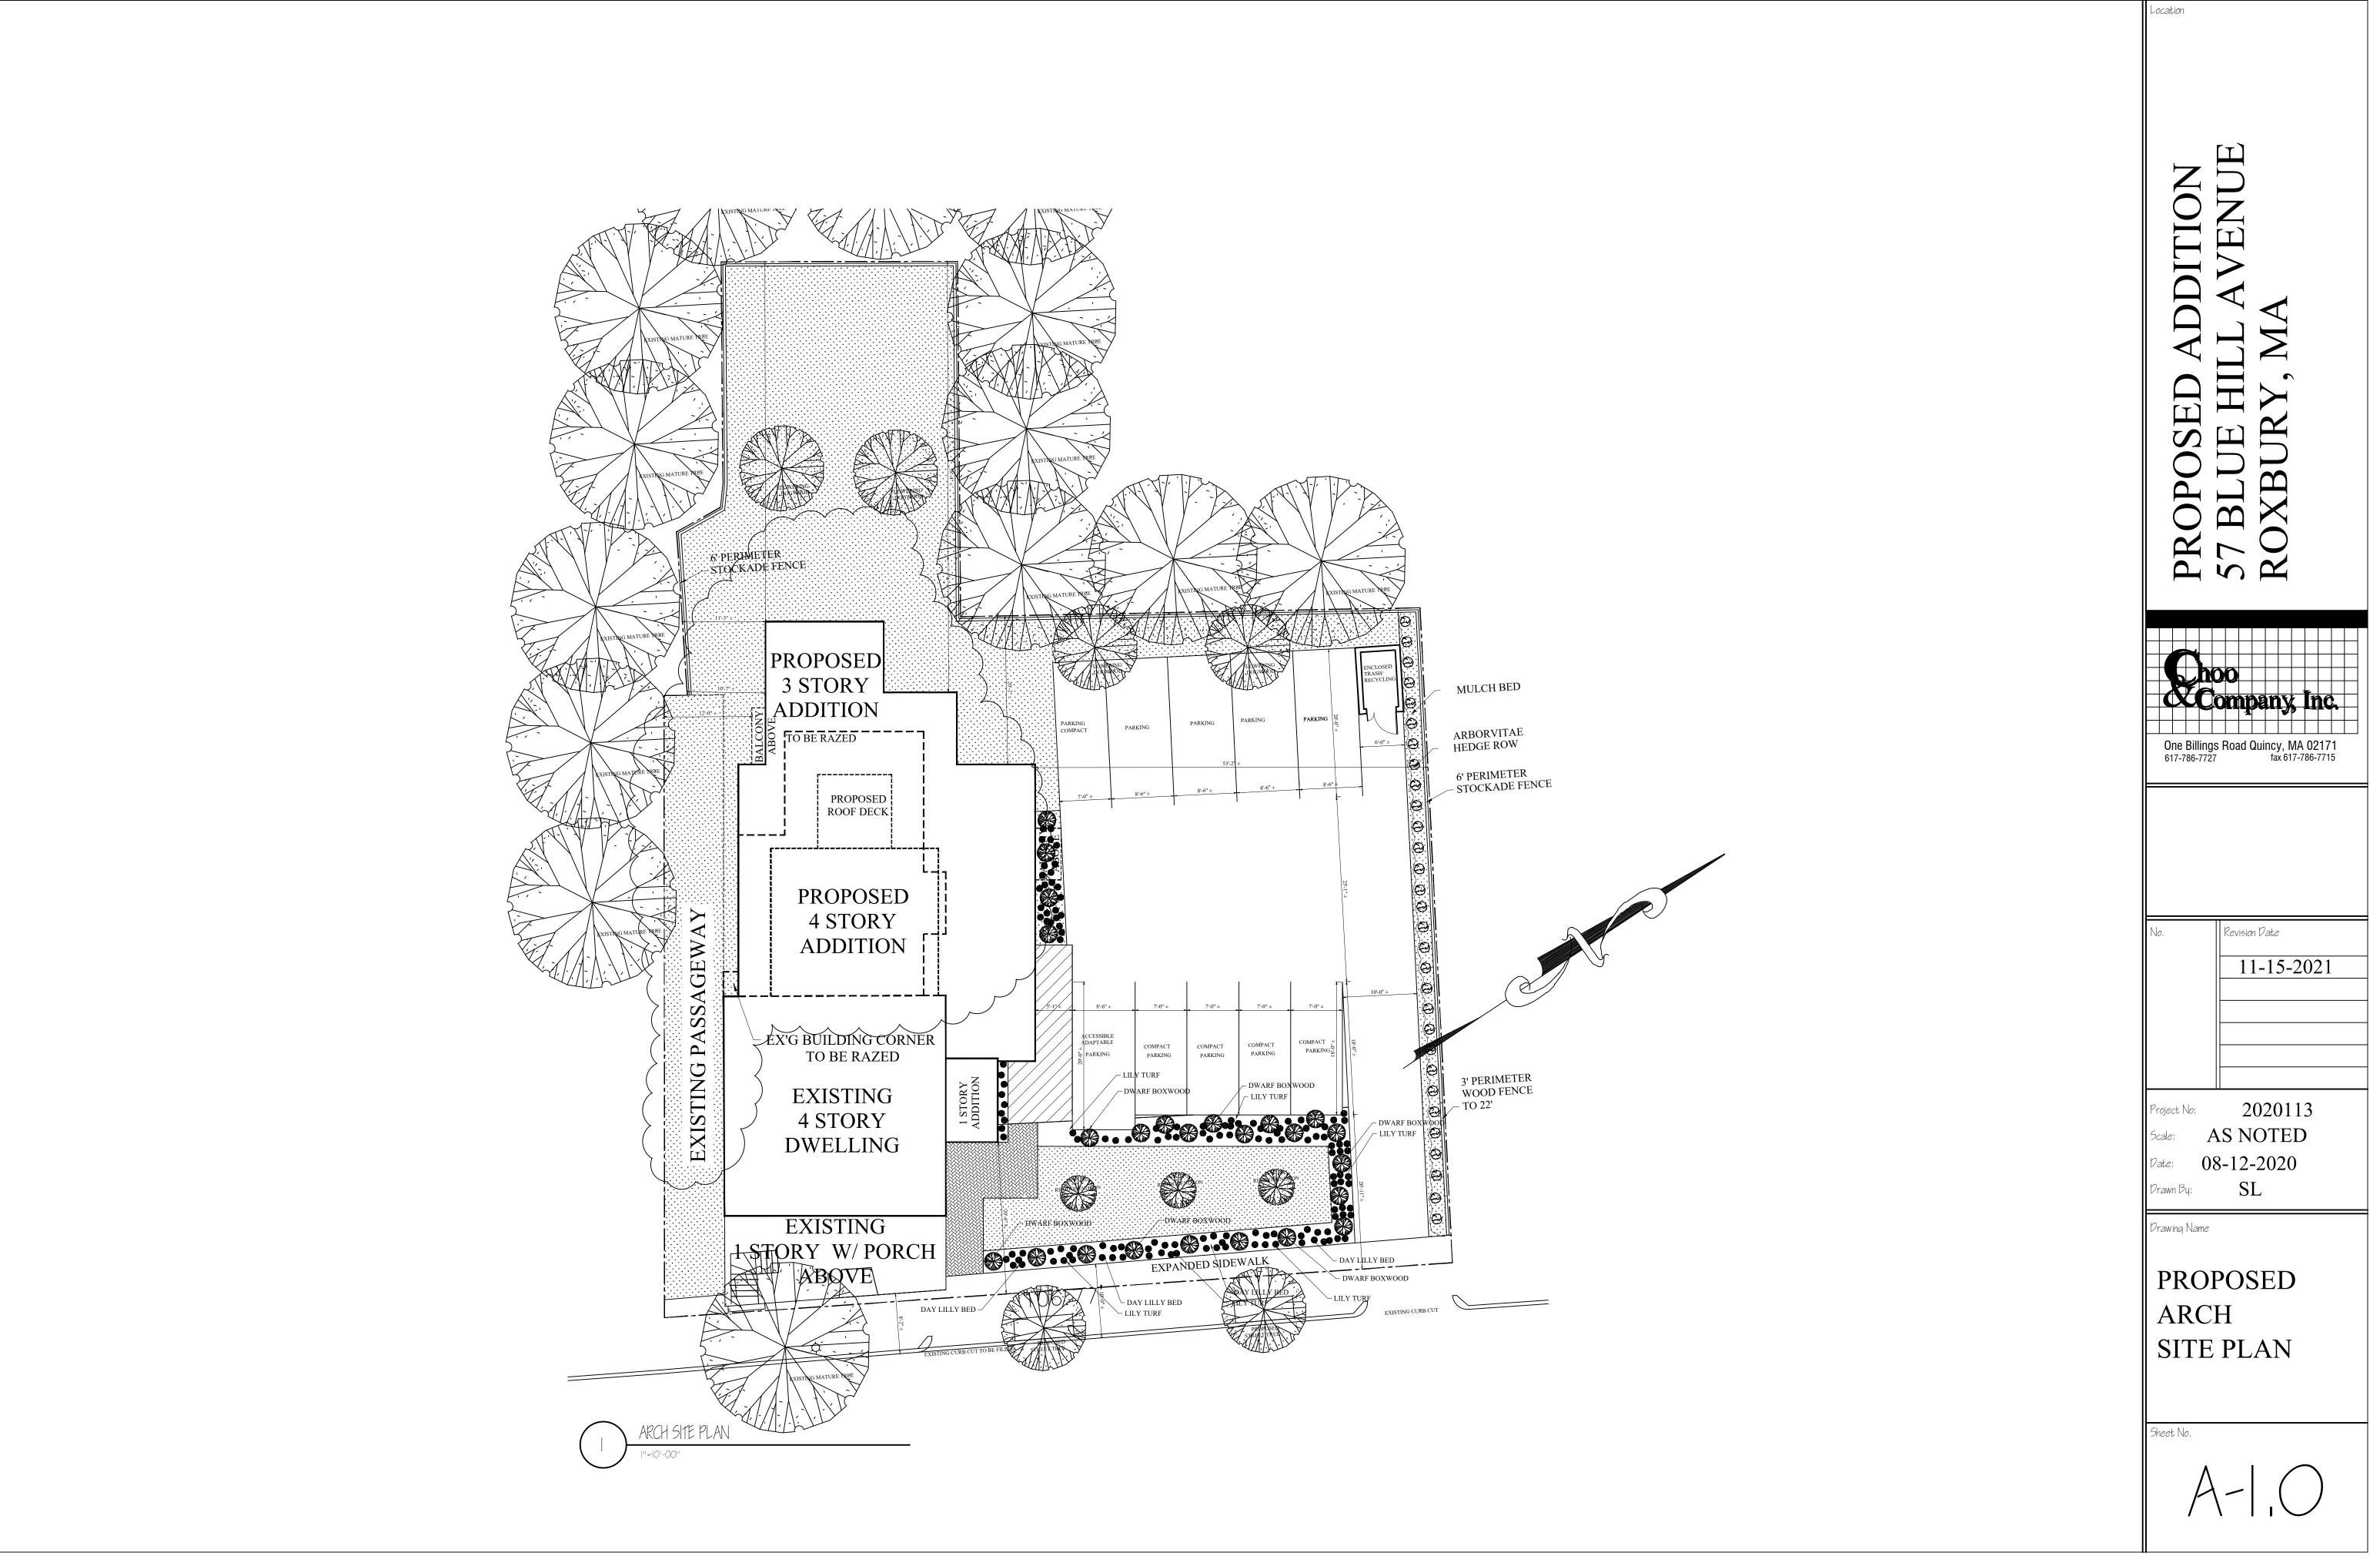

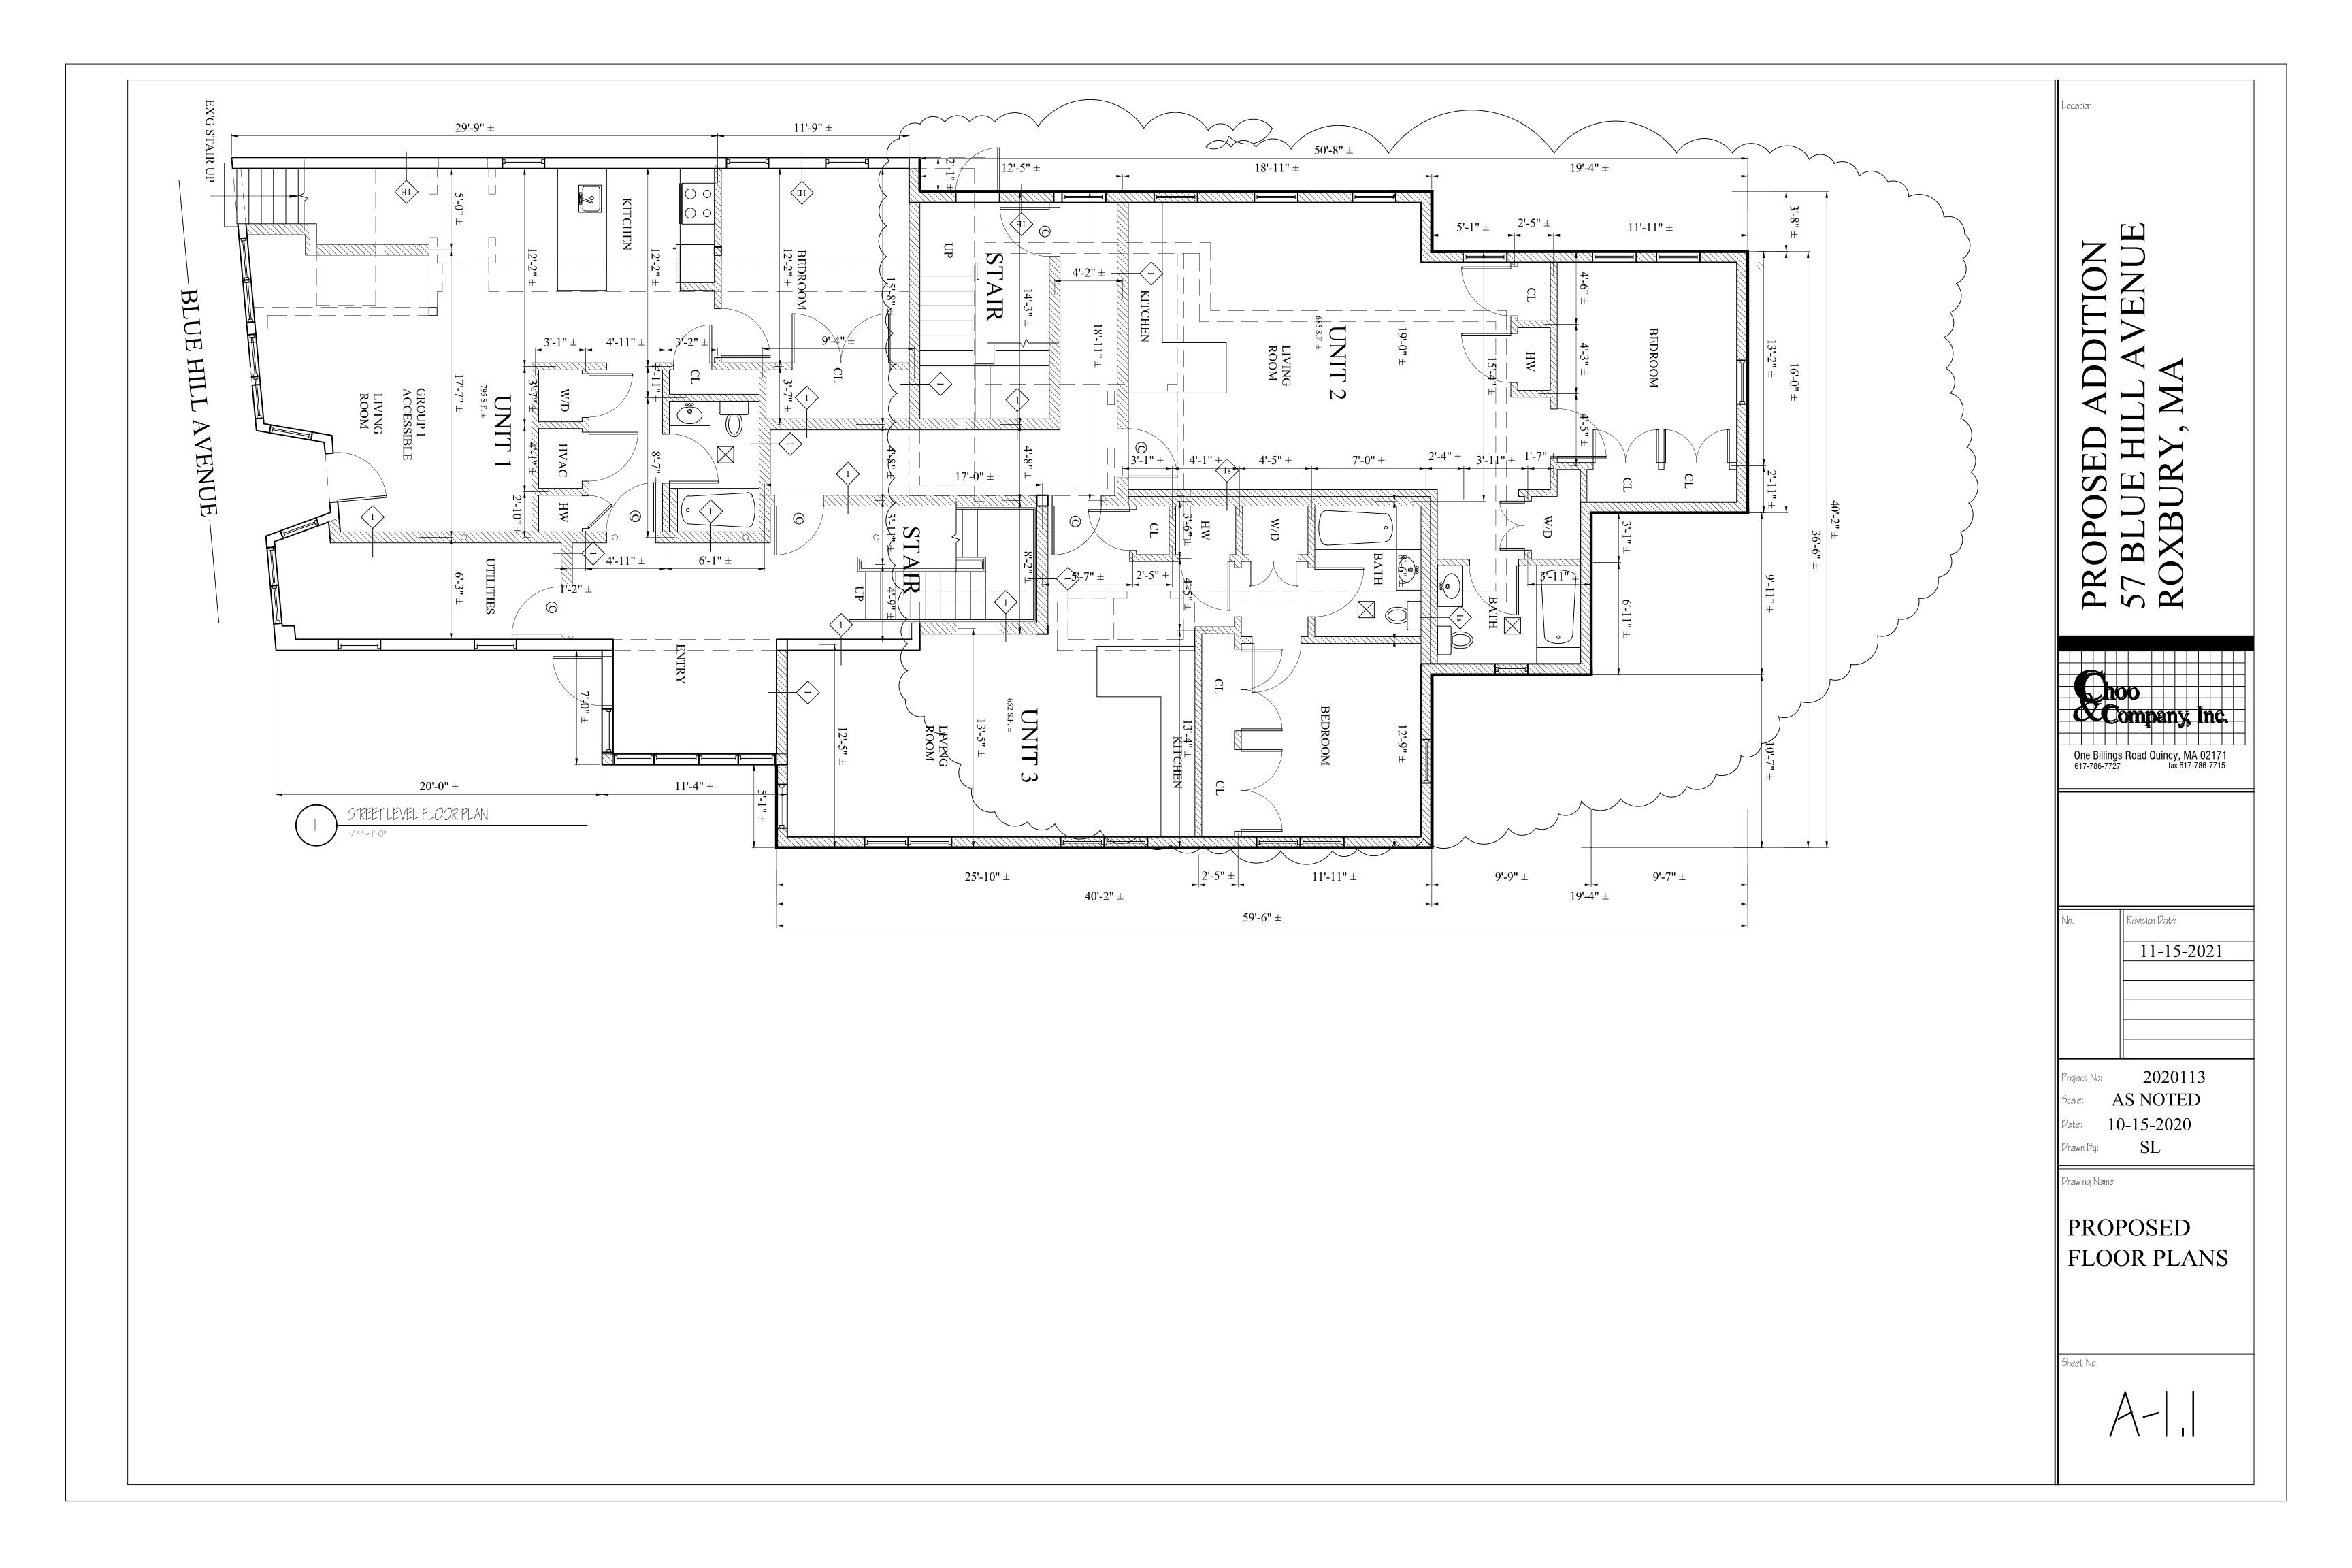

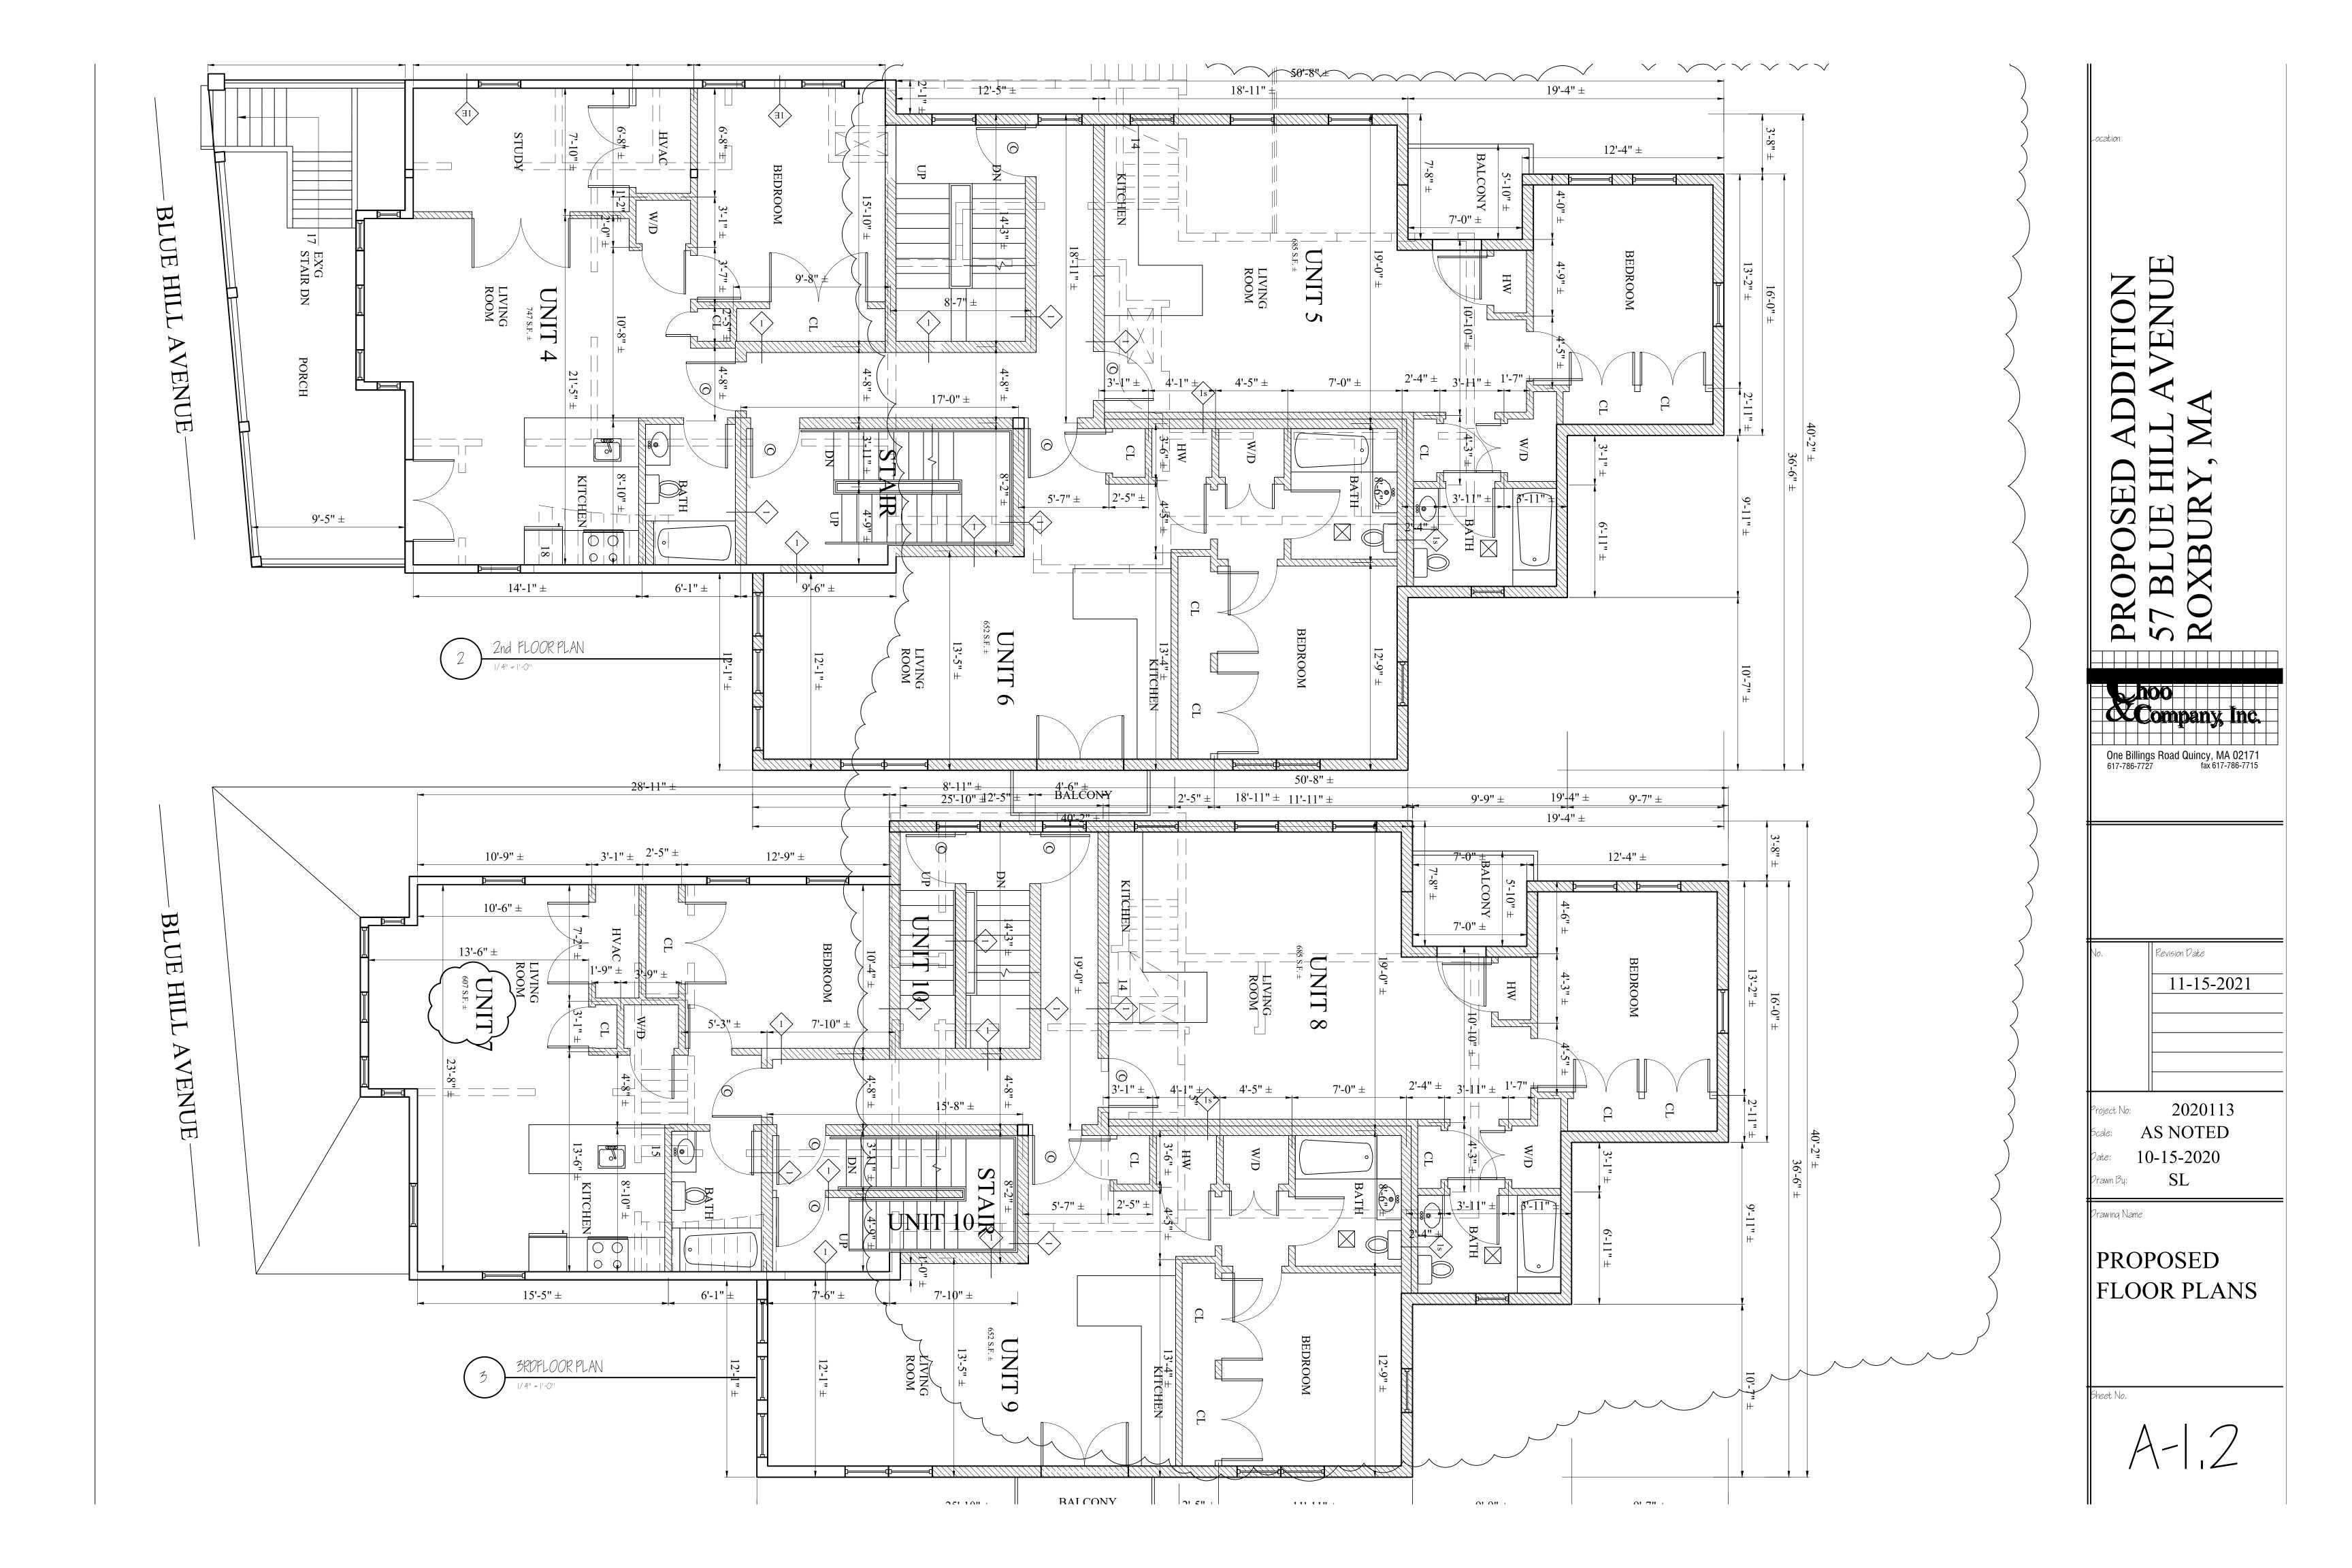

11'-11" ± 17'-4"  $\pm$ **√**10'-0" ± 5'-7" ± 9'-9" ± 13'-4" ± 2'-5" ± 6'-0"  $\pm$ One Billings Road Quincy, MA 02171 617-786-7727 fax 617-786-7715 20'-0" ± Revision Date 2020113 Scale: AS NOTED Date: 10-15-2020 Drawing Name PROPOSED FLOOR PLANS

11-15-2021





PROPOSED ADDITION 57 BLUE HILL AVENUE ROXBURY, MA

One Billings Road Quincy, MA 02171
617-786-7727 fax 617-786-7715

No. Revision Date

Project No: 2020113

Scale: AS NOTED


Date: 10-15-2020

Drawing Name

PROPOSED ELEVATIONS

neet No.

A-2.2

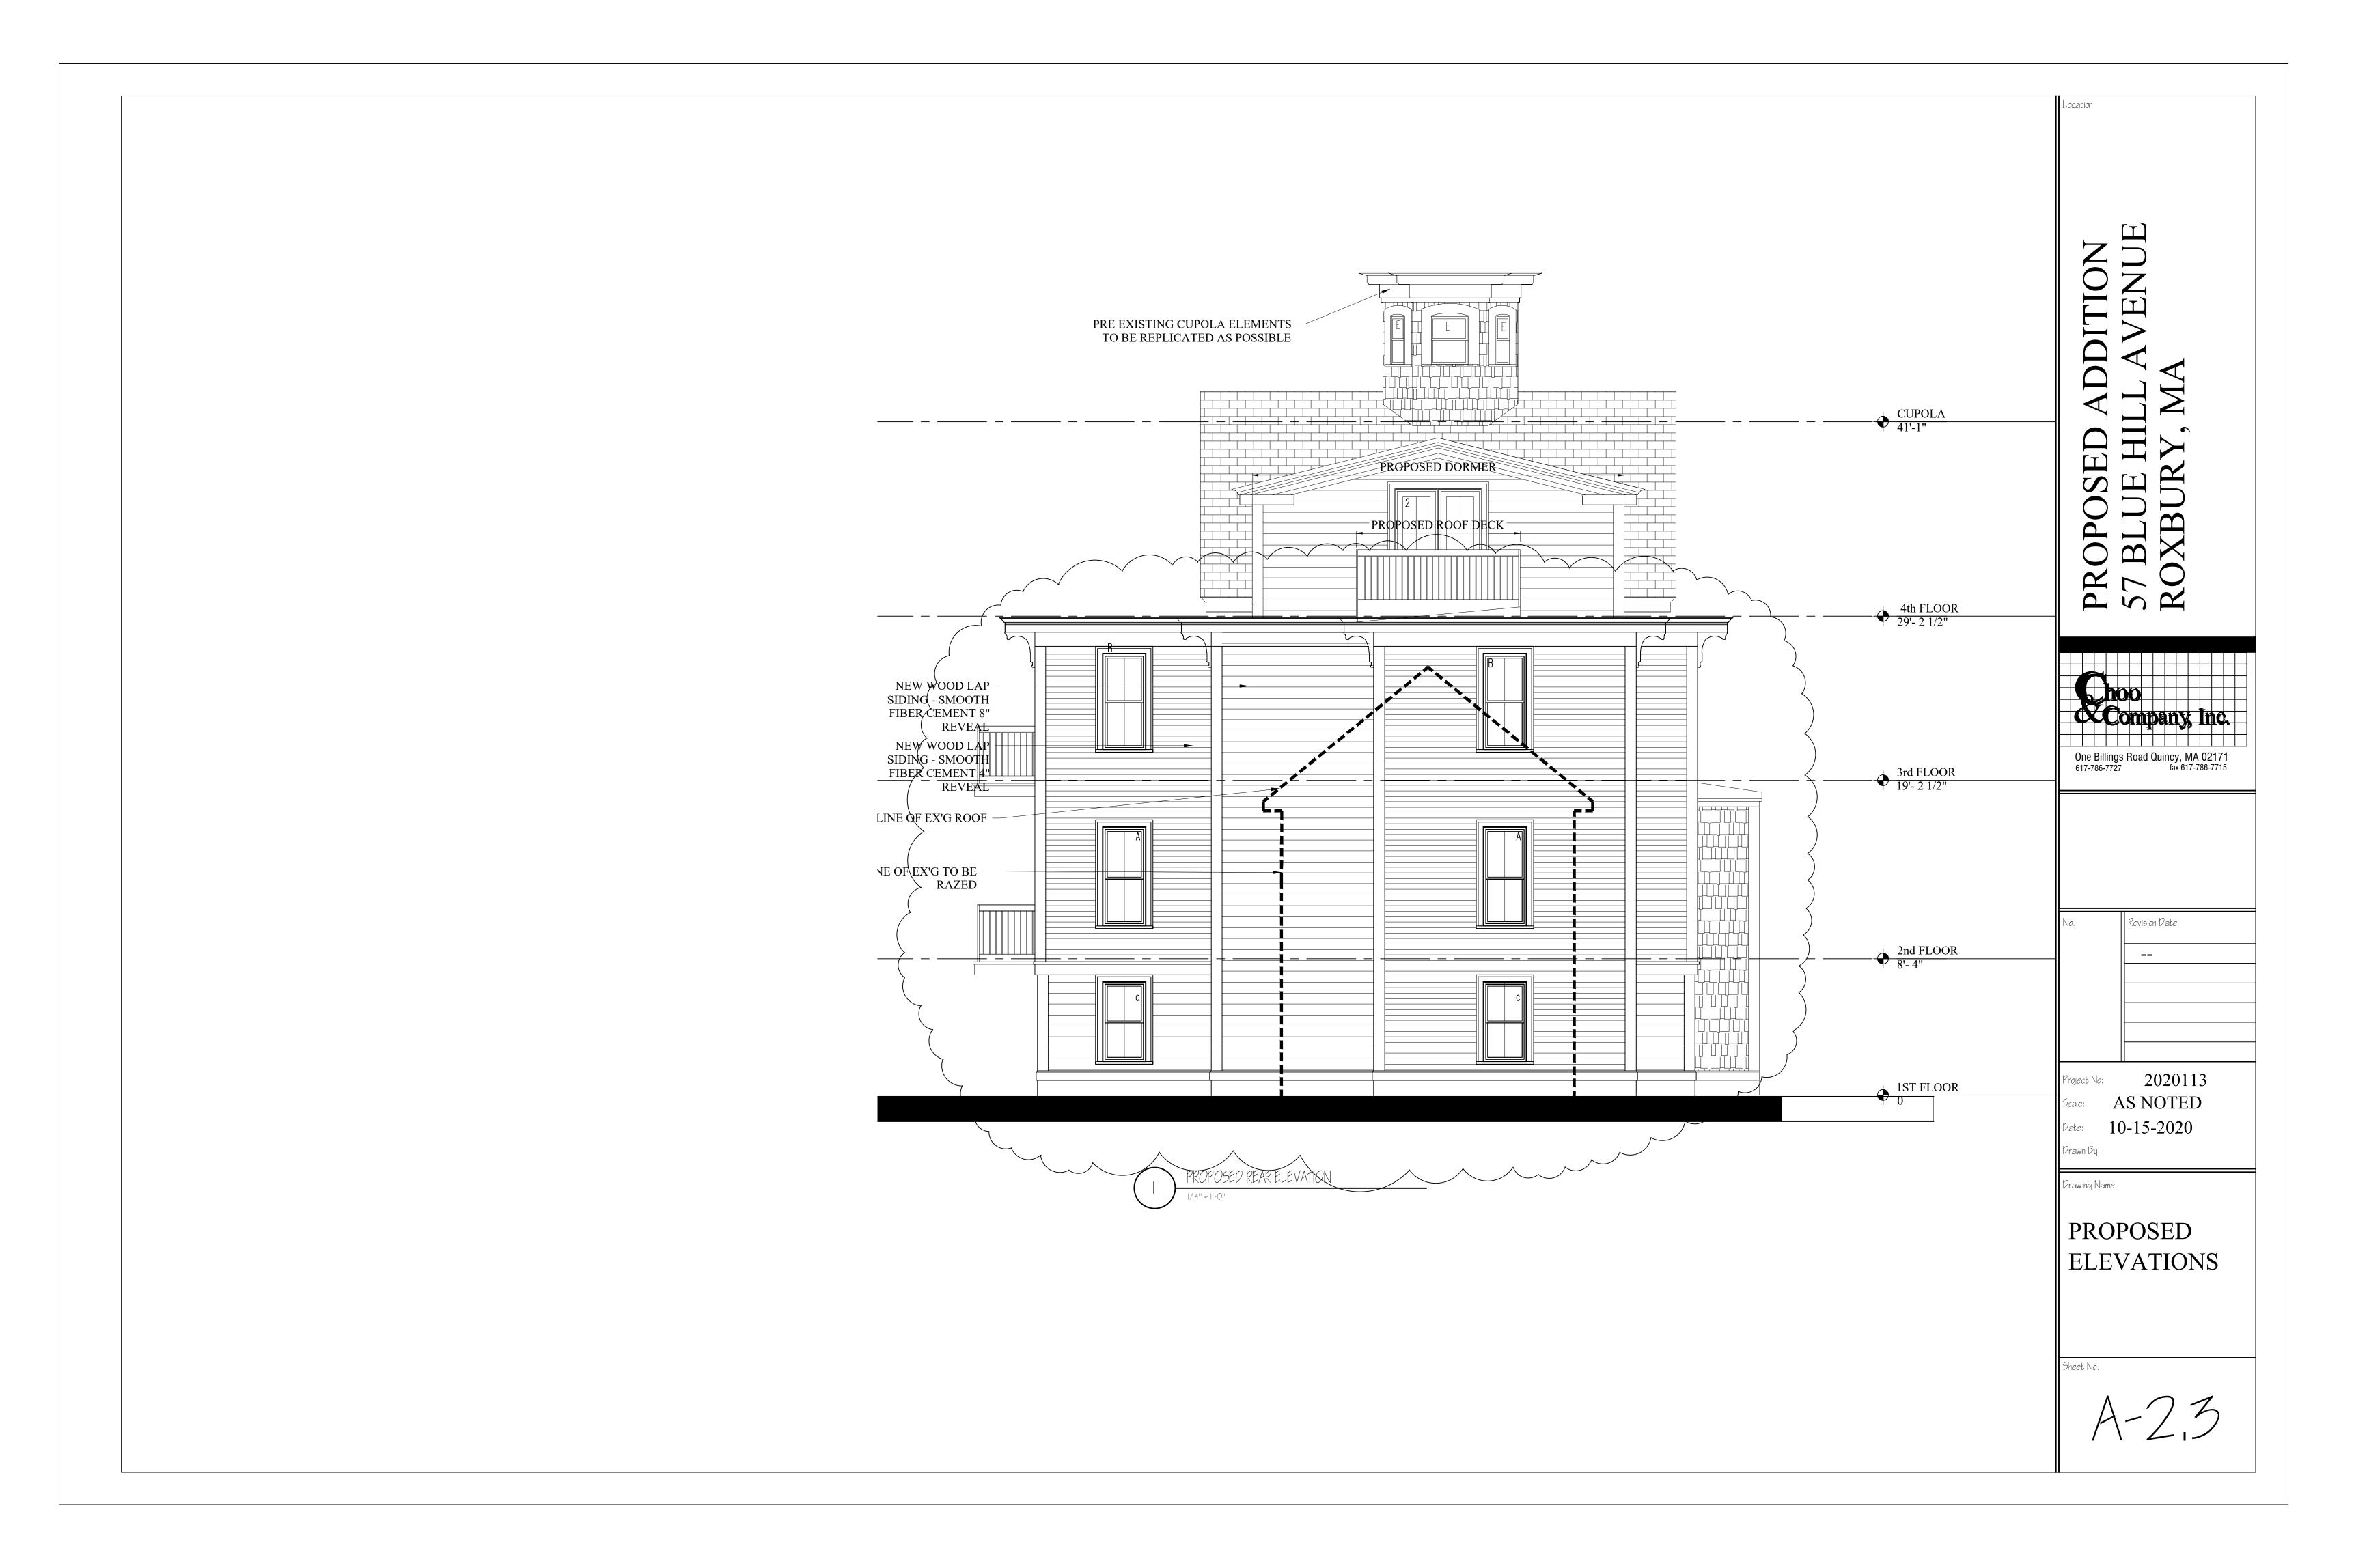



PROPOSED RIGHT SIDE ELEVATION

3/16" = 1'-0"

ZH

PROPOSED ADDITION 57 BLUE HILL AVENU POYBURY MA

One Billings Road Quincy, MA 02171 fax 617-786-7715

11-15-2021

 Project No:
 2020113

 Scale:
 AS NOTED

 Date:
 10-15-2020

 Drawn Bu;
 10-15-2020

Drawing Name

PROPOSED ELEVATIONS

Sheet No

A-2,4