DRAWING LIST


Sheet List					
NO.	SHEET NAME	SHEET DATE			
A000	TITLE SHEET	08/21/20			
C100	SITE PLAN	08/21/20			
A103	PLANS	08/21/20			
A201	ELEVATIONS	08/21/20			
S103	FRAMING PLAN AND SECTION	08/21/20			

BOSTON ZONIN	BOSTON ZONING REVIEW						
8 May Street	8 May Street						
DATE ADDRESS	8/17/2020 8 May Street, Jamai	ca Plain					
Zoning District: Zoning SubDistrict Nighborhood Design Overlay?	Jamica Plain Nieghbo 1F-9000 [1]	rhood - Article 55					
Parks and Rec. Agency? HABITABLE SPACE	EXISTING	CHANGE	PROPOSED				
Basement First Floor Second Floor	0 SF 1,211 SF 1,020 SF	0 SF 0 SF 0 SF	0 SF 1,211 SF 1,020 SF				
Third Floor	149 SF 2,380 SF ACCESSORS REPO	280 SF 0 SF RT SHOWS LIVIN	429 SF 2,660 SF G AREA AS 2586	SF			
OPEN SPACE							
Lot Size Building Footprint Paved Parking Area	9,247 SF 1,211 SF 576 SF	0 SF 0 SF 0 SF	9,247 SF 1,211 SF 576 SF				
Accesory Buidling Footprint	1,274 SF 6,186 SF	0 SF	1,274 SF 6,186 SF				
	REQUIRED	EXISTING	PROPOSED	CONFORMANCE			
LOT AREA, MIN.	9,000 SF	9,247 SF	9,247 SF	CONFORMING			
LOT WIDTH	70 FT	90 FT	90 FT	CONFORMING			
FRONTAGE	70 FT	90 FT	90 FT	CONFORMING			
HABITABLE AREA FAR		2,380 SF 0.26	2,660 SF 0.29	CONFORMING			
BUILDING HEIGHT [2] STORIES		30.5 FT 2.5	30.5 FT 2.5	CONFORMING CONFORMING			
OPEN SPACE [3]		6,186 SF	6,186 SF	CONFORMING			
SETBACK FRONT [4]		28.2 FT	28.2 FT	CONFORMING			
SETBACK SIDE [5]	10 FT 10 FT	8.9 FT 28.8 FT	8.9 FT 28.8 FT	EXISTING NON CONFORMING CONFORMING			
SETBACK REAR		47.6 FT	47.6 FT	CONFORMING			
REAR YARD MAXIMUM OCCUPANCY	25%	0.00%	0.00%	CONFORMING			

ATTIC RENOVATION

ADD NEW 3RD FLOOR MASTER BEDROOM AND BATHROOM

8 MAY STREET, BOSTON MA

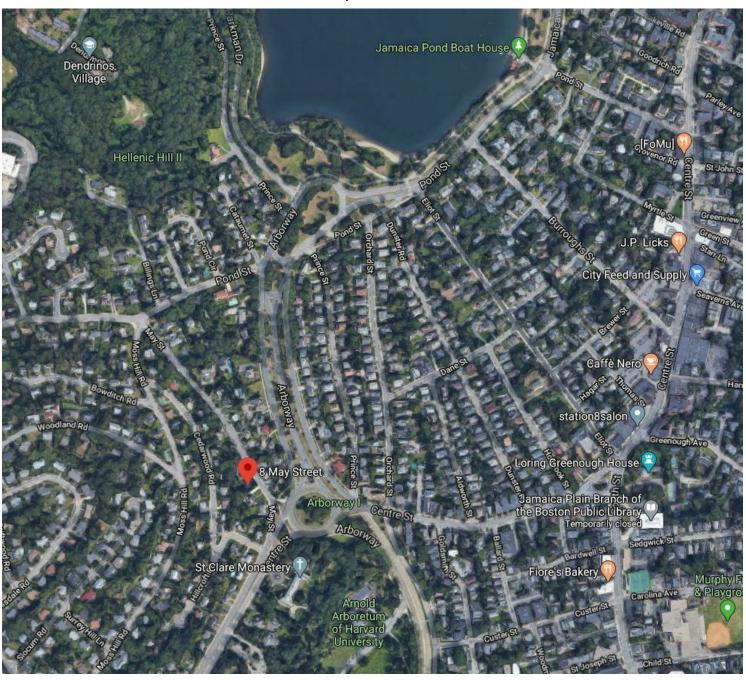

ADD NEW 3RD FLOOR MASTER BEDROOM AND BATHROOM

IECC/MA STRETCH ENERGY CODE COMPLIANCE REPORT

THIS PROJECT MEETS THE REQUIREMENTS OF 780 CMR 51:00 MASSACHUSETTS RESIDENTIAL CODE, 2015 IRC WITH MASS. AMENDMENTS, 2015.

ENERGY REQUIREMENTS:

APPENDIX AA: STRETCH ENERGY CODE

IECC 2015 WITH MASS. AMENDMENTS 780 CMR 115.AA MASS ENERGY STRETCH CODE METHODOLOGY

ADDITION COMPLIES WITH IECC 2015 SECTION R501, AND R502, ADDITIONS

SUBSECTION R402.1

PRESCRIPTIVE OPTION FOR RESIDENTIAL

CLIMATE ZONE 5

PROJECT MEETS THE FOLLOWING REQUIREMENTS FROM TABLE 402.1.2:

WOOD FRAME WALL R-VALUE MINIMUM = R-20

ROOF/CEILING INSULATION MINIMUM = R-49

FLOOR R-VALUE MINIMUM = R-30

FENESTRATION U FACTOR = .32, SKYLIGHT U FACTOR .55



OWNER .

TOM SOWLES

ARCHITECT:

HELIOS DESIGN GROUPINC. 116 ST. BOTOLPH STREET BOSTON, MA


GENERAL CONTRACTOR:


TOM SOWLES

PHASE:


CONSTRUCTION

SET DATE: 12/20/20

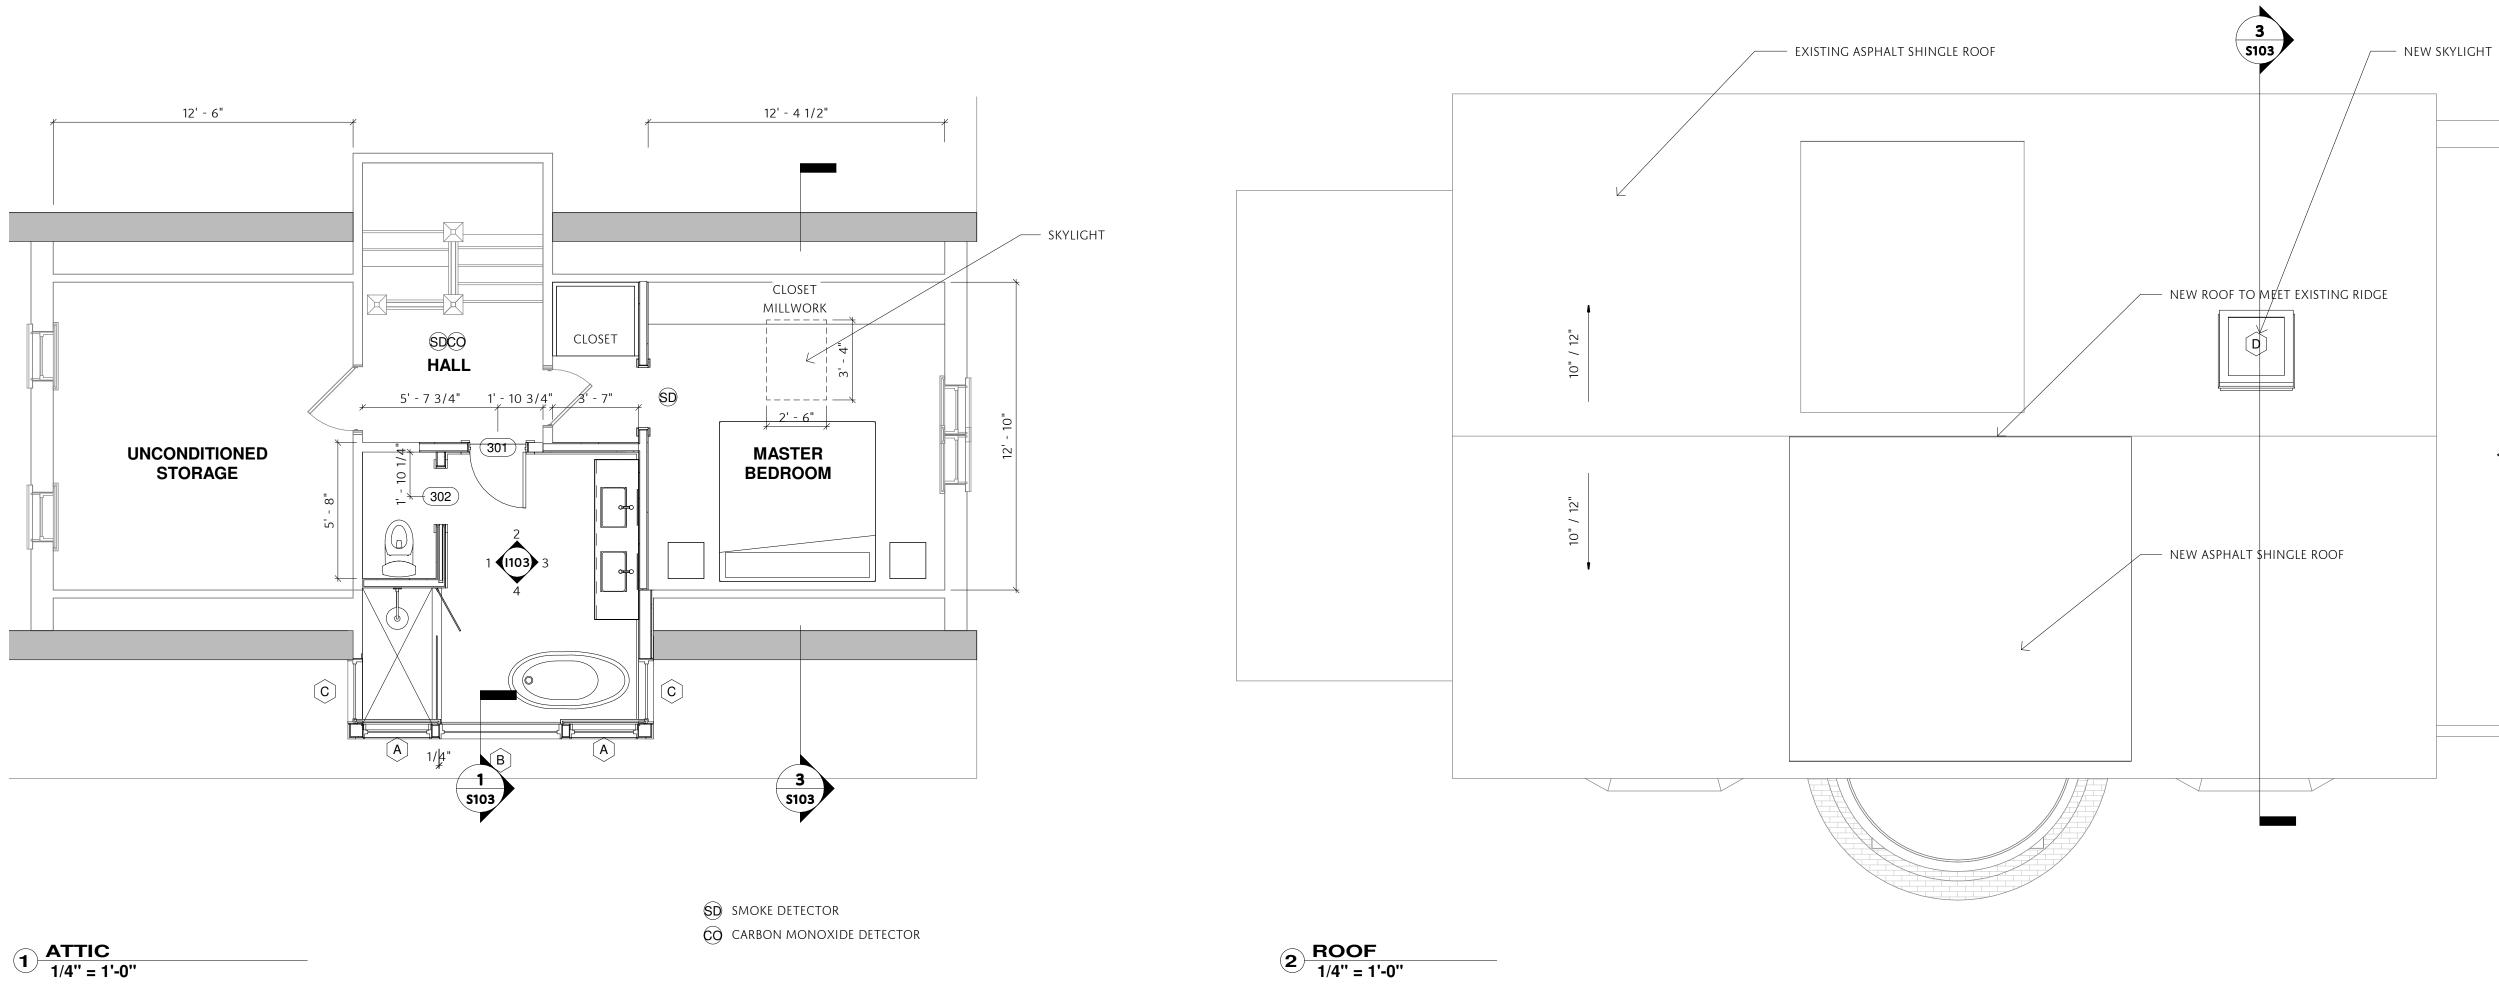

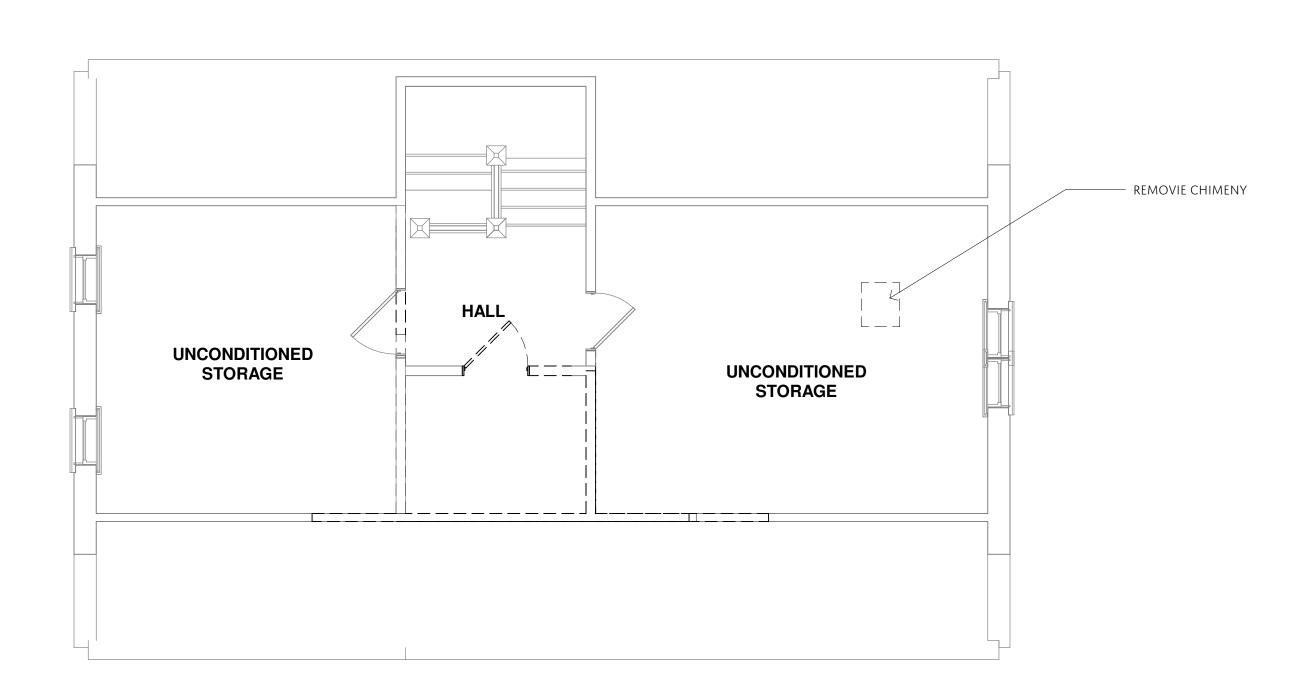

4 ATTIC DEMOLITION
1/4" = 1'-0"

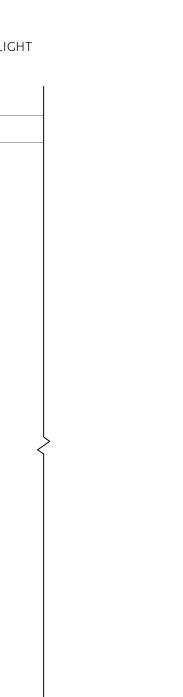

ATTIC RENOVATION

179 BOYLSTON STREET, JAMAICA PLAIN, MA 02130

REVISION DESCRIPTION

REVISIONS:

8 MAY STREET, BOSTON MA

OWNE

TOM SOWLES

PHASE:

CONSTRUCTION

DRAWING TITLE:

PLANS

SCALE: 1/4" = 1'-0"


SHEET DATE: 08/21/20 SET DATE: 12/20/20

SHEET NUMBER:

A103





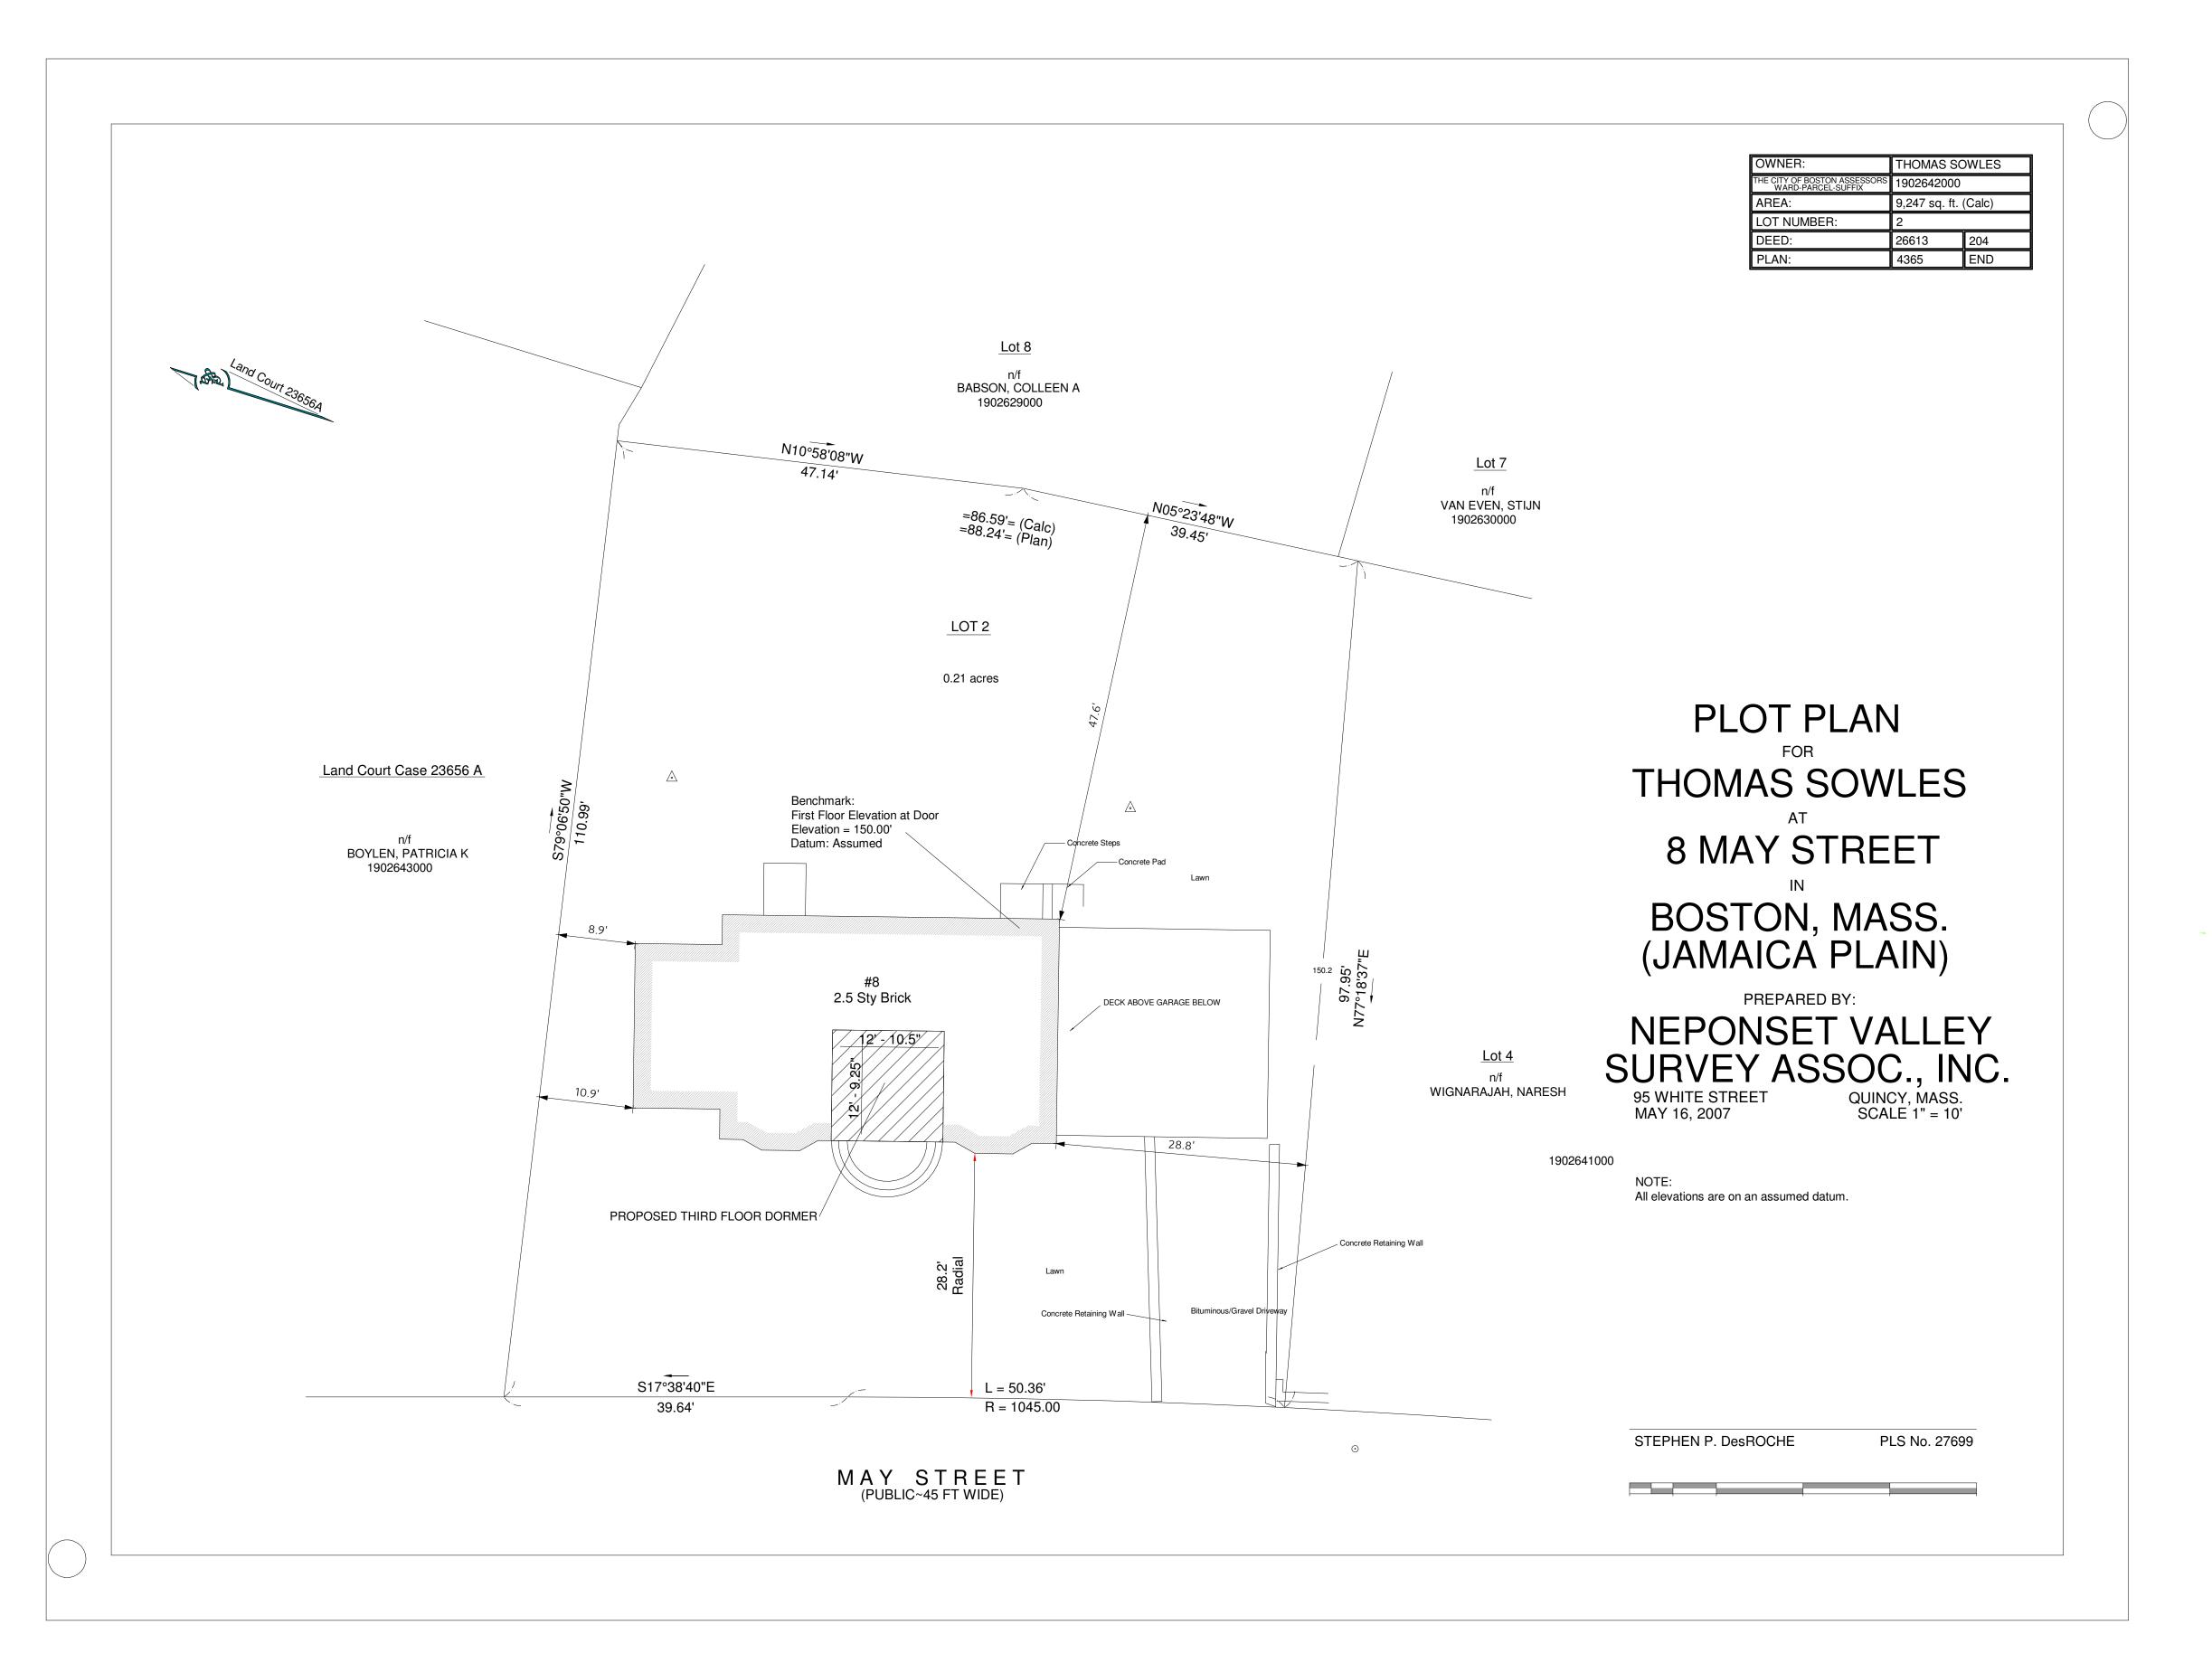



02130

NO. DATE REVISION DESCRIPTION

ATTIC RENOVATION

8 MAY STREET, BOSTON MA

OWNE

TOM SOWLES

PHASE:

CONSTRUCTION

DRAWING TITLE:


SITE PLAN

SCALE: 1" = 10'-0"

SHEET DATE: 08/21/20 | SET DATE: 12/20/2

SHEET NUMB

C100

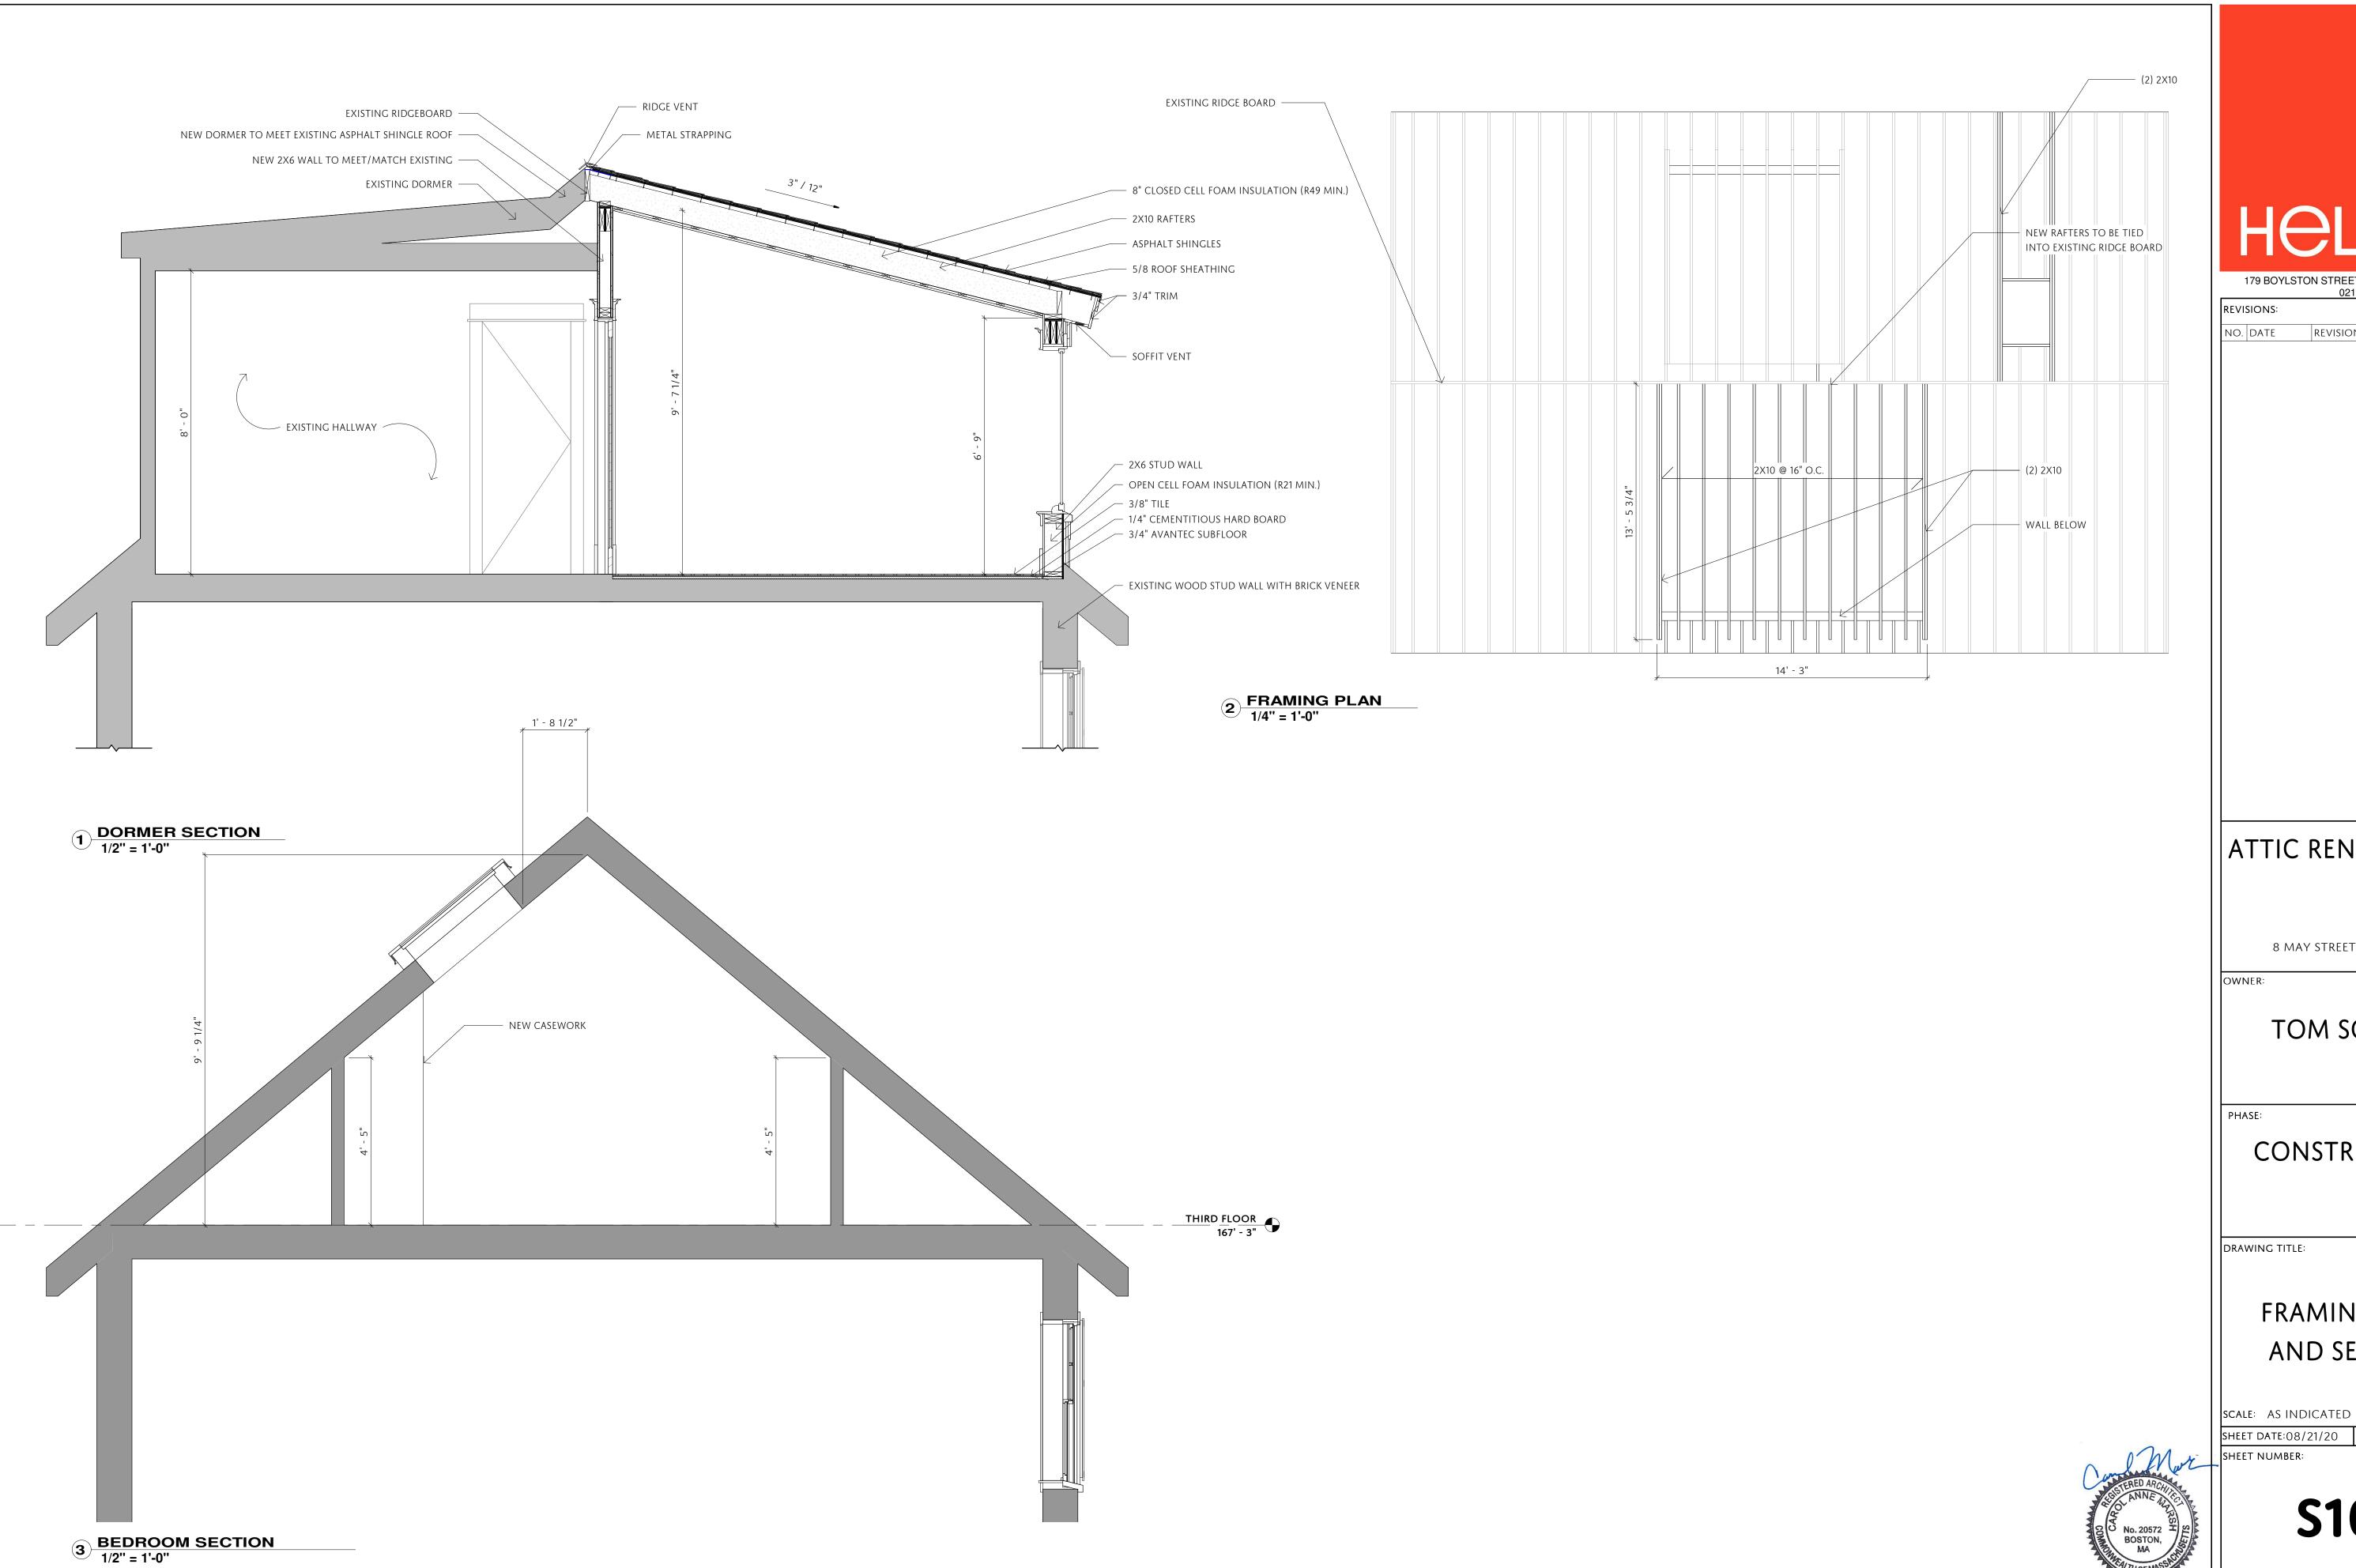

179 BOYLSTON STREET, JAMAICA PLAIN, MA

REVISION DESCRIPTION

ATTIC RENOVATION

8 MAY STREET, BOSTON MA

TOM SOWLES

CONSTRUCTION

FRAMING PLAN AND SECTION

SHEET DATE: 08/21/20 SET DATE: 12/20/20

S103