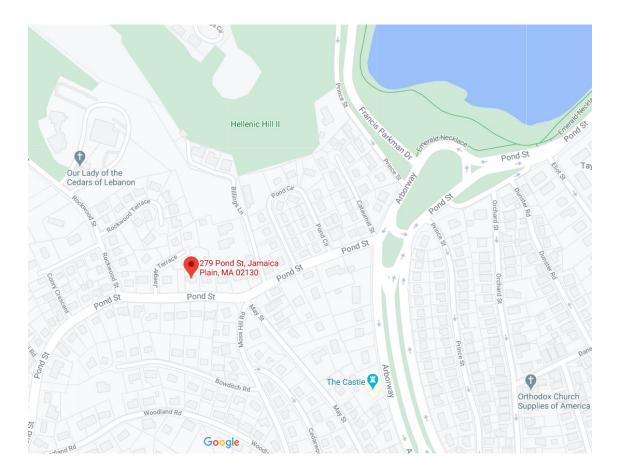


LEWIS RESIDENCE 279 POND STREET JAMAICA PLAIN, MA 02130



VICINITY MAP

CODE AND ZONING SUMMARY

279 Pond Street

Jamaica Plain, MA 02130 Parcel ID: 1902244000 Owner: George Lewis VI

Zoning District: Jamaica Plain Neighborhood (S-.3)

Zoning Subdistrict: 1F-9000

Subdistrict Type: Single-Family Residential

Overlays: Neighborhood Design

Lot Size: 12,810 SF Allowable FAR: 0.30

Existing Total Living Area: 2,773 SF

Existing FAR: 0.22

Proposed Addition: 214 SF New Total Living Area: 2,987 SF

New FAR: 0.23

Setbacks

Front: Required: 25'

Existing: 50.5' Proposed: Unchanged

Side: Required: 12'

E. Existing: 4.5' Proposed: Unchanged W. Existing: 46.0' Proposed: Unchanged

Rear: Required: 40'

Existing: 42.5' Proposed: Unchanged

All setbacks as existing (addition is over existing wing).

Building height is unchanged.

Drawing Index	
Sheet Number	Sheet Name

A0	Project Information	
A1	Notes	
A2	Second Floor Plan	
A3	Roof Plan	
A4	South Elevation	
A5	West Elevation	
A6	North Elevation	
A7	Building Section	
D1	Second Floor Demolition Plan	
E1	Second Floor Electrical Plan	





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No.	Description	Date

Project Information			
Project number	2103		!
Date	05/05/21	A0	!
Drawn by	MCO		
Checked by	LCO	Scale	

GENERAL NOTES

- 1. Obtain necessary permits and complete all work according to the Mass Building Code.
- 2. Provide schedule for owner including start and proposed finish date, and time line for finish and material choice decisions.
- 3. Protect existing house during construction. Contractor to maintain sealed off area during construction and to minimize traffic through main house.
- 4. Contractor to provide temporary toilet facilities.
- 5. Provide temporary bracing as required. Carry out any demolition operations with utmost care to maintain integrity of structure and finishes scheduled to remain.
- 6. Work will require modification to the existing structure. The contractor shall be responsible for providing bearing, supports, and/or bracing in accordance with good engineering practices. Framing lumber to be Hem fir No. 2 or bettr, with Fb=1100 PSI, E=1,400,000 PSI. All beam to post connectors to be of sizes necessary to accommodate connected pieces. Owner is responsible for any outside structural engineering design costs.
- 7. Structural notes and details to be reconfirmed after demolition.
- 8. Provide fireblocking, draftstops and firestops as per code.
- 9. Insulate all exterior walls and roofs with cavity insulation and rigid exterior insulation.
- 10. Patch, touch up, and clean all existing walls, ceilings and floors scheduled to remain, which are damaged by construction or such things as rewiring. Provide neat transition to new materials.
- 11. Unless otherwise noted, construction details shall match existing as much as possible.
- 12. Confirm all measurements in the field; do not scale drawings.
- 13. Provide owner or architect with samples of finish materials.
- 14. All materials and products to be installed as per manufacturer's recommendations.
- 15. Remove all construction and demolition materials and leave premises broom clean.
- 16. All work to be done according to the highest standards of the trade.
- 17. Warranty: Contractor to provide Owner with one-year warranty against defects in worksmanship, materials, equipment, and systems contractor is providing.
- 18. Liability and Workmen's Compensation insurance will be the responsibility of the contractor and must be kept in effect for the entire duration of the project. A written verification of the insurance coverage is required prior to the start of construction.

SCOPE OF WORK

- 1. Remove existing second floor side deck, posts, railings and decking. Leave existing roof intact, inspect condition, patch and repair if necessary.
- Remove existing second floor bathroom. Save existing plumbing fixtures and evaluate for reuse. Save doors for reuse.
- 3. Remove hexagonal window in bathoom on north side of house.
- Frame new addition off master bedroom, on top of existing side roof.
- 5. Insulate exterior walls and ceiling with stud/rafter cavity insulation and rigid exterior insulation, as per code, install smart vapor retarder between GWB and studs/rafters.
- 6. Install new shower, vanity and sinks, and toilet in master bathroom.
- 7. Flooring to be tile in master bath and closet, selected by owners.
- 8. Flooring in family bathroom to be tile, selected by owners.
- 9. Windows to be Pella with interior blinds (composite exterior and wood interior). Custom transom window to be determined.
- 10. Pocket doors as noted.
- 11. GWB and skim coat plaster throughout.
- 12. Interior trim and baseboards to match existing.
- 13. Paint all new interior and exterior work. Eggshell finish, Benjamin Moore Regal paints. Prime and two finish coats. Interior and exterior colors to be determined by owners.
- 14. Run new stack for master bathroom plumbing. Plumbing for hot and cold water to shower and sinks, connected to house plumbing.
- 15. Install new tub and toilet selected by owners in family bathroom. Reuse existing vanity, counter and sink.
- 16. Electrical work as described.
- 17. Install vent fans in master bathroom and family bathroom.
- 18. Connect to existing heat and AC system.
- 19. Install gutters and downspouts to match existing.
- 20. The following will be provided by owner, or by contractor for an additional cost once final decisions are made:
 - -Plumbing fixtures and fittings
 - -Decorative light fixtures
 - -Built-in cabinets, storage, and other millwork
 - -Mirrors, medicine cabinets, and bath accessories
 - -Countertops
 - -Tile and grout

GENERAL ELECTRICAL NOTES

- 1. Wiring includes master bathroom, walk-in closet and family bathroom.
- 2. Final lighting plan for master bathroom and family bathroom to be verified in field after rough framing.
- 3. Coordinate outlet locations with cabinetry, built ins and furniture layout.
- 4. Provide GFI outlets as per code.
- 5. All decorative light fixtures and bulbs to be provided by owner.
- 6. Check with owner about switch style (Lutron vs. toggle).
- 7. Install "warm floor" electric heat under tile with separate thermostat as supplemental heat.
- 8. Vents and closet lights by electrical subcontractor.

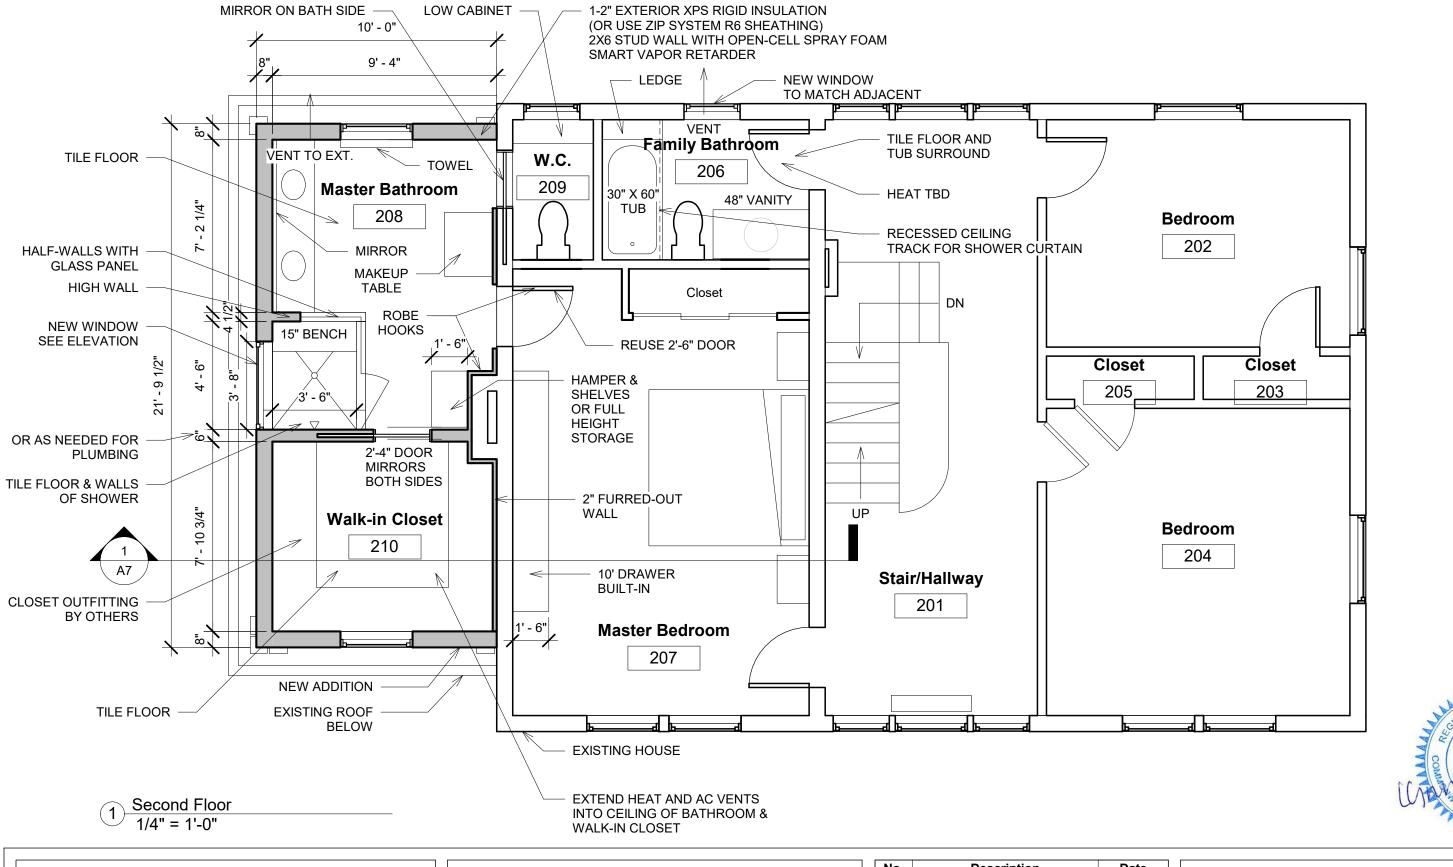




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No.	Description	Date

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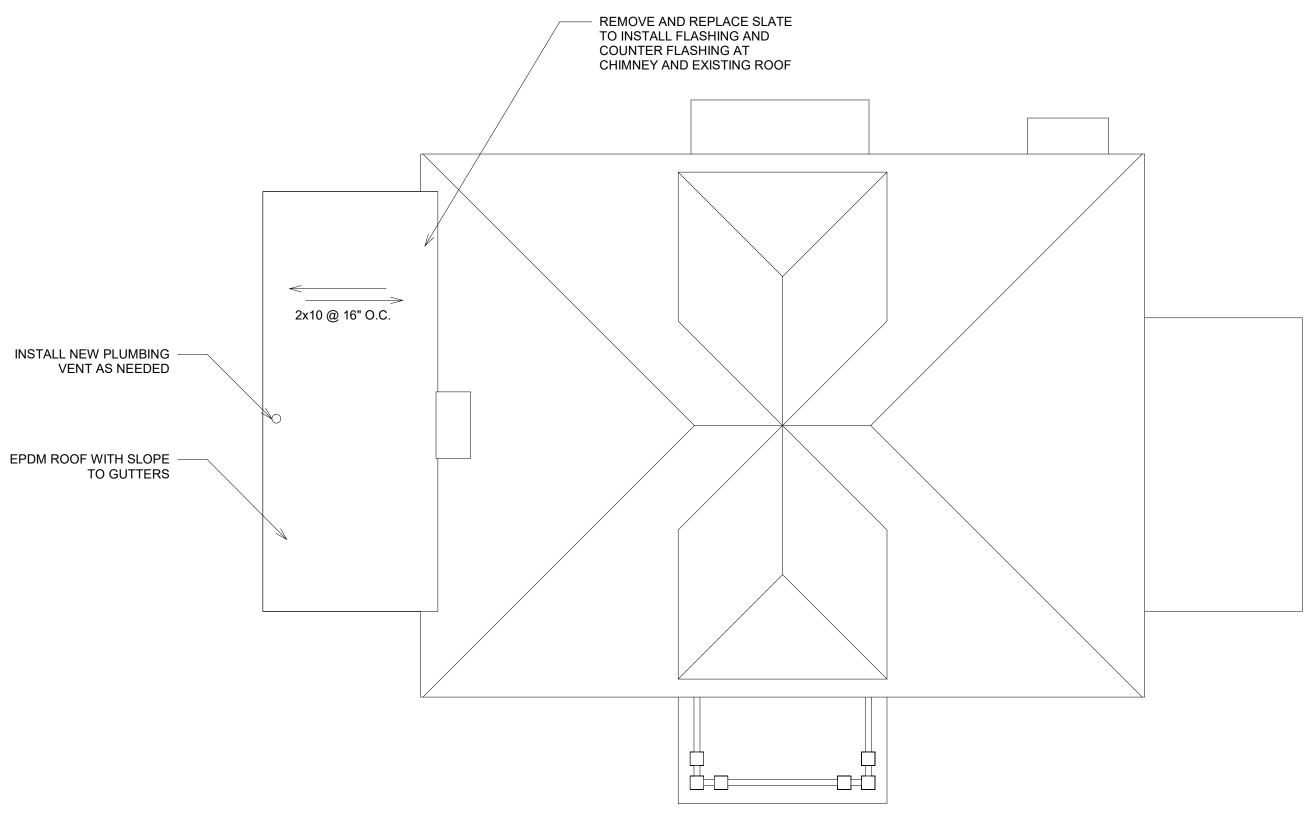
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No.	Description	Date
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Second Floor Plan			
Project number	2103		
Date	05/05/21	A2	
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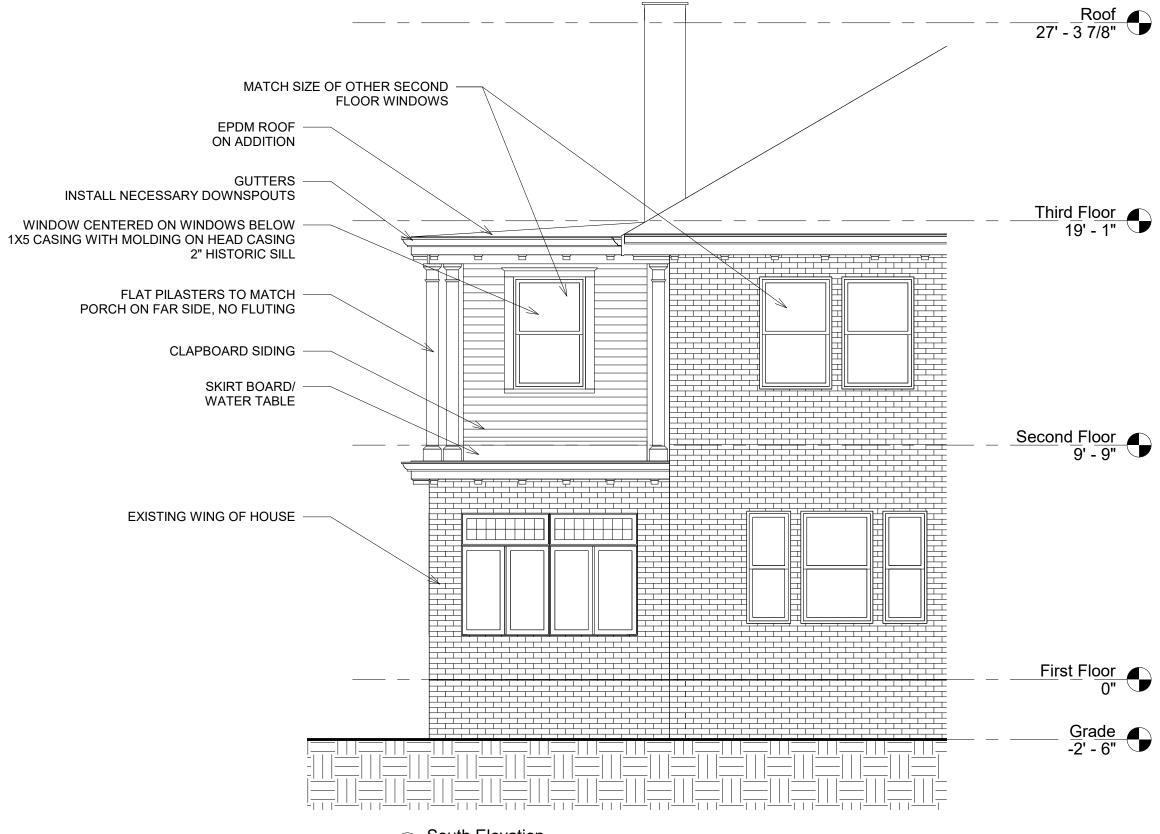
1 Roof Plan 3/16" = 1'-0"

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No.	Description	Date

Roof Plan			
Project number	2103		
Date	05/05/21	A3	
Drawn by	MCO		
Checked by	LCO	Scale 3/16" = 1'-0"	





1 South Elevation 1/4" = 1'-0"

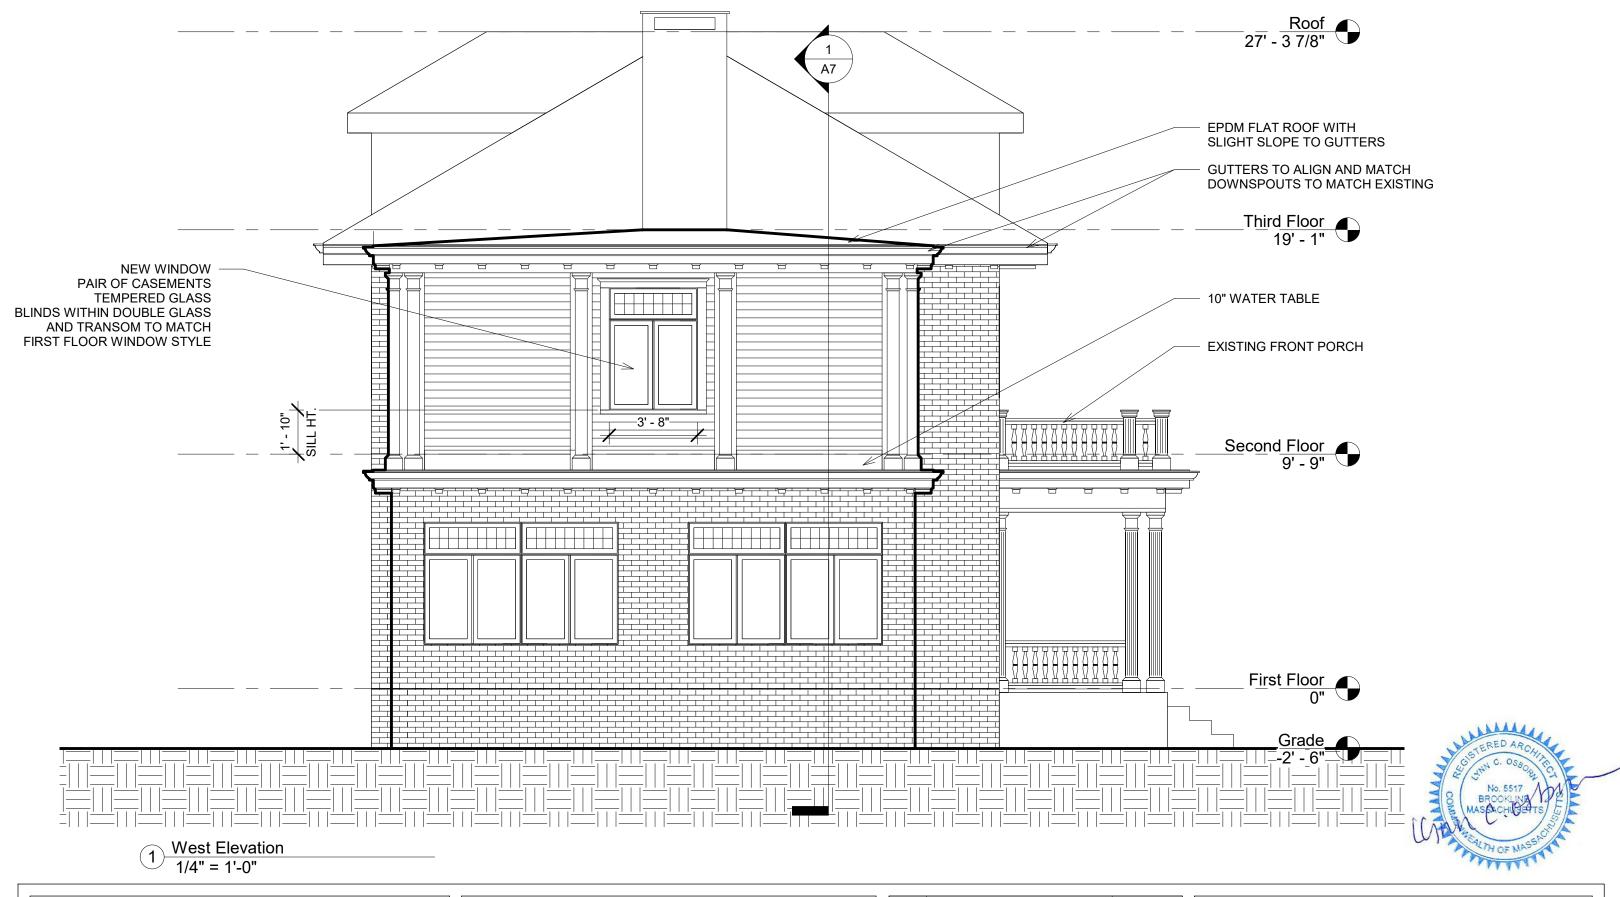
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617-306-8480

Lewis Residence 279 Pond Street Jamaica Plain, MA 02130

No.	Description	Date

South Elevation		
Project number	2103	
Date	05/05/21] A4
Drawn by	MCO	
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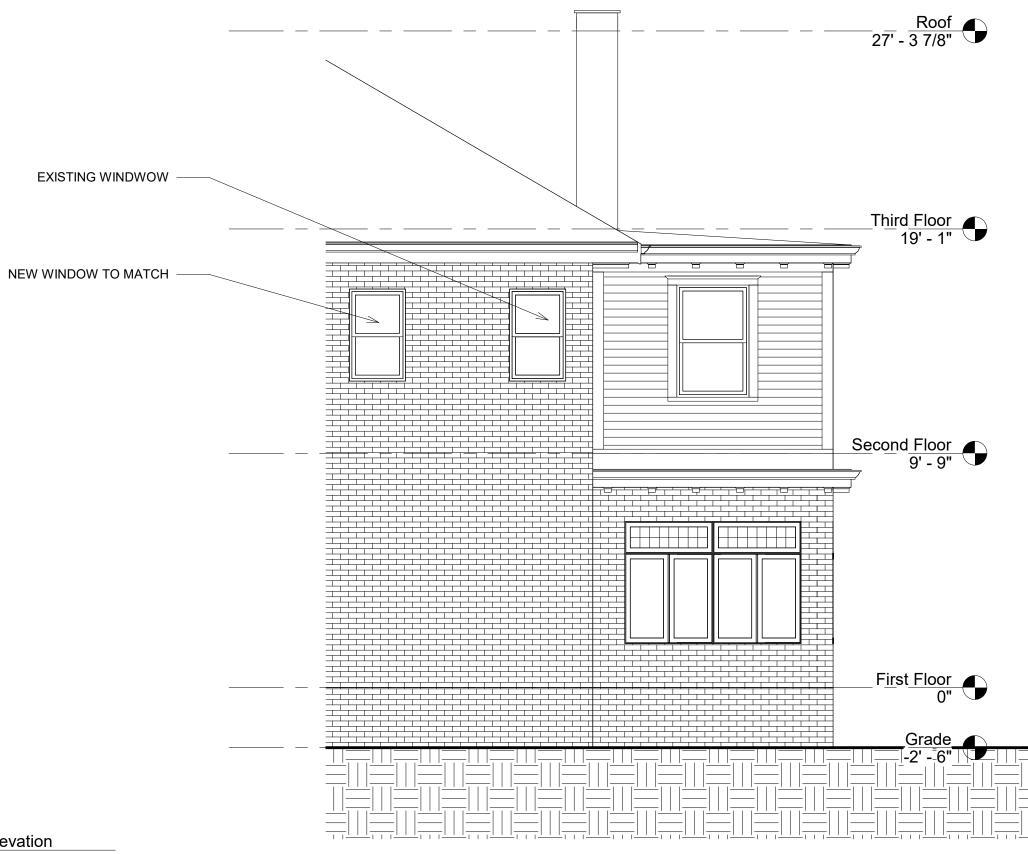


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No.	Description	Date

West Ele	evation		
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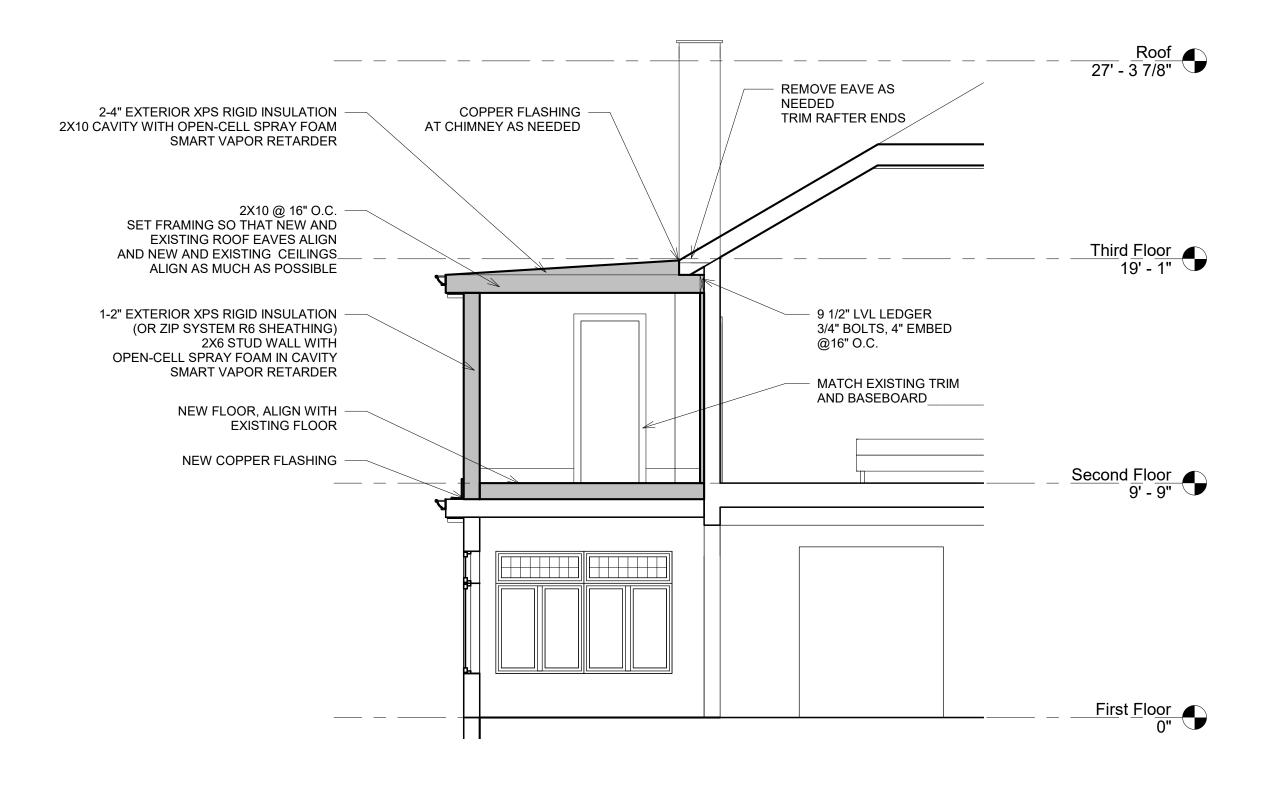


1 North Elevation 1/4" = 1'-0"

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No.	Description	Date

North El	evation		
Project number	2103		
Date	05/05/21	A6	
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STERED ARCHITECTORY

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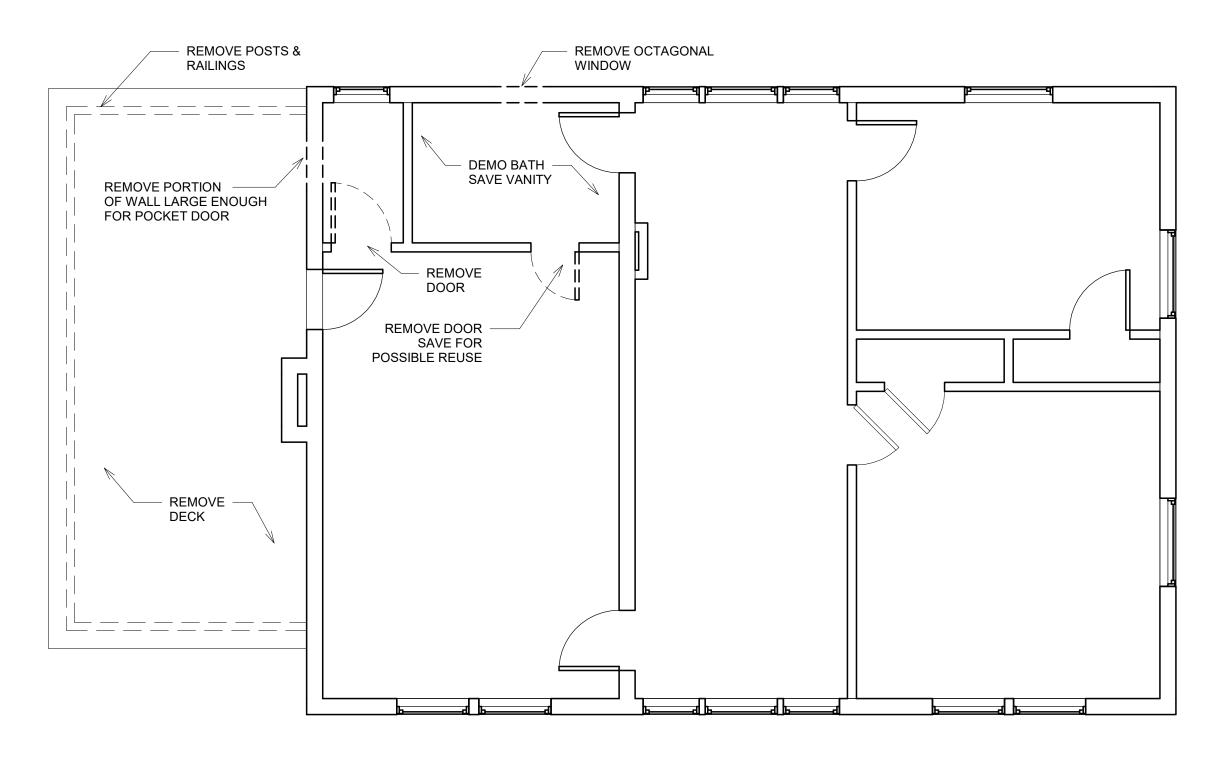
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1 Section 1 1/4" = 1'-0"

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No.	Description	Date	
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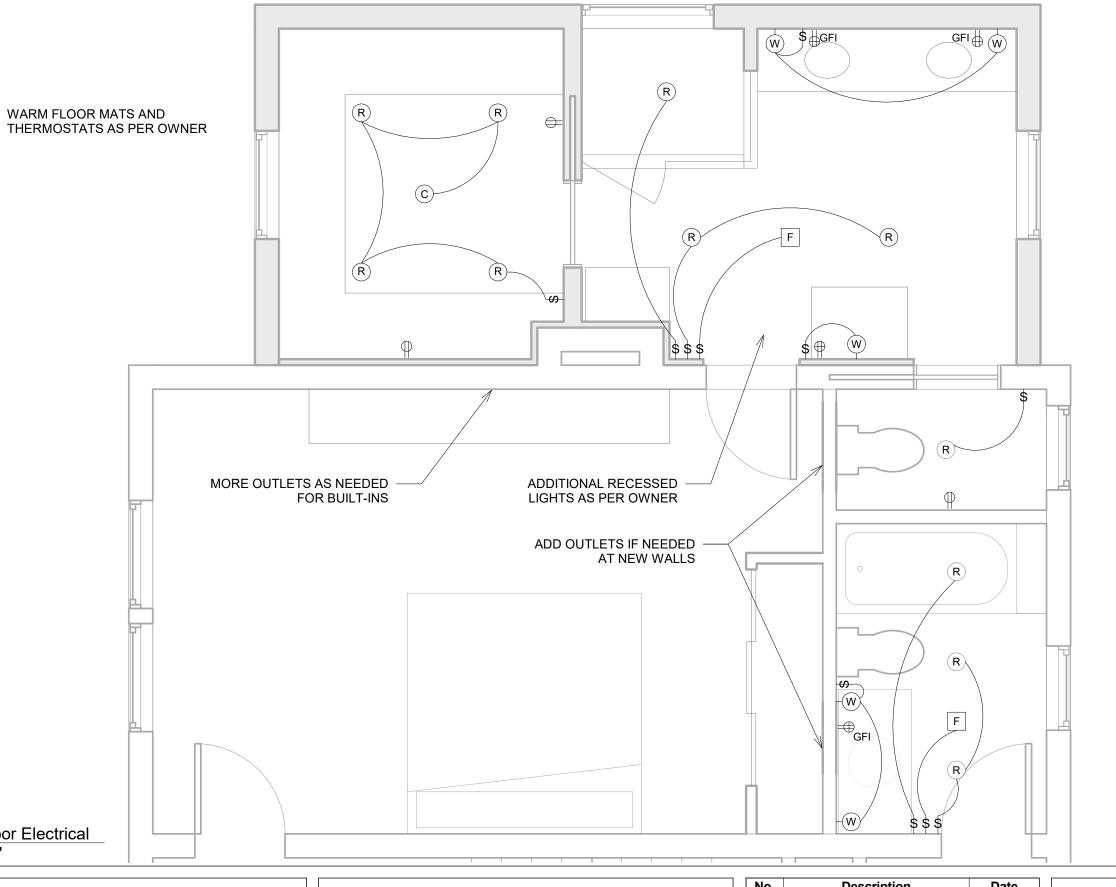
Second Floor Demolition
1/4" = 1'-0"



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No.	Description	Date

Second	Floor Demo	lition Plan	
Project number	2103		
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Checked by	LCO	Scale 1/4" = 1'-0"	
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LEGEND

- RECESSED DOWNLIGHT (WATERPROOF IN SHOWERS)
- © CEILING-MOUNTED LIGHT
- W WALL SCONCE
- DUPLEX OUTLET
- DUPLEX OUTLET, COUNTER HEIGHT GROUND FAULT INTERUPTOR
- F FAN ONLY



Second Floor Electrical
3/8" = 1'-0"



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Lewis Residence 279 Pond Street Jamaica Plain, MA 02130

No.	Description	Date

Second	Floor	Electrical	Plan

Project number	2103	
Date	05/05/21	F1
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Checked by	LCO	Scale 3/8" = 1'-0"

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No.	Description	Date	

Existing Front View				
Project number	2103			
Date	08/23/21	A15		
Drawn by	MCO	, , , ,		
Checked by	LCO	Scale		





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No.	Description	Date

Proposed Front View				
Project number	2103	• 4 •		
Date	08/23/21	A16		
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Checked by	LCO	Scale		