
25 RUSKINDALE ROAD EXTERIOR COLOR SCHEME A

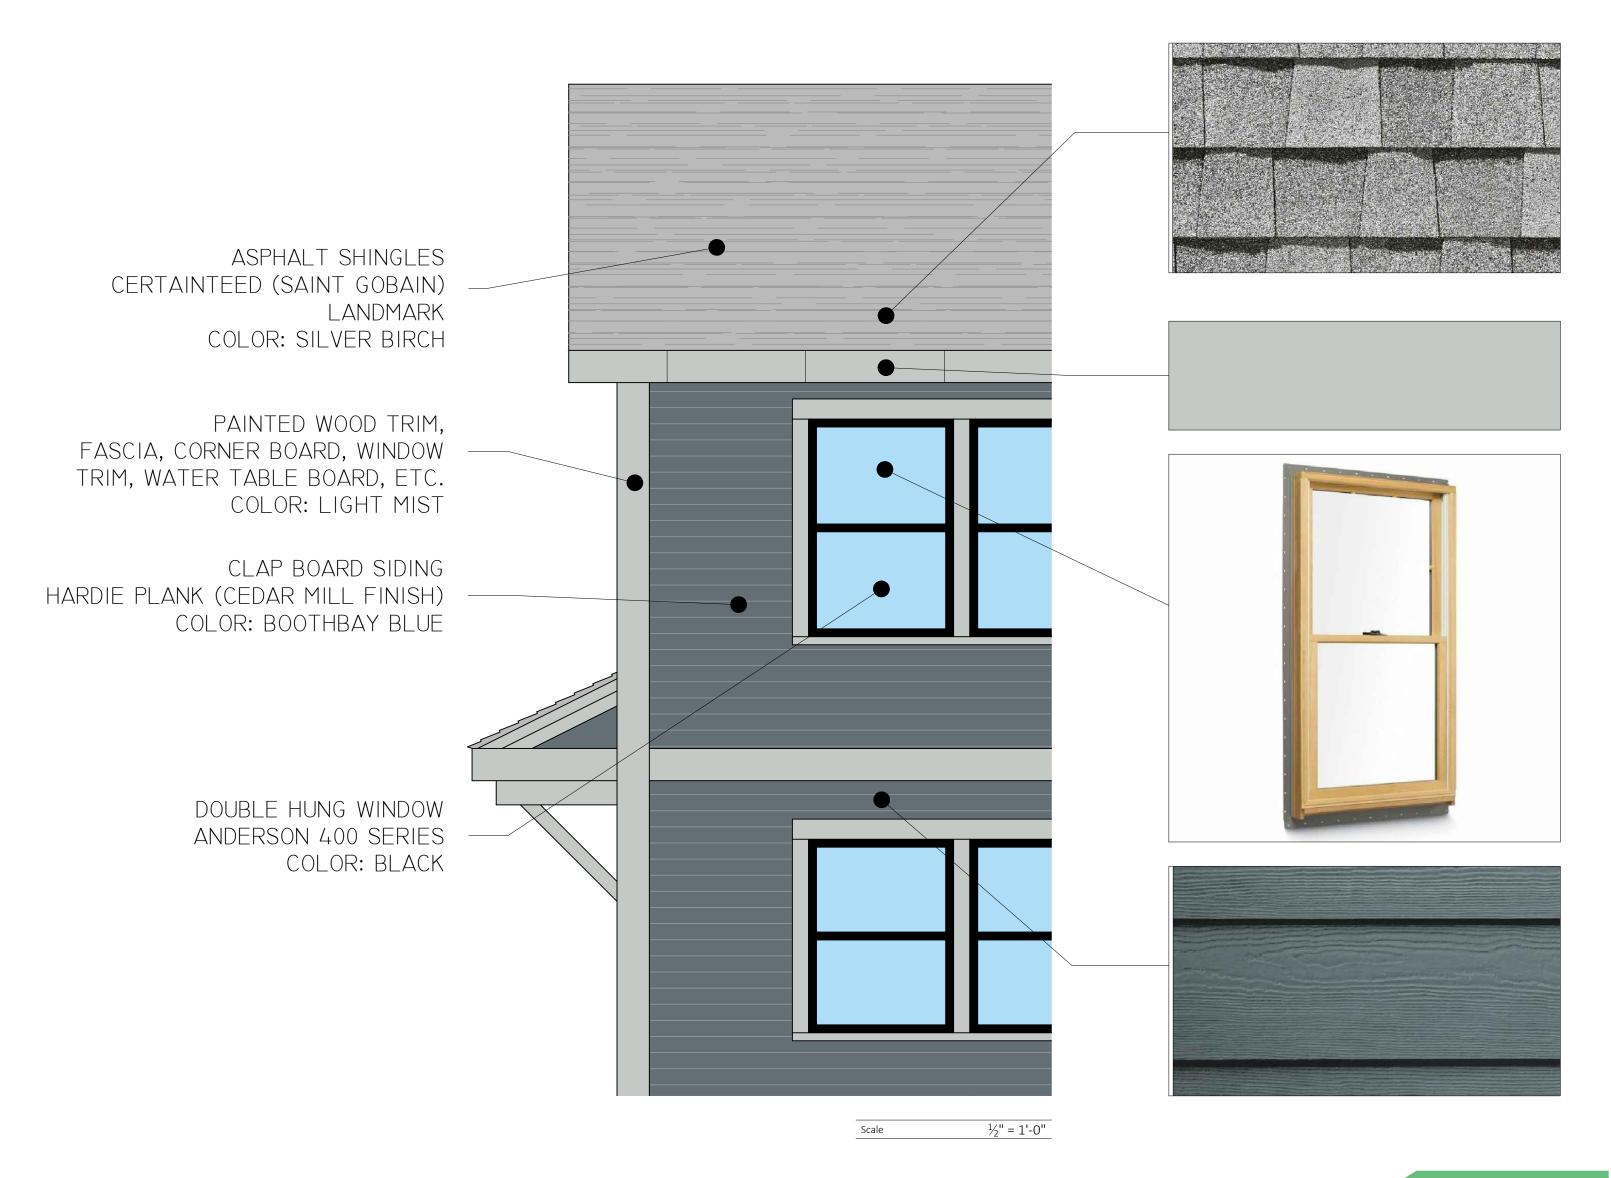






½" = 1'-0"

Scale


25 RUSKINDALE ROAD EXTERIOR COLOR SCHEME B



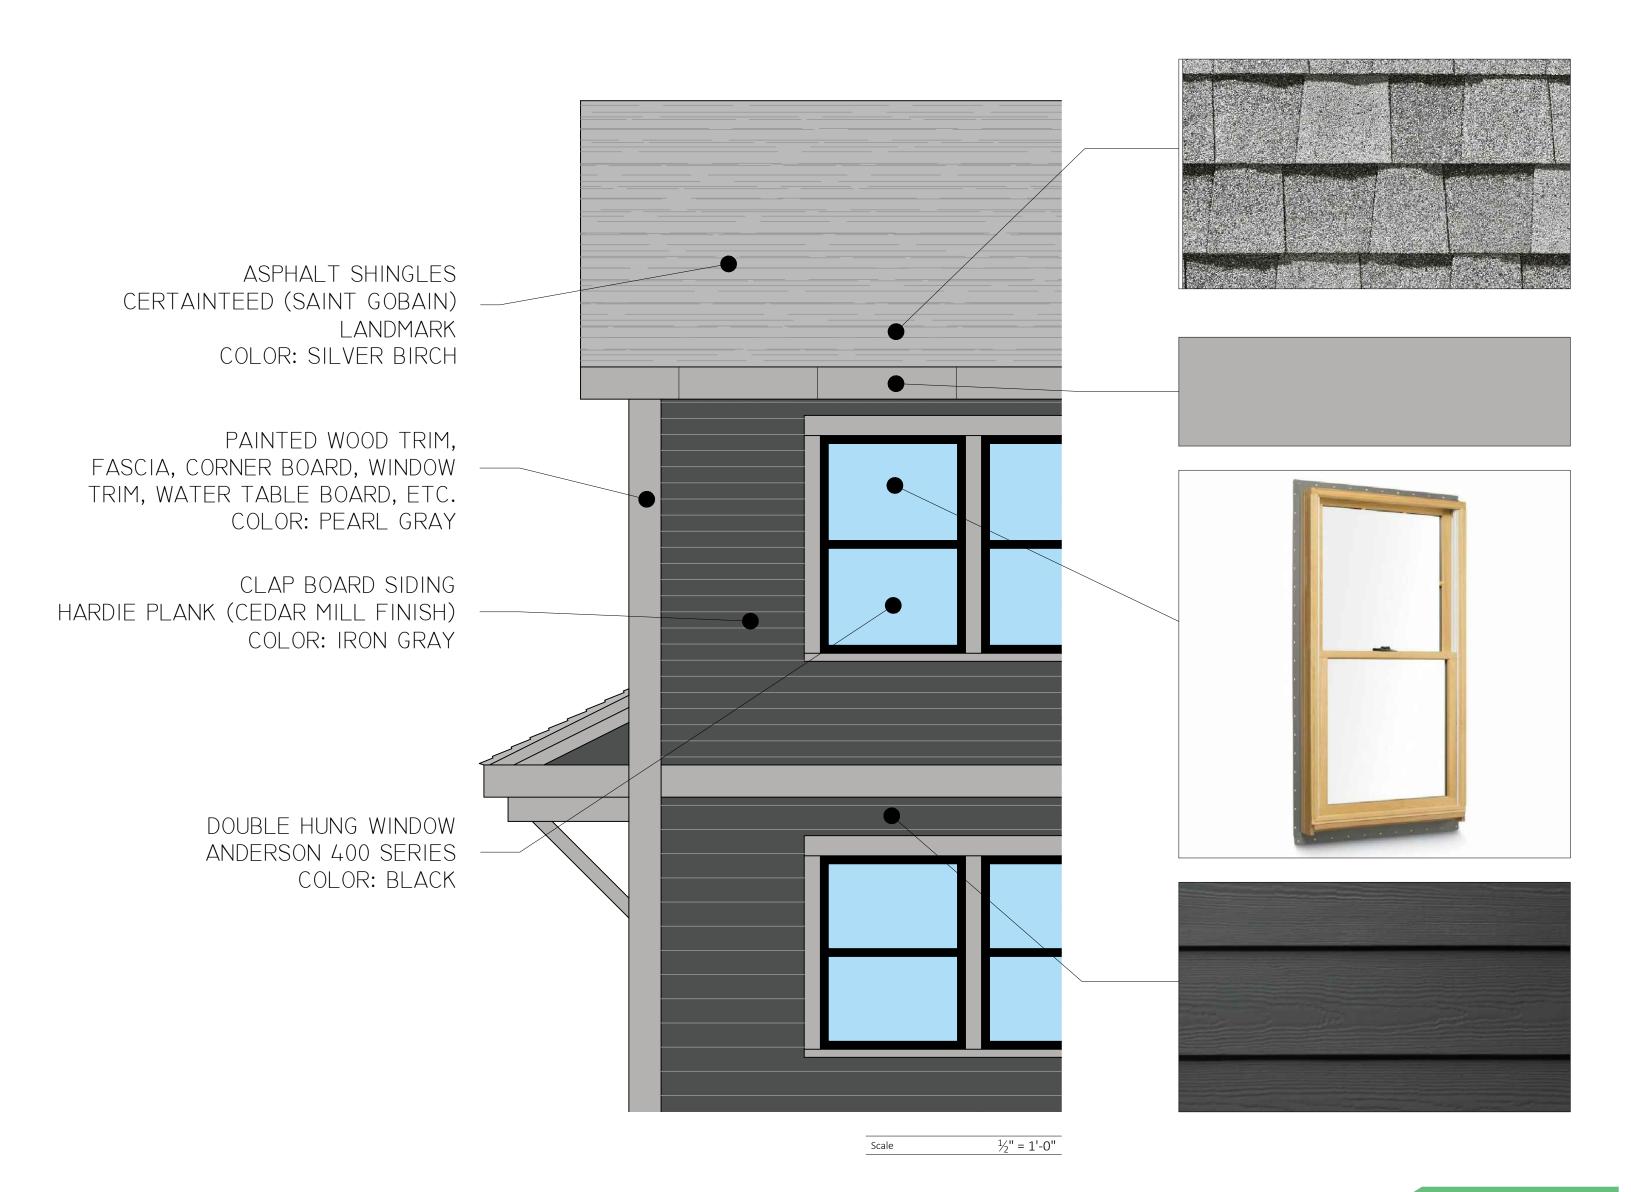



25 RUSKINDALE ROAD YouthBuild Strengthening Youth. Rebuild EXTERIOR COLOR SCHEME C

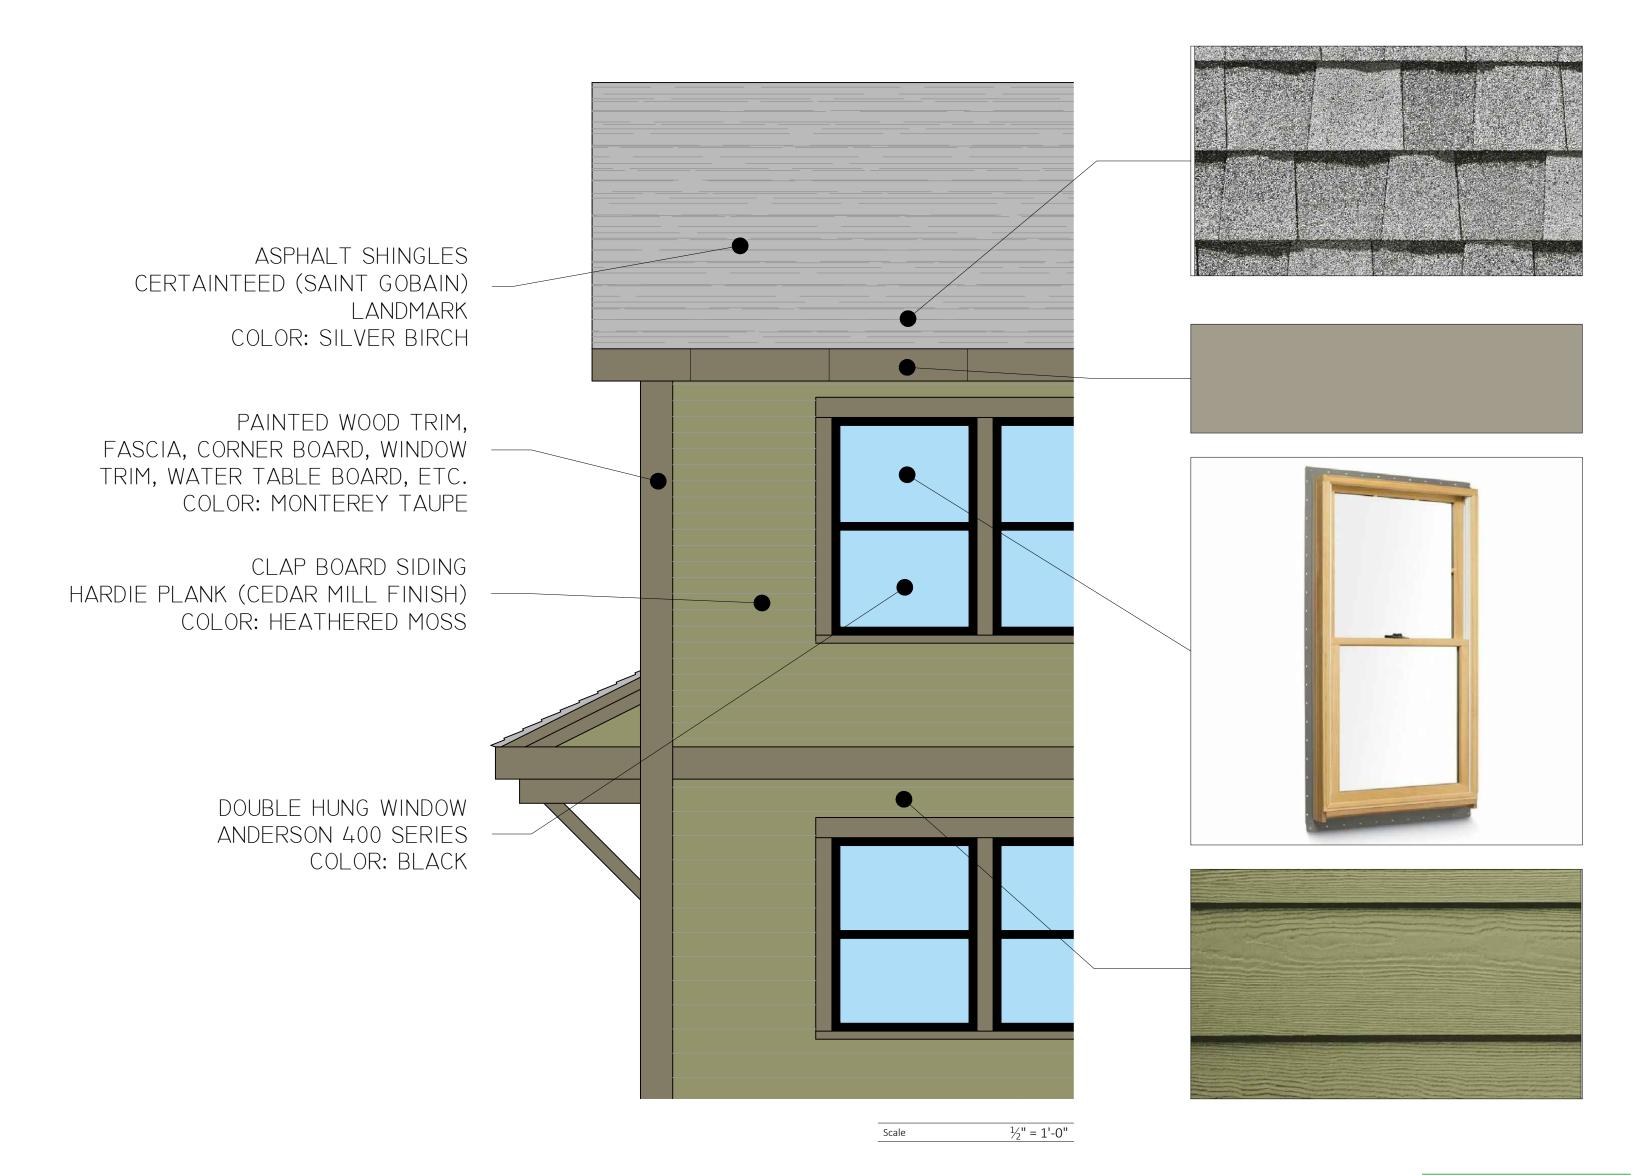



ZONING ANALYSIS

PROJECT ADDRESS	23-25 RUSKINDALE ROAD
NEIGHBORHOOD	HYDE PARK
ZONING AREA CODE	IF-6000
ZONING ARTICLE	69
DIJII DING LISE TYPE (FDOM TADI E A)	ONE EAMILY DETACHED - ALLOWED

GROSS FL	OOR AREA	,634 sq.ft.

	REQUIRED	EXISTING	PROPOSED
MINIMUM LOT FRONTAGE	60'-0"	90'-0"	NO CHANGE
MINIMUM LOT SIZE	6000 sq.ft.	7200 sq.ft.	NO CHANGE
MINIMUM LOT WIDTH	60'-0"	90'-0"	NO CHANGE
MAXIMUM FLOOR AREA RATIO	0.5		0.23
MAXIMUM BUILDING HEIGHT	2½ STORIES		2 STORIES
	35'-0"		24'-4"
USABLE OPEN SPACE	I,800 SQ.FT.		4,772 SQ.FT.
FRONT YARD SET BACK	20'-0"*		20'-3"
SIDE YARD SET BACK	10'-0"		10'-0"
REAR YARD SET BACK	30'-0" **		30'-3"
OFF STREET PARKING / DWELLING UNIT	2		2

^{*} ARTICLE 69.30.1 CONFORMITY WITH EX. BUILDING ALIGNMENT ** ARTICLE 69.30.10 REAR YARD OF CERTAIN SHALLOW LOTS.

PERMITTED AS OF RIGHT	YES
-----------------------	-----



RUSKINDALE ROAD

SITE USE PLAN



27 Centre St. Roxbury, MA 02119 (617) 445-8887 www.youthbuildboston.org

Construction Supervisor:

Joseph Diaz CS License Number: HIC License Number: Office: (617) 445-8887 Cell: (617) 592-8259

SUBN	IISSIONS:	
No.	Description	dd/mm/
001	Project Proposal	14/19/20
	BLICKINIDALE BEC	IDENICE


RUSKINDALE RESIDENCE 23 Ruskindale Road Boston, Ma 02126

ZONING ANALYSIS

Project number	1603
Date	31/10/2017
Drawn by	AH
Checked by	AH

LP100

½" = 1'-0"

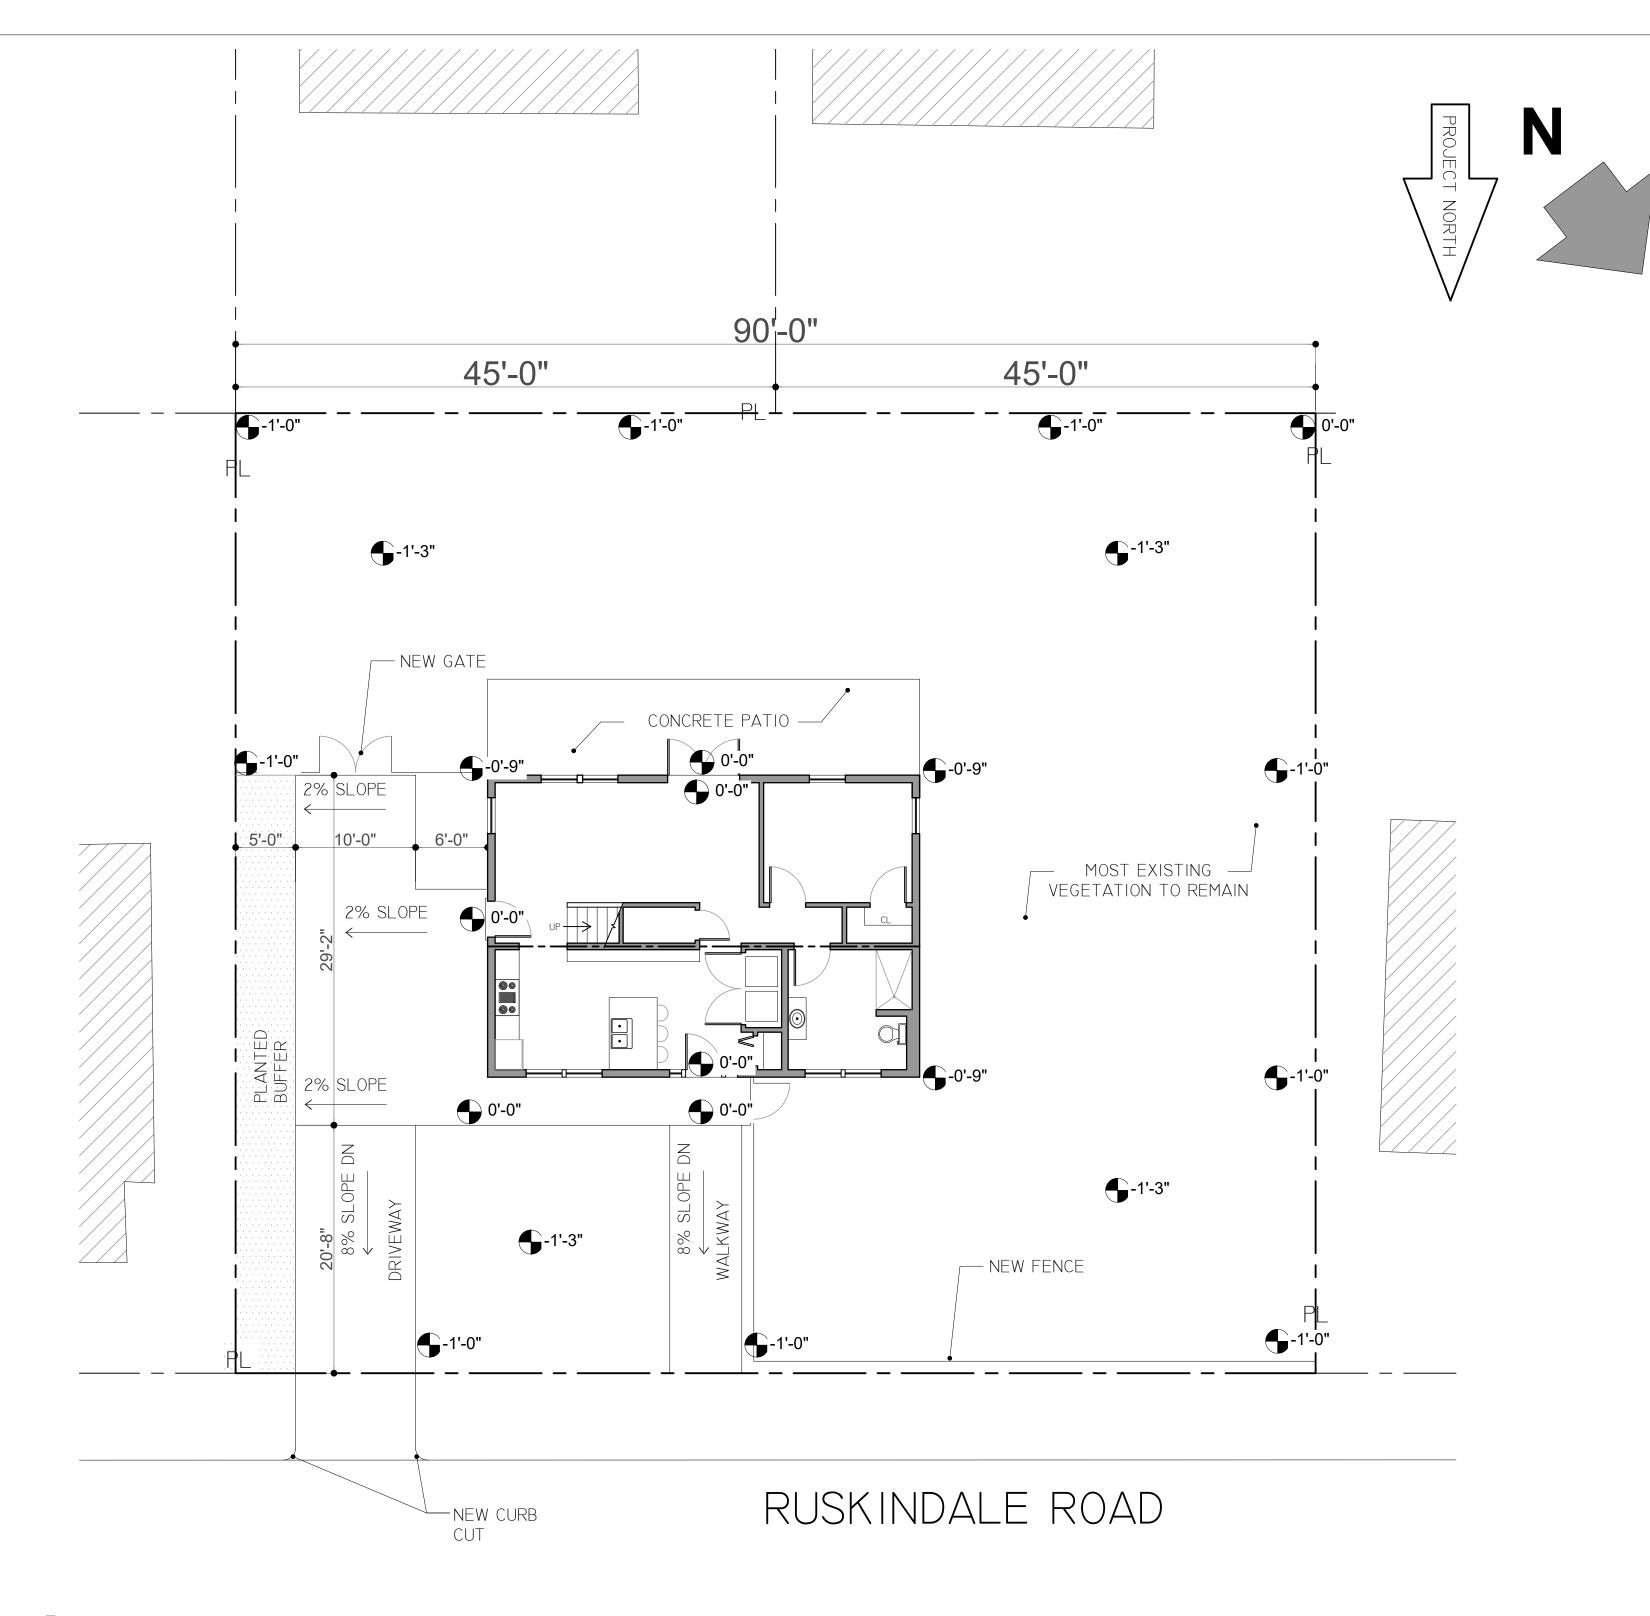



27 Centre St. Roxbury, MA 02119 (617) 445-8887 www.youthbuildboston.org

Construction Supervisor:

Joseph Diaz
CS License Number:
HIC License Number:
Office: (617) 445-8887
Cell: (617) 592-8259

SUBMISSIONS:

No.	Description	dd/mm
001	Project Proposal	14/19/20

RUSKINDALE RESIDENCE 23 Ruskindale Road Boston, Ma 02126


SITE IMPROVEMENT PLAN

Project number	1603
Date	31/10/2017
Drawn by	AH
Checked by	AH

LP101

Scale $\frac{1}{8}$ " = 1'-0"

SITE IMPROVEMENT PLAN

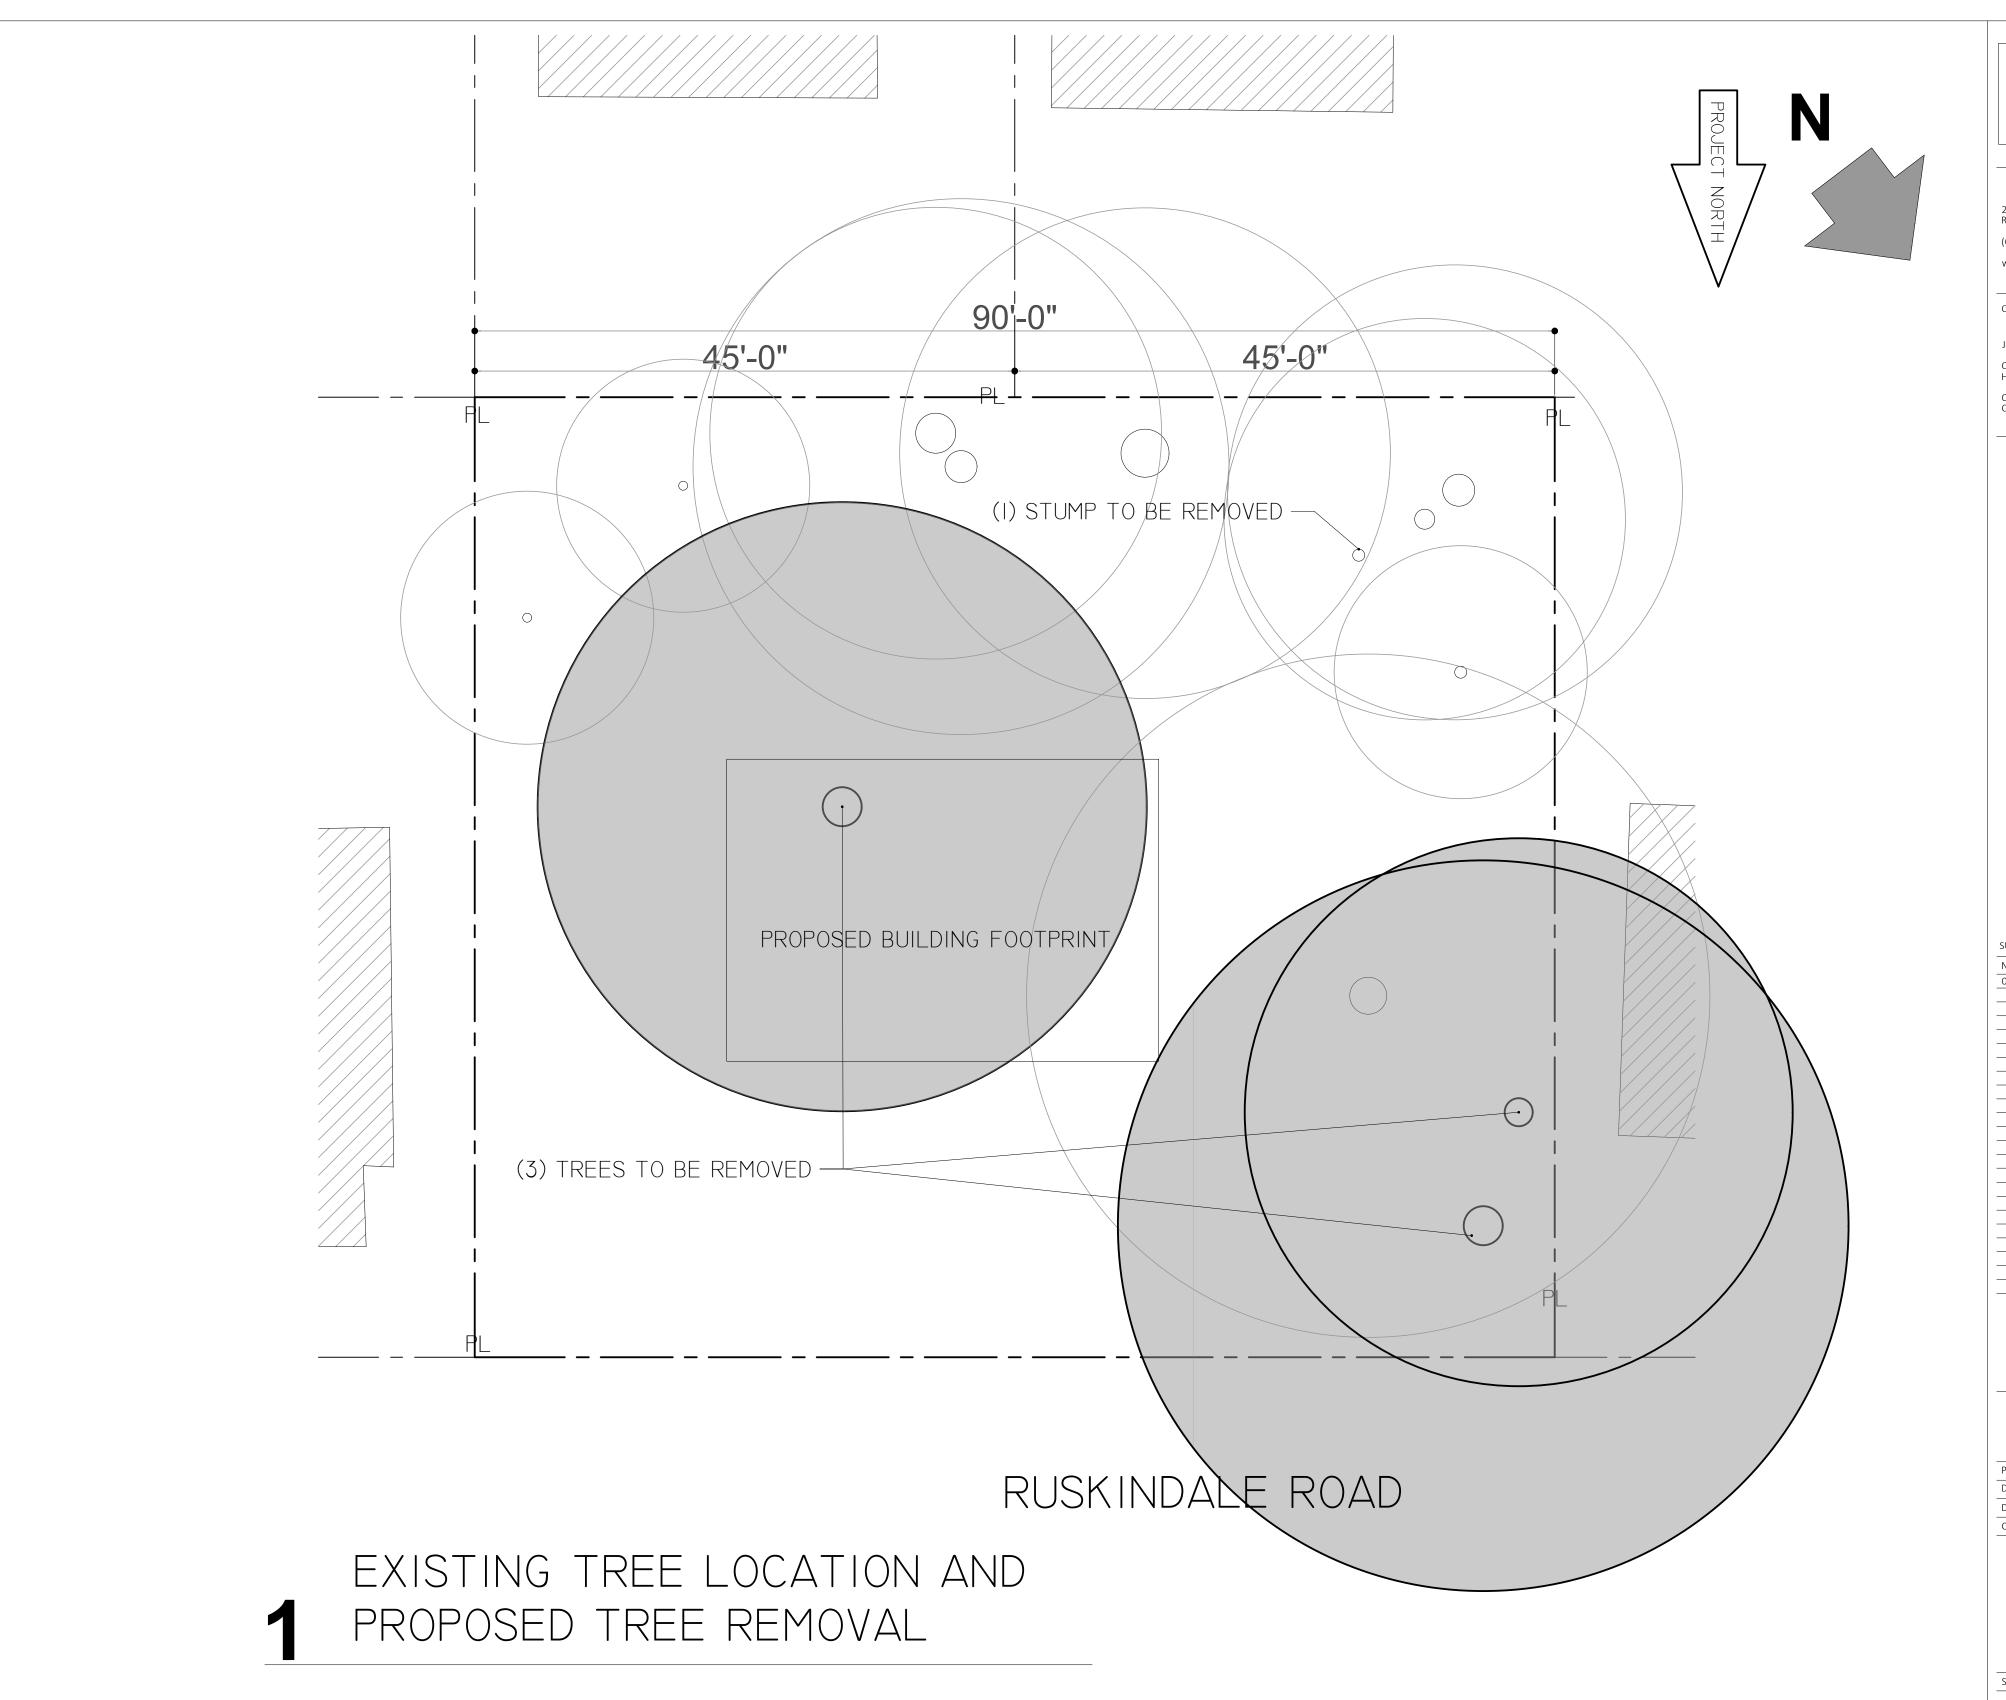



27 Centre St. Roxbury, MA 02119 (617) 445-8887 www.youthbuildboston.org

Construction Supervisor:

Joseph Diaz
CS License Number:
HIC License Number:
Office: (617) 445-8887
Cell: (617) 592-8259

SUBMISSIONS:

No.	Description	dd/mm,
001	Project Proposal	14/19/20
	DUCKIND ALE DEC	IDENICE


RUSKINDALE RESIDENCE 23 Ruskindale Road Boston, Ma 02126

EXISTING TREE LOCATION AND PROPOSED TREE REMOVAL

Project number	1603
Date	31/10/2017
Drawn by	AH
Checked by	AH

LP102

Scale $\frac{1}{8}$ " = 1'-0"

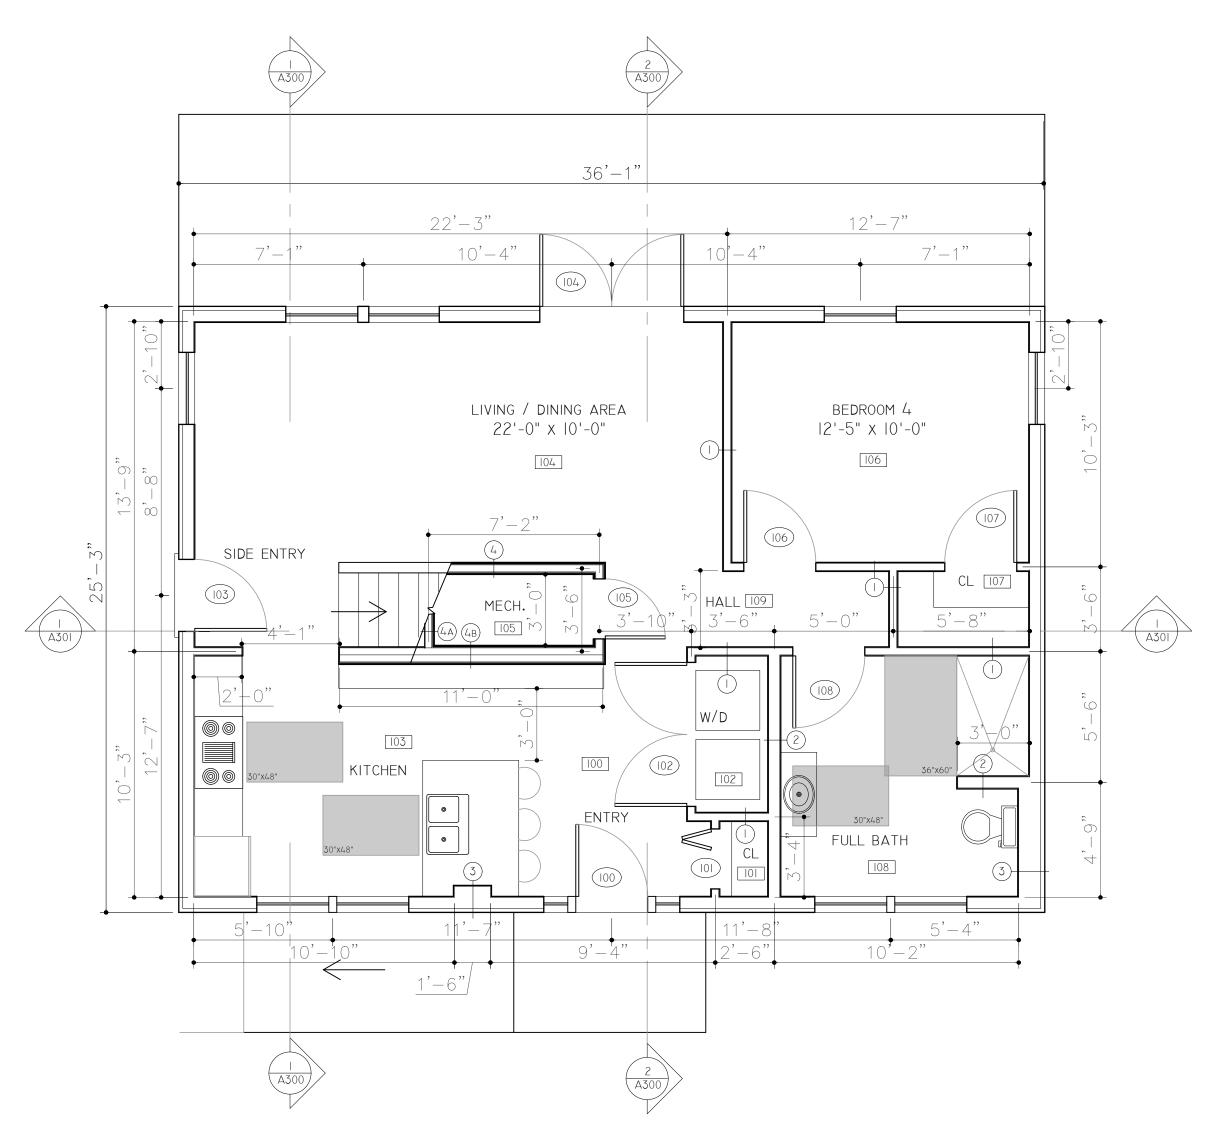

FIRST FLOOR PLAN

- INTERIOR DIMENSIONS ARE TO FACE OF STUD
- REFER TO A700 FOR PARTITION TYPE DETAILS



27 Centre St. Roxbury, MA 02119 (617) 445-8887 www.youthbuildboston.org

Construction Supervisor:

Joseph Diaz
CS License Number:
HIC License Number:
Office: (617) 445-8887
Cell: (617) 592-8259

SUBMISSIONS:

No.	Description	dd/mm
001	Project Proposal	14/19/2


RUSKINDALE RESIDENCE 23 Ruskindale Road Boston, Ma 02126

FIRST FLOOR PLAN

Project number	1603
Date	31/10/2017
Drawn by	AH
Checked by	AH

A100

Scale $\frac{1}{4}$ " = 1'-0"

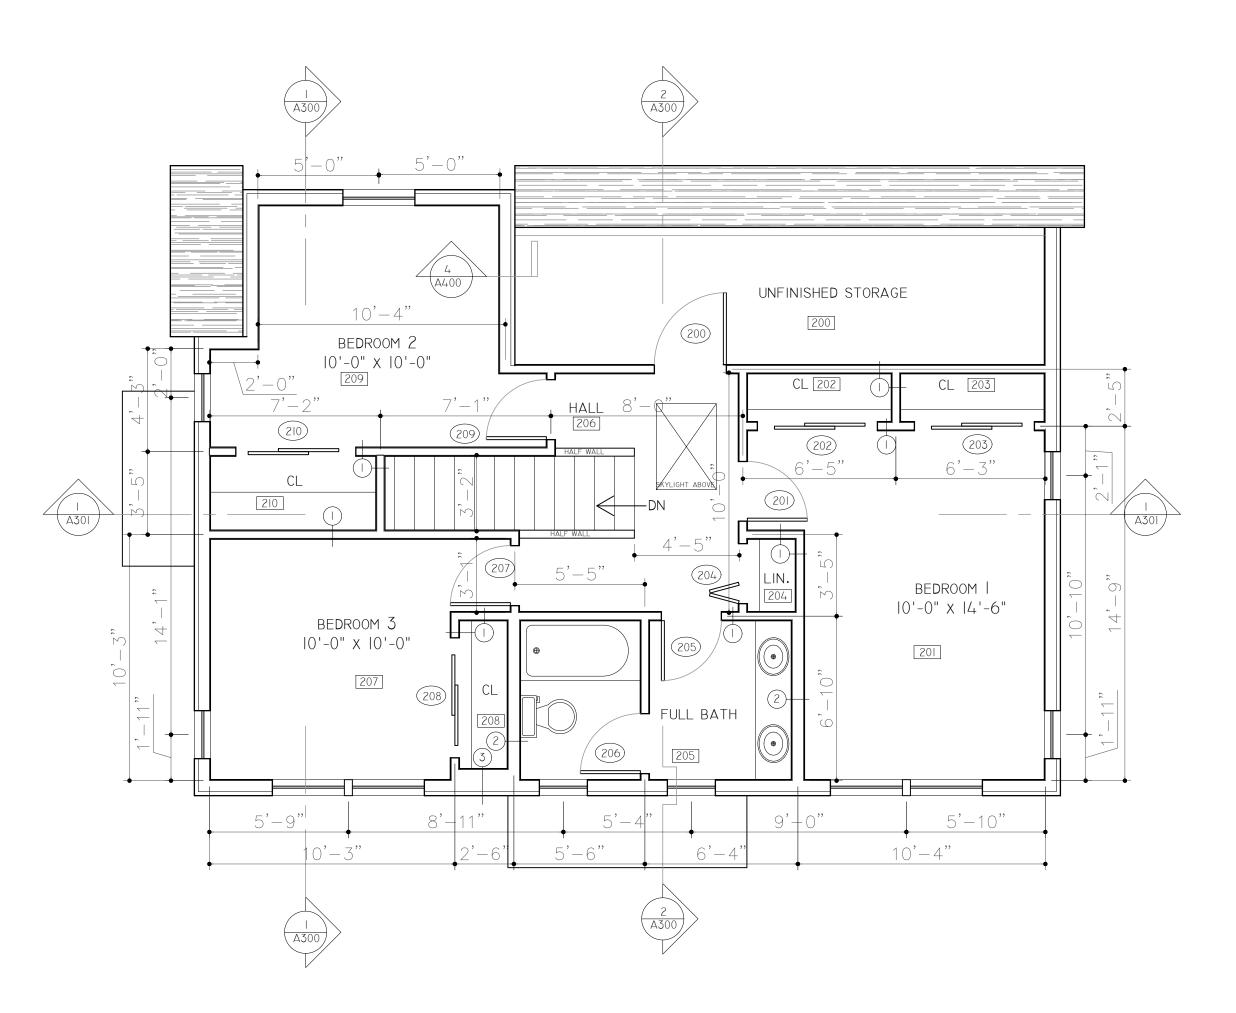

SECOND FLOOR PLAN

- INTERIOR DIMENSIONS ARE TO FACE OF STUD
- REFER TO A700 FOR PARTITION TYPE DETAILS



27 Centre St. Roxbury, MA 02119 (617) 445-8887 www.youthbuildboston.org

Construction Supervisor:

Joseph Diaz CS License Number: HIC License Number: Office: (617) 445-8887 Cell: (617) 592-8259

SUBMISSIONS:

No.	Description	dd/mm
001	Project Proposal	14/19/2


RUSKINDALE RESIDENCE 23 Ruskindale Road Boston, Ma 02126

SECOND FLOOR PLAN

Project number	1603
Date	31/10/2017
Drawn by	AH
Checked by	AH

A101

Scale $\frac{1}{4}$ " = 1'-0"

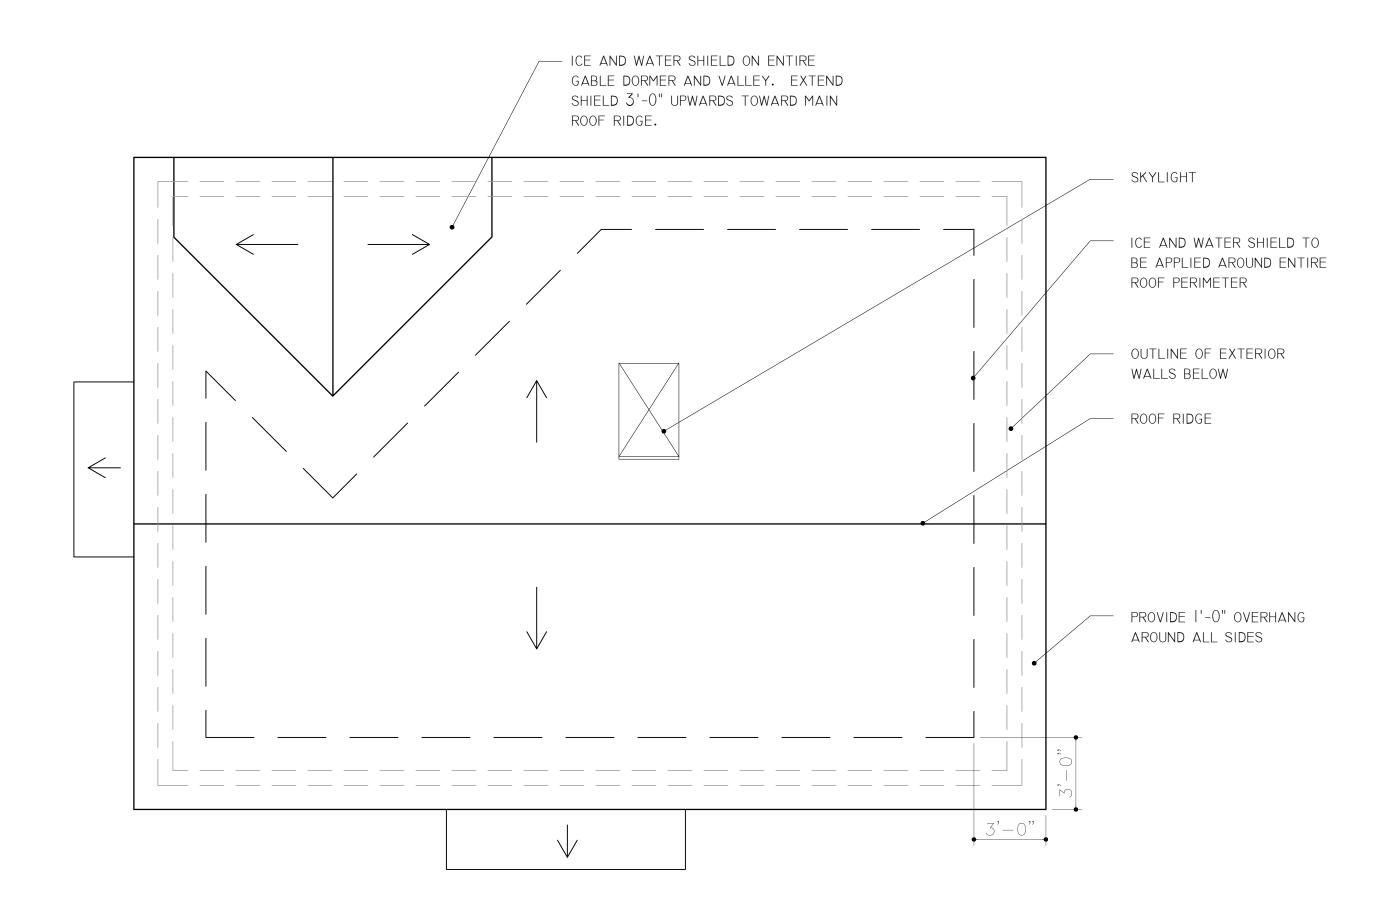

1 ROOF PLAN



27 Centre St. Roxbury, MA 02119 (617) 445-8887 www.youthbuildboston.org

Construction Supervisor:

Joseph Diaz

CS License Number:
HIC License Number:
Office: (617) 445-8887
Cell: (617) 592-8259

SUBMISSIONS:

No.	Description	dd/mm/y
001	Project Proposal	14/19/201
	1	

RUSKINDALE RESIDENCE 23 Ruskindale Road Boston, Ma 02126

ROOF PLAN


Project number	1603
Date	31/10/2017
Drawn by	AH
Checked by	AH
-	


A102

cale $\frac{1}{4}$ " = 1'-0"



A FRONT ELEVATION

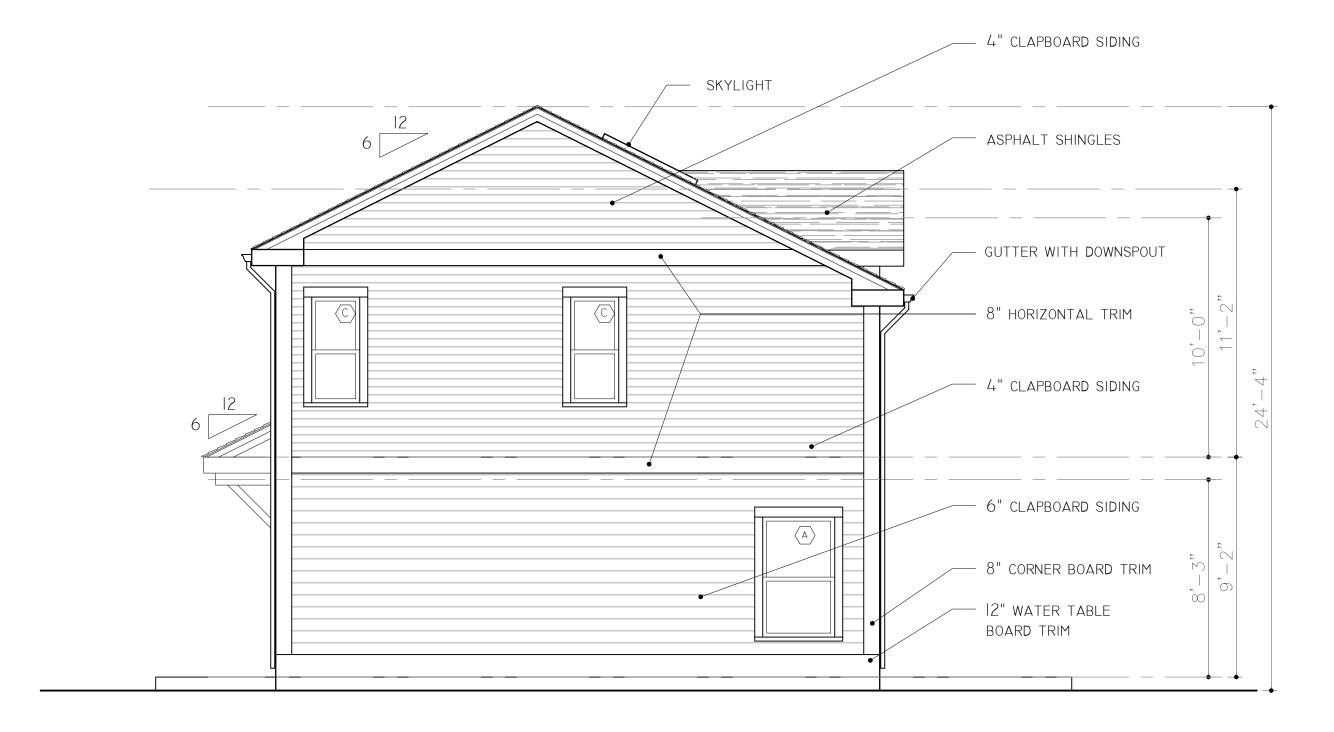

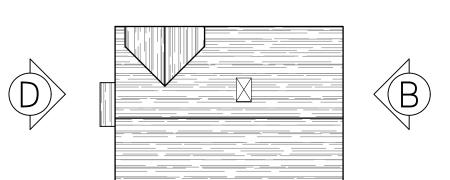



B SIDE ELEVATION



27 Centre St. Roxbury, MA 02119 (617) 445-8887 www.youthbuildboston.org

Construction Supervisor:

Joseph Diaz

CS License Number:
HIC License Number:
Office: (617) 445-8887
Cell: (617) 592-8259

SUBMISSIONS:

No.	Description	dd/mm/y
001	Project Proposal	14/19/201

RUSKINDALE RESIDENCE 23 Ruskindale Road Boston, Ma 02126

FRONT AND SIDE ELEVATION


Project number	1603
Date	31/10/2017
Drawn by	АН
Checked by	AH

A200

Scale $\frac{1}{4}$ " = 1'-0"



C REAR ELEVATION

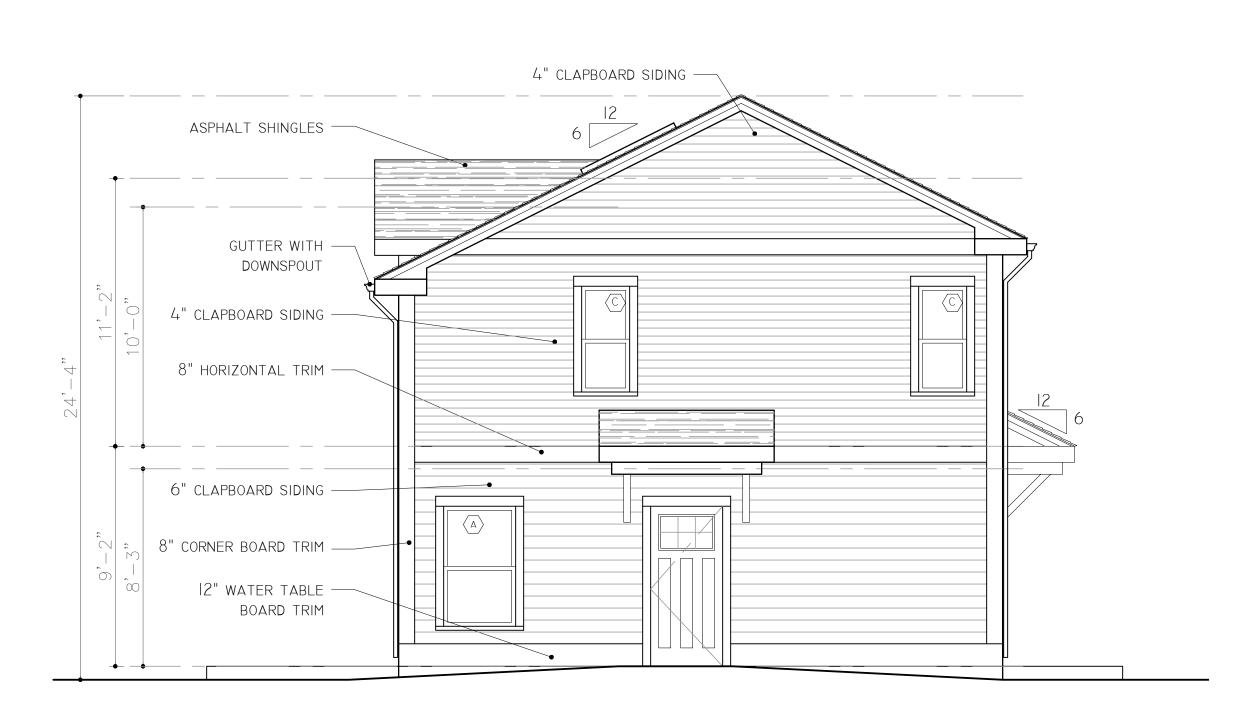





27 Centre St. Roxbury, MA 02119 (617) 445-8887 www.youthbuildboston.org

Construction Supervisor:

Joseph Diaz
CS License Number:
HIC License Number:
Office: (617) 445-8887
Cell: (617) 592-8259

SUBMISSIONS:

No.	Description	dd/mm,
001	Project Proposal	14/19/20

RUSKINDALE RESIDENCI 23 Ruskindale Road Boston, Ma 02126


> SIDE AND REAR ELEVATION


Project number	1603
Date	31/10/2017
Drawn by	AH
Checked by	AH


A201

ale $\frac{1}{4}$ " = 1'-0"



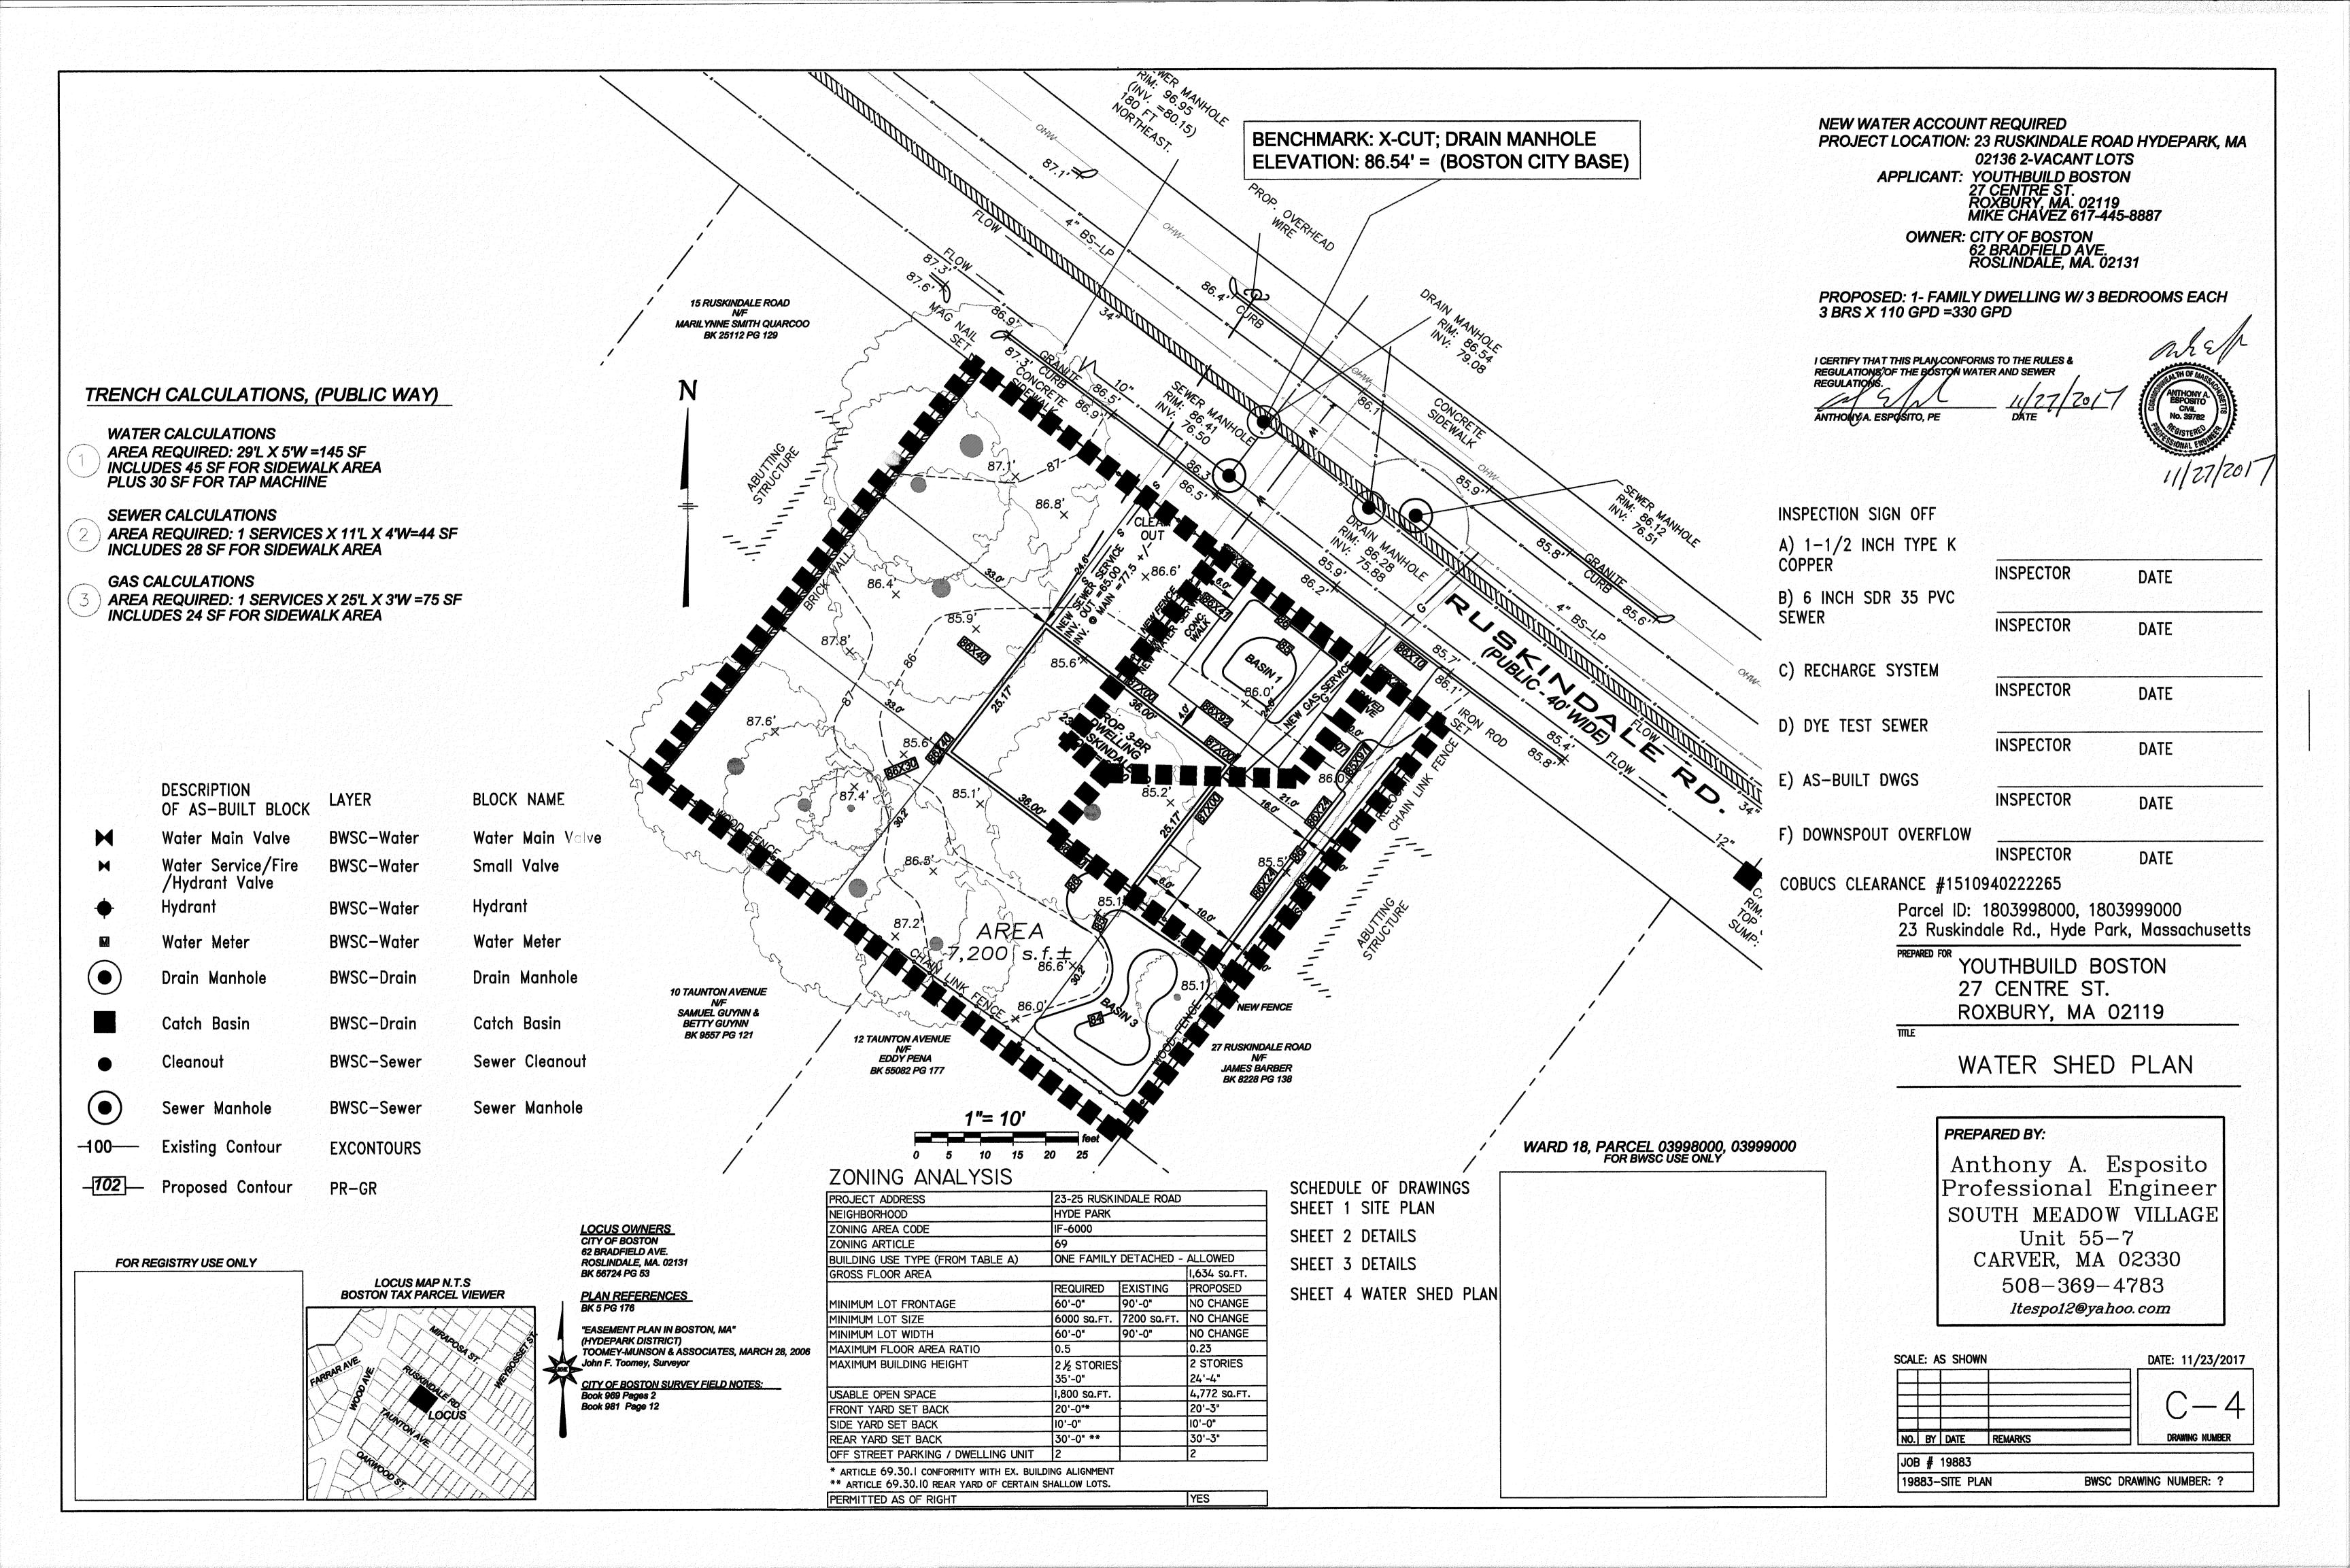

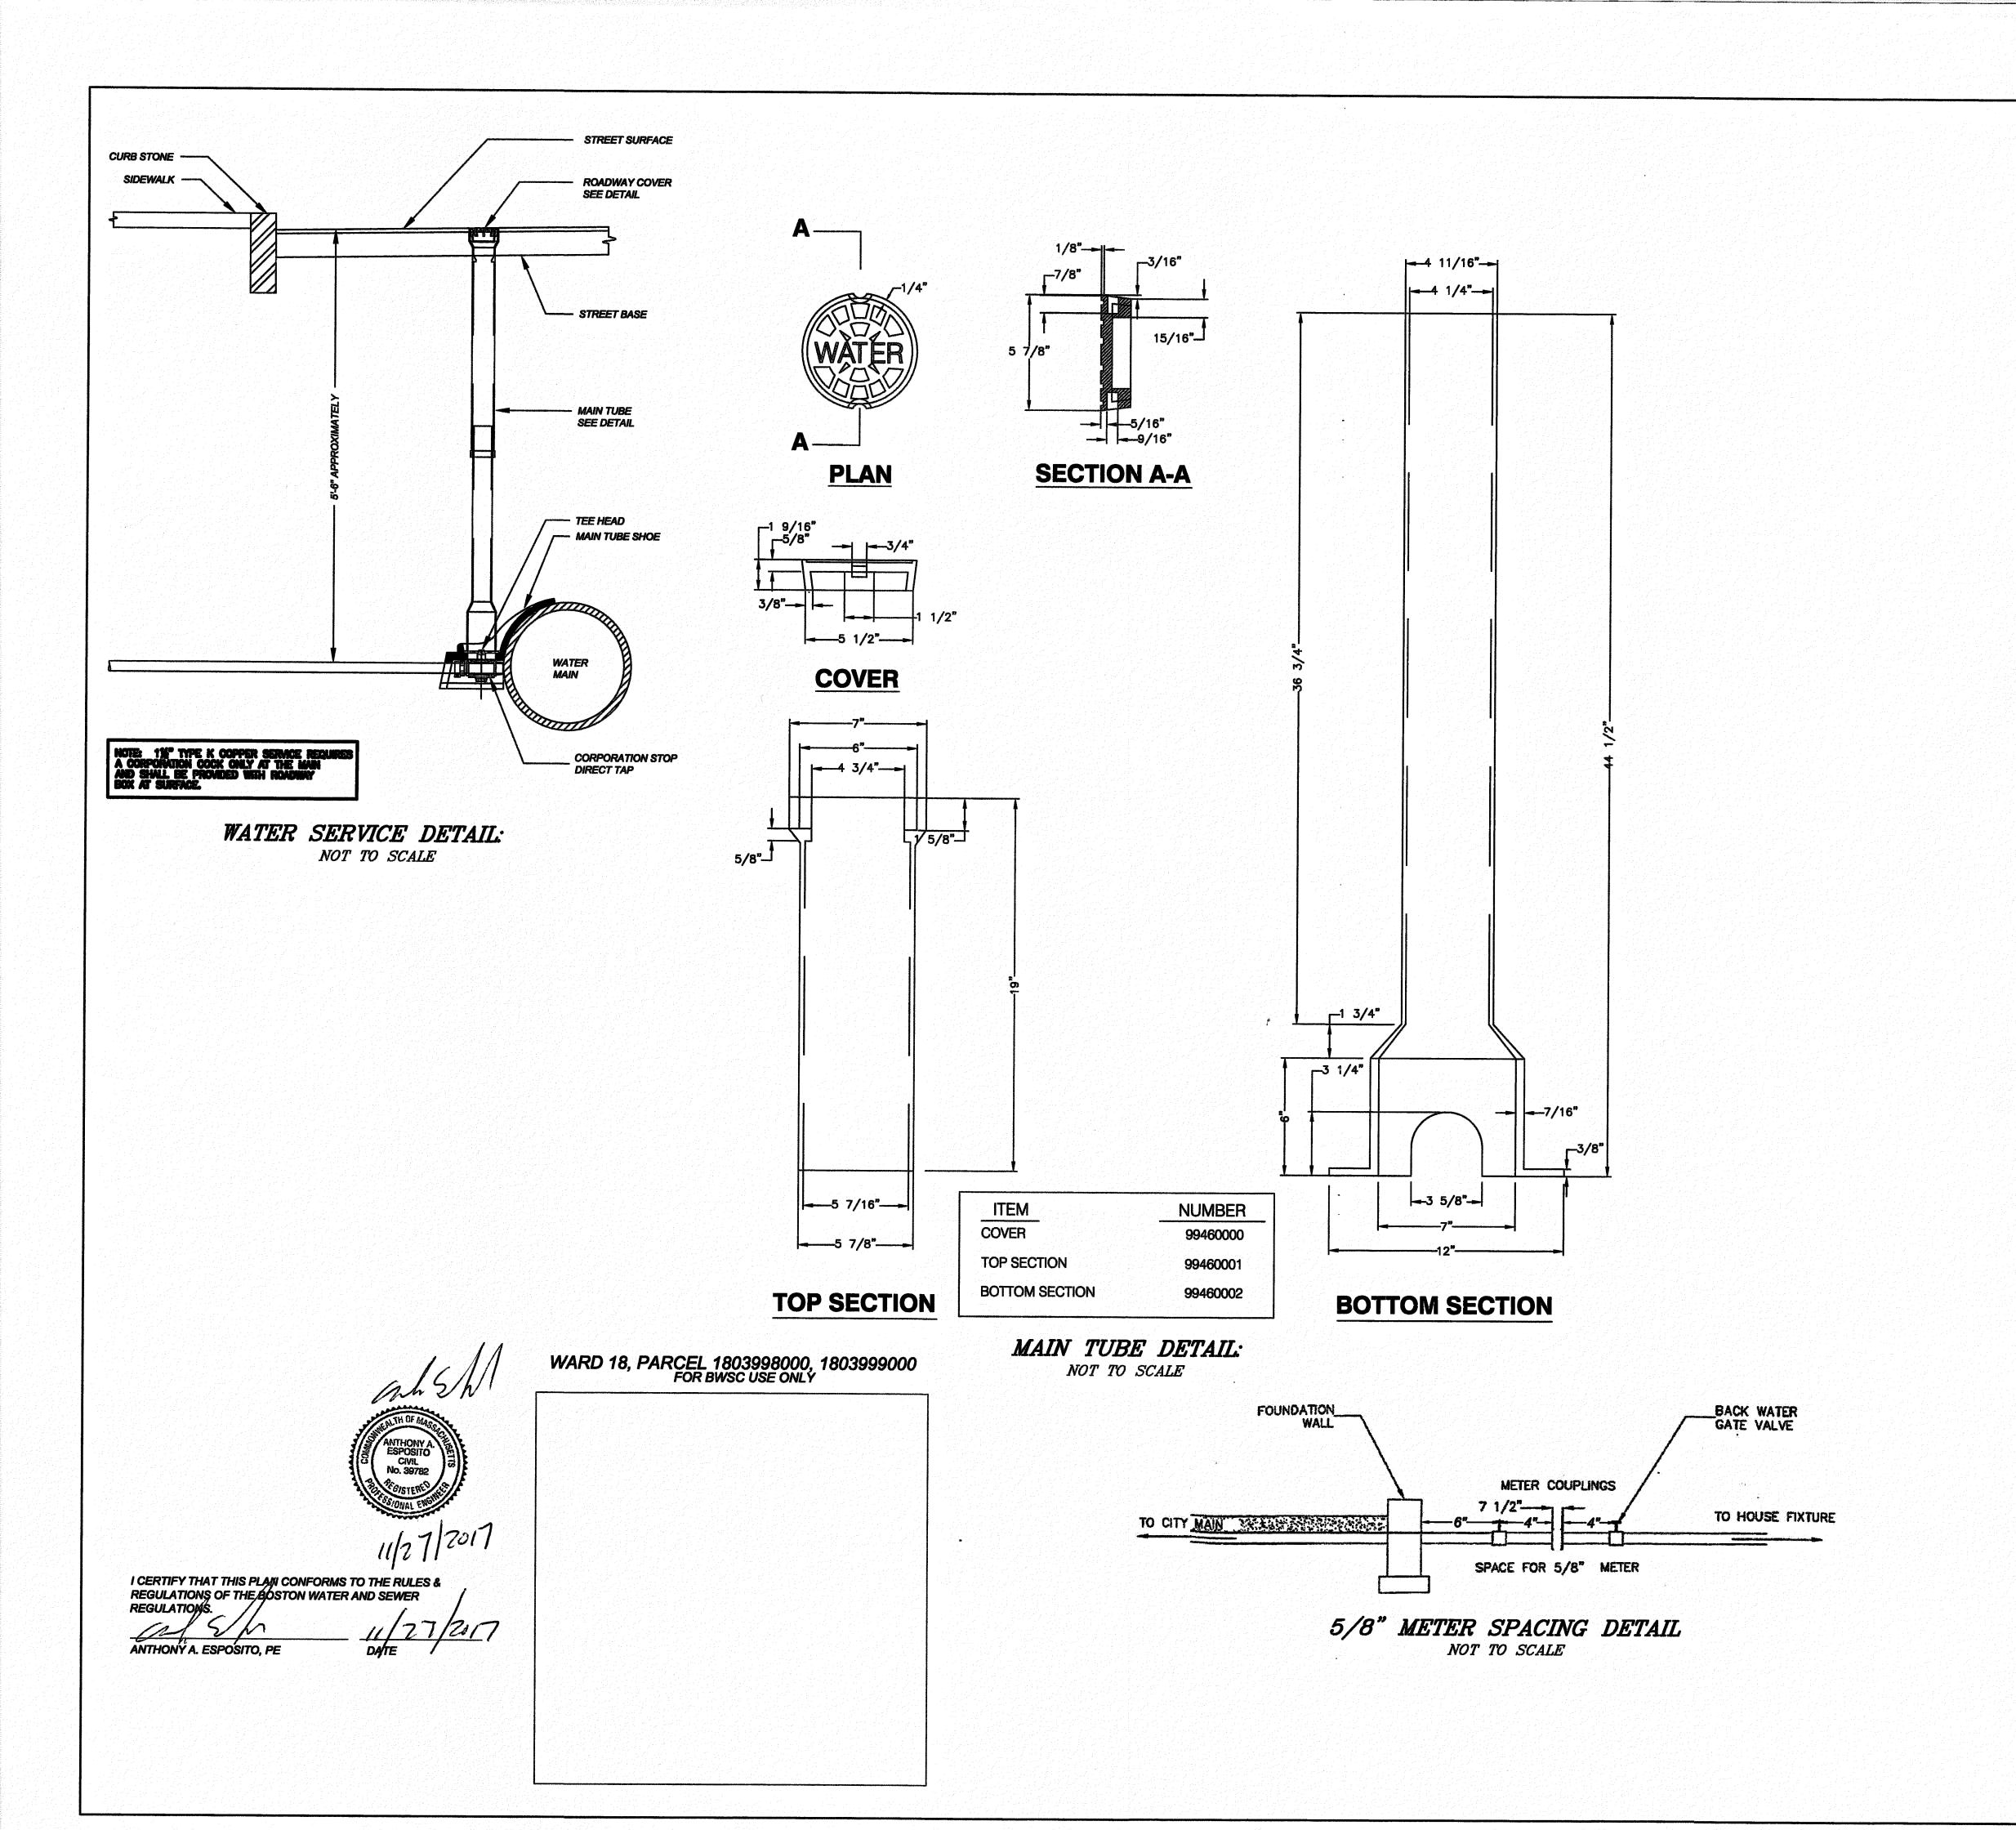

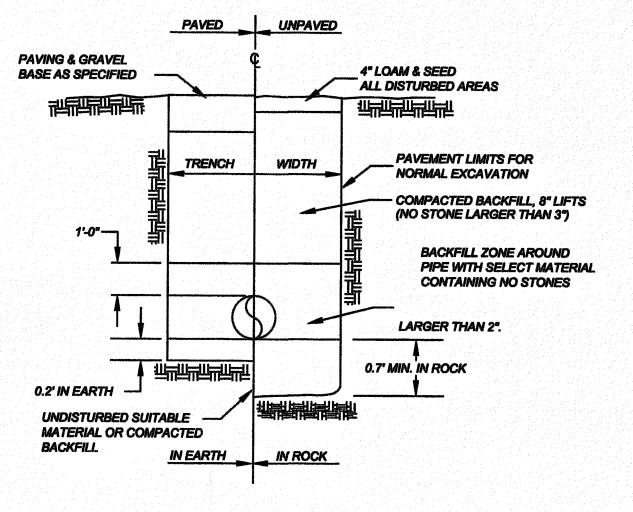

UTILITY TRENCH DETAIL:
NOT TO SCALE

Parcel ID: 1803998000, 1803999000 23 Ruskindale Rd., Hyde Park, Massachusetts


YOUTHBUILD BOSTON
27 CENTRE ST.
ROXBURY, MA 02119


TILE .


DETAILS

PREPARED BY:

Anthony A. Esposito Professional Engineer SOUTH MEADOW VILLAGE Unit 55-7 CARVER, MA 02330 508-369-4783 Itespo12@yahoo.com

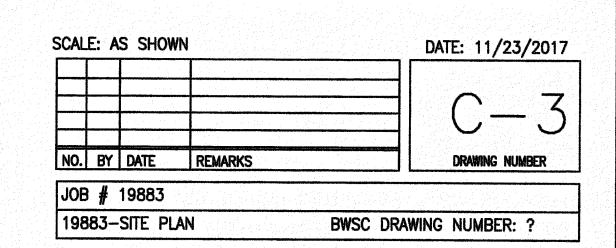

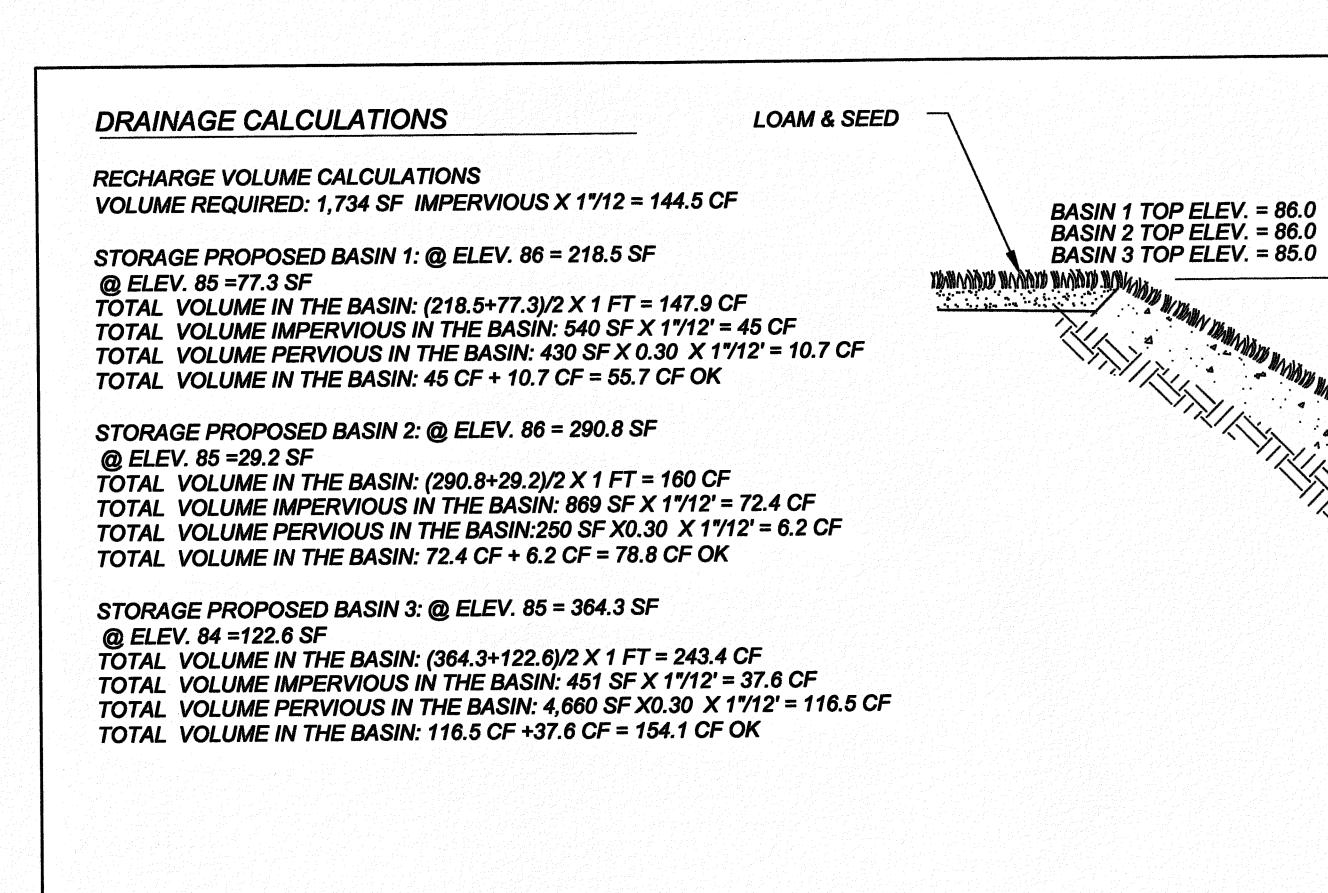

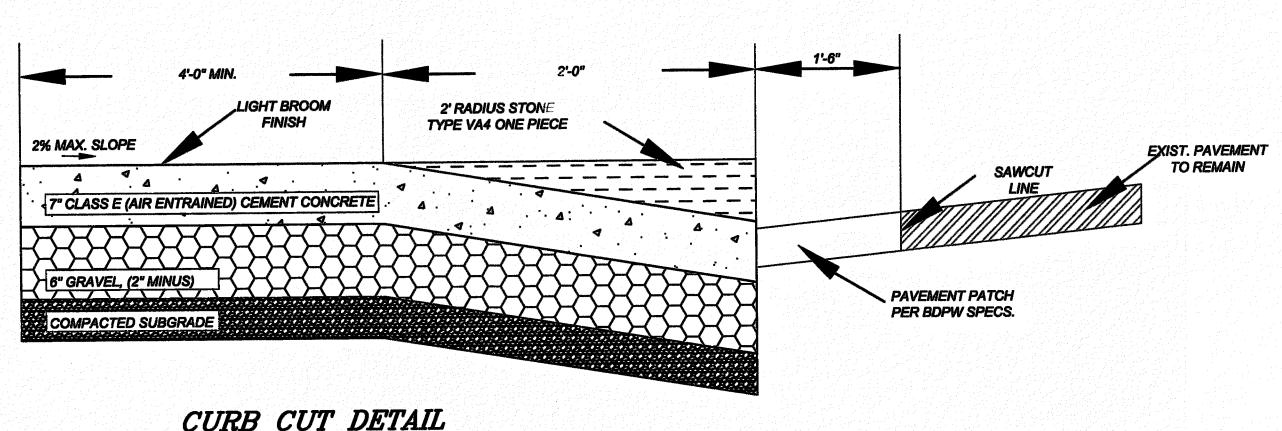

NOT TO SCALE

DESIGN & CONSTRUCTION NOTES

- 1. Locations of all utilities and underground structures are from survey and records of the City, utility companies and are considered approximate as to size and location and may be incomplete. Call Digsafe (1-888-DIG-SAFE) to obtain clearance before excavating in each area.

 2. Project Surveyor - J. K. Holmgren Engineering, Scott Faria 508-583-2595
- 3. Notify the MWRA for any work in the vicinity of utility lines within 30 feet and/or operated by the MWRA without written permission from the MWRA prior to work.
- 4. All work shall be performed in accordance with the City of Boston Water &Sewer Commission, Boston Department of Public Works, (DPW) and Boston Traffic and Parking, (BTP) Rules and Regulations.
- 5. Utilities: In the City of Boston, the contractor shall be licensed by the Boston Water & Sewer Commission, (BWSC) and obtain permit in writing for the project and make arrangements for inspections by the BWSC. All existing lines for inspection, opening, etc. shall be inspected by BWSC staff.
- All pipe materials, fittings, catch basins etc. shall be of BWSCs specifications and standards.


Water and sewer/drain shall have a minimum 10 foot separation or the sewer/drain should be below the water by 18 inches clear separation vertically between the pipes. All utility trenches shall be repaired with infra-red bonding process or as stated in the Road Opening Permit.

All sewer pipe shall be tested for leaks cleaned and flushed prior to use. Leak test shall be by water or by low pressure air.

Water service shall be Type K copper tubing. Water service shall be tested, pressurized, flushed and bacteria tested per the BWSC.

Backflow prevention and fire protection services, if needed, shall be designed by a licensed fire protection engineer.

While constructing one utility line, provide protection for all other utility lines and the contractor shall be responsible for any damage, repair and other liabilities.

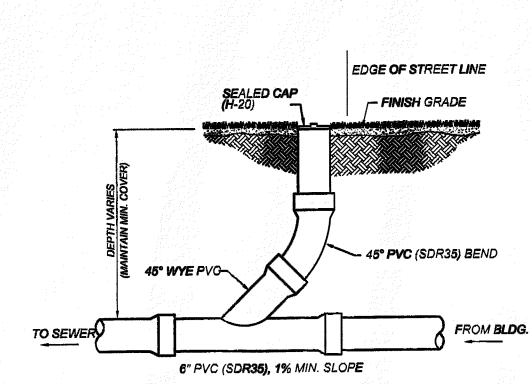

BASIN 1 BOT. ELEV. = 85.0 BASIN 2 BOT. ELEV. = 85.0

BASIN 3 BOT. ELEV. = 84.0

BASIN DETAIL

SEWER CLEANOUT DETAIL: NOT TO SCALE

EXISTING SEWER OR DRAIN PIPE SADDLE CONNECTOR DETAIL: NOT TO SCALE

LOAM & SEED

4" 50/50 LOAM AND SAND MIX

AND SUBSOIL ALONG THE BASIN BOTTOM

REMOVE ORIGINAL TOP

6. All trenches shall be backfilled in layers of 12 inches, well compacted and allowed to settle prior


to applying asphalt base course or as stated in the road opening permit. 7. Contractor shall assume the risk of dewatering and ledge blasting. Obtain all blasting permits if needed.

8. All disturbed areas shall be restored to their original condition.

9. Within 1 foot of utility mains dig by hand only.

- 10. Any and all piping work of the building and within the building must comply with the legal jurisdiction of the plumbing code requirements of local, state and federal rules and regulations. Pipes shown shall comply with the minimum pipe size and pipe material needed per the current Plumbing Code for the type of construction. Plumbing work shall be by a currently licensed plumber registered in Massachusetts. The Code shall supercede the proposed pipe size and material if needed.
- 11. Take adequate safety at the work at all times, follow the latest OSHA regulations, take proper traffic safety procedures, order police details where needed and designate a person as a safety inspector.

12. A prerequisite for filing a General Service Application with the BWSC for new construction is a Rough Construction Sign-Off document from the City of Boston's Inspectional Service Department

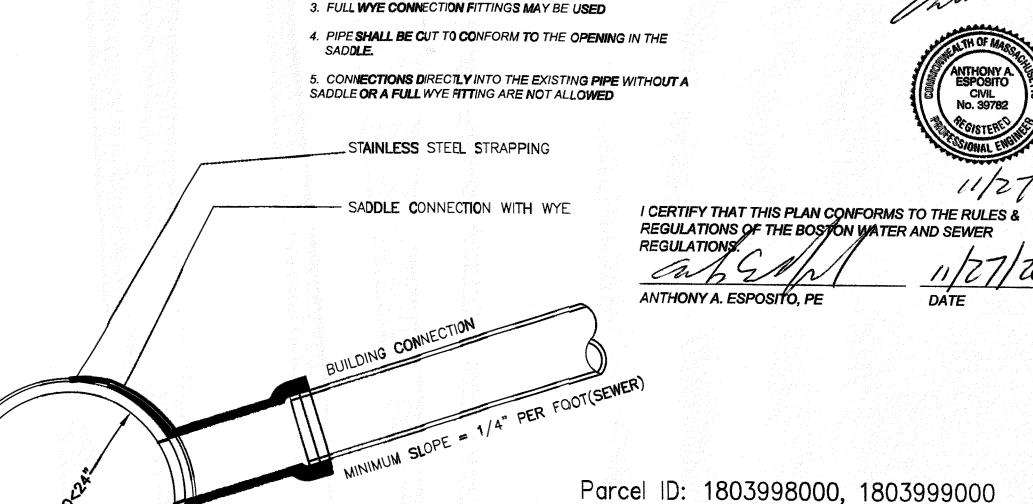

1. FULL PVC OR IRON SADDLE MAY BE USED TO

CONN**ECT TO EXISTI**NG P**VC,** CLAY, **CON**CRETE, **OR IR**ON P

DETAILS

PREPARED BY:

Anthony A. Esposito Professional Engineer SOUTH MEADOW VILLAGE Unit 55-7 CARVER, MA 02330 508-369-4783 ltespo12@yahoo.com

23 Ruskindale Rd., Hyde Park, Massachusetts

YOUTHBUILD BOSTON

ROXBURY, MA 02119

27 CENTRE ST.

WARD 18, PARCEL 1803998000, 1803999000 FOR BWSC USE ONLY

SCALE: AS SHOWN DATE: 11/23/2017 NO. BY DATE REMARKS DRAWING NUMBER JOB # 19883 19883-SITE PLAN **BWSC DRAWING NUMBER: ?**

