BUILDING **CODE ANALYSIS**

R-3 RESIDENTIAL PER SECTION 310.5 OF THE IBC 2015
OCCUPANT LOAD
FIRST FLOOR:
2,200 S.F. / 200 S.F. PER OCCUPANT (RESIDENTIAL) = 11 OCCUPANTS
SECOND FLOOR:
2,001 S.F. / 200 S.F. PER OCCUPANT (RESIDENTIAL) = 10 OCCUPANTS
TOTAL OCCUPANCY: BUILDING = 21 OCCUPANCY **BUILDING AREA** FIRST FLOOR:
SECOND FLOOR:
TOTAL AREA: 2,200 GROSS SQ. FT. [±] 2,001 GROSS SQ. FT. [±] 4,201 GROSS SQ.FT. [±]

APPLICABLE CODES

CMR 780 MASSACHUSETTS STATE BUILDING CODE, NINTH EDITION MASSACHUSETTS ENERGY STRETCH CODE

INTERNATIONAL BUILDING CODE 2015 (IBC 2015)

INTERNATIONAL RESIDENTIAL CODE 2015 (IRC 2015)

INTERNATIONAL ENERGY CONSERVATION CODE 2015 (IECC 2015)

NA

FIRE RATED CONSTRUCTION

EXTERIOR WALLS ARE GREATER THAN 5' FROM THE PROPERTY LINE. THE EXTERIOR WALLS DO NOT REQUIRE A FIRE RATING BASED ON THE MINIMUM FIRE SEPARATION DISTANCE PER TABLE R302.1 (1) OF IRC 2015.

EXTERIOR WALLS OF TYPE 5B CONSTRUCTION DO NOT REQUIRE A FIRE RATING PER IBC 2015 TABLE 601.

FIRE EXTINGUISHERS
FIRE EXTINGUISHERS ARE NOT REQUIRED FOR R3 OCCUPANCIES PER 906.1 OF THE IBC 2015; HOWEVER, RCA RECOMMENDS FOLLOWING THE REQUIREMENTS FOR R2 OCCUPANCIES, WHICH DOES REQUIRE FIRE EXTINGUISHERS. FOR TYPE R2 OCCUPANCIES TYPE 2-A FIRE EXTINGUISHERS ARE REQUIRED AND THE MAXIMUM TRAVEL DISTANCE TO AN EXTINGUISHER SHALL NOT EXCEED 75 FEET PER TABLE 906.3.(1) OF THE IBC 2015.

ENERGY CONSERVATION
INTERNATIONAL ENERGY CONSERVATION CODE. IECC
2015 ENERGY STRETCH CODE CMR 780:
RESIDENTIAL ENERGY EFFICIENCY PER IECC. RESIDENTIAL PROVISIONS, PARAGRAPH R202.
CEILING/ROOF: R=38 MINIMUM

CAVITY R=20 MINIMUM (SHOWN IN DETAILS PROVIDED)
OR
R= 13 MINIMUM WITH R=5 MINIMUM CONTINUOUS INSULATION.

R=15 CONTINUOUS MINIMUM ON INTERIOR OF CONCRETE OR R-19 CAVITY.

BASEMENT WALLS:

MASSACHUSETTS ENERGY STRETCH CODE-CHAPTER 4 - RESIDENTIAL ENERGY EFFICIENCY 401.2 "DEMONSTRATE COMPLIANCE WITH ENERGY STAR QUALIFIED HOMES THERMAL BYPASS INSPECTION CHECKLIST." UNHEATED SLAB FLOORS: R=10 MINIMUM FOR 24" BELOW.

10.

CONSTRUCTION TYPE
5B PER TABLE 601 OF THE IBC 2015
MAXIMUM AREA PER FLOOR: 7,000 S.F. PER TABLE 506.2 OF THE IBC 2015
MAXIMUM NUMBER OF STORIES ABOVE GRADE PLANE PER TABLE 504.4
OF THE IBC 2015

MINIMUM WIDTH FOR EGRESS STAIRS PER 1011.2.1: 36 INCHES WITH MAXIMUM LENGTH OF EXIT TRAVEL PER TABLE 1017.2: 250 FEET REQUIRED DOOR EGRESS WIDTH PER 1005.3.2: $6 \times .2 = 1.2$ " 34" PROVIDED.

SPRINKLER
BUILDING IS NOT EQUIPPED WITH AN AUTOMATIC SPRINKLER SYSTEM

GENERAL NOTES

THE CONTRACTOR IS RESPONSIBLE FOR OBTAINING AND POSTING ALL I FEDERAL AUTHORITIES HAVING JURISDICTION PRIOR TO THE START OF

THIS PROJECT IS DESIGNED UPON THE BASIS OF THE MASSACHUSETTS STATE BUILDING CODE, LATEST EDITION AND CURRENT REGULATIONS AS WELL AS LOCAL, STATE AND FEDERAL REGULATIONS REGARDING HEALTH AND SAFETY IN THE WORKPLACE.

THE CONTRACTOR IS SOLELY RESPONSIBLE FOR ALL CONSTRUCTION ACTIVITIES, MATERIALS, MEANS AND METHODS. THE CONTRACTOR IS TO COORDINATE ALL SEPARATE SUBCONTRACTORS TO COMPLETE THE FULL SCOPE OF WORK AS INDICATED IN THE CONSTRUCTION DOCUMENTS.

NECESSARY VALID CONSTRUCTION/DEMOLITION PERMITS FROM ON-SITE CONSTRUCTION.

THE CONTRACTOR SHALL KEEP ALL BUILDING MEANS OF EGRESS CLEAR OF ANY OBSTRUCTIONS AT ALL TIMES.

6 THE CONTRACTOR SHALL NOT OBSTRUCT TRAFFIC OUTSIDE OF THE AUTHORIZED CONSTRUCTION SITE OR ANY ADJACENT RIGHT OF WAY DURING CONSTRUCTION, UNLESS PRIOR APPROVAL IS OBTAINED FROM THE NECESSARY LOCAL GOVERNING AUTHORITIES. ALL CONSTRUCTION MATERIALS AND EQUIPMENT ARE TO BE STORED NEATLY WITHIN THE SCOPE OF WORK AREA ONLY.

œ

ALL DEBRIS IS TO BE PROPERLY REMOVED FROM THE WORK AREAS, LEAVING THE WORK AREAS BROOM CLEAN. ALL DEBRIS IS TO BE STORED ON SITE IN REFUSE DUMPSTER, REMOVED PERIODICALLY, AND DISPOSED OF IN ACCORDANCE WITH ALL LOCAL, STATE AND FEDERAL GUIDELINES AND LAWS. ACCESS TO THE WORK AREA IS TO BE RESTRICTED BY THE CONTRACTO TO BE LEFT OPEN OR UNLOCKED. THE CONTRACTOR IS RESPONSIBLE F BUILDING AS REQUIRED. OR. ENTRANCES ARE NOT TO BE LEFT UNATTENDED AT ANY TIME. DOORS/GATES ARE NOT FOR SECURING THE AREA AND EQUIPMENT WITHIN THE LIMIT OF WORK AND SITE OF THE

THE CONTRACTOR IS FULLY RESPONSIBLE FOR THE REMOVAL OF SNOW, RAINWATER, ICE CONSTRUCTION ACTIVITY ON THE PROJECT. THE CONTRACTOR IS TO PROVIDE ALL NECESSARY TEMPORARY WEATHER PROTECTION FOR THE BUILDING DURING THE FULL SCOPE OF CONSTRUCTION ACTIVITY ON THE PROJECT.

ALL INTERIOR/EXTERIOR FINISHES, COLORS, TILES, FIXTURES, ETC.

PLUMBING/MECHANICAL/ELECTRICAL/HVAC INTERIOR WORK SHALL BE SEPARATELY PERMITTED

<u>12</u>

LIST OF DRAWINGS

TITLE SHEET AND BUILDING CODE ANALYSIS BUILDING CODE ANALYSIS

LANDSCAPE PLAN

SLAB PLAN
FIRST FLOOR PLAN
SECOND FLOOR PLAN
ROOF PLAN
WALL SECTION AND BUILDING SECTIONS / ENLARGED STAIR PLAN AND DETAIL
ELEVATIONS
ELEVATIONS
ENLARGED BATHROOM AND KITCHEN PLANS
FLOOR AND WALL ASSEMBLES / WINDOW, DOOR AND ROOM FINISH SCHEDULES

GENERAL NOTE:

TITLE SHEET AND **BUILDING CODE ANALYSIS**

SCALE: NONE CHECKED BY: DRAWN BY:

PROJECT # 20-021

DATE: 8-24-20

Norfolk Design & Construction 23-25 Rosebery Road Mattapan, MA 02126

RCA, LLC 415 Neponset Ave. www.roche-christopher.com

Telephone: 617-282-0030 Fax: 617-282-1080 Dorchester, Massachusetts 02122

DESCRIPTION

ACOUSTICAL REQUIREMENTS HVAC SYSTEM SOUND NOISE CONTROL IN CEILING ASSEMBLIES WITH MULTIPLE LAYERS OF GYPSUM BOARD, THE RESILIENT CHANNELS SHOULD ALWAYS BE INSTALLED BETWEEN THE BOTTOM CHORD OF THE TRUSS AND THE GYPSUM BOARD.
 RESILIENT CHANNELS USED IN WALL ASSEMBLIES SHOULD BE INSTALLED WITH THE PERFORATION ON THE TOP.
 UTILIZE SURFACE MOUNTED LIGHT FIXTURES TO THE EXTENT POSSIBLE TO MINIMIZE FLANKING TRANSMISSION.
 FLOOR DEFLECTION SHALL BE LIMITED TO L/540 TO ACHIEVE BETTER AND MORE EFFECTIVE IMPACT NOISE CONTROL.
 IN ACOUSTICAL UNDERLAYMENT AND GYPSUM FLOOR TOPPING FLOOR SYSTEMS, VERIFY THAT ALL SEAMS IN THE ACOUSTICAL UNDERLAYMENT ARE THOROUGHLY TAPED SO THERE IS NO POSSIBILITY OF GYPSUM CONCRETE TOPPING DRIPPING THROUGH TO THE SUB-FLOOR. USE TAPE RECOMMENDED BY GYPSUM CONCRETE FLOOR TOPPING MANUFACTURER.
 LEAVE [§]/₈ GAP AND USE ACOUSTICAL CAULK TO PREVENT DIRECT CONNECTIONS WHERE FINISHED FLOOR FLOOR SOUGH AS WOOD, LAMINATED WOOD, VINYL, CERAMIC TILE, ETC. MEET CABINETS, WALL PARTITIONS AND BUILT-IN FURNITURE. USE PERIMETER WALL STRIPS TO ISOLATE FINISHED FLOOR FLOOR FROME THE CEILING GYPSUM BOARD TO THE PERIMETER WALL PARTITION. PREVENT THE CEILING GYPSUM BOARD TO THE PERIMETER WALL PARTITION. PREVENT THE CEILING GYPSUM BOARD TO THE WALL PARTITION. PREVENT THE CEILING GYPSUM BOARD TO THE WALL PARTITION. PREVENT THE CEILING GYPSUM BOARD TO THE WALL PARTITION.
 PORTON FRAMING. FILL THE GAP BETWEEN THE CEILING GYPSUM BOARD AND THE WALL PARTITION. NOISE CONTROL OF TYPICAL FLOOR-CEILING ASSEMBLIES SOUND ISOLATION PER SECTION 1207 OF THE IBC 2015 PLUMBING SYSTEM NOISE CONTROL NAILERS USED IN THE WOOD FRAME FLOOR-CEILING ASSEMBLY SHALL NOT TOUCH THE UNDERSIDE OF THE SUB-FLOOR OR THE RESILIENT CHANNELS.
EXTEND THE DEMISING WALL TO THE OUTER LAYER OF THE EXTERIOR WALL. AVOID ANY GAPS BY PLACING THE STUDS CLOSE TO THE DEMISING WALL.
ALL LAYERS OF THE DEMISING AND CORRIDOR WALL PARTITIONS SHALL BE COMPLETELY SEALED WITH ACOUSTICAL SEALANT AND TAPED ALONG THE PERIMETERS TO REDUCE SOUND LEAKS.
DO NOT CONNECT TOILETS TO THE UNIT-SEPARATION WALLS. PROVIDE FLOOR-MOUNTED TOILETS AT THE UNIT-SEPARATION WALL PARTITIONS.
ELECTRICAL BOXES FOR POWER, TV, PHONE, ETC. IN DEMISING WALLS SHOULD BE SEPARATED BY MINIMUM 24" OR ONE STUD SPACE.
SEAL ALL THE ELECTRICAL BOXES INSTALLED IN UNIT SEPARATION AND UNIT-CORRIDOR PARTITIONS WITH OUTLET PUTTY PADS.
ALL ENTRY DOORS TO ALL THE DWELLING UNITS SHALL BE PROVIDED WITH ACOUSTICAL GASKETS ALONG THE JAMB.
CONDENSING UNITS SHALL BE LOCATED OVER THE CORRIDORS TO THE MAXIMUM EXTENT POSSIBLE INSTALL SUPPLY AIR DUCTS IN THE CENTER OF THE TRUSSES AND SUPPORT THEM WITH STRAPS TO AVOID CONTACT WITH THE CEILING OR WALL FRAMING.

PROVIDE A 1 CLEARANCE AROUND THE HVAC AND TOILET EXHAUST DUCTS WITHIN DWELLING UNITS.

SEAL AND TAPE ALL DUCTS AND PIPE PENETRATIONS THRU WALL PARTITIONS WITH ACOUSTICAL CAULK. AVOID UNNECESSARY PENETRATIONS IN THE DEMISING PARTITIONS.

BATHROOM EXHAUST FANS SHALL MEET LOW NOISE LEVEL (≤3.0 SONES) REQUIREMENTS. SUPPLY WATER PIPING SHALL BE ISOLATED HORIZONTALLY AND VERTICALLY BY GROMMETS AT ALL STUDS, PLATES AND FRAMING MEMBERS.

WATER HAMMER ARRESTORS SHALL BE PROVIDED AT THE WASHING MACHINE CONNECTION.

COMPLETELY SEAL ALL PIPE PENETRATIONS OF WALLS AND FLOOR-CEILING ASSEMBLIES

SEPARATING DWELLING UNITS AND BETWEEN DWELLING UNITS AND COMMON AREAS, INCLUDING

THE TOILET PIPE PENETRATION OF THE FLOOR. PROVIDE A SLEEVE AROUND THE PIPES

PENETRATING THE FLOOR OR WALL AND COMPLETELY FILL THE GAP WITH ROCK WOOL AND FIRE ALL DRAIN PIPING SHALL BE WRAPPED WITH FIBERGLASS INSULATION.
PIPING SHALL NOT COME IN DIRECT CONTACT WITH ANY PARTITION, WALL, CEILING OR STRUCTURAL ELEMENT SUCH AS FLOOR TRUSSES.
ALL SUPPLY PIPING SHALL BE ISOLATED FROM THE BUILDING STRUCTURE WITH RESILIENT MATERIAL SUCH AS NEOPRENE FOAM PADS OR FIBERGLASS SLEEVES.
SUPPLY WATER PIPE RISERS SHALL BE ISOLATED WITH ³/₄" NEOPRENE PAD UNDER THE PIPE CLAMPS. THE NEOPRENE PADS SHALL BE SIZED TO 50Ibs/in² AND HAVE A ¹/₈" THICK METAL BEARING PLATE BETWEEN PAD AND PIPE CLAMP. PROVIDE A GROMMET AT ALL STUDS, PLATES, BLOCKS AND FRAMING MEMBERS. CONDUIT PIPE RISERS RUNNING THROUGH DWELLING UNITS SHALL BE ISOLATED FROM THE FLOOR. ALL PIPES, CABLES AND WIRES PENETRATING THE DEMISING WALL SHALL BE CAULKED. RAILINGS AND GUARDRAILS RAILING AND GUARDRAIL REQUIREMENTS D $\dot{\Omega}$ RAILING PROFILES: RAILING PROFILES SHALL MEET THE REQUIREMENTS OF THE AMERICAN WITH DISABILITIES ACT GUIDELINES FOR BUILDINGS. PREPARE SHOP DRAWINGS INDICATING THE RAILING ELEVATIONS, PROFILES, MOUNTING, AND ATTACHMENT TO STRUCTURE. ALL CONNECTIONS SHALL BE FORMED OR MITERED WITH ALL EDGES SMOOTH. HANDRAILS: UNIFORM LOAD OF 50 LBF/FT APPLIED IN ANY DIRECTION. CONCENTRATED LOAD OF 200 LBF APPLIED IN ANY DIRECTION. UNIFORM AND CONCENTRATED LOADS NEED NOT BE ASSUMED TO ACT CONCURRENTLY. CONTROL OF CORROSION: PREVENT GALVANIC ACTION AND OTHER FORMS OF CORROSION BY INSULATING METALS AND OTHER MATERIALS FROM DIRECT CONTACT WITH INCOMPATIBLE MATERIALS. TOP OF GUARDS: UNIFORM LOAD OF 50 LBF/FT APPLIED IN ANY DIRECTION. CONCENTRATED LOAD OF 200 LBF APPLIED IN ANY DIRECTION. UNIFORM AND CONCENTRATED LOADS NEED NOT BE ASSUMED TO ACT CONCURRENTLY. INFILL OF GUARDS: CONCENTRATED LOAD OF 50 LBF APPLIED HORIZONTALLY ON AN AREA OF 1 SF. UNIFORM LOAD OF 25 LBF/SQ. FT. APPLIED HORIZONTALLY. INFILL LOAD AND OTHER LOADS NEED NOT BE ASSUMED TO ACT CONCURRENTLY. PROVIDE RAILINGS CAPABLE OF WITHSTANDING THE EFFECTS OF GRAVITY LOADS AND THE FOLLOWING LOADS AND STRESSES WITHIN LIMITS AND UNDER CONDITIONS INDICATED: GENERAL NOTE:

VERIFY AND CONFIRM ALL CONDITIONS AND/OR DIMENSIONS SHOWN PRIOR TO COMMENCING CONSTRUCTION OR ORDERING MATERIALS. NOTIFY ARCHITECT OF ANY INCONSISTENCIES FOR REVIEW AND APPROVAL BEFORE PROCEEDING WITH CONSTRUCTION.

T2

BUILDING CODE ANALYSIS

PROJECT #
20-021

DATE: 8-24-20
REV:

SCALE:
NONE

DRAWN BY:
CD

CHECKED BY:
R.P.B.


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Dorchester, Massachusetts 02122

Telephone: 617-282-0030 Fax: 617-282-1080



40'-0" 38'-4" SLAB ON GRADE AT FIRST FLOOR 38'-4" SLAB ON GRADE 60'-0" 38'-4" SLAB ON GRADE AT FIRST FLOOR **+** 38'-4" 40'-0"

GENERAL NOTE:

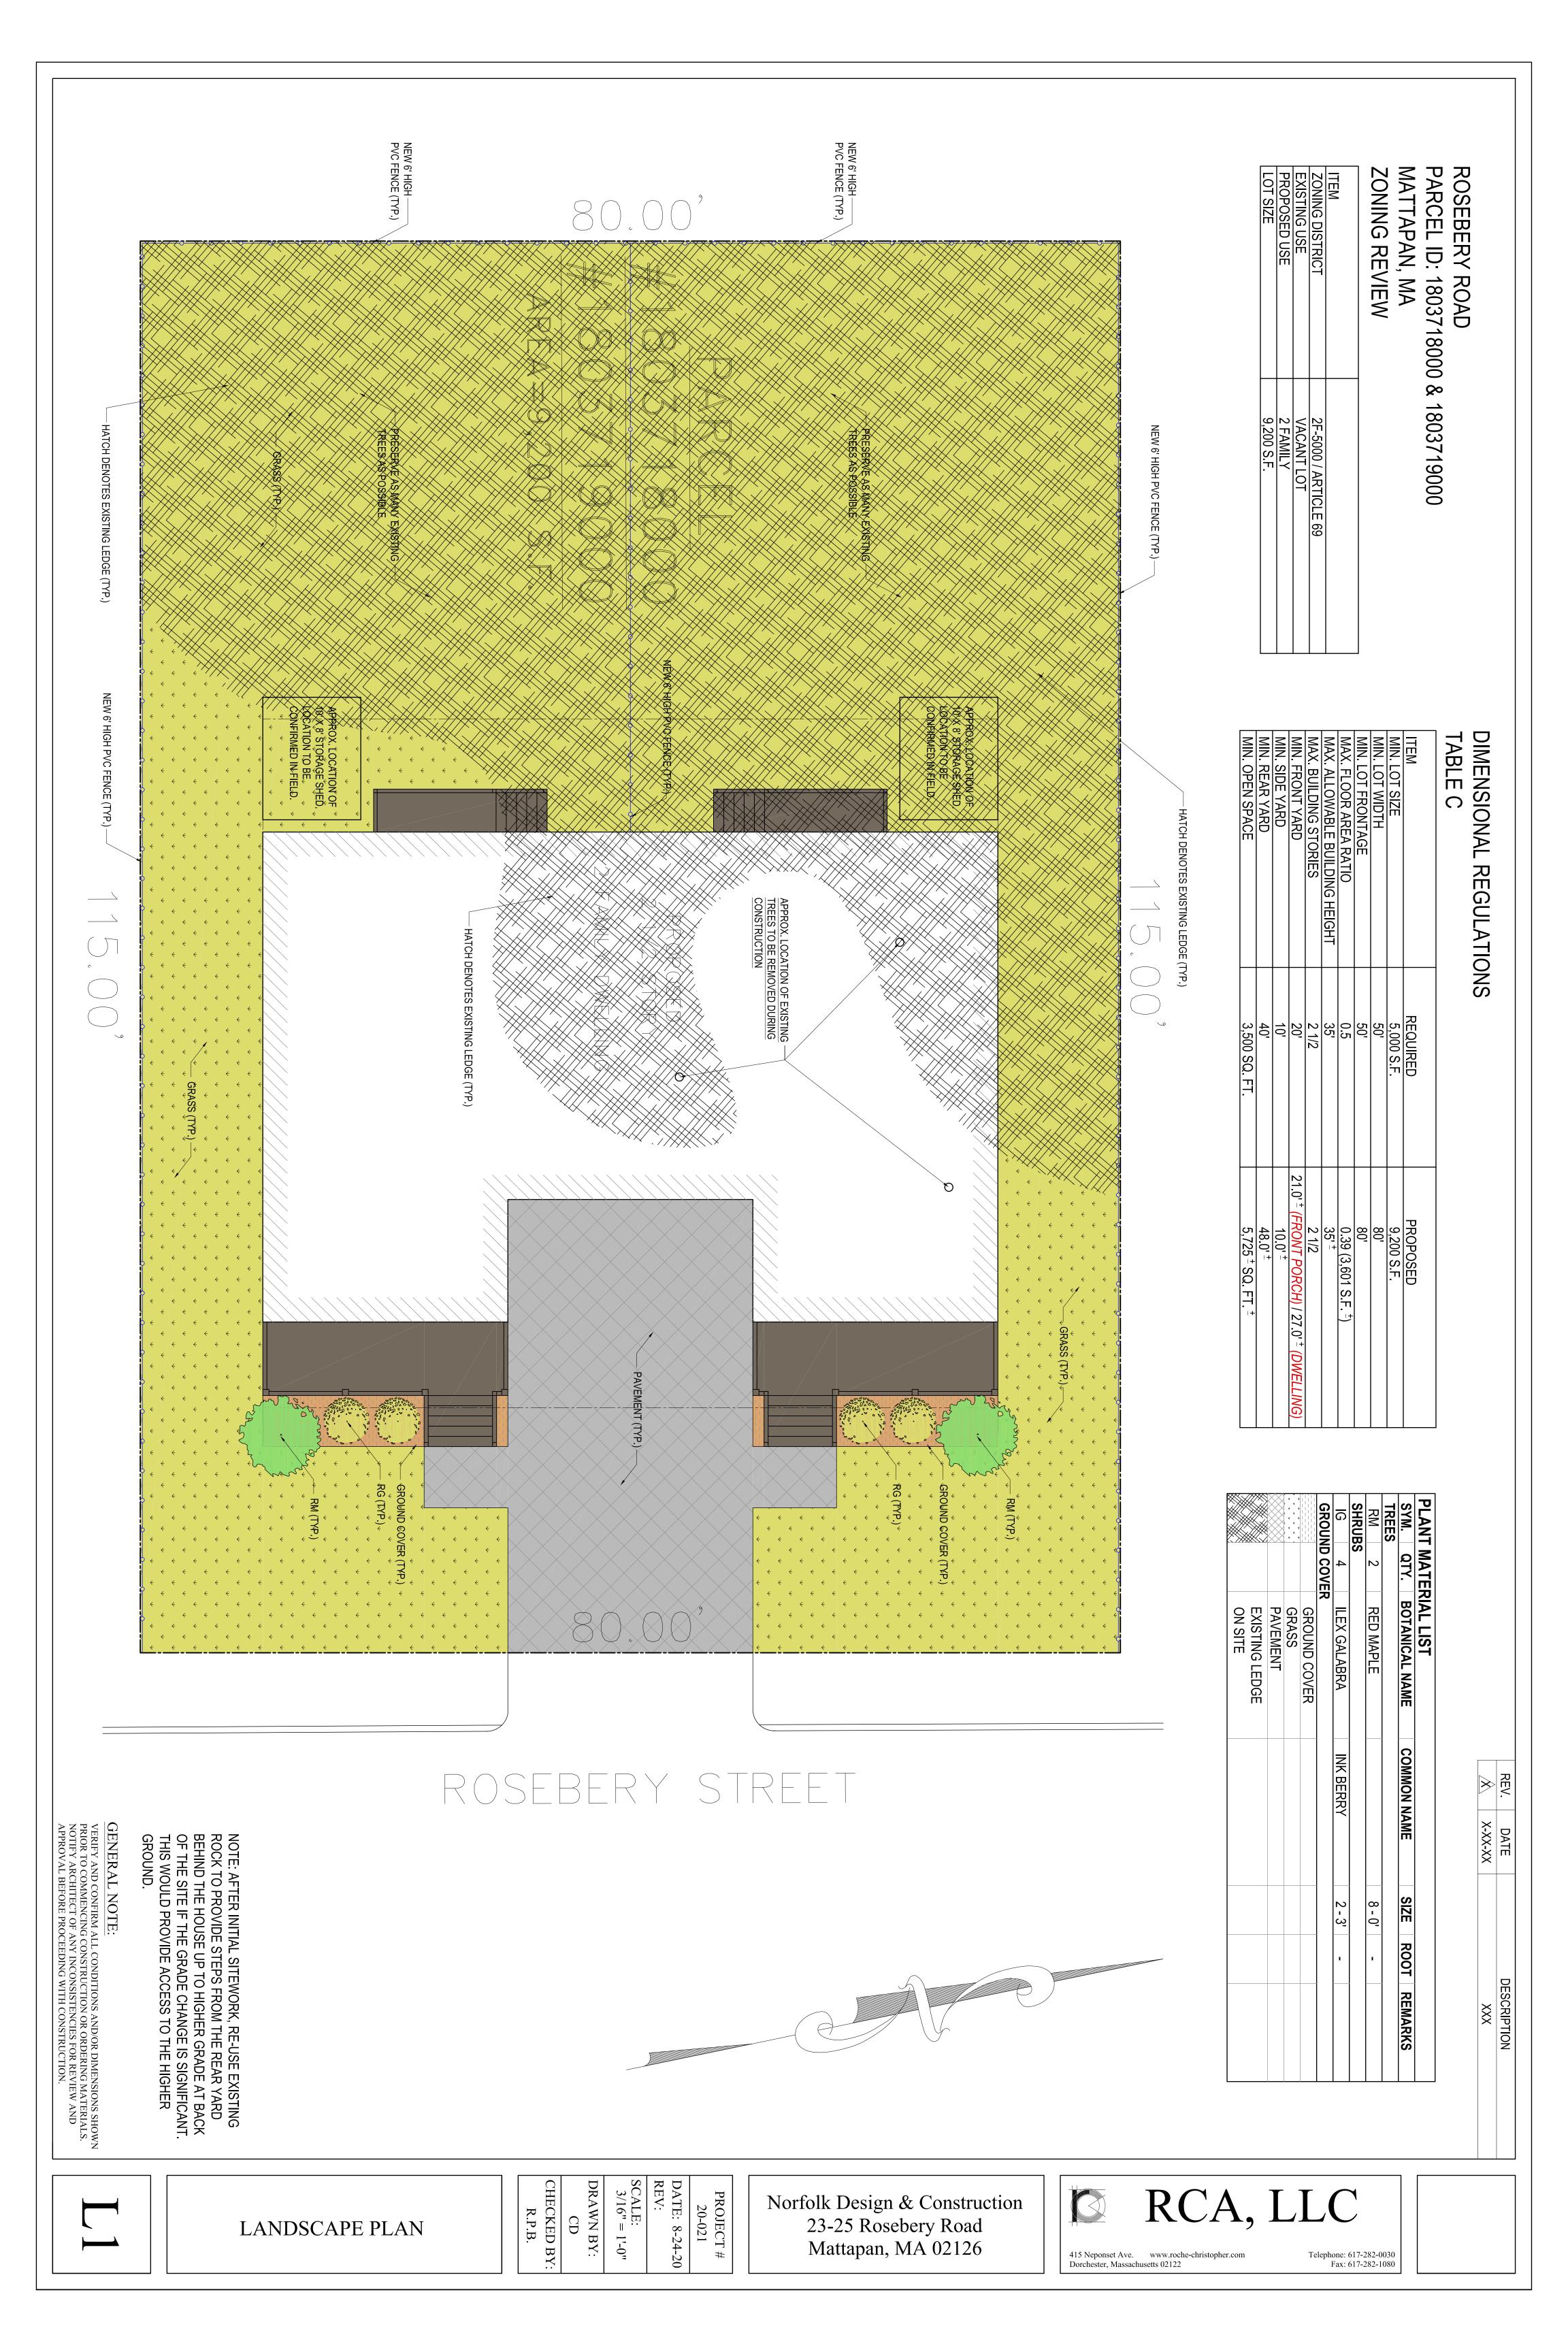1 0 1

VERIFY AND CONFIRM ALL CONDITIONS AND/OR DIMENSIONS SHOWN PRIOR TO COMMENCING CONSTRUCTION OR ORDERING MATERIALS.

NOTIFY ARCHITECT OF ANY INCONSISTENCIES FOR REVIEW AND APPROVAL BEFORE PROCEEDING WITH CONSTRUCTION. \Box HARDWIRED & INTERCONNECTED CARBON MONOXIDE DETECTOR HARDWIRED & INTERCONNECTED HEAT DETECTOR

LEGEND

SLAB PLAN

HARDWIRED & INTERCONNECTED SMOKE DETECTOR

SLAB PLAN


DATE: 8-24-20 REV: CHECKED BY: R.P.B. DRAWN BY: SCALE: 1/4" = 1'-0" PROJECT # 20-021

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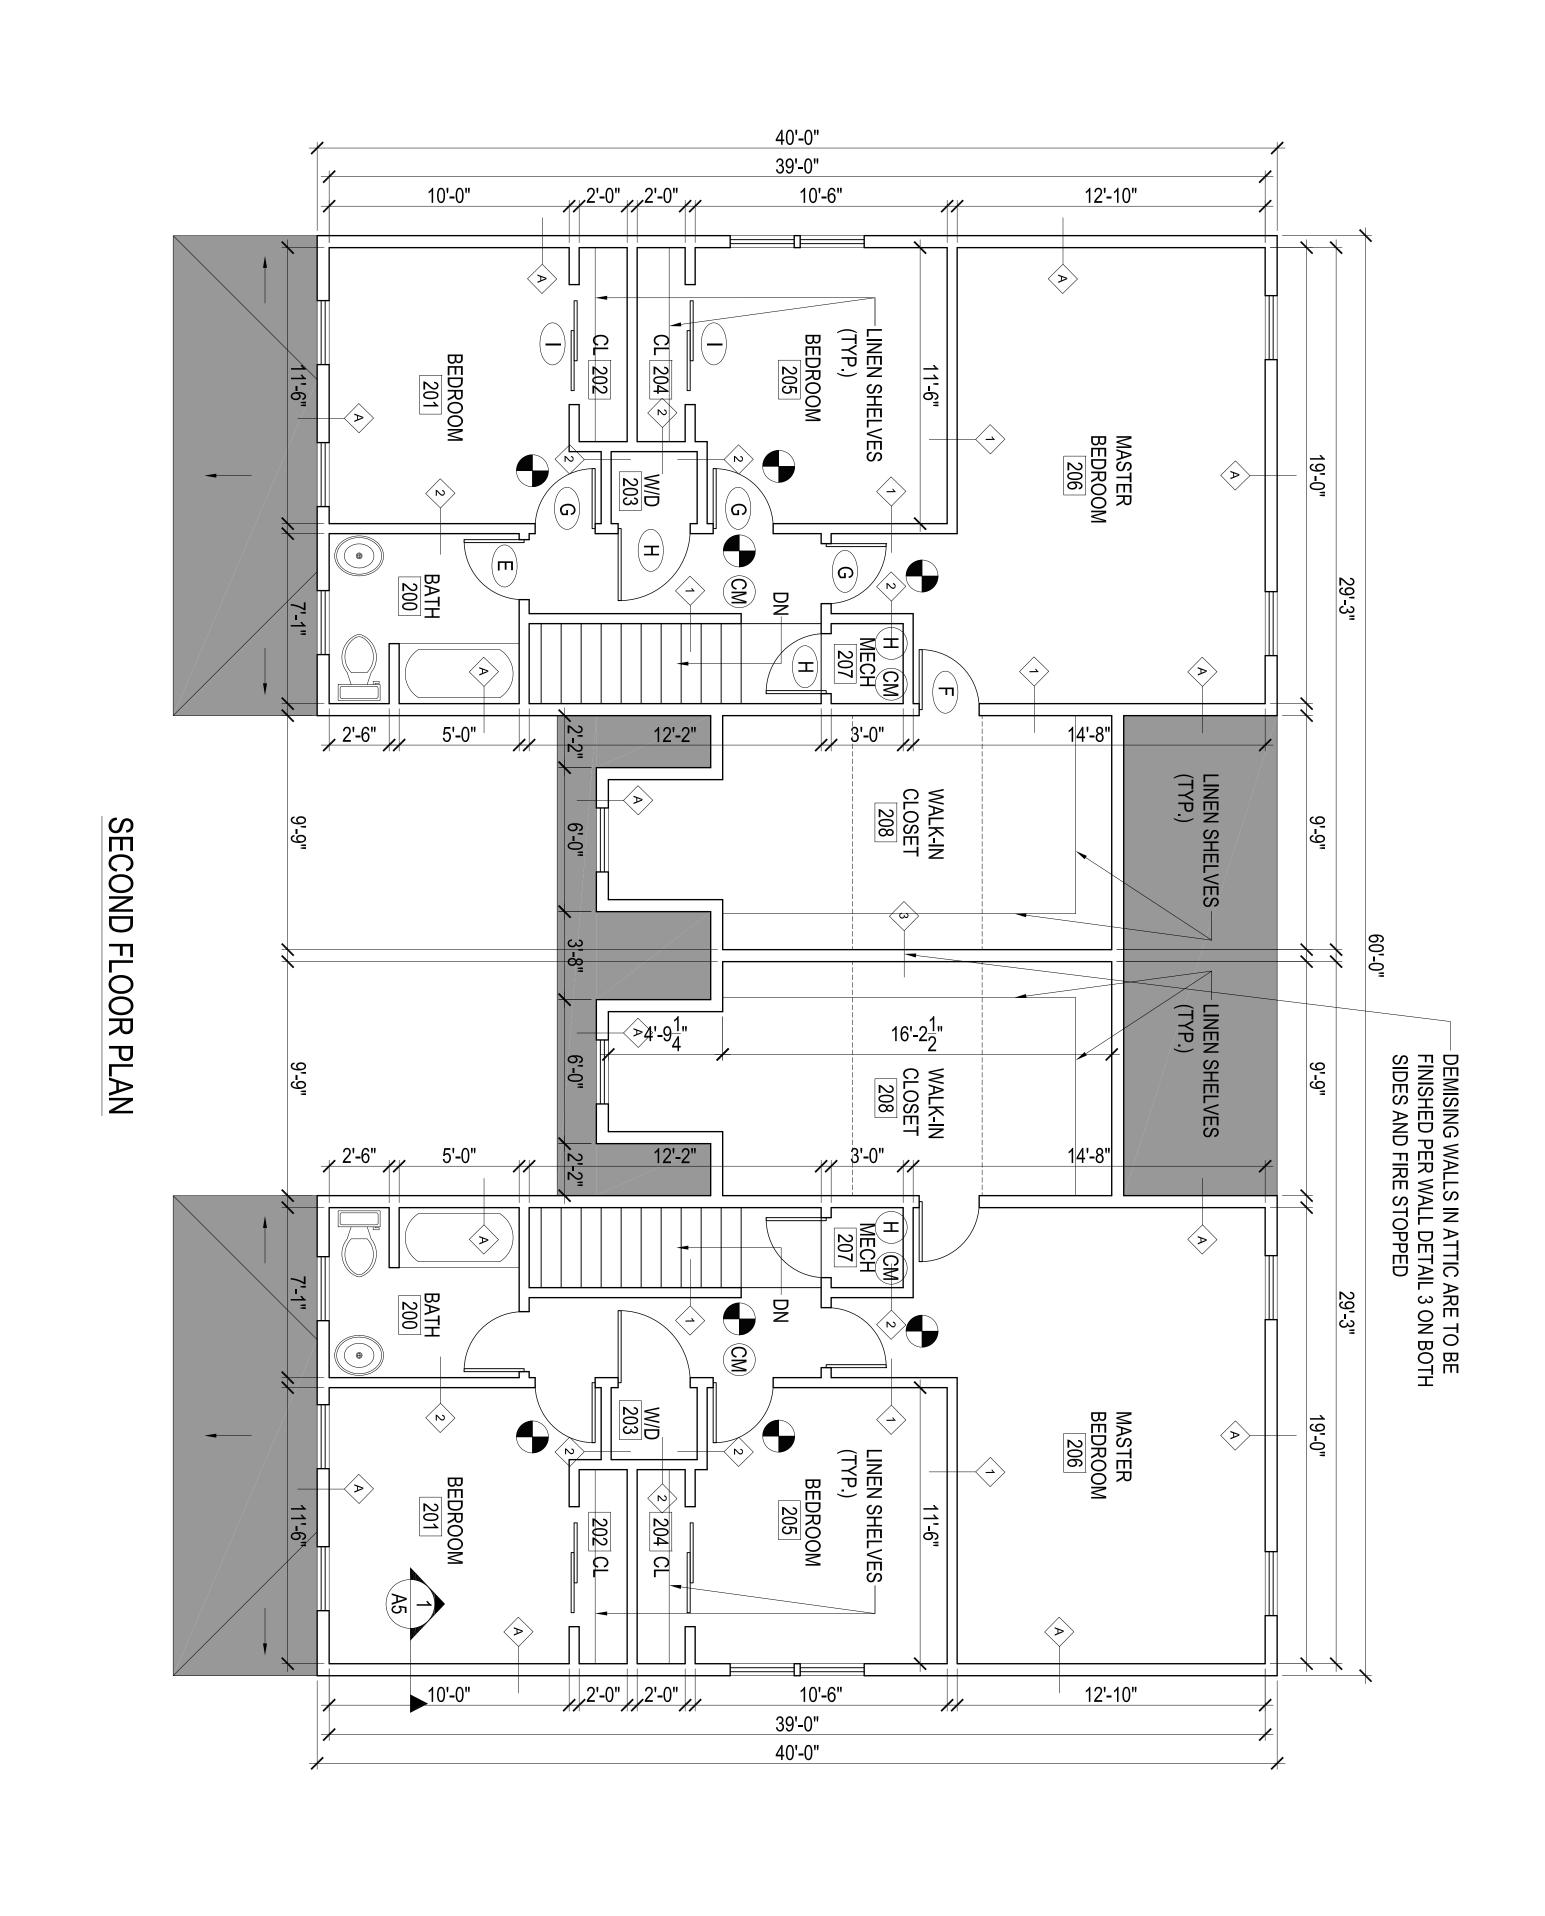
LEGEND

FIRST FLOOR PLAN

CHECKED BY: R.P.B. DATE: 8-24-20 REV: SCALE: 1/4" = 1'-0" DRAWN BY: PROJECT # 20-021

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LEGEND

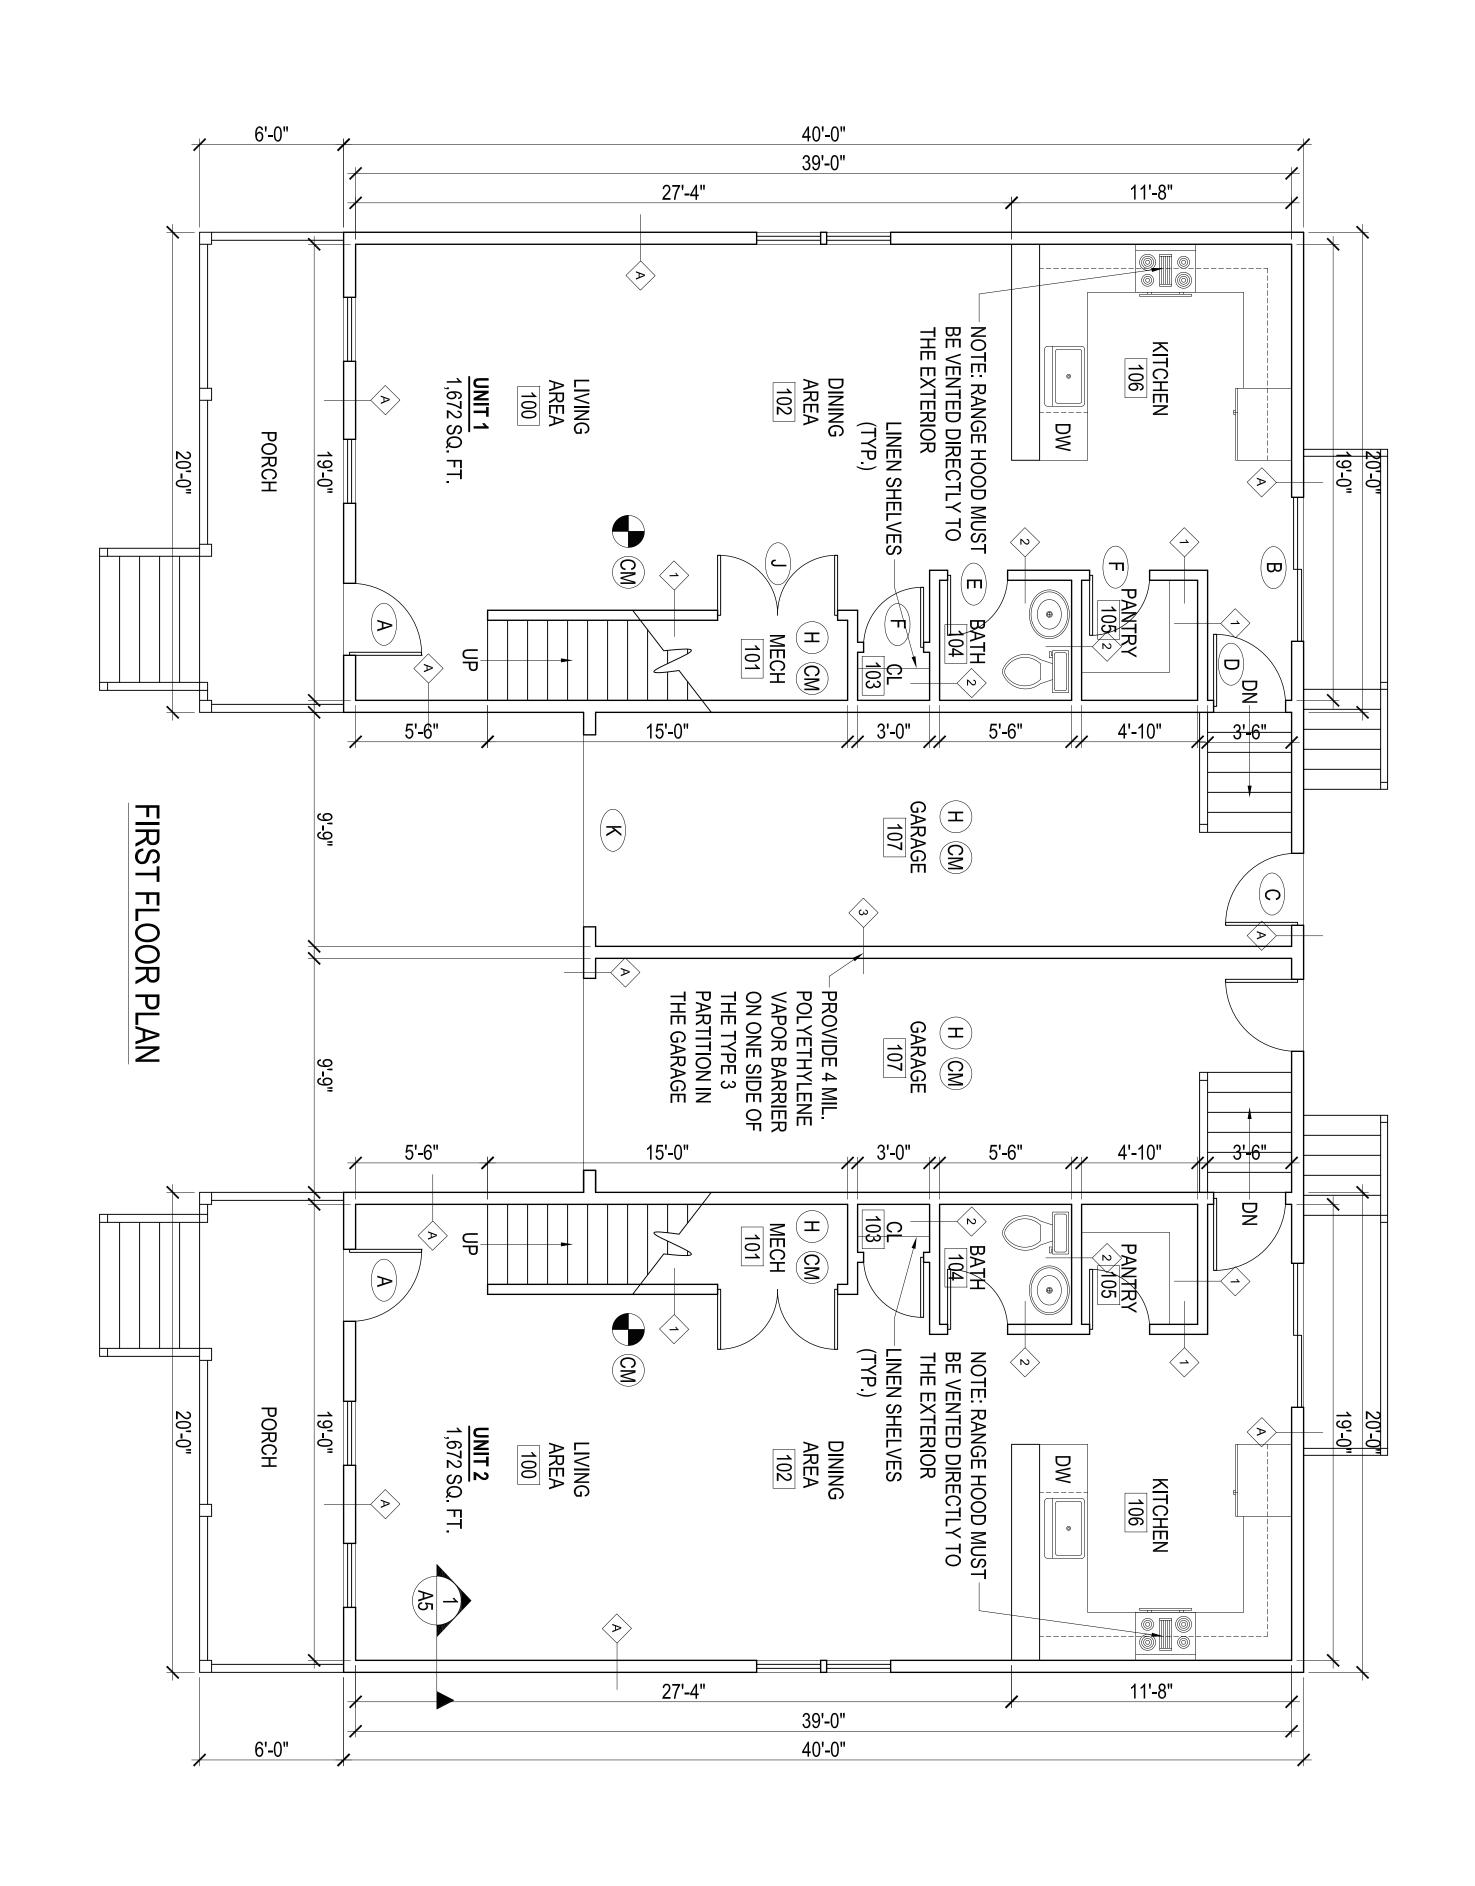HARDWIRED & INTERCONNECTED SMOKE DETECTOR HARDWIRED & INTERCONNECTED HEAT DETECTOR

SECOND FLOOR PLAN


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ROOF NOTES:

PROVIDE BITUTHANE ICE AND WATERSHIELD BY W.R. GRACE. APPLY 3'-0" WIDE AT RAKE EDGE, RIDGE AND VALLEYS. PROVIDE TWO LAYERS OF 3'-0" WIDE PRODUCT AT ROOF EAVE-OVERLAP TO SHED WATER.

PAINTED ALUMINUM FLASHING: PROVIDE NEW PAINTED ALUMINUM ROOF EDGE TRIM. NEW ASPHALT SHINGLES ROOFING; LANDMARK SERIES BY CERTAINTIED. COLOR TO BE SELECTED BY OWNER.

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HANGING GUTTERS SHALL BE 6" WIDE SEAMLESS REFINISHED ALUMINUM. PROVIDE FOR THERMAL EXPANSION. ATTACH GUTTERS TO EAVE OR FASCIA WITH FIRMLY ANCHORED STRAPS NOT MORE THAN 36" APART. PROVIDE NEW CLOSURE AND SEAL WATER TIGHT WITH SEALANT. SLOPE GUTTERS TO DOWNSPOUTS. DO NOT PAINT GUTTERS IN THE FIELD. INSTALL CONTINUOUS GUTTER SCREEN ON GUTTERS WITH REMOVABLE NON-CORROSIVE FASTENERS. PROVIDE SPLASH GUARD TO PREVENT CORNER SPLASHING.

GUTTERS AND DOWNSPOUTS. INSTALL ROOFING AND FLASHING, INCLUDE STEP FLASHING, IN ACCORDANCE WITH THE NRCA ROOFING MANUAL, CHAPTER 6 FOR ASPHALT SLOPED ROOF SYSTEM.

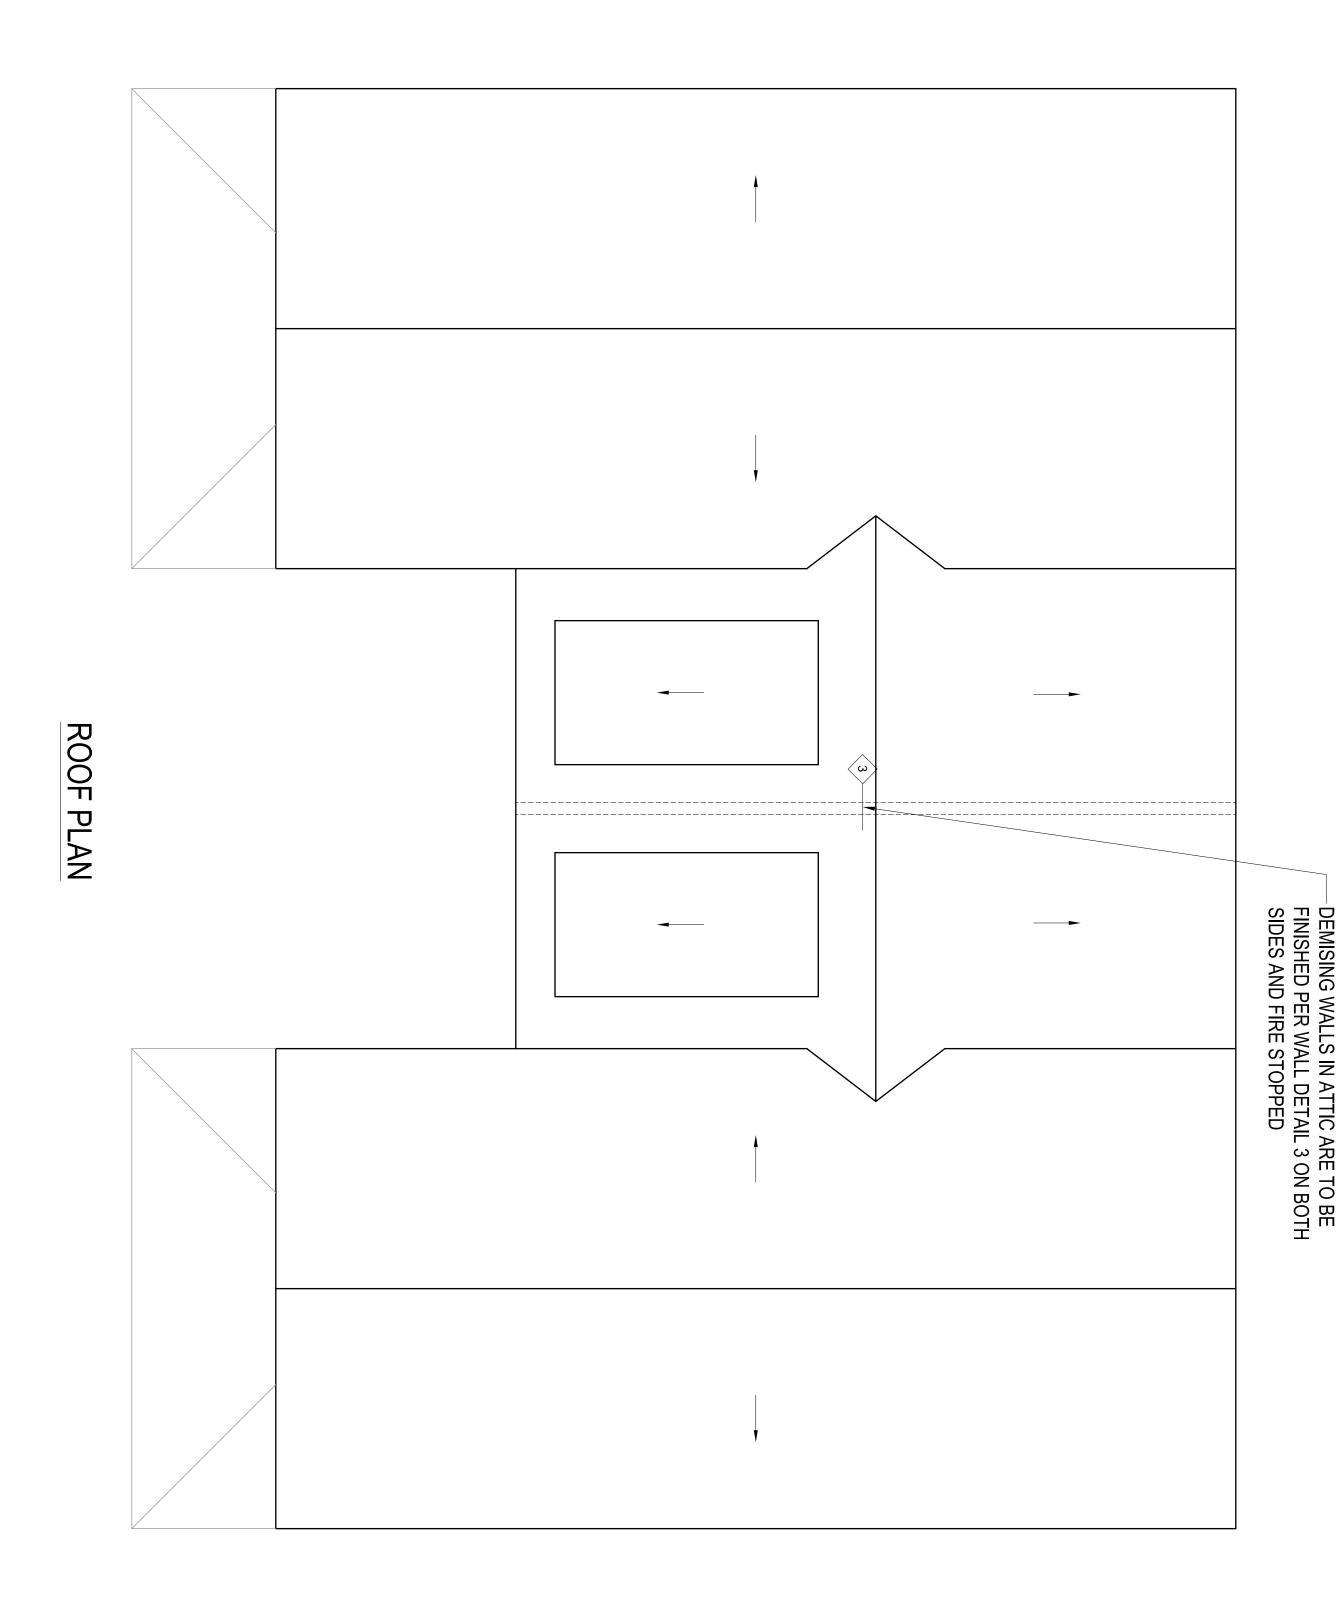DOWN SPOUTS SHALL BE 2" X 3" PREFINISHED ALUMINUM. JOIN SECTION WITH 1-1/2" TELESCOPING JOINTS. PROVIDE HANGERS WITH FASTENERS DESIGN TO HOLD DOWNSPOUTS SECURELY TO WALLS AT TOP AND BOTTOM AND 60" O.C. MAXIMUM. DO NOT PAINT DOWNSPOUTS IN THE FIELD.

GENERAL NOTE:

1 0 1

VERIFY AND CONFIRM ALL CONDITIONS AND/OR DIMENSIONS SHOWN PRIOR TO COMMENCING CONSTRUCTION OR ORDERING MATERIALS.

NOTIFY ARCHITECT OF ANY INCONSISTENCIES FOR REVIEW AND APPROVAL BEFORE PROCEEDING WITH CONSTRUCTION.

ROOF PLAN

CHECKED BY: R.P.B. SCALE: 1/4" = 1'-0" DATE: 8-24-20 REV: DRAWN BY: PROJECT # 20-021

Norfolk Design & Construction 23-25 Rosebery Road Mattapan, MA 02126




Telephone: 617-282-0030 Fax: 617-282-1080

REV


DESCRIPTION

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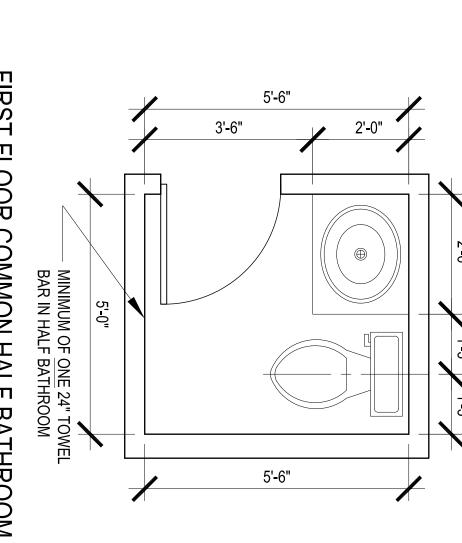


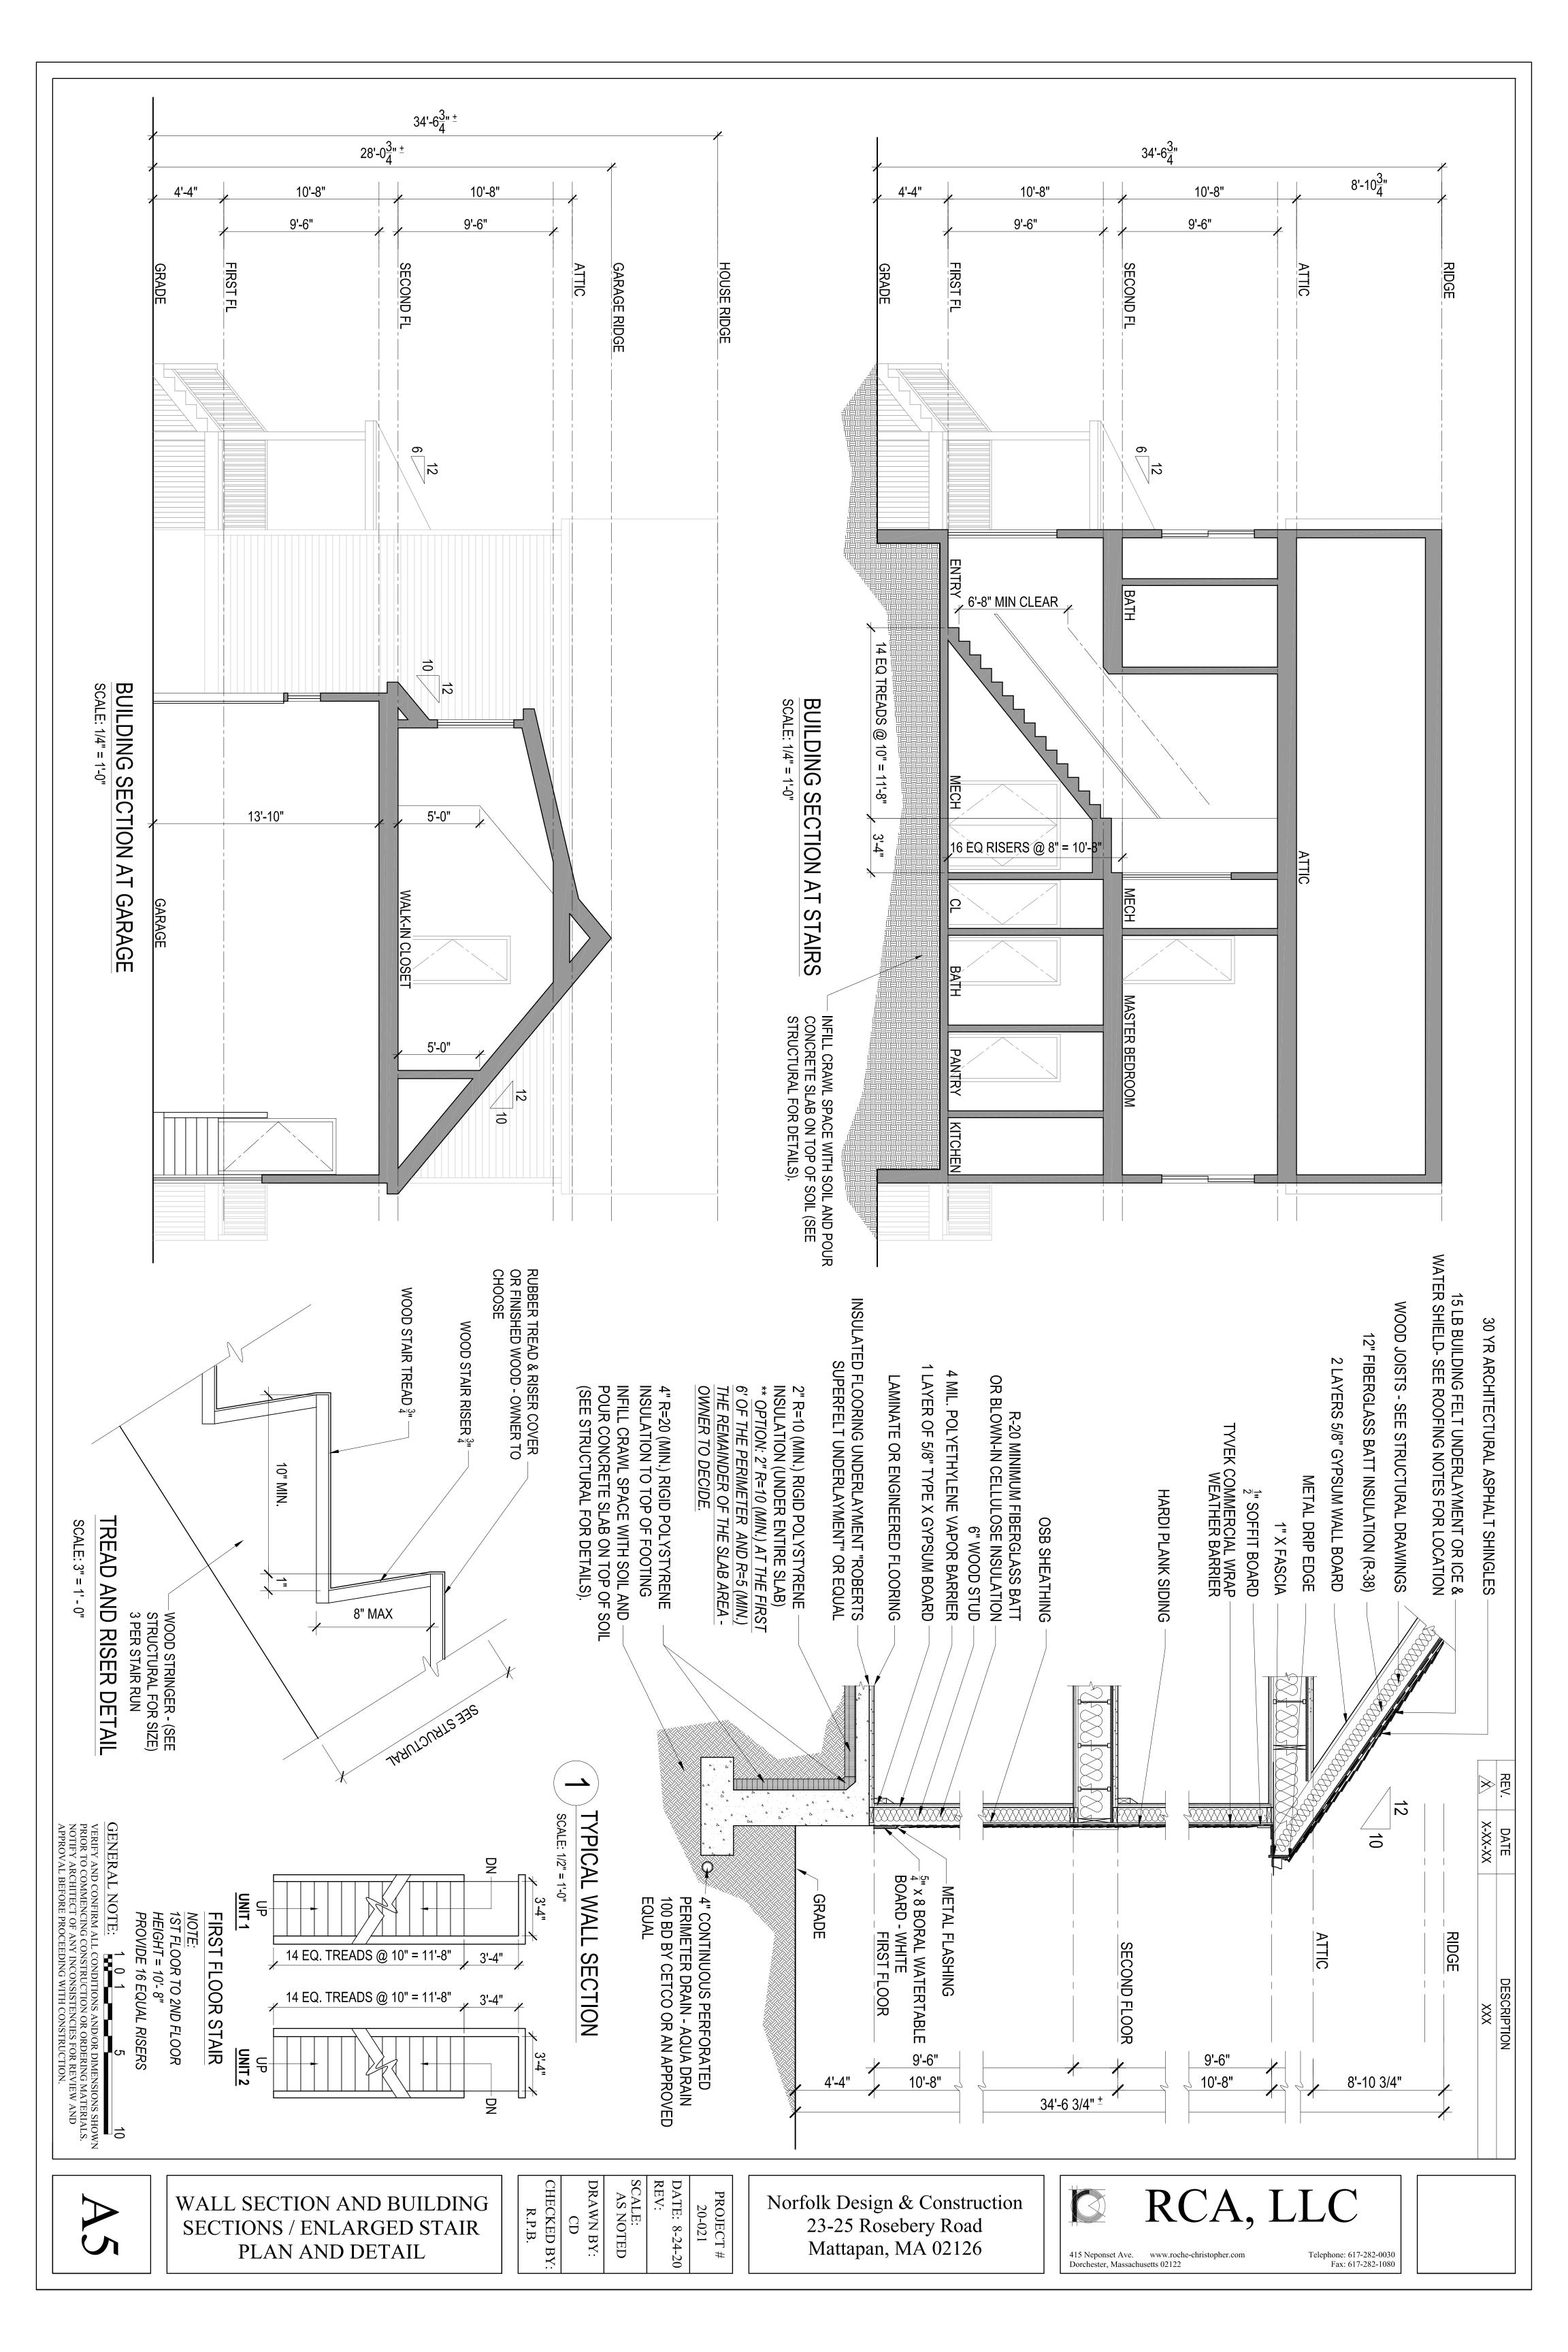



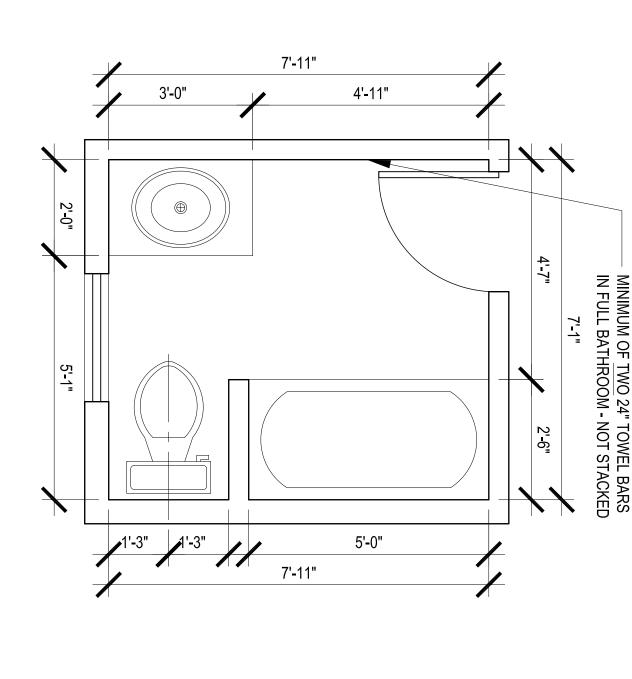

SECOND FLOOR COMMON BATHROOM PLAN OR SIMILAR



FIRST FLOOR COMMON HALF BATHROOM PLAN OR SIMILAR

2'-0" 2'-0" 2'-6" 2'-0" 2'-0" 1'-6"

3'-6"

2'-0"

2'-0"

2'-6"

2'-0"

1-0

NOTE: RANGE HOOD MUST BE VENTED DIRECTLY TO

THE EXTERIOR

DISHWASHER I

3'-0"

2'-0"

2'-0"

2'-0"


OR SIMILAR

OR SIMILAR

KITCHEN ELEVATION B

KITCHEN ELEVATION C

OR SIMILAR

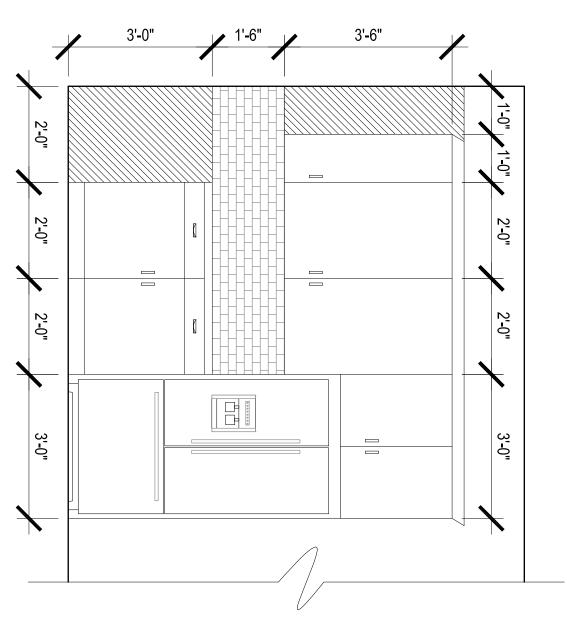

KITCHEN ELEVATION A

BATHROOM NOTES:

KITCHEN NOTES:

 \gg

X-XX-XX

DESCRIPTION

- PROVIDE TOILET TISSUE DISPENSER AT EACH WATER PROVIDE MIRROR/MEDICINE CABINET, 30" HIGH \times 24" WIDE, ABOVE EACH VANITY AND LAVATORY. MOUNT 40" ABOVE THE FLOOR.

က

2

- PROVIDE FULL HEIGHT CERAMIC WALL TILE AT TUB ENCLOSURES (3 SIDES). PROVIDE BULL NOSE TILE AT EDGES. SUBMIT SAMPLES TO THE OWNER FOR FINAL WALL TILE SELECTION.
- PROVIDE CERAMIC TILE SOAP HOLDERS AT TUBS.
 BATHROOMS SHALL RECEIVE CERAMIC FLOOR TILE AND
 MATCHING CERAMIC BASE INSTALLED BY THIN SET
 METHOD. SUBMIT SAMPLES TO THE OWNER FOR FINAL
 FLOOR TILE AND BASE SELECTION.
 PROVIDE CRACK SUPPRESSION MEMBRANE AT ALL
 FLOOR LOCATIONS TO RECEIVE CERAMIC TILE.

 ∞

CABINETRY.

PROVIDE ALL NECESSARY FILLER PANELS AND TRIM FOR A COMPLETELY FINISHED INSTALLATION.

COUNTERTOPS SHALL BE SELECTED BY THE OWNER. IF COUNTERTOPS ARE NOT SOLID SURFACE, THEN THE SECOND OPTION IS THAT COUNTERTOPS SHOULD BE ONE-PIECE SQUARE-EDGED, 0.50" THICK MINIMUM HIGH PRESSURE LAMINATE, WITH 4" INTEGRAL "POST-FORMED",

7.

<u>ი</u>

RETURN CROWN MOLDING TRIM AT SIDES AND ENDS OF

5

OR LESS CYCLE.
PROVIDE FINISHED END AND BACK PANELS AT ALL
EXPOSED LOCATIONS FOR A COMPLETELY FINISHED
INSTALLATION.

 ω 4

GARBAGE DISPOSALS SHALL BE A MINIMUM OF 1/2 HP. DISHWASHERS SHALL HAVE WATER USE OF 6.0 GALLON

2

PROVIDE CABINETRY SHOP DRAWINGS FOR EACH KITCHEN LAYOUT. CONFIRM FINISH DIMENSIONS OF APPLIANCES TO BE INSTALLED IN THE CABINETRY.
ALL APPLICABLE KITCHEN APPLIANCES SHALL BE ENERGY

0

5

- SUBMIT MARBLE SAMPLES TO THE OWNER FOR FINAL PROVIDE $\frac{1}{2}$ " THICK MARBLE THRESHOLDS AT BATHROOM DOORS. COORDINATE MARBLE COLOR WITH TILE COLOR.

9

WATER-BASED.
CABINETS SHALL HAVE HIGH PRESSURE OR SOLID WOOD FORMALDEHYDE-FREE DOORS AND DRAWERS WITH PULLS AND FRAMES COMPLYING WITH "ANSI/KCMA A161.1" CABINETRY SPECIFICATIONS. THERMOFOIL AND PARTICLE BOARD CABINETS ARE NOT ALLOWED.
CABINETRY STYLE AND COLOR TO BE SELECTED BY THE OWNER (THE FINAL SELECTION MUST MEET ALL MINIMUM

USE MOISTURE RESISTIVE GYPSUM WALL BOARD AT BATHROOM WALLS, EXCEPT USE DENSGUARD TILE BATHROOM WALLS, EXCEPT USE DENSGUARD TILE BACKER BOARD AT TUB SURROUNDS AND SHOWERS.

ALL FULL BATHROOMS HAVE AT A MINIMUM OF TWO 24"

TOWEL BARS (NOT STACKED), ONE ROB HOOK, A SHOWER CURTAIN ROD AND A TOILET PAPER HOLDER.9.

ALL HALF BATHROOMS HAVE AT A MINIMUM OF ONE 24"

TOWEL BAR.

9

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- INSTALLED AT INITIAL CONSTRUCTION.

 BATHROOM EXHAUST SYSTEMS SHOULD OPERATE
 CONTINUOUSLY AT LOW SPEED AND INCLUDE SWITCHING
 TO BOOST DISCHARGE VENTILATION FOLLOWING
 OCCUPANT USE BY AT LEAST 50%.

 ALL BATHROOM DOORS SHALL BE UNDERCUT ½" TO ROMOTE REQUIRED AIR CHANGES THROUGHOUT 末
- UNIT. FRESH AIR MUST BE MECHANICALLY-SUPPLIED TO ALL

3

UNITS.

<u>12</u>

10.

FLOORING UNDER REMOVABLE BASE CABINETS MUST

BE

REQUIREMENTS ABOVE).

0 DW	NOTE KITCHEN BASE CABINET TO BE A MINIMUM OF A 36" CABINET.	MINIMUM DE 30" Y 22" Y 6"		

OR SIMILAR KITCHEN PLAN

NOTE: RANGE HOOD MUST BE VENTED DIRECTLY TO THE EXTERIOR

GENERAL NOTE:

ENLARGED BATHROOM AND KITCHEN PLANS

SCALE: 1/2" = 1'-0" CHECKED BY: DATE: 8-24-20 DRAWN BY: PROJECT # 20-021


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TYPICAL AT ALL INTERIOR PARTITIONS
USE MOISTURE RESISTIVE GYPSUM BOARD
AT TOILET ROOMS
USE 1/2" CEMENT BOARD AT ALL TILE
LOCATIONS

ENHANCED ACOUSTICAL FLOOR / CEILING ASSEMBLIES

ENGINEERED WOOD JOISTS SEE STRUCTURAL DRAWINGS
 6" FIBERGLASS SOUND
 BATT INSULATION (R-19)
 1 LAYER 5/8" TYPE X GYPSUM BOARD

- GENECLIP TYPE RST -7/8" METAL FURRING

101 102 103 104 105

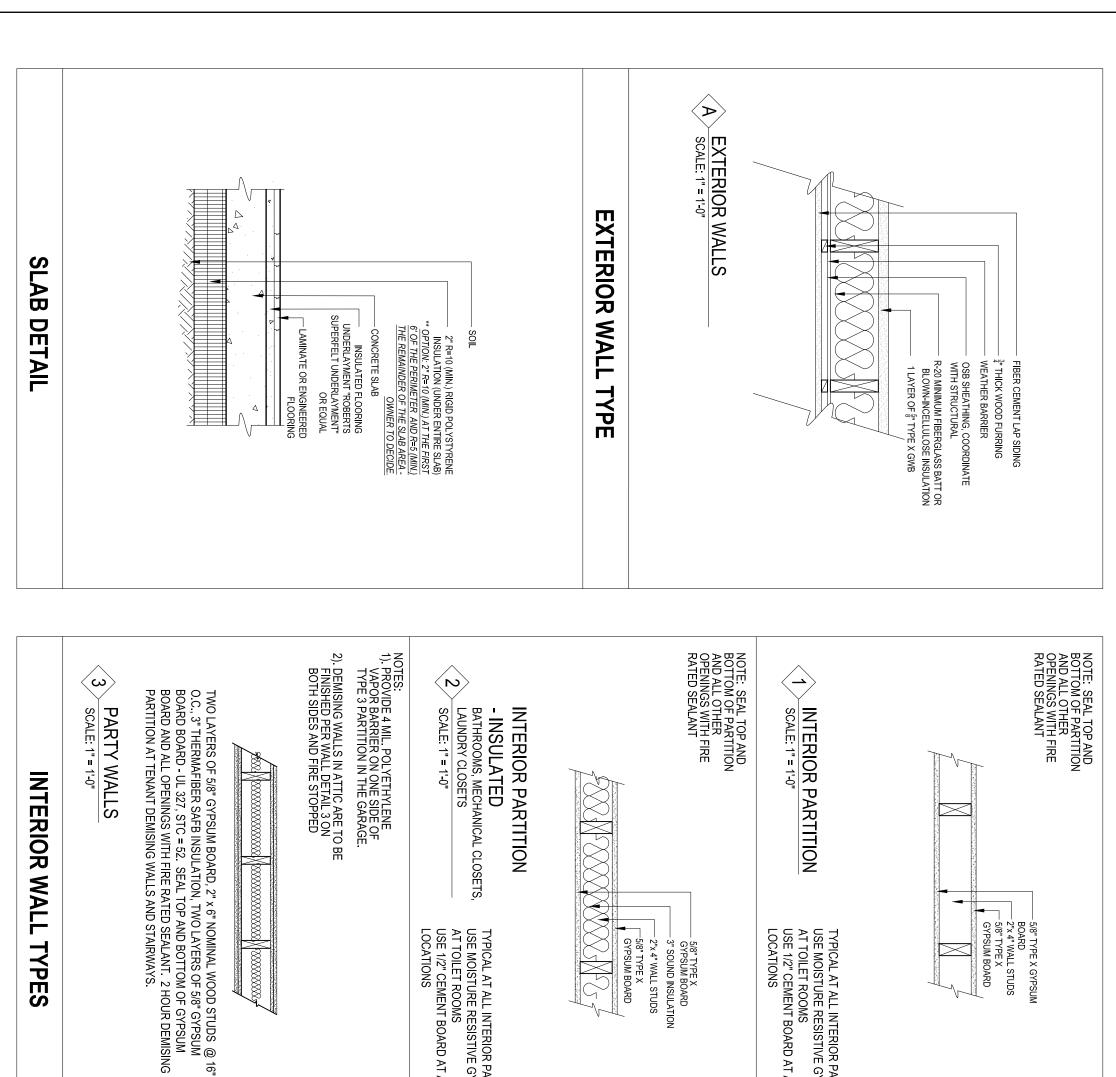CLOSET BATH PANTRY

106

KITCHEN

SECOND

HARDWOOD

HARDWOOD

OWNER'S OPTION TO PROVIDE ENHANCED ACOUSTICAL ASSEMBLY

203

WASHER / CLOSET

G. W.B.
G. W.B.
G. W.B.
G. W.B.
G. W.B.
G. W.B.


BEDROOM CLOSET


BEDROOM


MASTER BEDROOM

SOUND CONTROL CRITERIA


FLOOR ASSEMBLIES

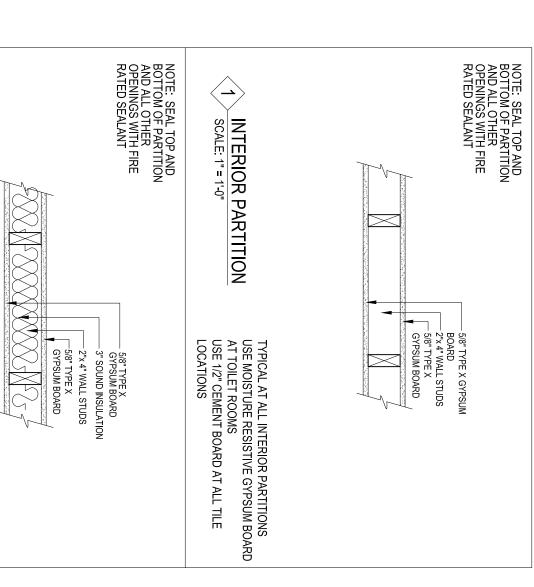

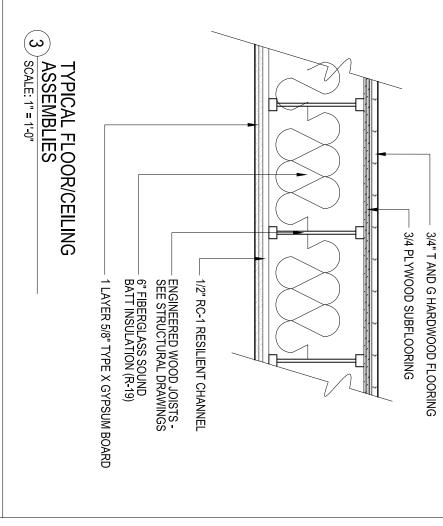

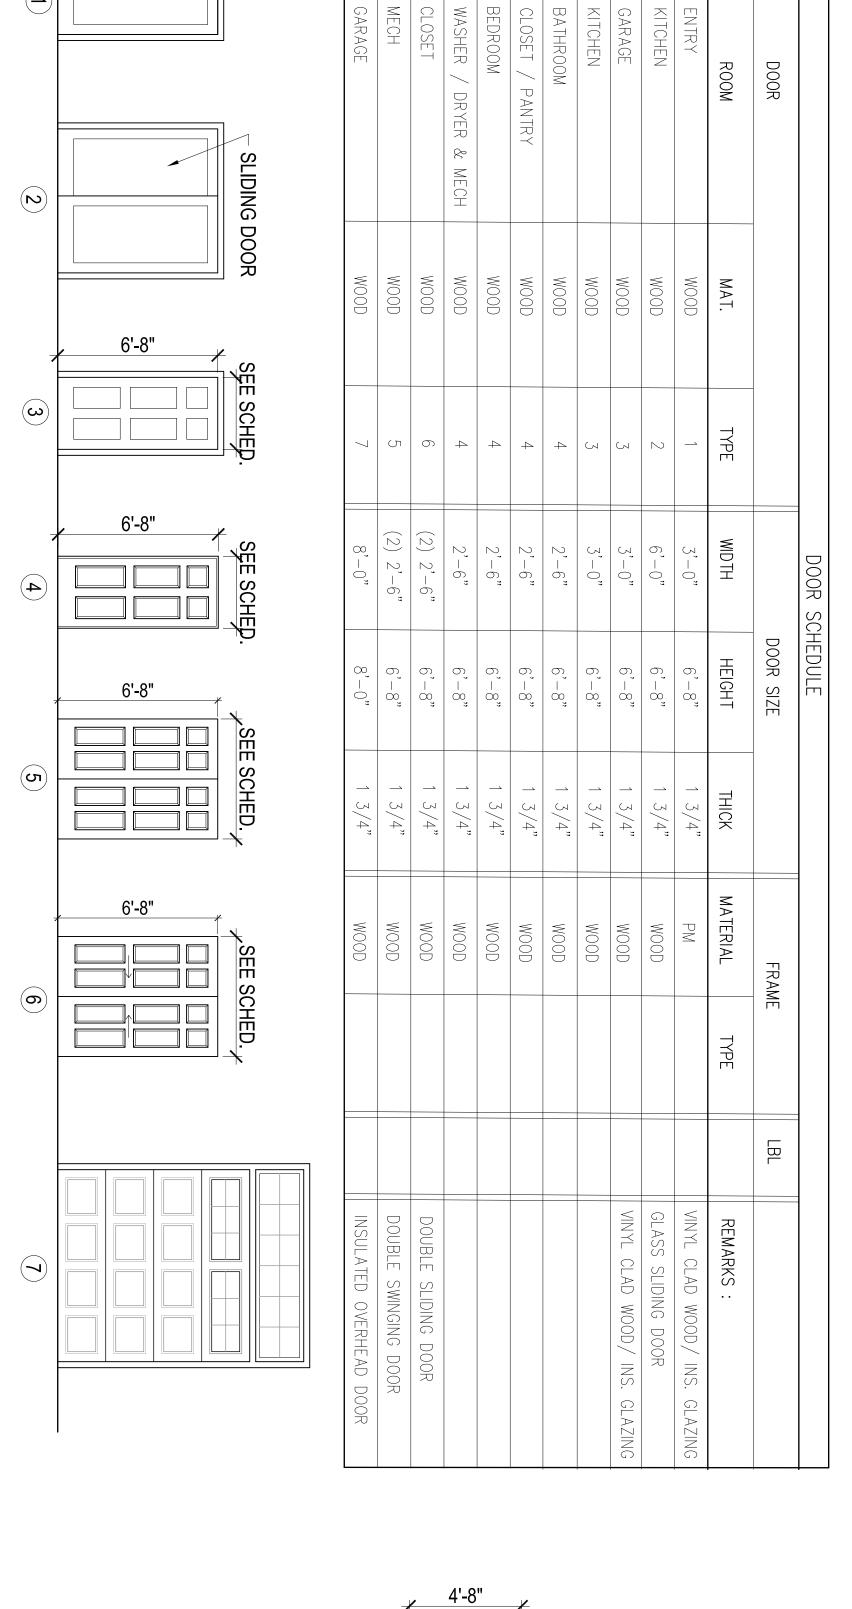



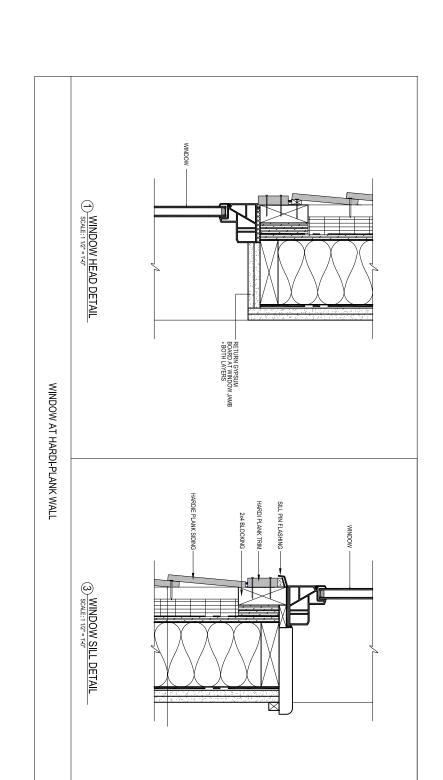

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WINDOW TYPES

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B

TYPICAL WINDOW TRIM DETAIL

1X3 BORAL WINDOW TRIM (TYP.)

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ALL WINDOWS SHOULD RECEIVE PROPERLY-SIZED WINDOW SHADES: FIBERGLASS-COATED, VINYL PLASTIC, FIRE-RETARDANT, FADE-RESISTANT ROLLER SHADES WITH LARGE DIAMETER COTTON CORD ATTACHED TO

PROVIDE WINDOW GUARDS AND / OR LIMITERS TO COMPLY WITH "KIDS CAN'T FLY". 1X3 BORAL WINDOW TRIM AROUND ALL WINDOWS.

MINI-BLINDS ARE DISCOURAGED SINCE THE BLINDS
THEMSELVES MAY POSE A CHOKING RISK, BUT IF USED, IT
MUST BE VERIFIED THAT THE SELECTED PRODUCT IS
SAFE FOR CHILDREN.

WINDOW AT HARDI-PLANK WALL	(1) WINDOW HEAD DETAIL. SCALE: 110" = 140"	RETURN GYPSUM BOARD AT TWINDOW JAME BOARD AT
HPLANK WALL	(3) WINDOW SILL DETAIL	SILL PIN FLASHING HARDI PLANK TRIM HARDIE PLANK SIDING HARDIE PLANK SIDING

WINDOW SCHEDULE	HEDULE			
TYPE	Ē	MODEL NUMBER	MFG.	REMARKS
DOUBLE-HUNG	SNNH	TW2646		
DOUBLE-HUNG	HUNG	TW2656		
	NN	WINDOW NOTES	ES:	
	1. WINE	WINDOW TREATMENTS MUST BE I	WINDOW TREATMENTS MUST BE PROVIDED IN ALL UNIT.	DED IN ALL UNIT.
	2. ALL \	ALL WINDOW TREATME CHILD SAFETY.	ALL WINDOW TREATMENTS MUST BE CORDLESS FOR CHILD SAFETY.	RDLESS FOR

DESCRIPTION

 \square

2'-7 5/8"

7/8"

ROUGH OPENING
WIDTH HEIGH
" 2'-8 1/8" 4'-8
" 2'-8 1/8" 5'-8

4'-8 7/8" 5'-8 7/8"

WIDTH

ODINDING INOID.
VERIFY AND CONFIRM ALL CO
PRIOR TO COMMENCING CONS
NOTIFY ARCHITECT OF ANY IN
ומדורים מתחום ביו זיין מתחום ו

FLOOR AND WALL ASSEMBLES / WINDOW, DOOR AND ROOM FINISH SCHEDULES


ARDWOOD

R.P.B.	CHECKED BY:	CD	DRAWN BY:	SCALE: AS NOTED	DATE: 8-24-20 REV:	20-021	PROJECT #

Norfolk Design & Construction 23-25 Rosebery Road Mattapan, MA 02126



Telephone: 617-282-0030 Fax: 617-282-1080 415 Neponset Ave. www.roche-christopher.com Dorchester, Massachusetts 02122

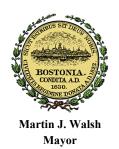

Boston Inspectional Services Department

Planning and Zoning Division

1010 Massachusetts Avenue, 5th Floor, Boston, MA 02118 Telephone: (617) 635-5300

MORE INFORMATION REQUEST LETTER

Sean Lydon Inspector of Buildings

November 05, 2020

ADLER BERNADIN 60 COMMERCIAL STREET STOUGHTON, MA 02072

RE: Application #: ERT1060807

Location: 23 - 25 Rosebery Rd, Ward 18
Zoning District: Hyde Park Neighborhood, 2F-5000

Purpose: To Erect a new 2 story, Two (2) Family Townhouse-style Dwelling with a Garage between the Dwelling Units, as per plans.

The following information shall be provided to Inspectional Services Department to complete the Building Permit Plan Review:

1. City Agencies' Approvals:

- Boston Planning and Development Agency: Two Sets of Approved Drawings
- Department of Public Works: Contact for Curb Cut

All construction documents shall be organized in two sets, submitted together (no partial information will be accepted), and dropped off at Inspectional Services Department with the above referenced application number or re-uploaded on the portal if it is an ePlan application. More information may be required. Please be advised that the time limitation of your application shall be 180 days, otherwise it shall be deemed abandoned per 780 CMR. Thank you for your assistance.

