

Boston Inspectional Services Department

Planning and Zoning Division

1010 Massachusetts Avenue, 5th Floor, Boston, MA 02118 Telephone: (617) 635-5300

MORE INFORMATION REQUEST LETTER

Marc Joseph
Inspector of Buildings

September 01, 2021

Mayor

DENIS KEOHANE 469 NEPONSET AVE BOSTON, MA 02122

Applicant to provide all NON highlighted items

Review done 10/21/21

RE: Application #: ERT1230791

Location: 8 Kinsale Ln, Ward 18

Zoning District: Hyde Park Neighborhood, 1F-9000

Purpose: Eight lot single family subdivision. Lot #5. Construct a wood framed 3 Bed, 2 full bathrooms, 2 half bathrooms, 2 car unattached

garage as per plans.

eplan --> BOA

The following information shall be provided to Inspectional Services Department to complete the Building Permit Plan Review:

- 1. Construction Documents (two sets and to scale):
 - Certified Plot Plan, stamped and signed by a MA Registered Land Surveyor: Shall be stamped by land surveyor. Indicate driveway width.
- 2. Additional Information/Comments:
 - Applicant shall file a new ERT for the accessory building (garage) (2nd request)
 - Indicate separation between buildings on plot plan. (2nd request)
 - The applicant shall e-mail ISDPZReview@boston.gov copying Jordi.segalesperez@boston.gov after uploading all the requested information and obtaining all the necessary approvals (if requested). Please don't email us until everything requested here is ready; We don't do partial reviews to be more efficient. If you have any questions, the best way to reach me is through email.

All construction documents shall be organized in two sets, submitted together (no partial information will be accepted), and dropped off at Inspectional Services Department with the above referenced application number or re-uploaded on the portal if it is an ePlan application. More information may be required. Please be advised that the time limitation of your application shall be 180 days, otherwise it shall be deemed abandoned per 780 CMR. Thank you for your assistance.


RESIDENTIAL SUB-DIVISION:


8 KINSALE LANE LOT 5, TYPE C

BOSTON (HYDE PARK), MASSACHUSETTS

AUGUST 2, 2021 PERMIT SET

	LOT AREA	LOT	LOT	FAR	HEIGHT		OPEN	FRONT	SIDE	REAR
	DWELLING	WIDTH	FRONTAGE		ST	HGT	SPACE	SETBACK	SETBACK	SETBACK
1F-9000										
ALLOWED	9,000 SF	70 FT	70 FT	.3	2-1/2	35 FT	1,800 SF	25 FT	10 FT	40 FT
PROPOSED	10,055 SF	84 FT	87 FT	1962/10,055= .20	2-1/2	31-1 13/4" FT	7,537 SF	25.1 FT	25.3 FT	40.0 FT & 40.2 FT

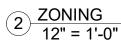

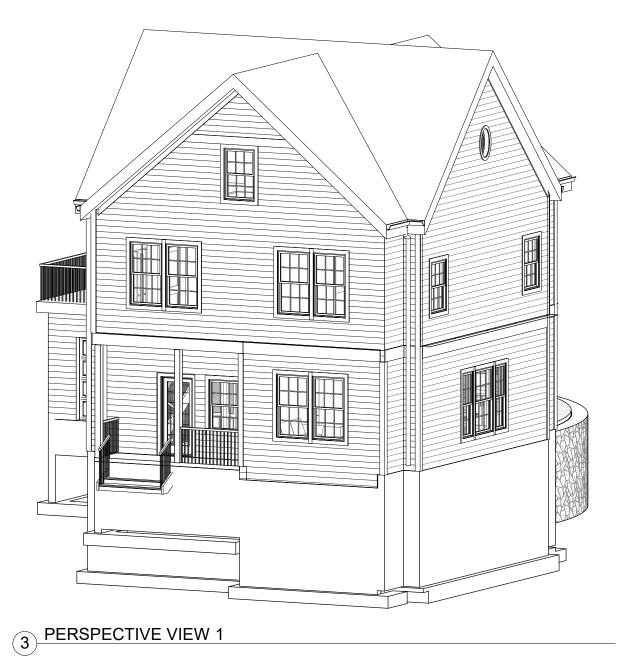

GENERAL NOTES, STANDARDS AND CONDITIONS:

INDUSTRY STANDARDS: THE FOLLOWING CONSTRUCTION AND CODE STANDARDS SHALL

780CMR MASSACHUSETTS STATE BUILDING CODE 9TH EDITION

ASHRAE AMERICAN SOCIETY OF HEATING, REFRIGERATION MPI AND AIR CONDITIONING ENGINEERS ARCHITECTURAL WOODWORK INSTITUTE CARPET AND RUG INSTITUTE

CONSTRUCTION SPRECIFICATION INSTITUTE FACTORY MUTUAL

INTERNATIONAL BUILDING CODE

MASTER PAINTERS INSTITUTE NFPA NATIONAL FIRE PROTECTION INSTITUTE OSHA OCCUPATIONAL SAFETY AND HAZARD ASSOC. SDI STEEL DOOR INSTITUTE

SMACNA SHEET METAL AIR COND. CONTRACTORS ASSOC. UL UNDERWRITERS LABORATORY

USGBC US GREEN BUILDING COUNCIL

GENERAL NOTES:

- 1. ALL PERMITS AND LICENSES SHALL BE SECURED BY THE CONTRACTOR. ALL WORK SHALL BE DONE IN ACCORDANCE WITH THE MA STATE BUILDING CODE AND ALL OTHER CODES, ORDINANCES AND STANDARDS NOTED ABOVE. CONTRACTOR SHALL NOTIFY THE ARCHITECT IMMEDIATELY OF ANY DISCREPANCIES IN THE CONTRACT DOCUMENTS AND PROCEED AFTER THEY ARE RESOLVED.
- 2. CONTRACTOR AND ALL SUBS SHALL BE LICENSED IN THE STATE OF MASSACHUSETTS AND SUPPLY PROOF OF ADEQUATE GENERAL LIABILITY AND WORKMANS COMP INSURANCE TO THE OWNER AND ARCHITECT.
- 3. CONTRACTOR SHALL PREPARE A SCHEDULE OF VALUES AND SUBMIT PERCENTAGES OF COMPLETION ALONG WITH THE MONTHLY REQUISITION FOR PAYMENT.
- 4. CONTRACTOR SHALL COORDINATE ALL ARCHITECTURAL, STRUCTURAL, MEP/FP, CIVIL AND LANDSCAPE WORK PERFORMED BY SUBCONTRACTORS IN ACCORDANCE WITH THE INTENT OF THE CONTRACT DRAWINGS AND SUBMIT SHOP DRAWINGS DEMONSTRATING COORDINATION AND UNDERSTANDING.
- 5. ALL NOTATIONS AND INDICATIONS ON THE DRAWINGS APPLYING TO ONE AREA OR CONDITION SHALL APPLY TO OTHER
- SIMILAR AREAS OR CONDITIONS ON THE DRAWINGS UNLESS OTHERWISE NOTED. 6. PROVIDE SEALANT AT ALL INTERIOR AND EXTERIOR JOINTS, TYPICAL.
- 7. PROVIDE FLASHINGS AT ALL OPENINGS, WINDOWS, DOORS, CONNECTIONS AND TRANSITIONS TO INSURE A WATERTIGHT
- 8. PROVIDE ALL ACCESS PANELS AS REQUIRED BY CODE AND REQUIRED BY ARCHITECTURAL, MEP/FP EQUIPMENT AND INSTALLATIONS WHETHER OR NOT INDICATED ON THE PLANS. ACCESS PANELS SHALL BE FLUSH AND LOCATIONS COOR-DINATED WITH THE ARCHITECT.
- 9. CONTRACTOR SHALL COORDINATE ALL SIZE AND LOCATIONS OF ALL SLAB AND WALL OPENINGS INCLUDING PER EQUIPMENT MANUFACTURERS RECOMMENDATIONS OR PER COORDINATION WITH EACH TRADE.
- 10. ALL PENETRATIONS THROUGH RATED WALLS, CEILINGS AND FLOORS SHALL BE FIRE STOPPED AND SMOKE SEALED WITH AN APPROVED RATED ASSEMBLY OR WITH MECHANICAL FIRE DAMPERS.


1. IF APPLICABLE TO THE PROJECT REFER TO GEOTECHNICAL REPORT FOR EXCAVATION AND SUB SURFACE PREP, SHORING, FOUNDATION DESIGN AND WATERPROOFING RECOMMENDATIONS.

SITE WORK/EXISTING CONDITIONS

- 1. TEMPORARY SHORING: PROVIDE AND MAINTAIN SHORING, BRACING AND STRUCTURAL SUPPORTS AS REQUIRED TO PRESERVE STABILITY AND PREVENT MOVEMENT, SETTLEMENT OR COLLAPSE OF CONSTRUCTION AND FINISHES TO REMAIN AND/OR UNCONTROLLED MOVEMENT OR COLLAPSE OF CONSTRUCTION BEING DEMOLISHED. EXCAVATION AND SHORING SHALL BE DONE IN ACCORDANCE
- 2. TEMPORARY FACILITIES: PROVIDE TEMPORARY BARRICADES AND OTHER PROTECTION REQUIRED TO PREVENT INJURY TO PEOPLE, DAMAGE TO ADJACENT PARCELS AND/OR FACILITIES TO REMAIN.
- 3. UTILITY SERVICES AND MECHANICAL/ELECTRICAL SYSTEMS: MAINTAIN AS REQUIRED FOR OCCUPIED
- FACILITIES AND/OR CAPPED/DISCONTINUED AS REQUIRED. 4. HAZARDOUS MATERIALS: IF ENCOUNTERED OWNER SHALL REMOVE UNDER A SEPARATE CONTRACT.
- 5. CONTRACTOR SHALL PROTECT ALL ON-SITE ITEMS AND MATERIALS FROM WEATHER AND MOISTURE. THIS INCLUDES PROTECTING THE BUILDING FROM WEATHER AND MOISTURE THROUGHOUT THE COURSE OF CONSTRUCTION DURING WHICH TIMES THE BUILDING IS EXPOSED.
- 6. CONTRACTOR SHALL IMPLEMENT A STRATEGY FOR DRYING MATERIALS AND PRODUCTS PRIOR TO INSTALLATION WHICH MAY HAVE A HIGH MOISTURE CONTENT.

DEMOLITION, CONSTRUCTION WASTE MANAGEMENT, NOISE MITIGATION, DUST

- 1. OFFSITE DISPOSAL SHALL BE DEPOSITED, RECYCLED OR RECLAIMED IN A LANDFILL ACCEPTABLE TO AUTHORITIES HAVING JURISDICTION.
- 2. CONTRACTOR SHALL MITIGATE TO THE EXTENT POSSIBLE DUST, DEBRIS AND NOISE THROUGHOUT THE DEMOLITION AND CONSTRUCTION PROCESS. THE SITE SHALL BE MAINTAINED IN AN ORDERLY CONDITION ON A DAILY BASIS INCLUDING ALL SURROUNDING AREAS AND ADJACENT PARCELS AFFECTED BY THE SCOPE OF WORK.

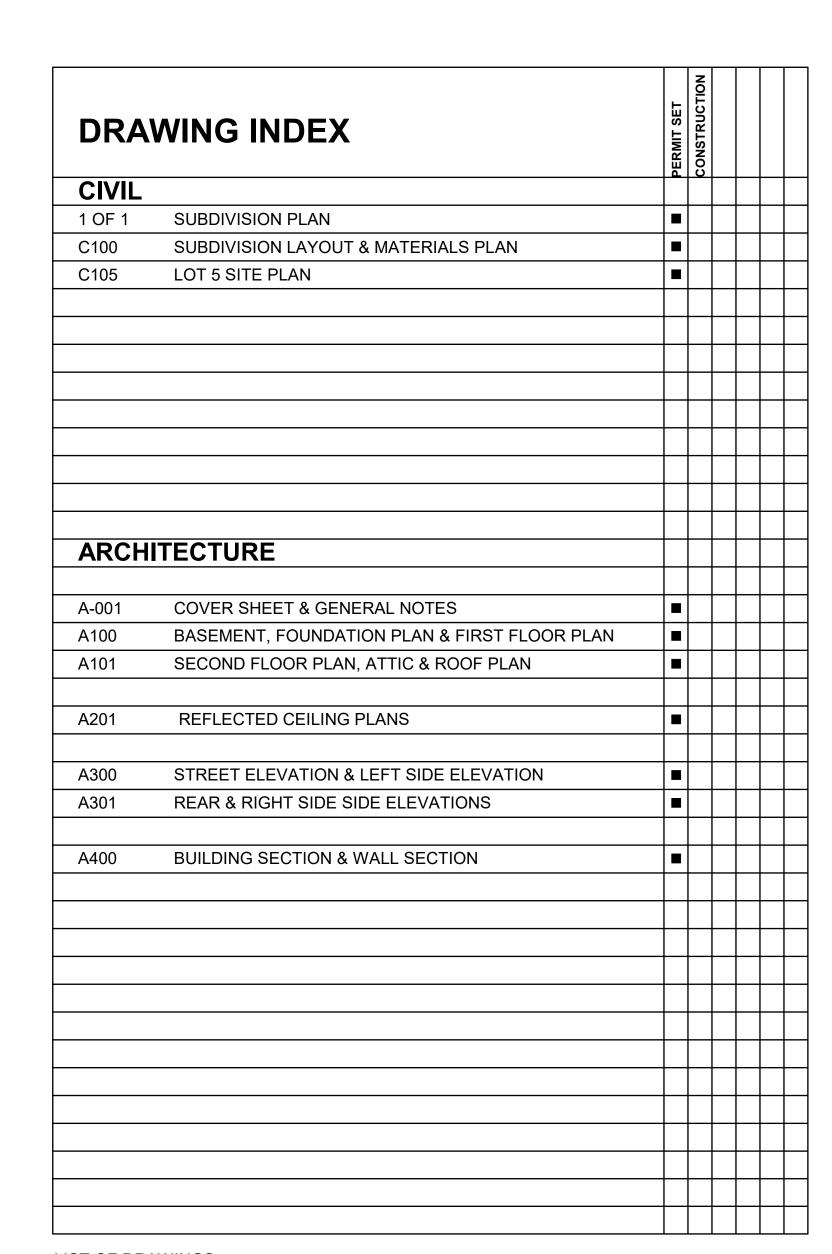






46 Waltham Street, Suite 2A Boston, Massachusetts 02118 617-542-4522

Kinsale Lane **Sub-Division**



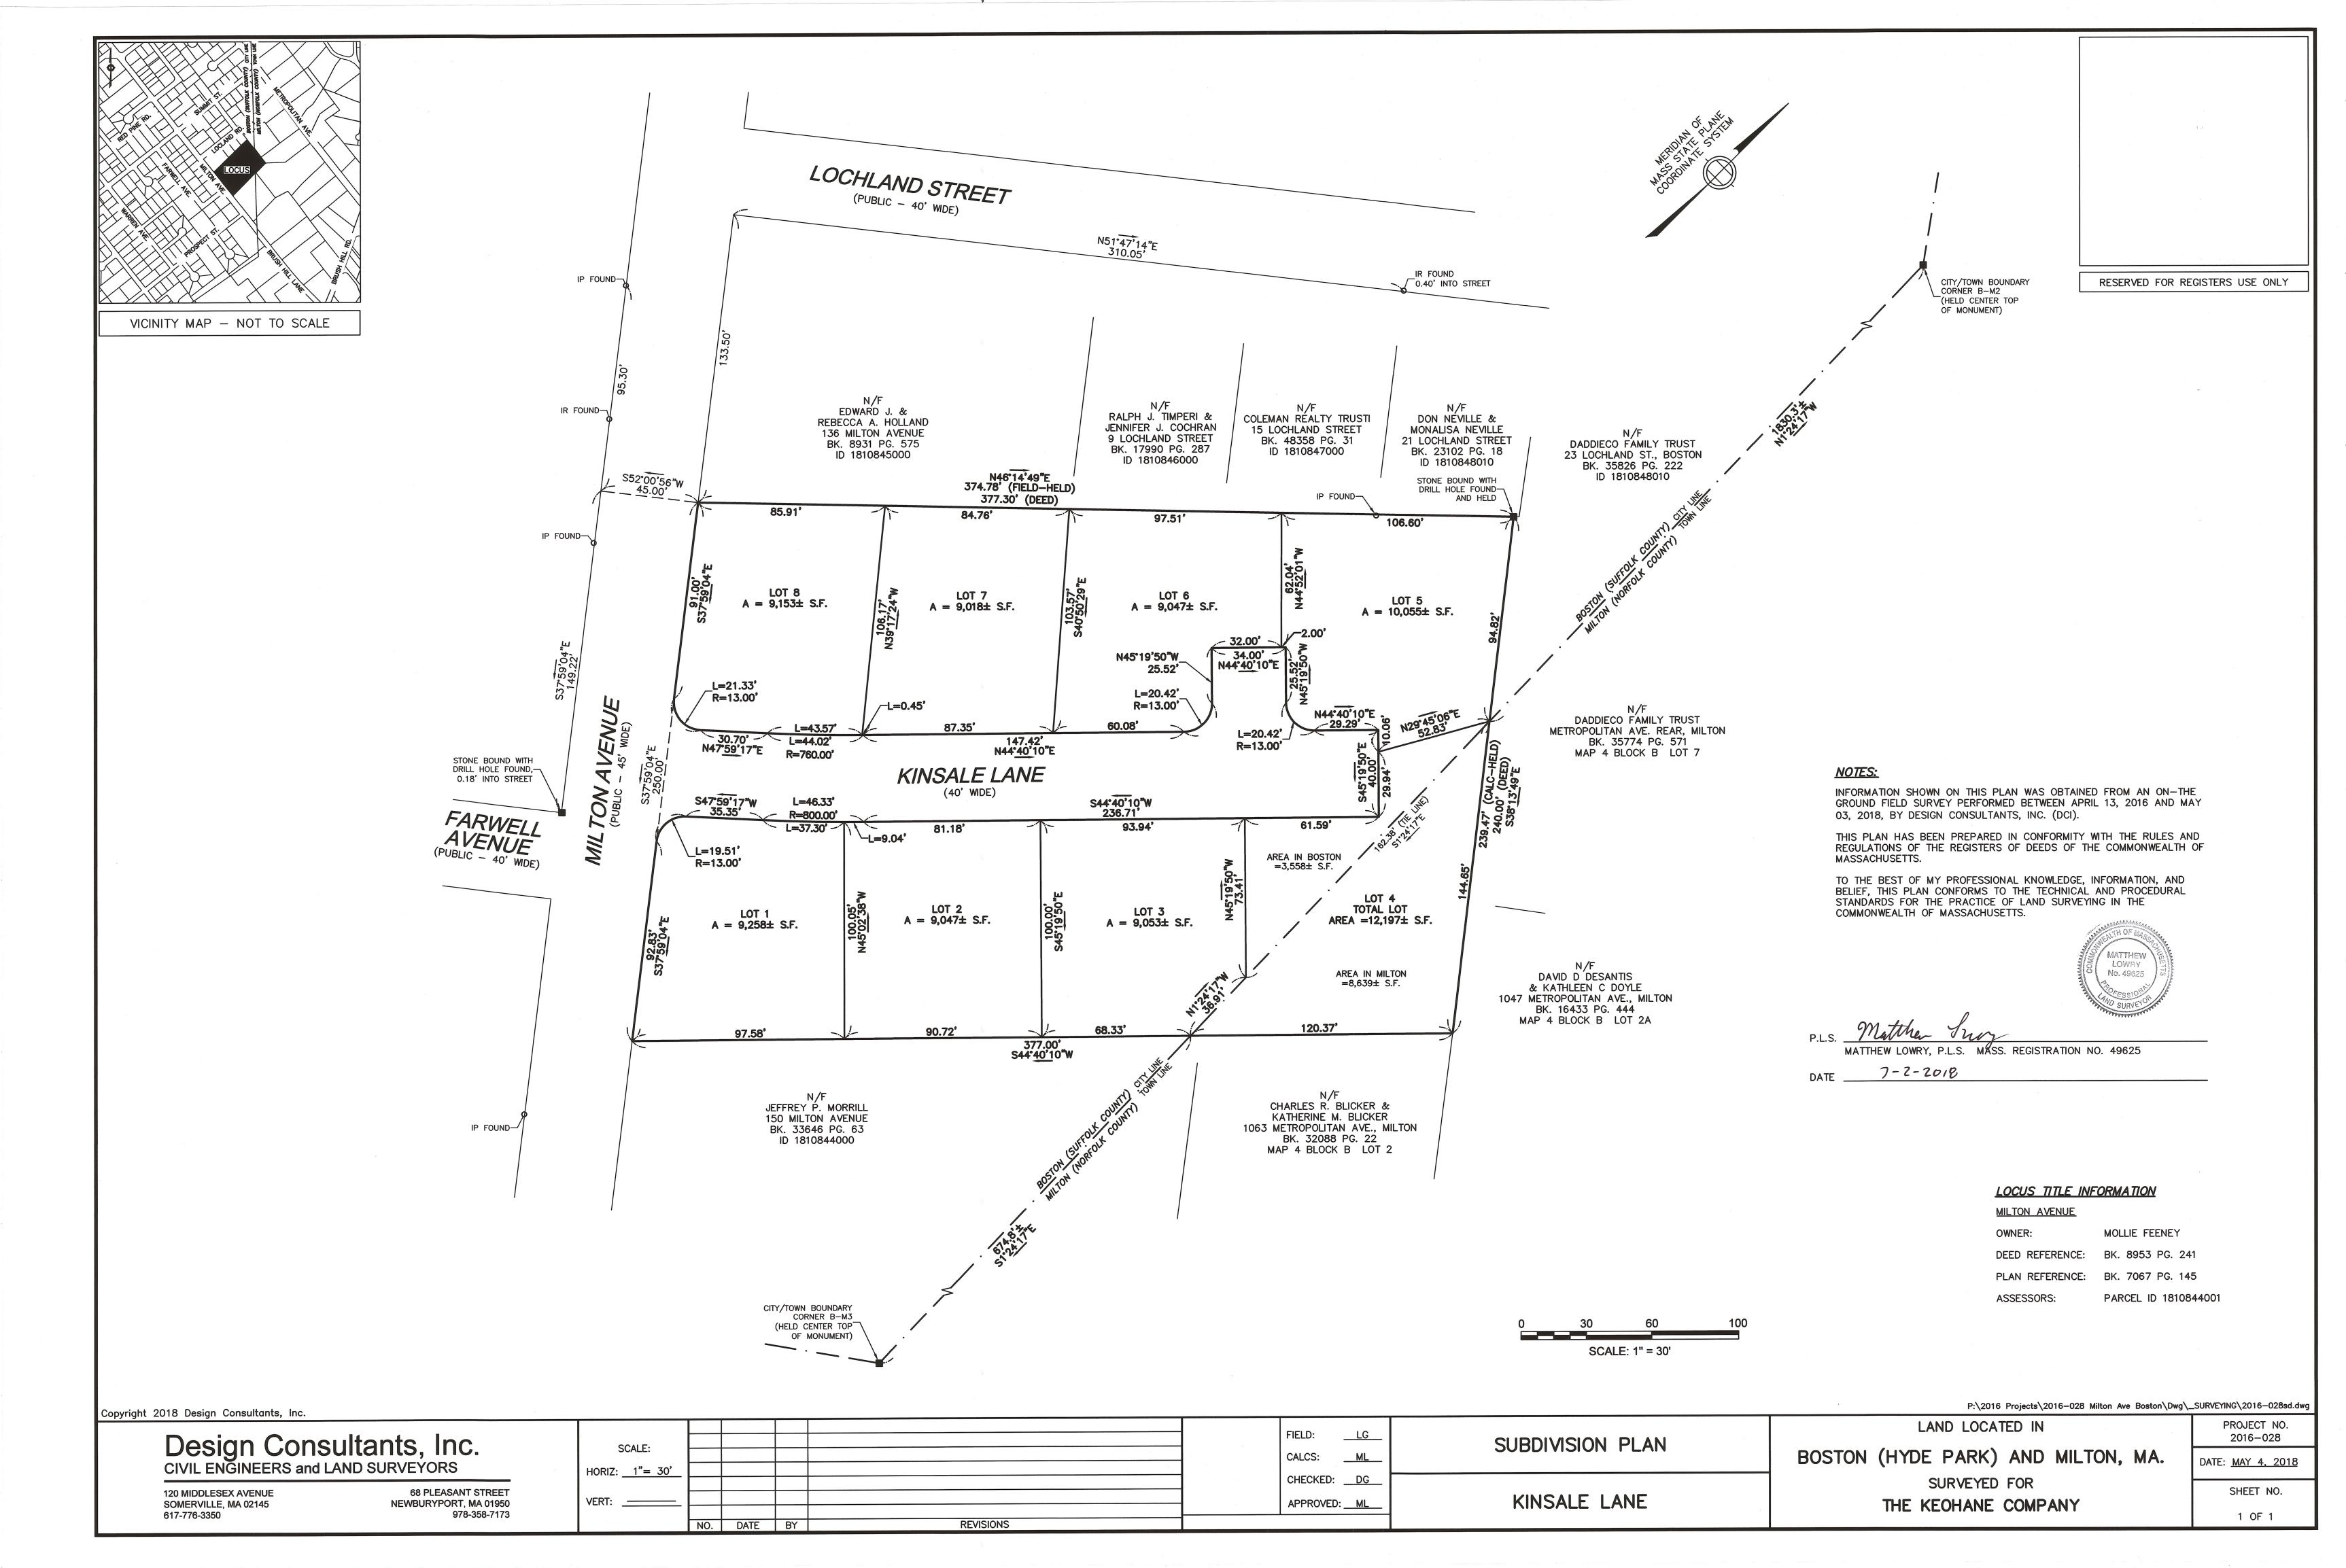

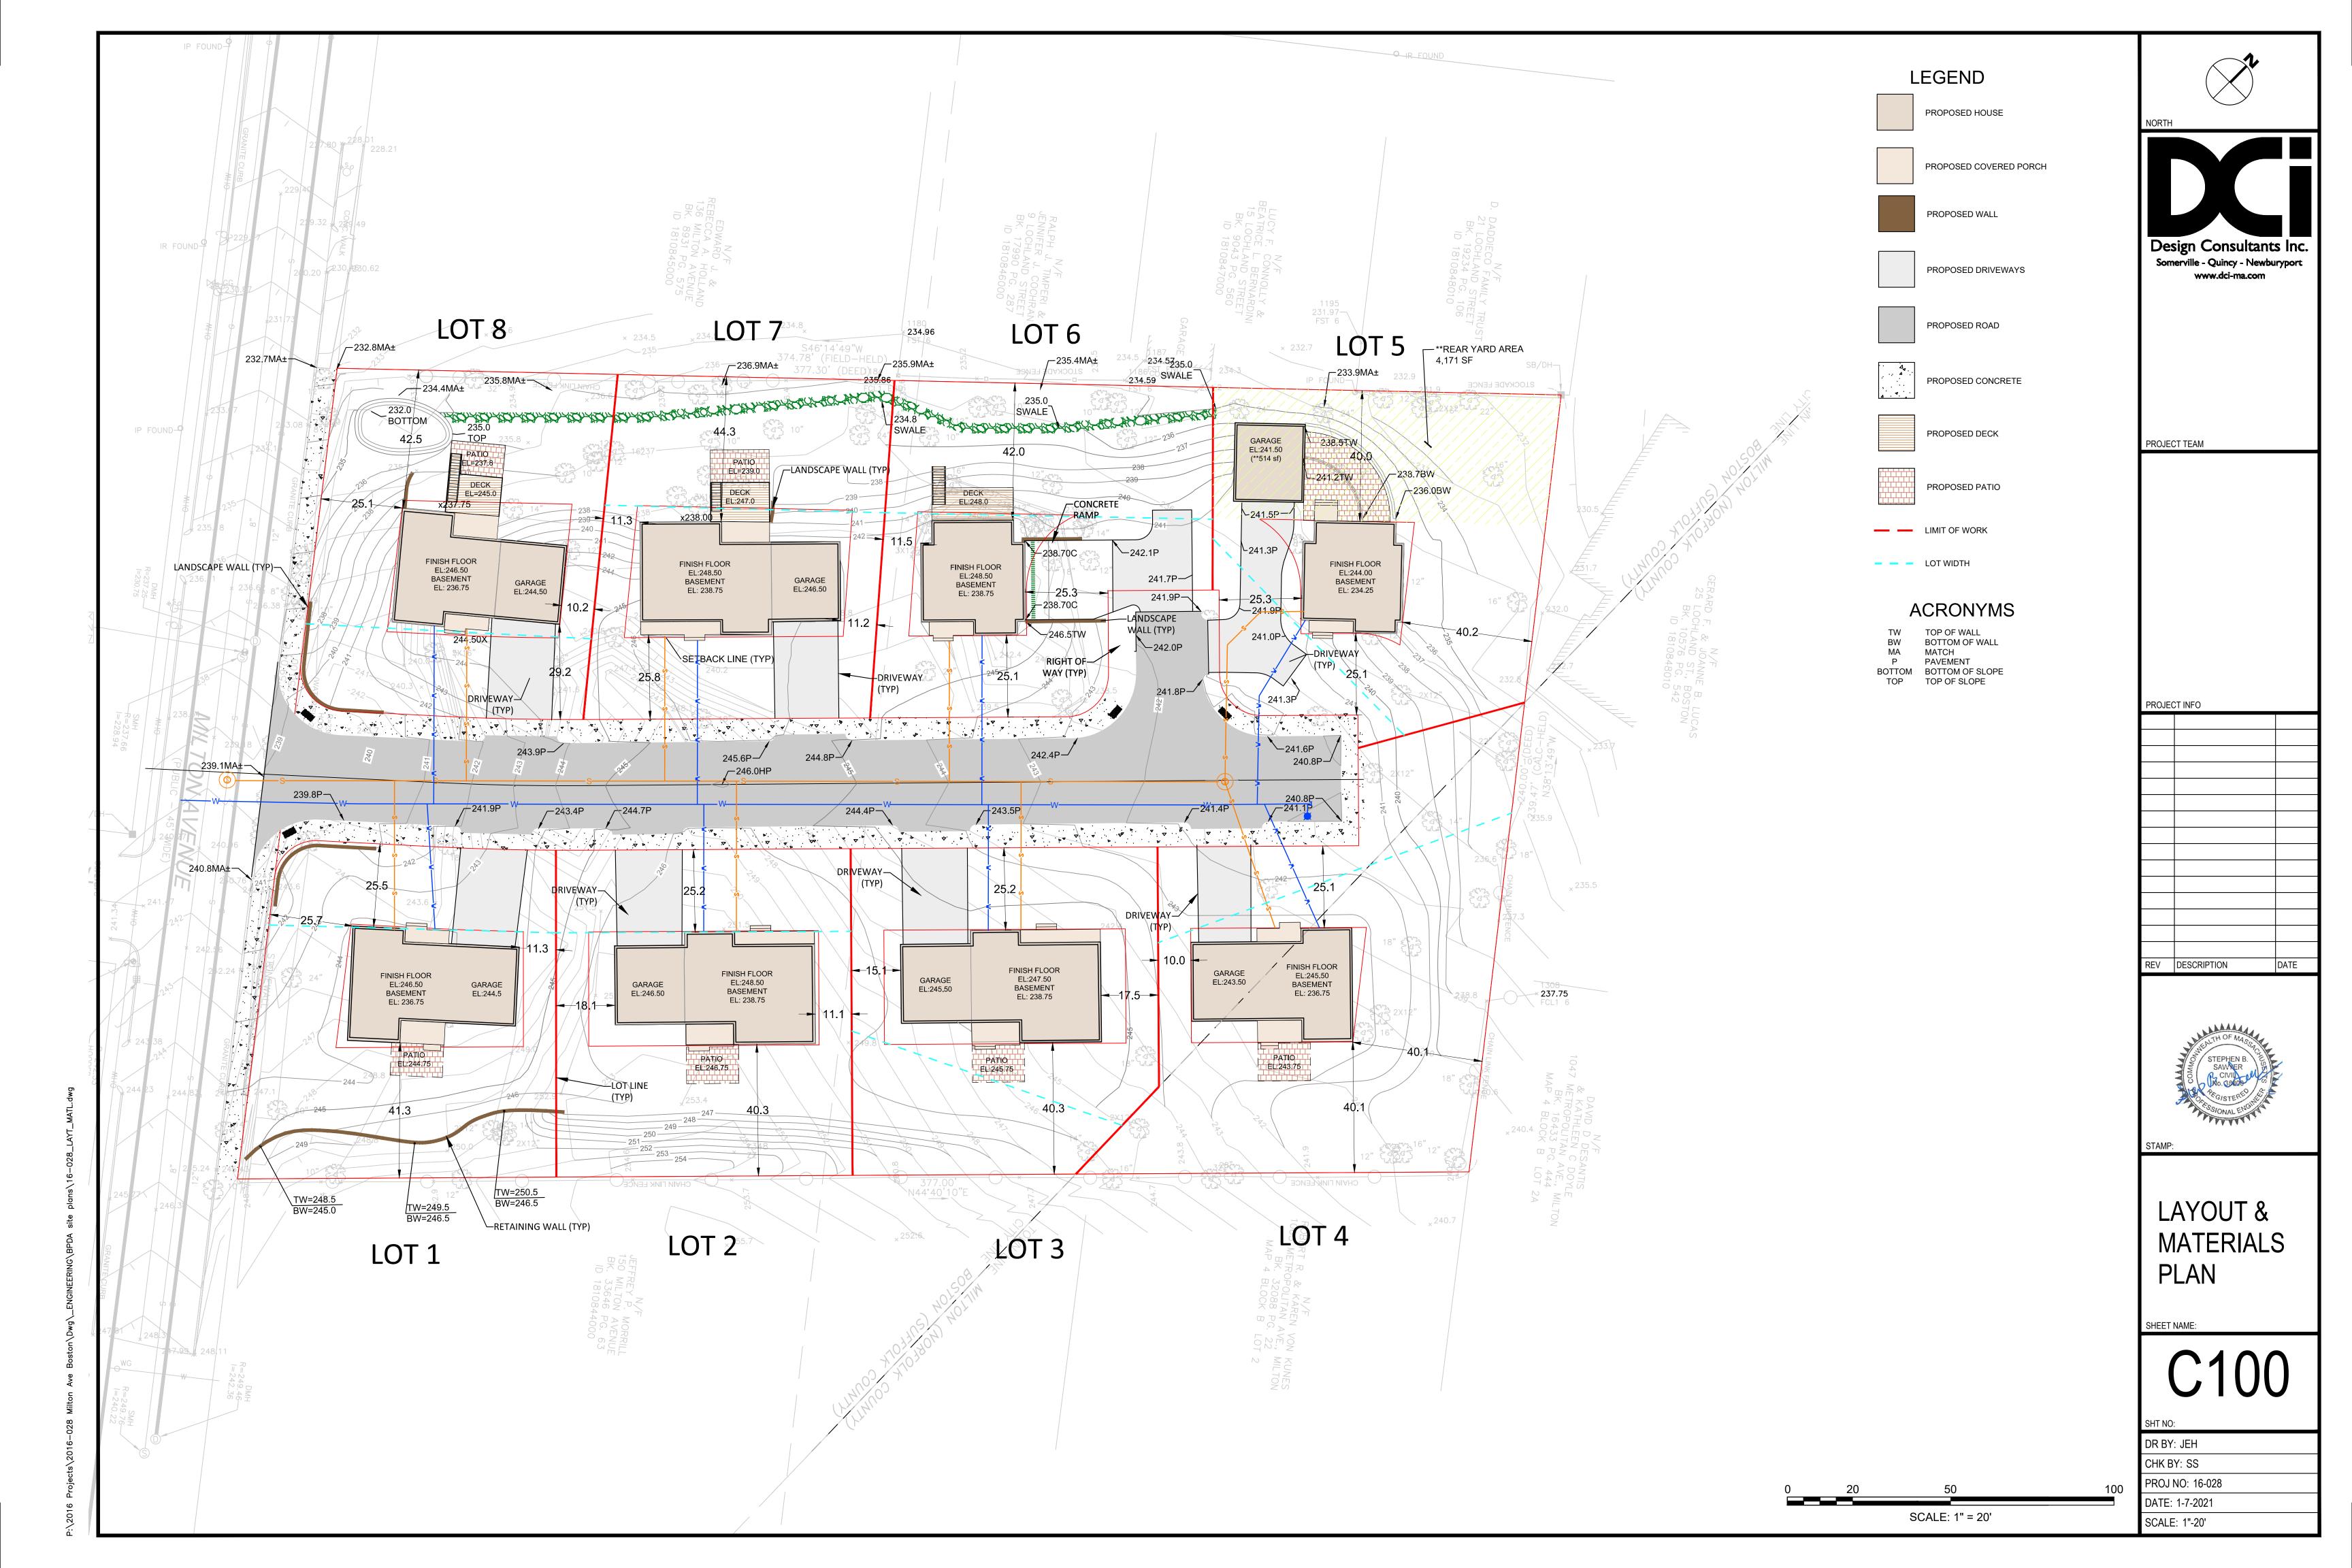

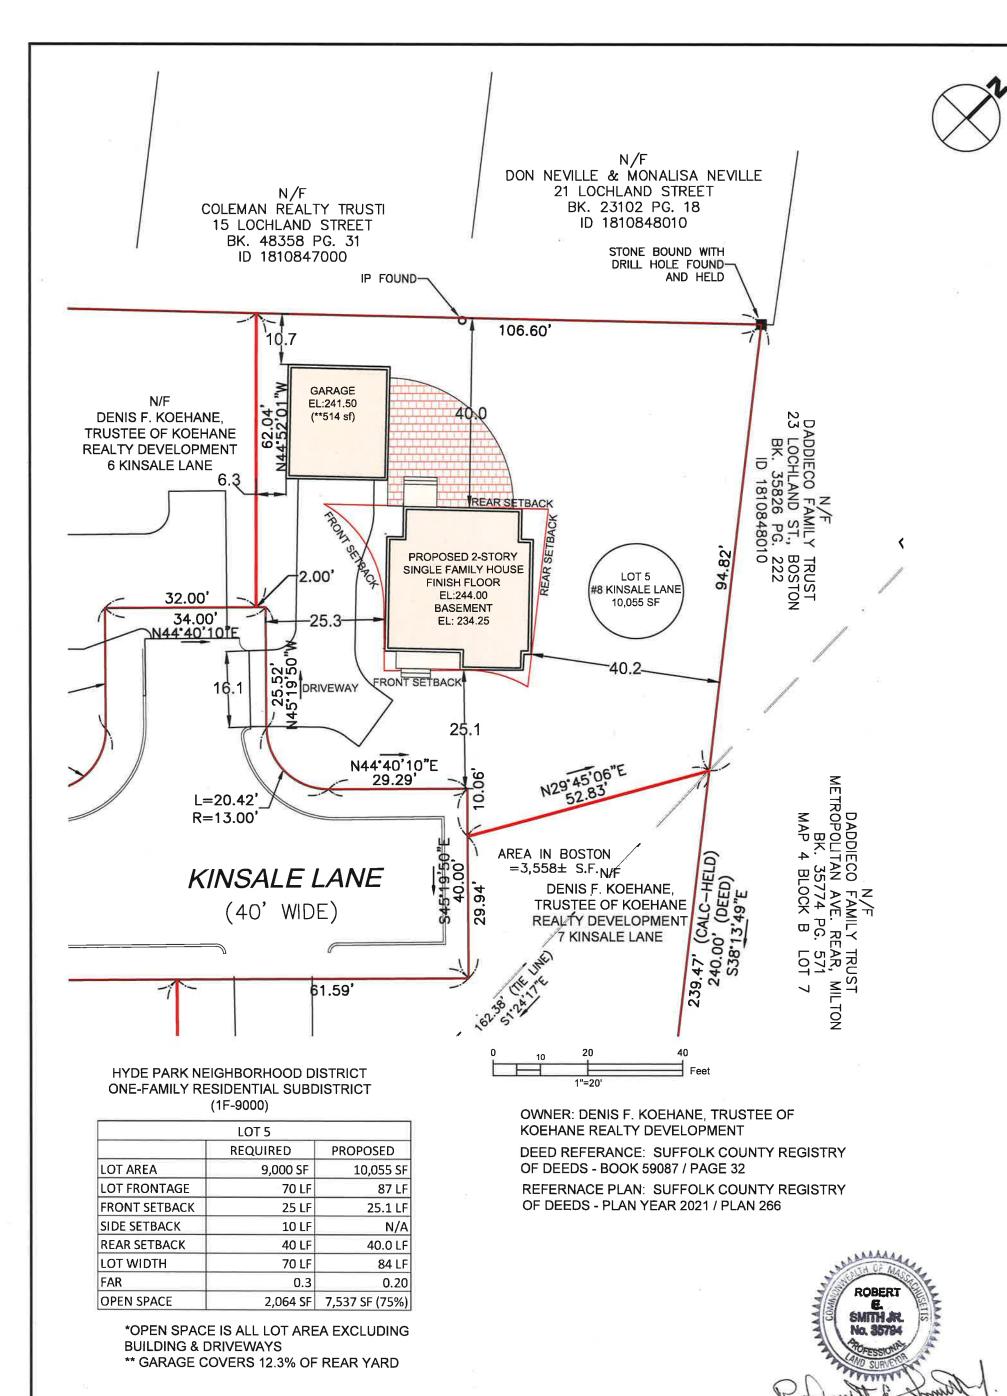



LOT 5 8 KINSALE LANE, BOSTON, MA SHEET NAME

CERTIFIED PLOT PLAN

SHEET NO.

C105


DR BY: GS

CHK BY: RS

PROJ NO: 2016-028


DATE: 10-05-2021

SCALE: 1" = 20'

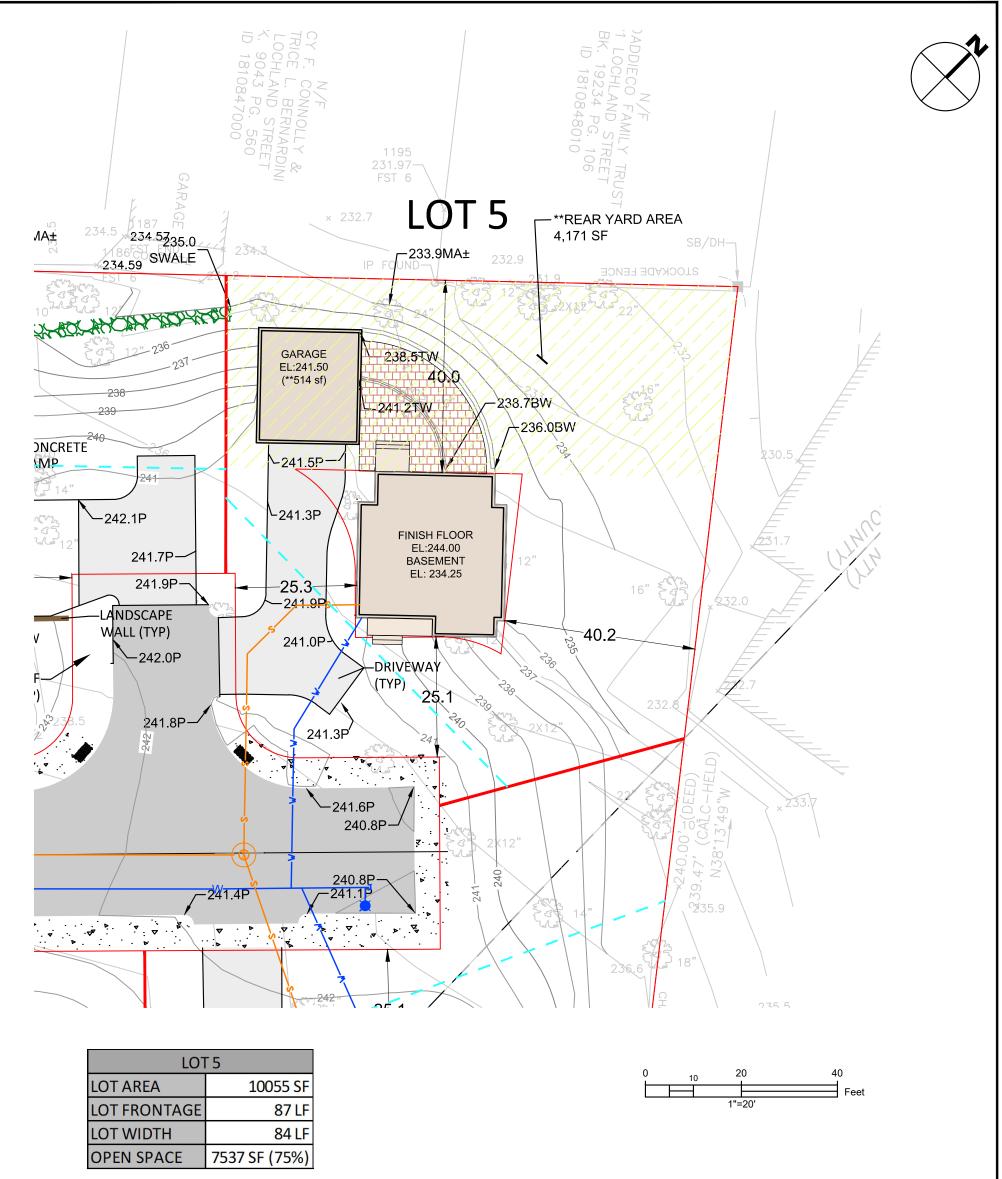


*OPEN SPACE IS ALL LOT AREA EXCLUDING BUILDING & DRIVEWAYS

LEGEND

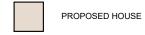

PROPOSED WALL

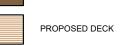

PROPOSED DRIVEWAYS

PROPOSED ROAD

PROPOSED CONCRETE

PROPOSED PATIO

PROPOSED COVERED PORCH

ACRONYMS
TW TOP OF WALL

TW TOP OF WALL
BW BOTTOM OF WALL
MA MATCH
P PAVEMENT
BOTTOM BOTTOM OF SLOPE
TOP TOP OF SLOPE





LOT 5 KINSALE LANE, BOSTON, MA SHEET NAME


SITE PLAN


SHEET NO.


C105


DR BY:	MH
CHK BY:	SBS
PROJ NO	: 2016-028
DATE:	04-06-2021
SCALE:	1" = 20'

^{**} GARAGE COVERS 12.3% OF REAR YARD

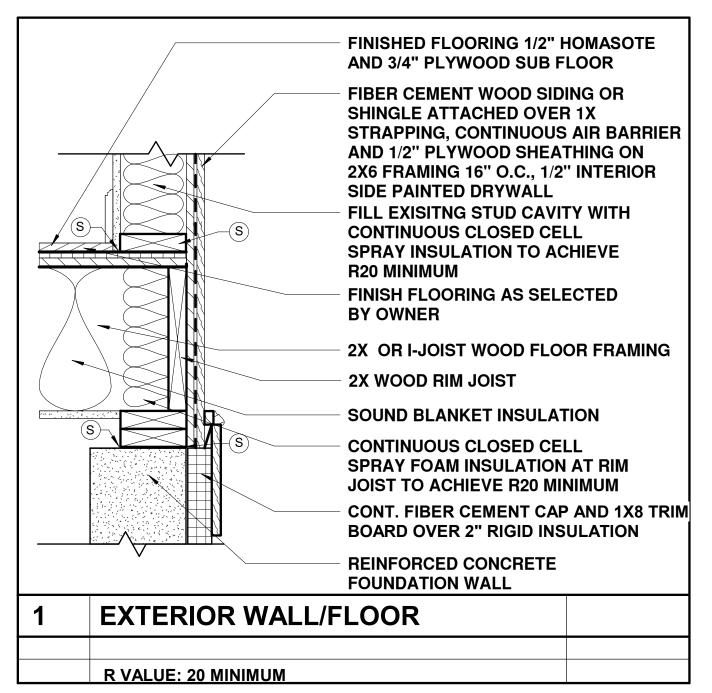

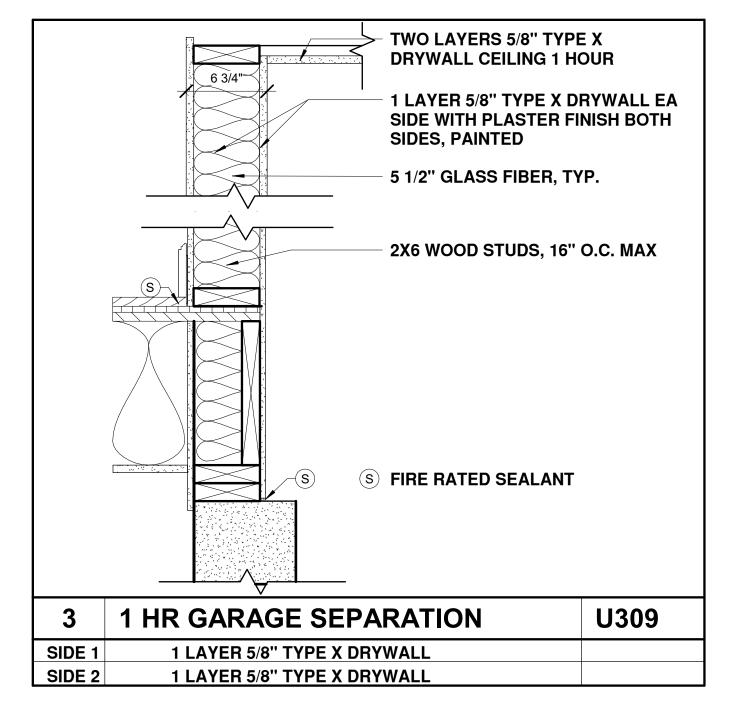

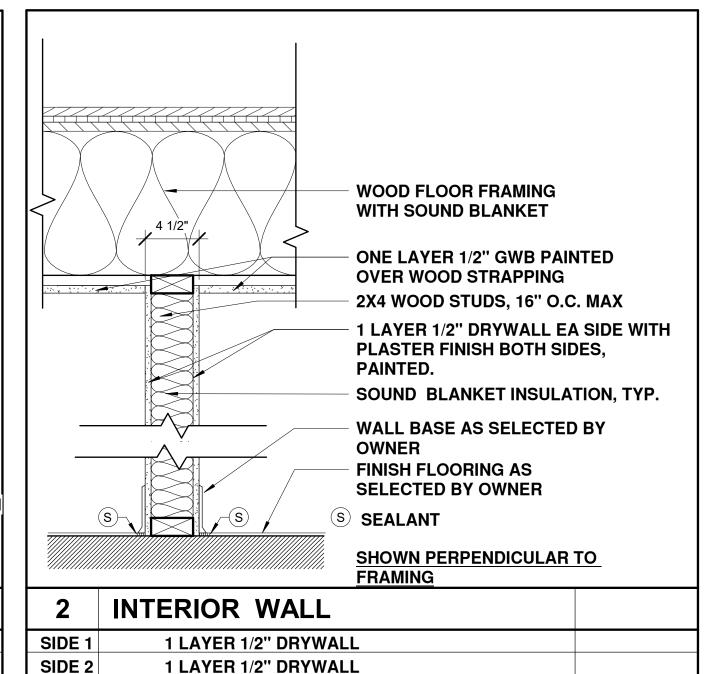

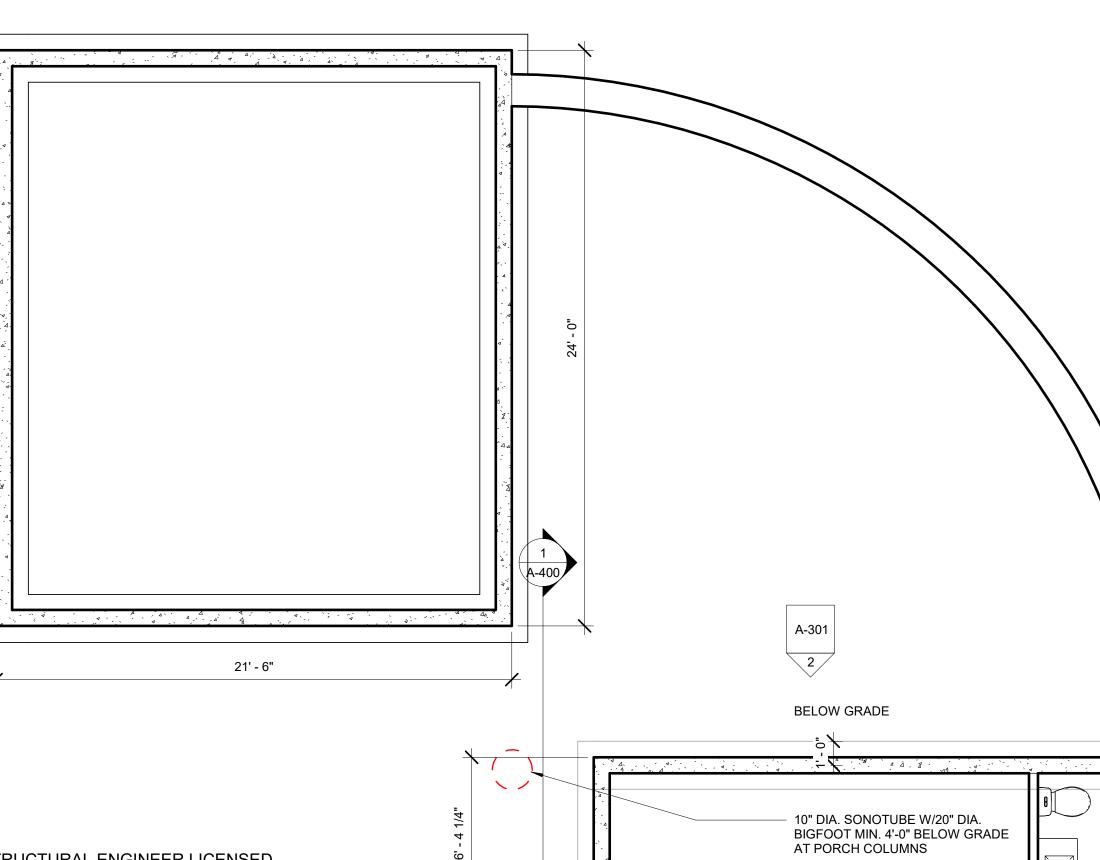

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1 BASEMENT 1/4" = 1'-0"

UP 16R@7.15"

15' - 10 7/8"

NOTE: BASEMENT LEVEL IS LESS THAN 65% ABOVE

GRADE AND NOT CONSIDERED THE FIRST STORY

A-300 2

TYPICAL 24" WIDE X12" DEEP

DOWELS 12" O.C.

POST UP AND

TYPICAL 4" REINFORCED

SLAB ON GRADE OVER 6 MIL VAPOR BARRIER

FOOTING,

CONTINUOUS CONCRETE WALL

FOOTING REINFORCED WITH (4) #5'S LONG WAY AND #5'S 12" O.C. SHORT

WAY IN BOTTOM OF FOOTING PLUS

BASEMENT

5

EL 234.25

└ - [→] 830 SF

TYPICAL 8" WIDE CONCRETE FOUNDATION

A-300

BELOW GRADE

13' - 6"

A-400

WALL WITH #5 REINFORCING BARS @12"
CONTINUOUS EACH WAY IN CENTER OF WALL

#5 X 4'-0" LONG FOOTING TO WALL


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CONCRETE GROUND SUPPORTED



Kinsale Lane Sub-Division

Hyde Park

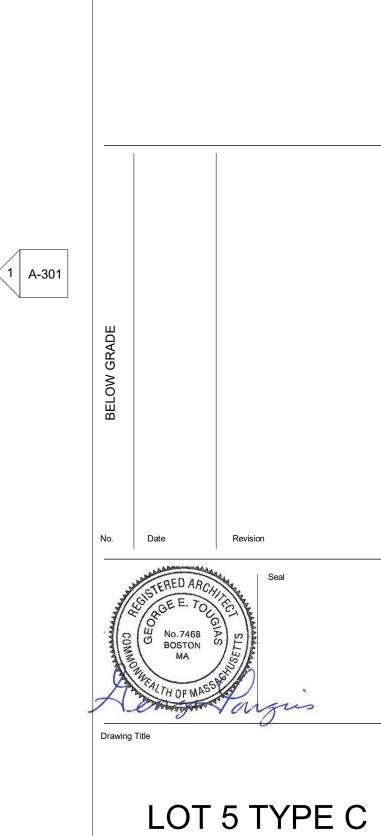

FOUNDATION PLAN NOTES:

3 WALL TYPES 1 1/2" = 1'-0"

THE FOUNDATION, FOOTING AND COLUMN SIZES SHALL BE DESIGNED BY A STRUCTURAL ENGINEER LICENSED IN THE COMMONWEALTH OF MASSACHUSETTS, STAMPED AND SIGNED.

1. SLAB ON GRADE TO BE 4" THICK SET OVER 6" OF 3/4" BANK RUN GRAVEL OR FREE DRAINING SOIL AND 6 MIL. VAPOR BARRIER. REINFORCE SLAB W 6X6XW2.0XW2.9 WWFSET 1-1/2" FROM TOP OF SLAB. CUT 1" RELIEF JOINTS IN SLAB @ 10-15 FR O.C. REMOVE ALL SOFT, ORGANIC OR UNSUITABLE MATERIAL FROM UNDER AND ADJACENT TO ALL FOOTINGS AND FROM UNDER ALL SLABS ON GRADE.

2. PROVIDE (2)2X6 PRESSURE TREATED SILL PLATE AT TOP OF FOUNDATION WALL. ANCHOR PLATE TO WALL W/ 5/8" DIA. X 1'-4" (4" HOOK) ANCHORS @48" O.C. AND AT ALL ENDS AND EACH SIDE OF CORNER OF FOUNDATION WALL.

OF FOUNDATION WALL.
3. BOTTOM OF EXTERIOR FOOTINGS TO BE 4'-0" MINIMUM BELOW FINISHED GRADE OR 8" BELOW BASEMENT

SLAB WHICHEVER IS LOWER.
4. ALL FOOTINGS SHALL BE CENTERED ON UNDER SUPPORTED MEMBERS.

5. SHORE, SHEET AND BRACE EXCAVATION AS REQUIRED TO ENSURE STABILITY AND SAFETY AT ALL TIMES.
6. ALL FOUNDATION WALLS SHAL BE BRACED DURING THE OPERATIONS OF BACK FILLING AND TAMPING BRACING

SHALL BE LEFT IN POSITION UNTIL PERMANENT RESTRAINTS HAVE BEEN INSTALLED.
7. NO FOOTING SHALL BE PLACED IN WATER. MATERIAL ADJACENT TO AND BELOW FOOTING SHALL BE KEPT FROM FREEZING AT AT ALL TIMES.

8. PROVIDE CONTINUOUS DRAINAGE PLANE AT FOUNDATION WALLS AND PERIMETER FOOTING DRAINS

CAST IN PLACE CONCRETE:

- 1. CONCRETE SHALL BE NORMAL WEIGHT TO ATTAIN A MINIMUM 28 DAY COMPRESSIVE STRENGTH OF 3000 PSI.
- 2.PROVIDE 6% AIR ENTRAINMENT IN ALL CONCRETE EXPOSED TO EARTH OR WEATHER.
- 3.PROVIDE DOWELS AND 2X4 KEY WAYS AT ALL CONSTRUCTION JOINTS. ALLOW 48 HOURS TO ELAPSE BETWEEN ADJACENT SLAB POURS. FOUNDATION WALL CONSTRUCTION SHALL BE KEYED AND SPACED AT 40'-0" MAX 4. ALL FORM WORK SHALL REMAIN IN PLACE FOR A MINIMUM OF THREE DAYS.
- 5. PROVIDE RELIEF JIOINTS INALL SLABS ON GRADE 10' O.C. IN EACH DIRECTION.
- 6. NOTIFY THE SITE BUILDING INSPECTOR IN ADVANCE OF PLACING CONCRETE FOR INSPECTION OF THE REINFORCING STEEL. DO NOT CAST CONCRETE UNTIL THE INSPECTION HAS BEEN SATISFACTORILY SIGNED OFF.

REINFORCING STEEL:


1.REINFORCING STEEL SHALL CONFORM TO ASTM A615 GRADE 60 AND WELDED WIRE FABRIC SHEETS SHALL CONFORM TO ASTM A185.


2. BARS SHALL BE SHALL BE RUN CONTINUOUSLY AROUND CORNERS, DOWELED INTO INTERSECTED WALLS, LAPPED AT NECESSARY SPLICES AND WITH SPLICES STAGGERED WHERE POSSIBLE AND HOOKED AT DISCONTINUOUS ENDS.




A100

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— CATHEDRAL CEILING ROOMS BELOW ———

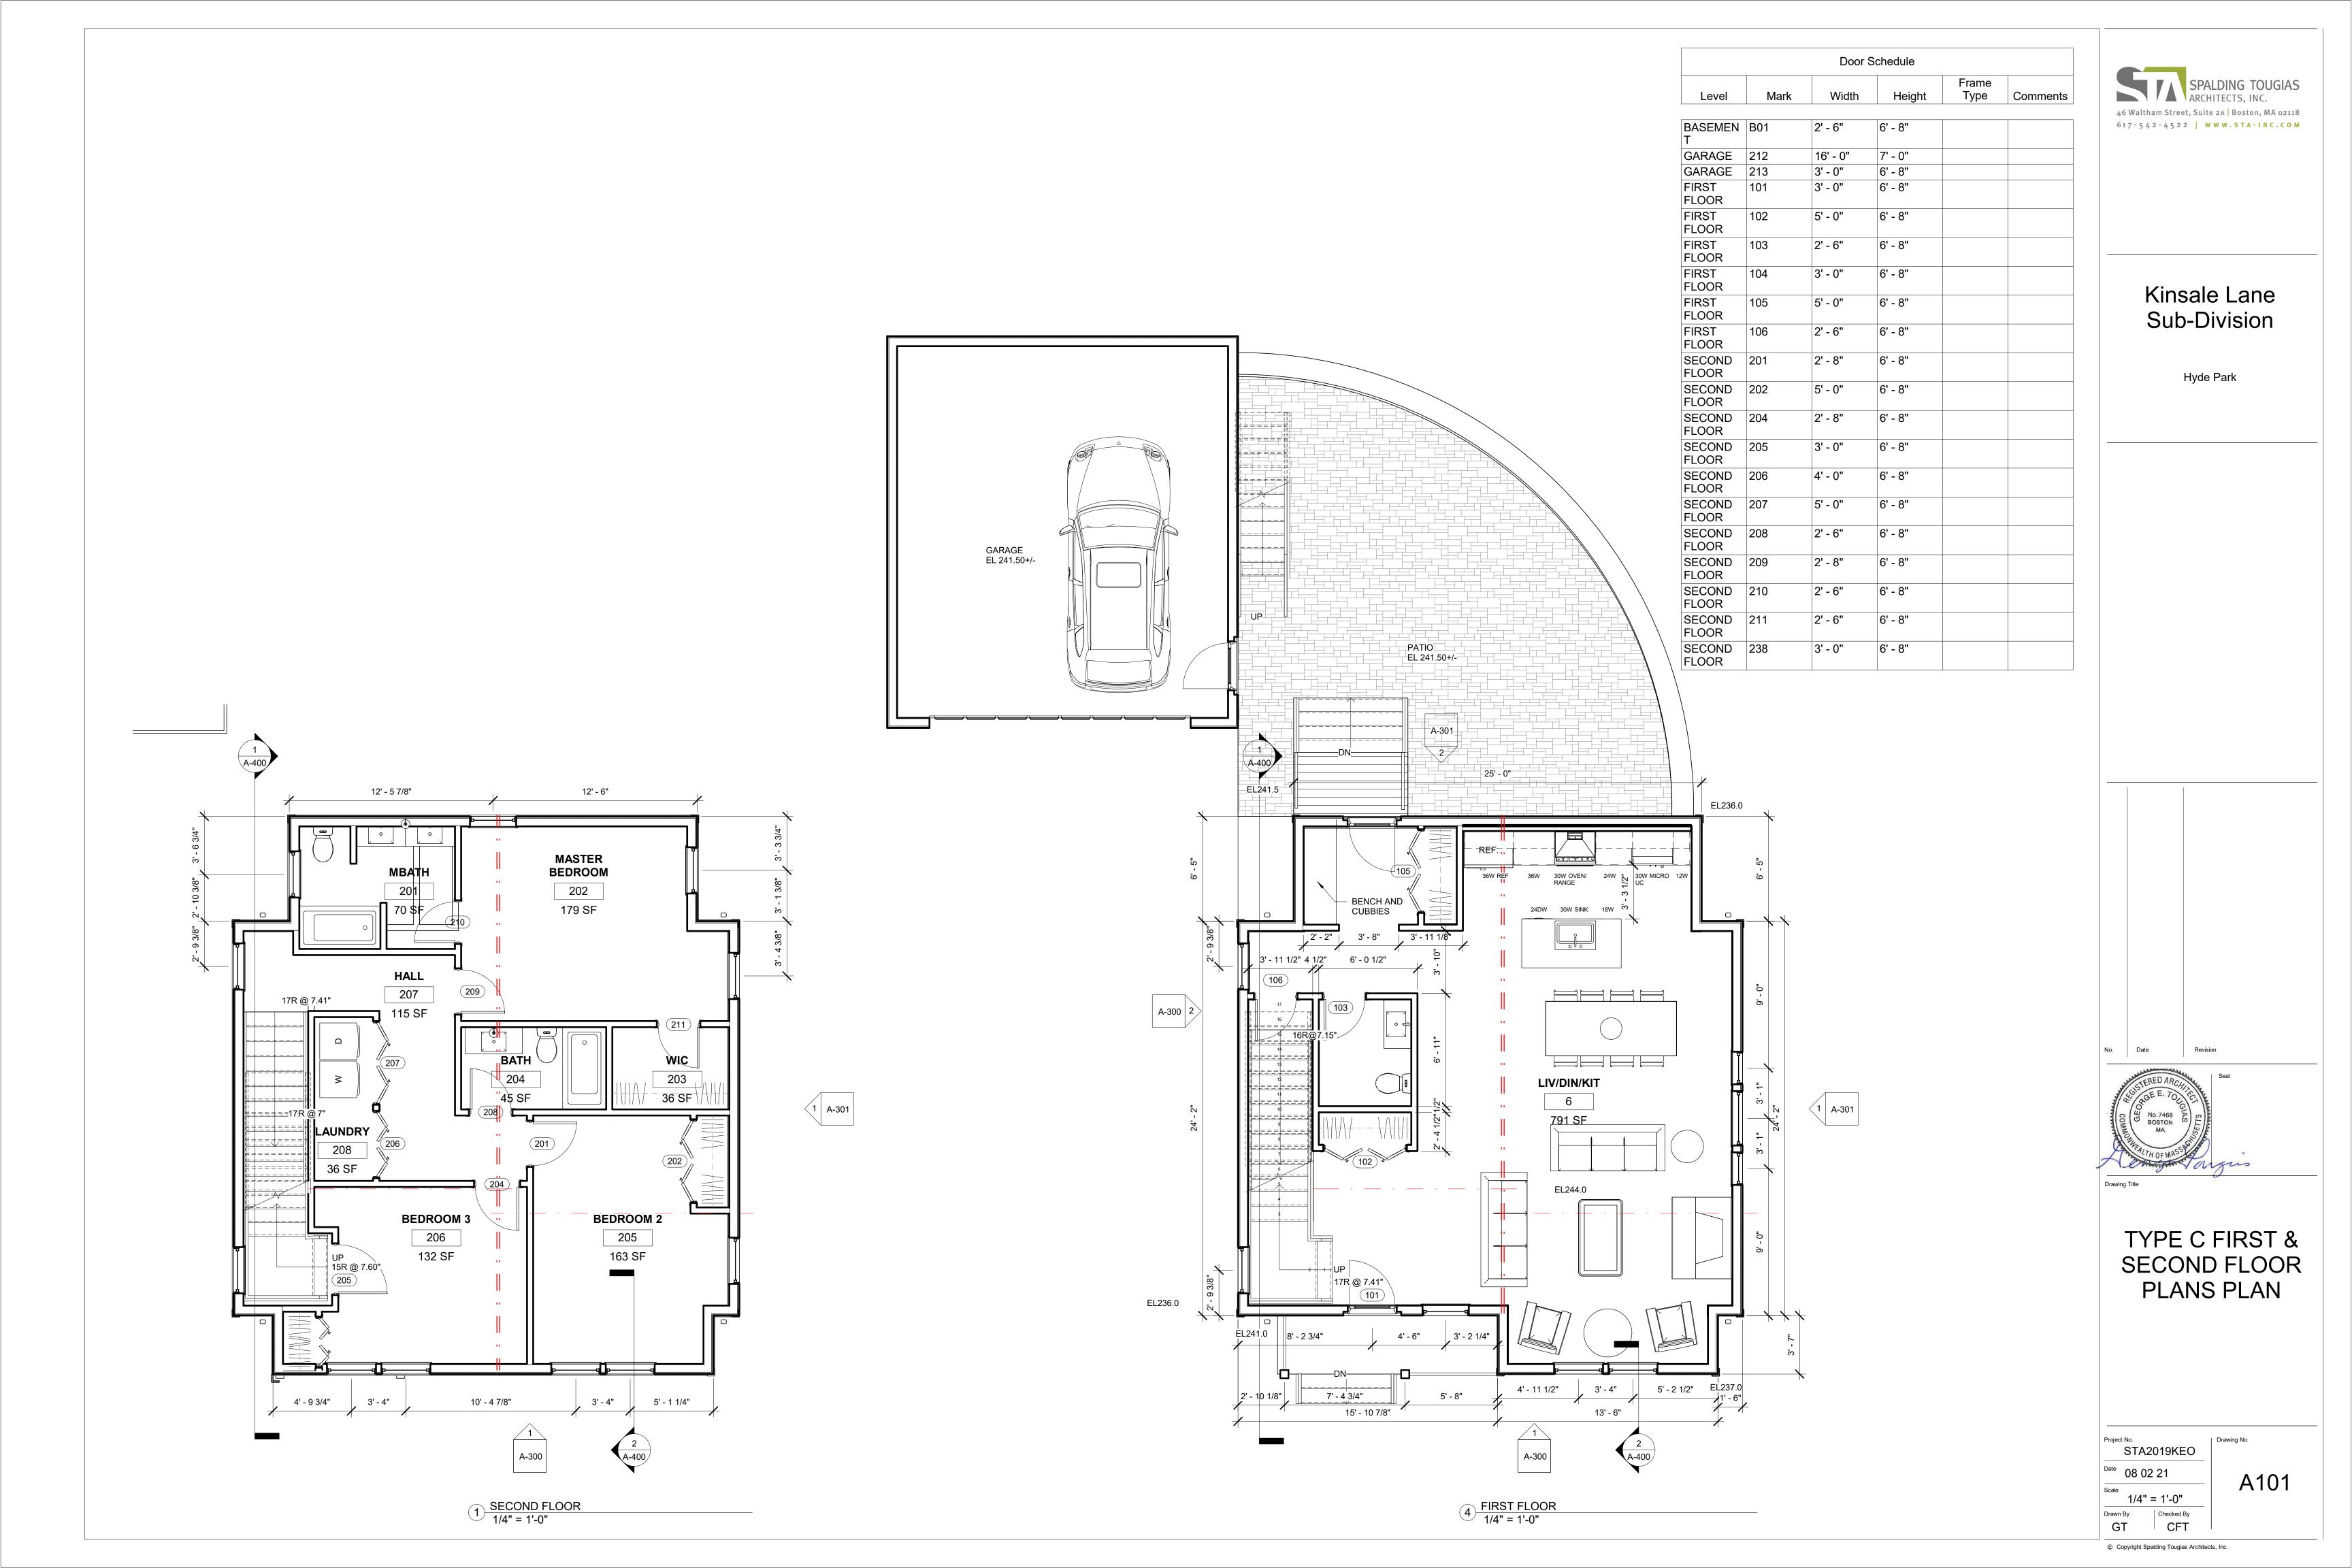NOTE: ATTIC IS 495 SF MEASURED 4'-0" AFF AND (495 SF/1006 SF SECOND FLOOR = 49.5%) IS 50% OR LESS THAN 1/2 THE AREA OF THE SECOND FLOOR PER HALF STORY DEFINITION.

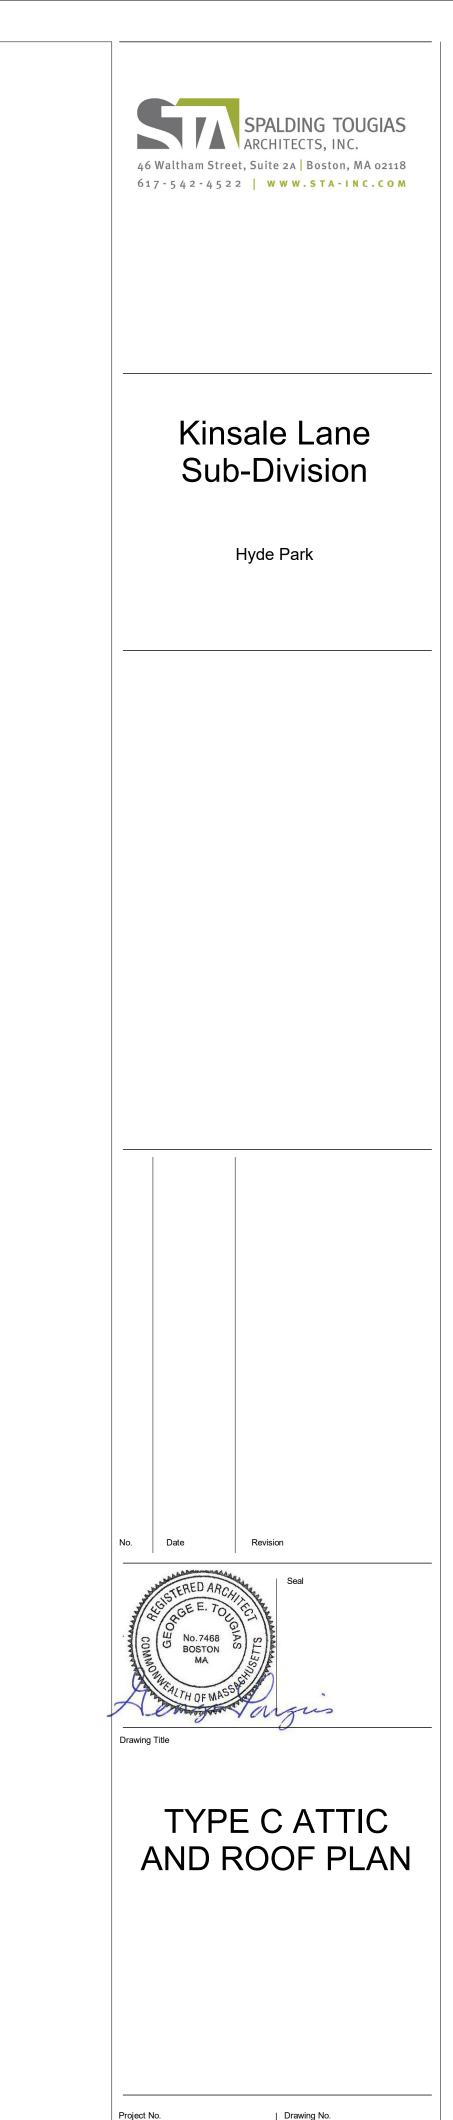A-300 2

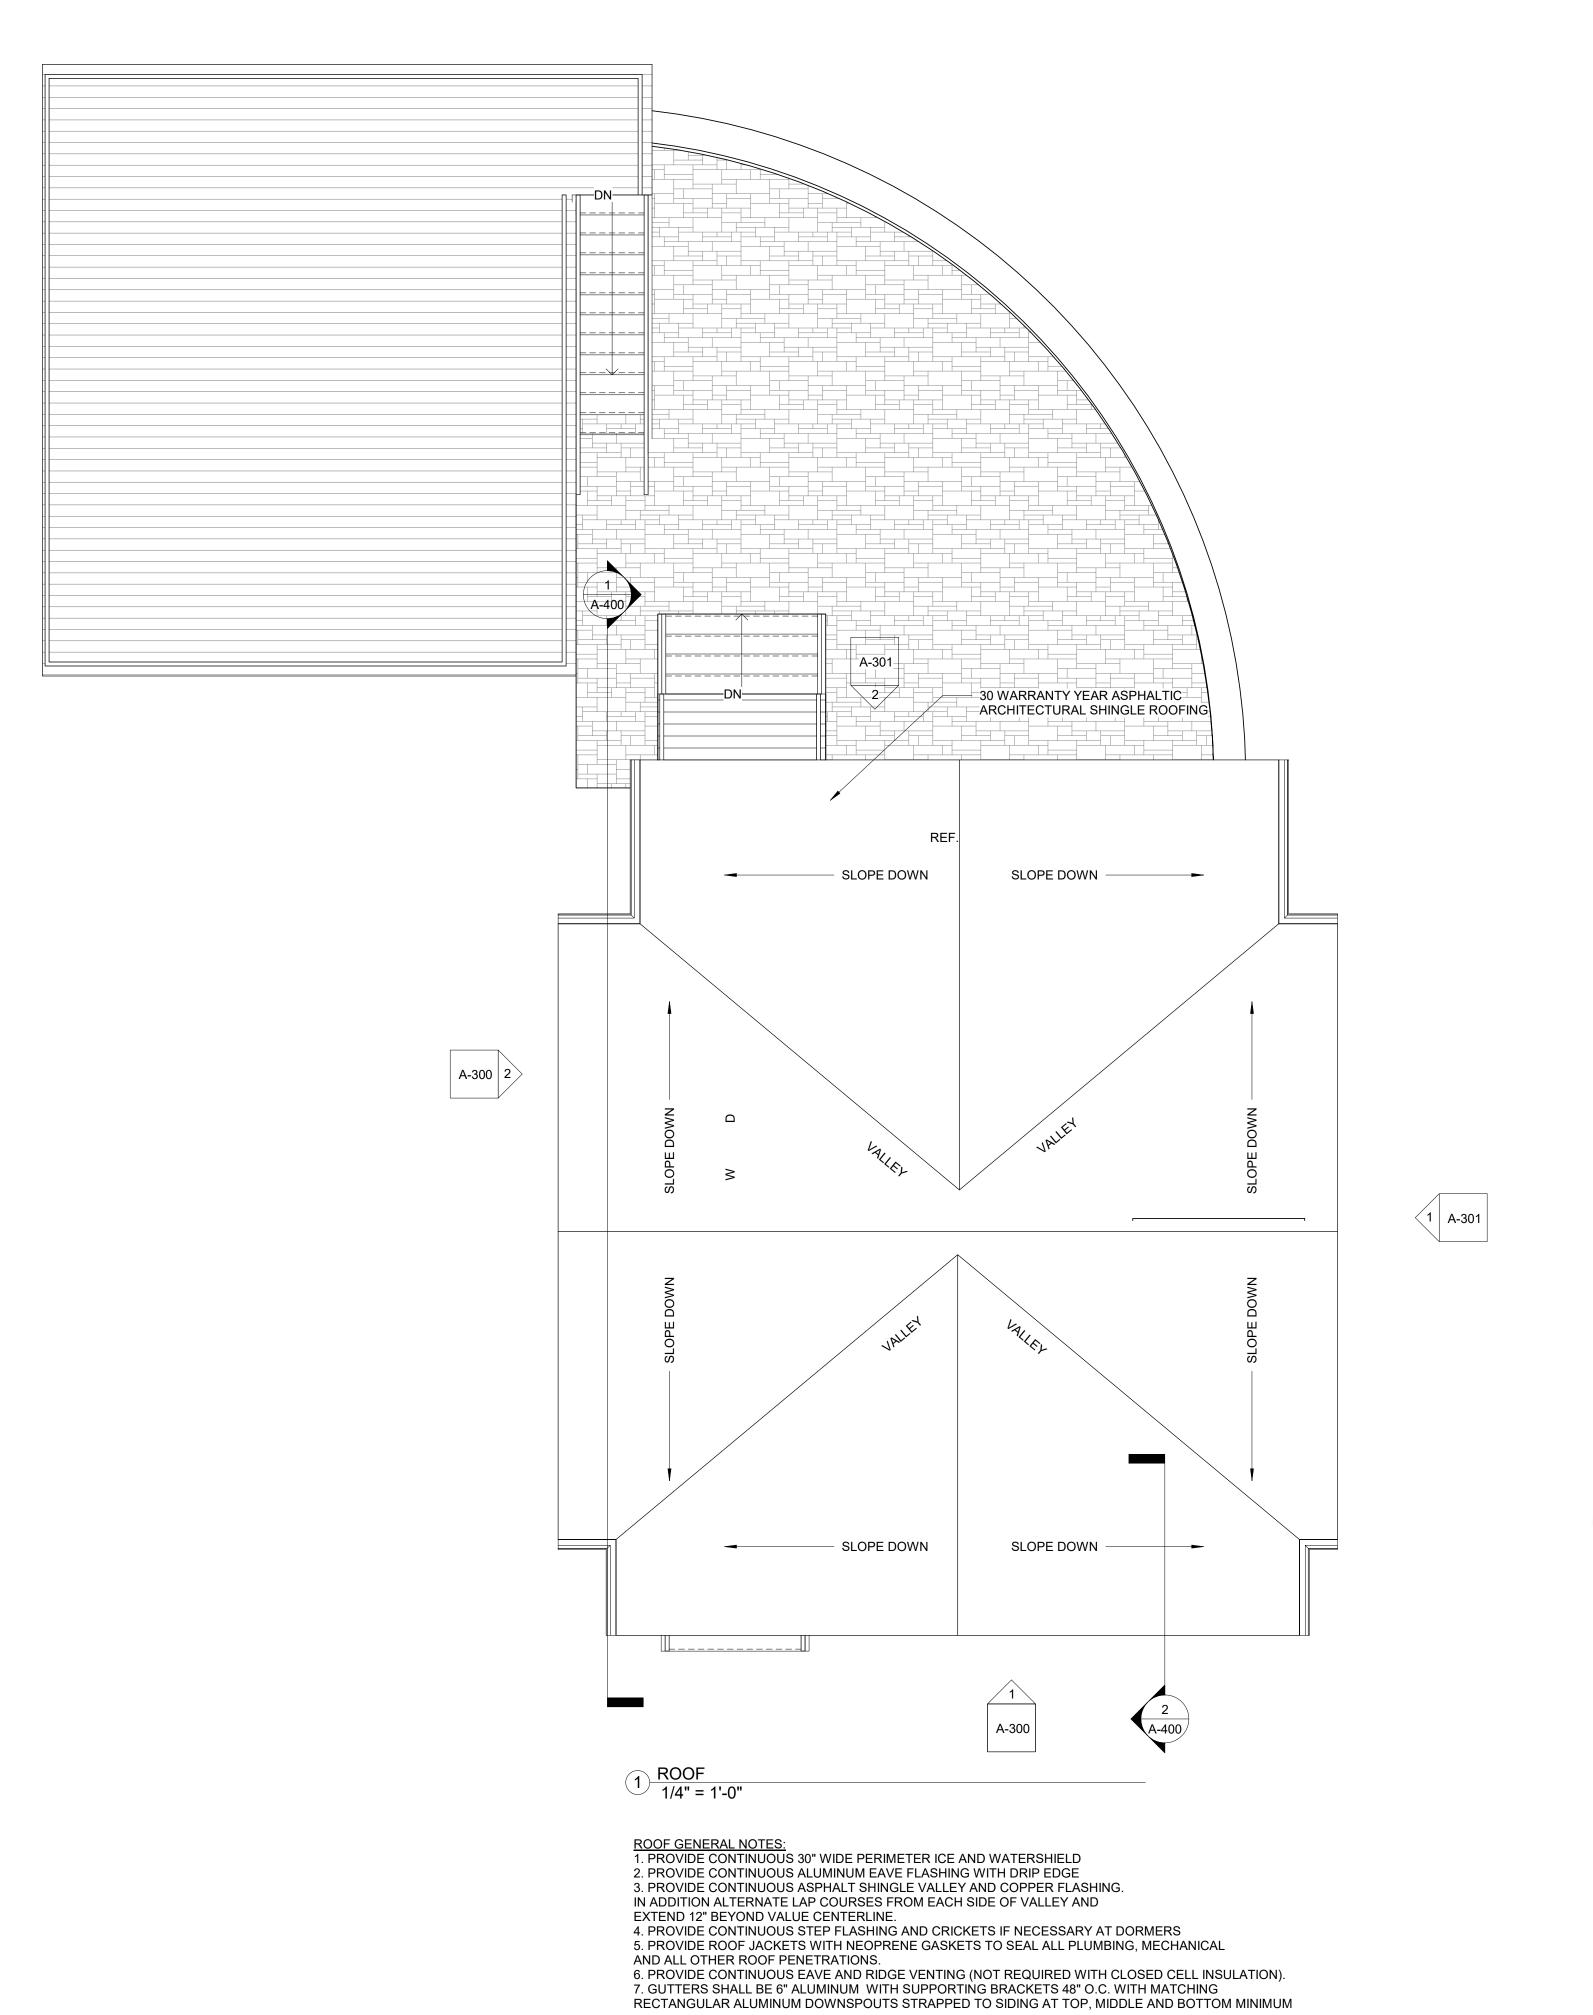DN 15R @ 7.60"

2 ATTIC 1/4" = 1'-0"

STA2019KEO Date 08 02 21


> 1/4" = 1'-0" CFT


A102

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Kinsale Lane **Sub-Division**

Hyde Park

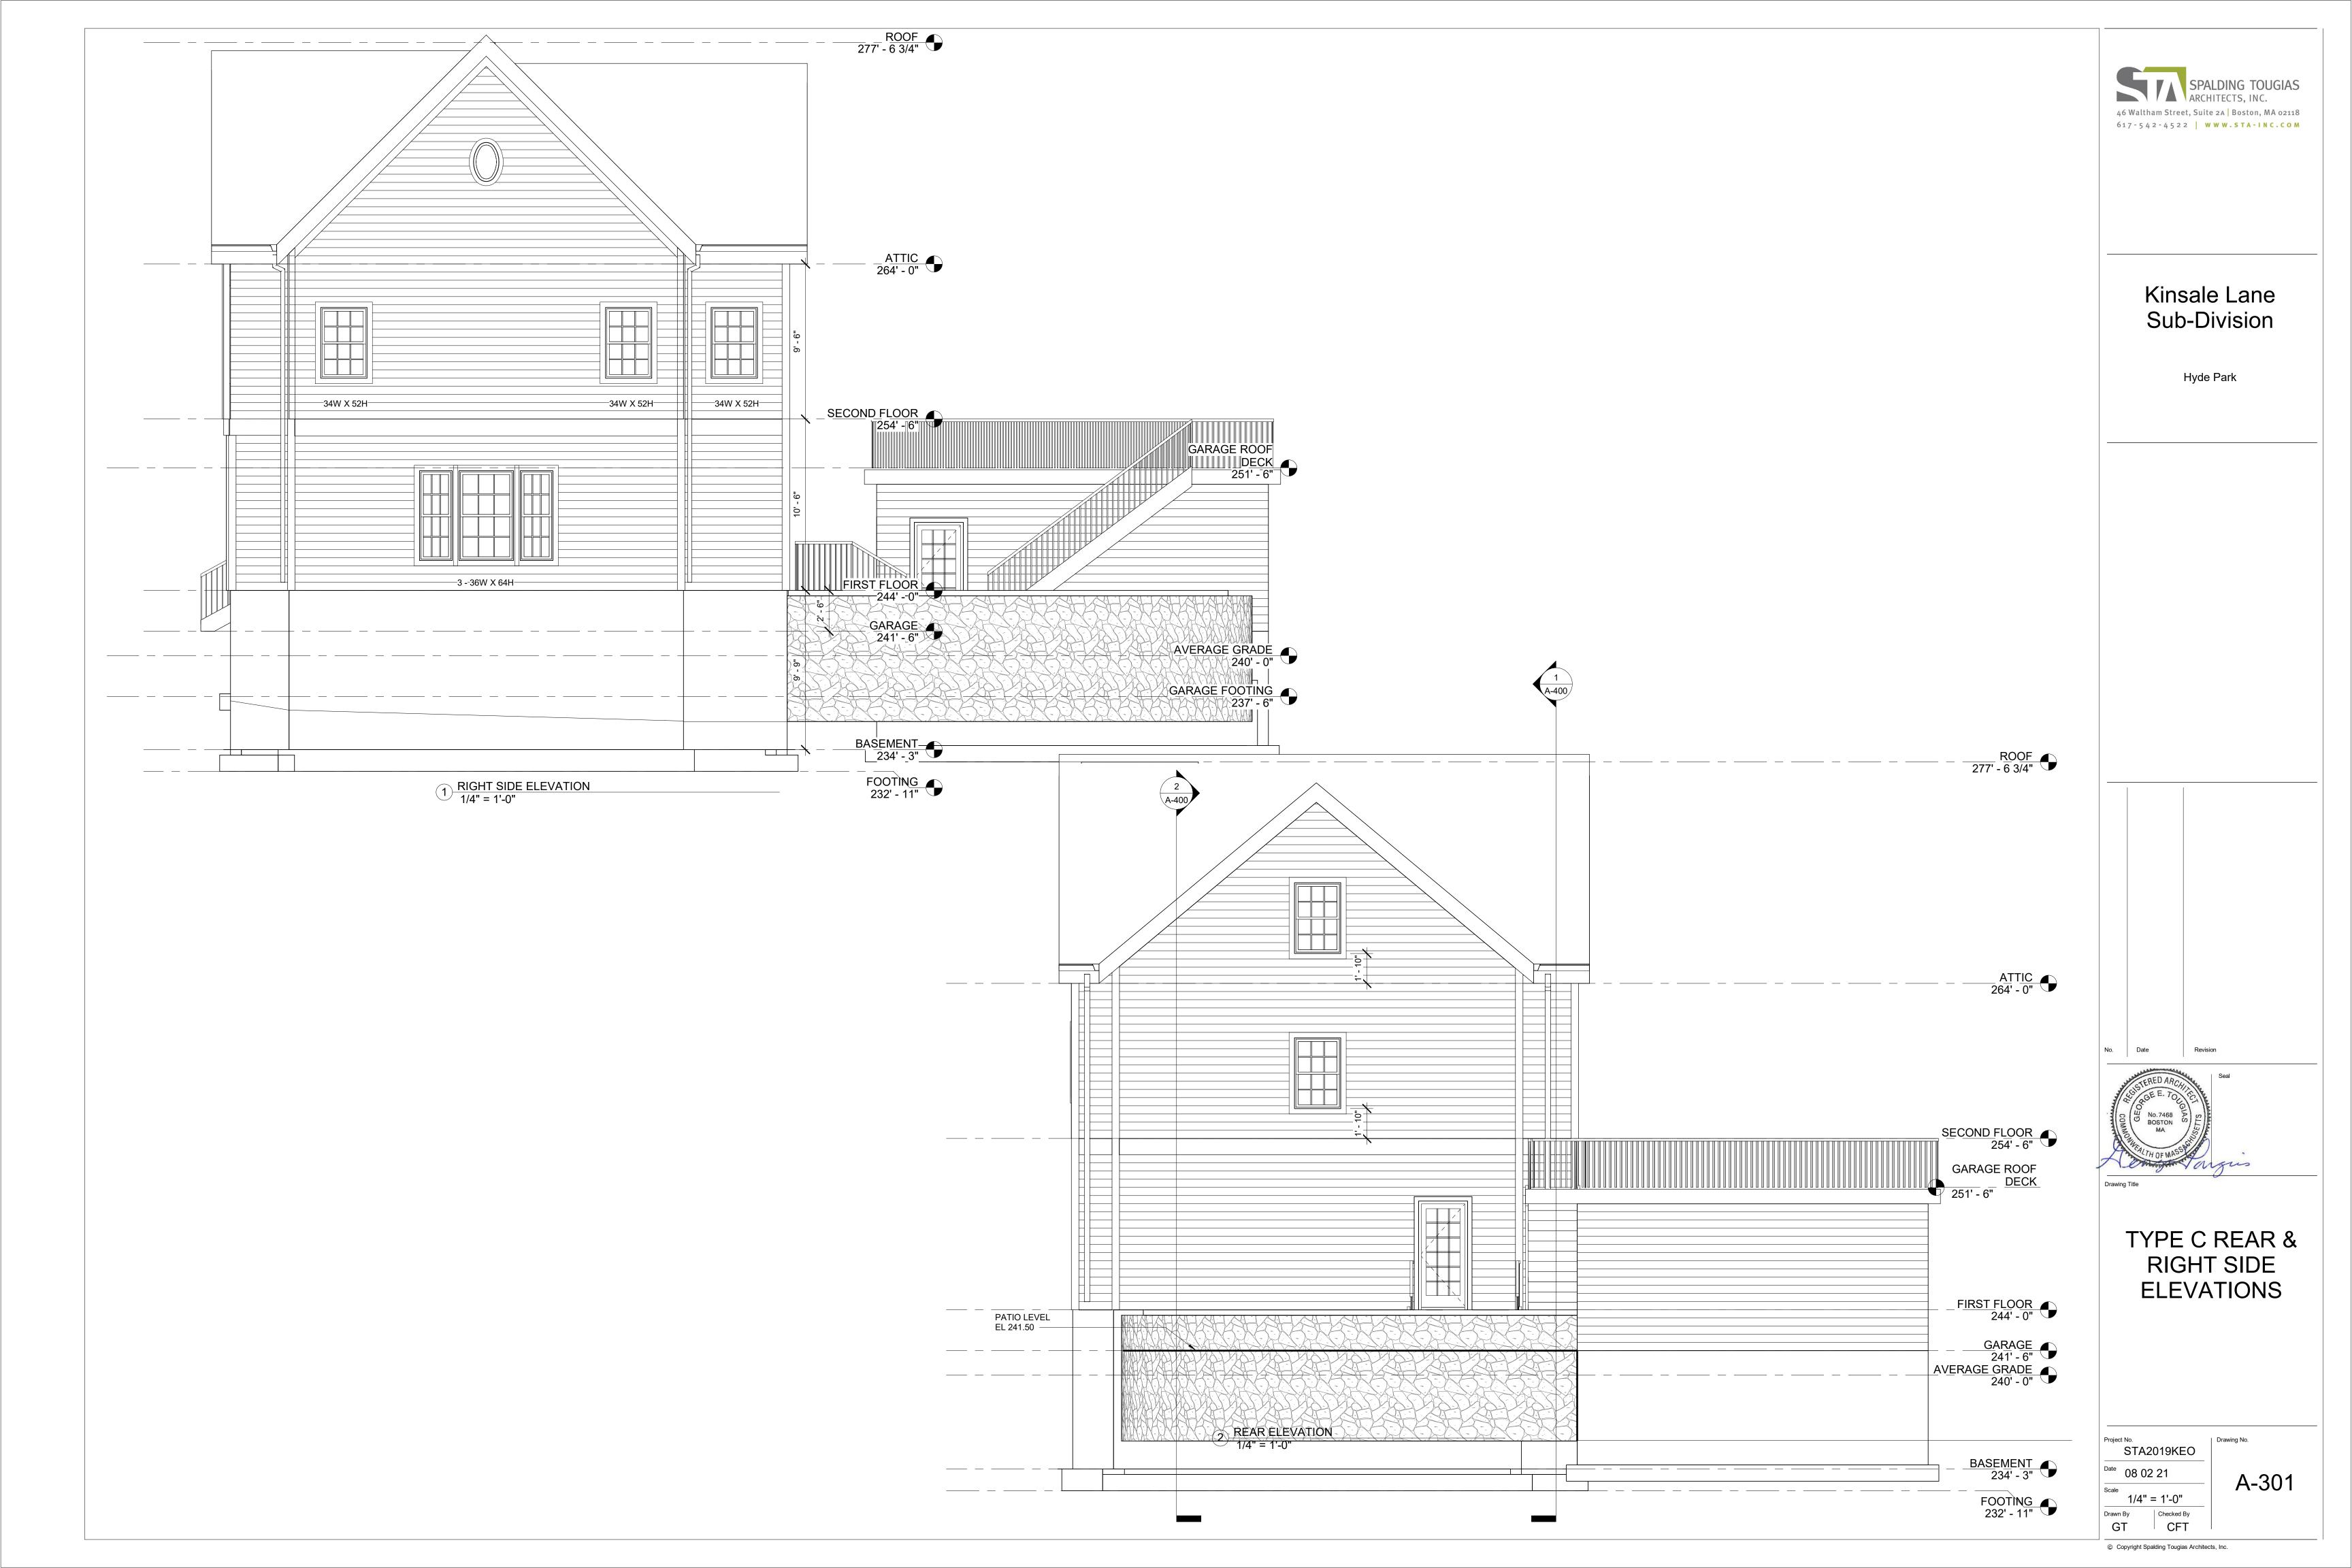

TYPE C BUILDING **SECTION & WALL** SECTION

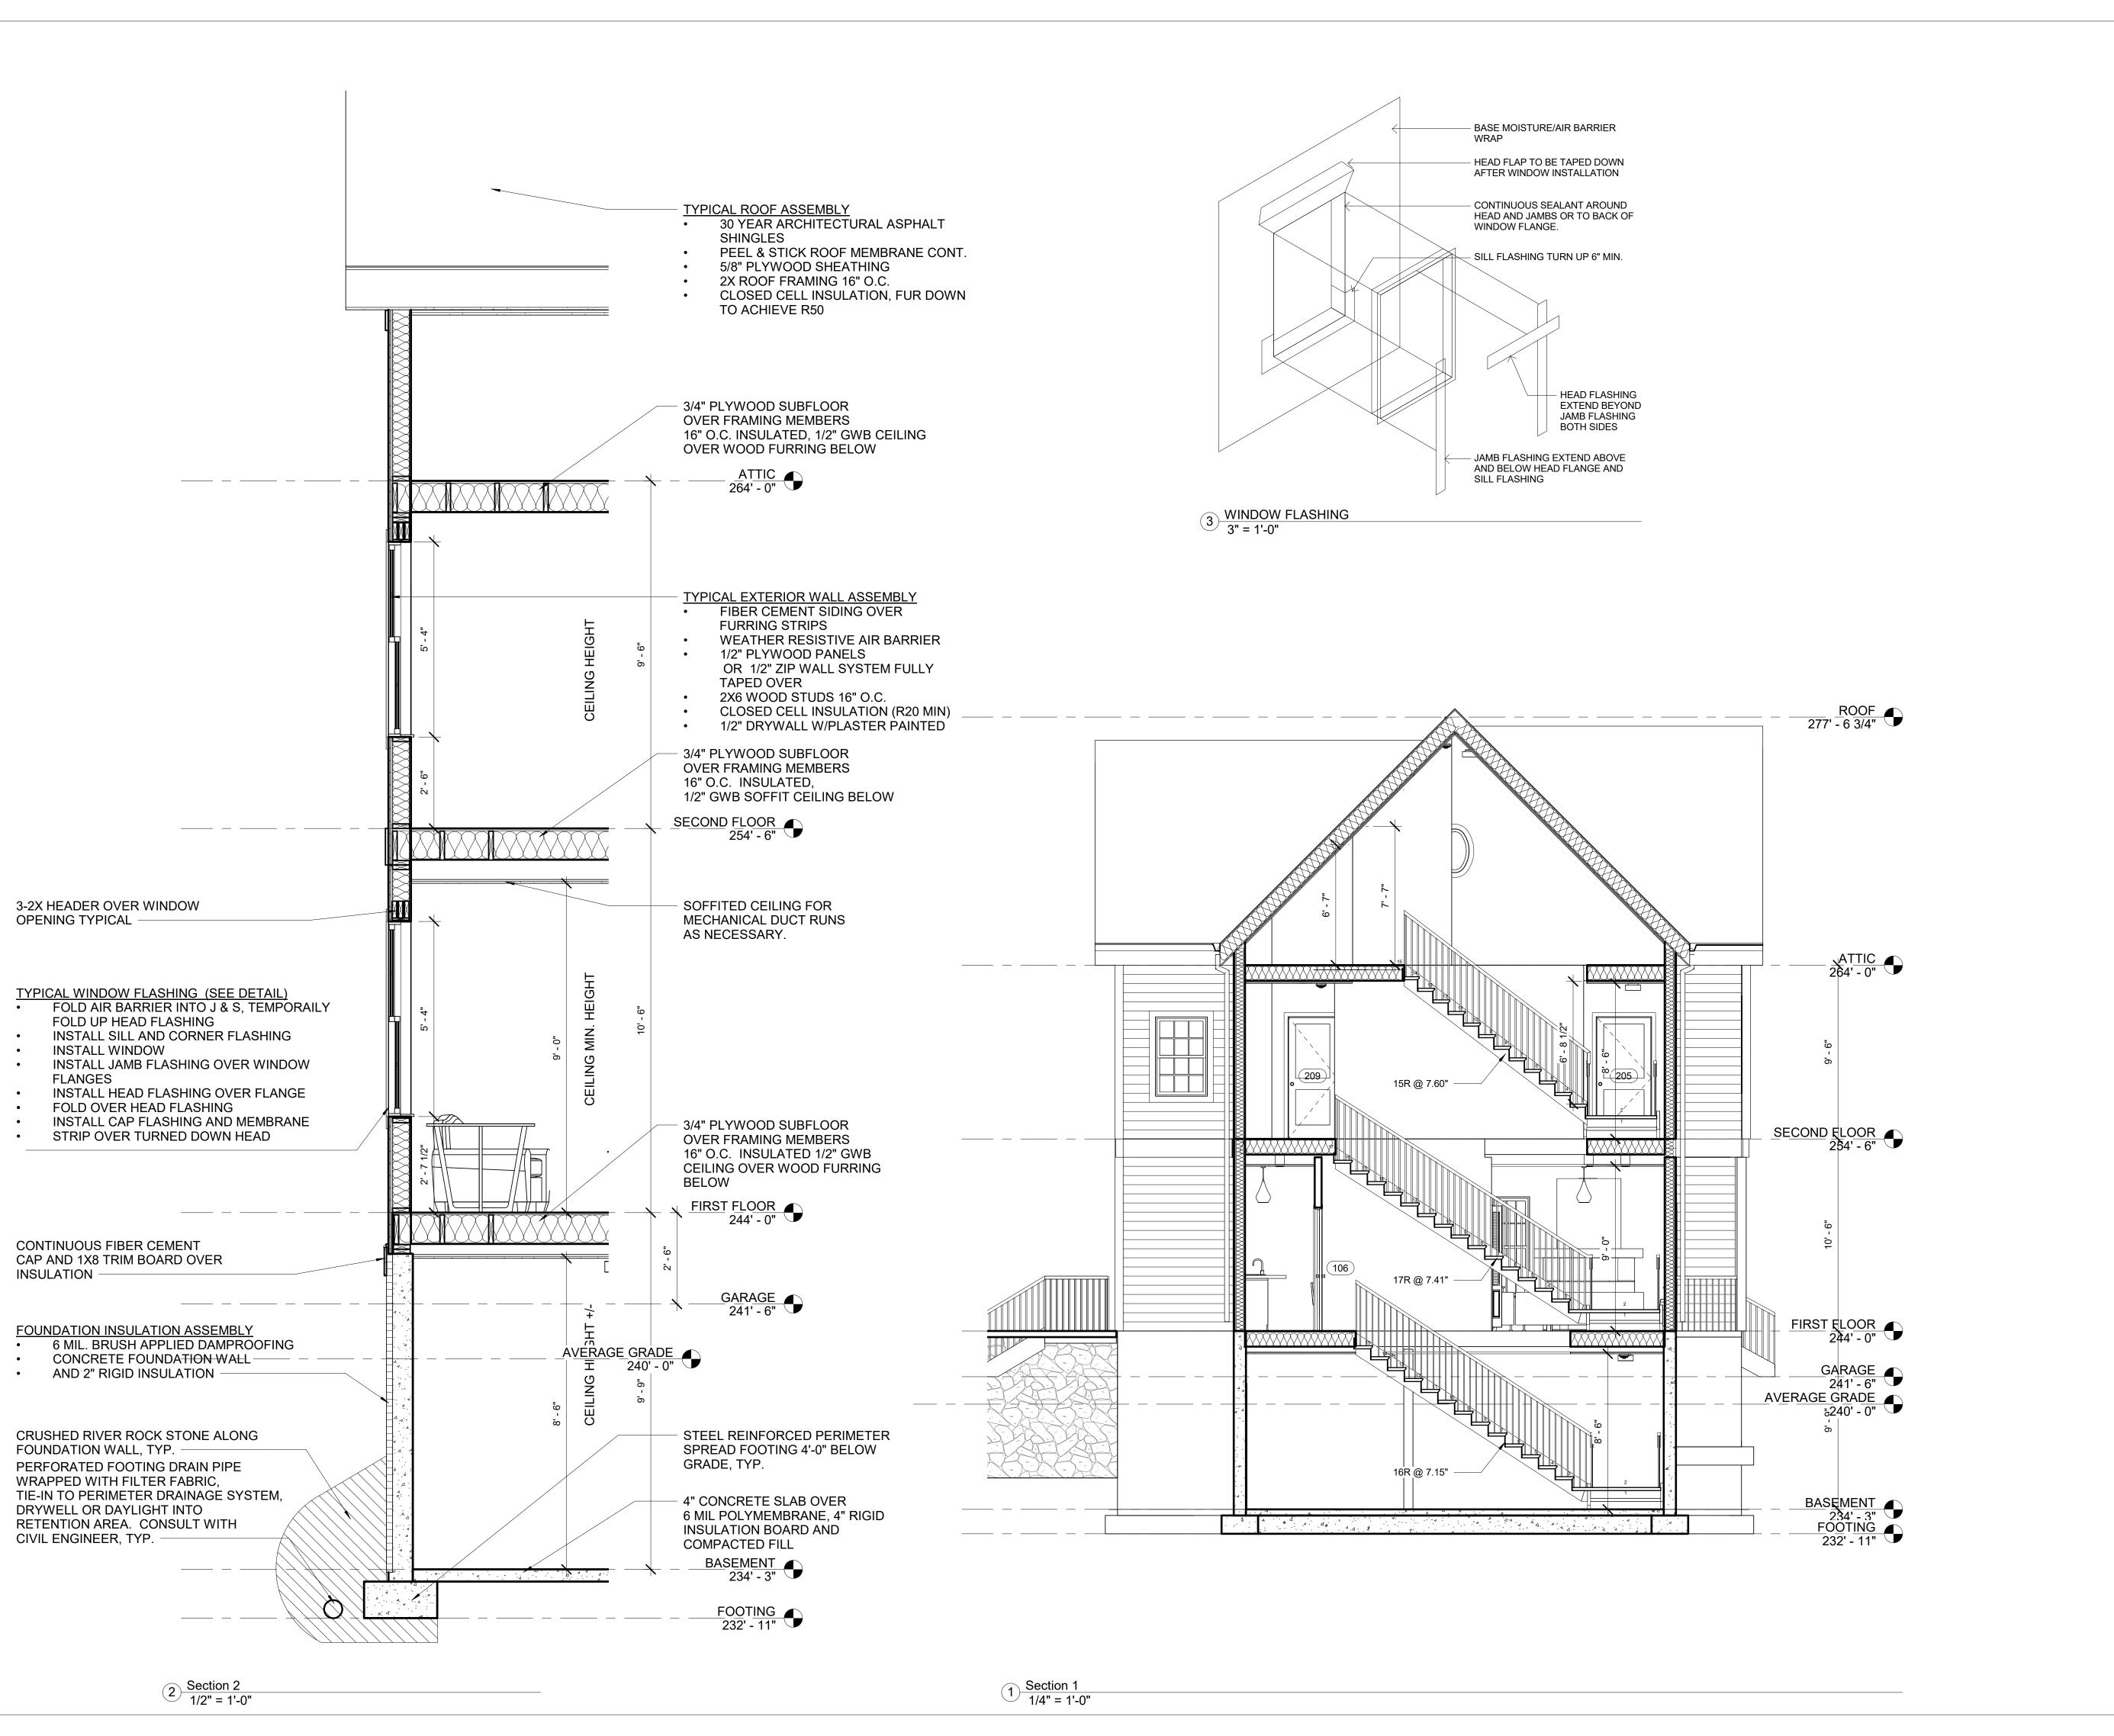STA2019KEO

GT

05 12 21 A-400 As indicated

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CFT