Planning Department Design Review Provisos 173-175 Walnut Street, Dorchester Boston, MA NDOD 18 August 2025



08/28/2025

General

- 1. All changes to the exterior and/or site plans shall be submitted to the Planning Department for review and approval.
- 2. All building improvements shall be completed *prior to issuance of occupancy permit by ISD* unless prior approval is granted by the Planning Department.
- 3. All site improvements, including but not limited to hardscape and plantings, must be completed *prior to issuance of occupancy permit by ISD* unless prior approval is granted by the Planning Department for a delay in completing the site improvements.

Landscape/Street/Site

- 4. All new trees shall have a minimum caliper of 3-inch caliper.
- 5. Existing trees on the parcel shall be prioritized for preservation when considering lot coverage and building footprint. Mature, healthy and native trees of 6" caliper and above are particularly significant and should be protected to the greatest extent possible. Where impacts are unavoidable and trees must be removed, trees shall be mitigated as specified in the following:
 - a. Tree replacement shall be based on 1:1 ratio, based on caliper size of removed trees.
 - b. Replacement trees are to be planted in landscaped areas within the project site, or off-site in the near vicinity (in open pits or other available areas in the general location of the project), with approval by the City.
 - c. The Proponent shall be responsible for installation of trees, and maintenance of newly planted trees for at least 24 months after the date of Final Inspection, or issuance of a Certificate of Occupancy.
- 6. Existing street trees within the public right of way are to be protected and retained. Building, building protrusions, and construction shall not negatively impact the existing street tree, critical root zone, nor impede the healthy growth of the tree's canopy.

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BOSTON REDEVELOPMENT AUTHORITY

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- a. Where impacts are unavoidable and public street trees must be removed, the proponent must apply for tree removal approval from the City's Tree Warden and provide mitigation as specified by the Parks and Recreation Department.
- 7. Fences shall be of high-quality material; wood or metal is preferred. Chain link fencing is not preferred, especially in front yards; if chain-link is used, it must be vinyl-coated chain link in combination with landscaping. Fences shall not be higher than 6'-0" without ZBA approval. Fences of 6'-0" height are only allowed for rear yards. Front yard fences should not be taller than 42" (3'-6").
- 8. Screening and buffering shall be provided along the side yards to ensure privacy for you and your neighbors. The planting buffer should contain a mix of deciduous and evergreen trees and shrubs. The use of bulbs, perennials, and annuals are encouraged. A minimum five (5) foot wide buffer is encouraged.
- 9. Parking shall be located in the rear, as such that it is not visible from the public realm, wherever possible. Parking shall not be located in the front yard. Screening and buffering shall be provided between parking and the public right of way, and from your neighbors if space allows. A minimum five (5) foot wide buffer is encouraged. Parking shall not be partially covered by the building; it should be wholly within the footprint of the building and screened or entirely outside the building footprint.
- 10. Curb-cuts should be limited to 10ft wide for residential projects, and 20ft wide for commercial projects. The pedestrian sidewalk must be continuous over the access driveway.
- 11. Driveway widths should be limited to 10ft wide. If necessary, driveways may taper from curb-cut dimension to the width of the garage opening.
- 12. Permeable surfaces are encouraged on site; use permeable paving for any necessary paved surfaces and increase the vegetative cover as much as possible through the inclusion of ground-level plantings, green roofs, and porous surfaces. Project sites located in a Groundwater Conservation Overlay District (GCOD) are strongly encouraged to maximize permeable surfaces on their site.
- 13. Public sidewalks fronting the project site should be upgraded to meet the Americans with Disabilities Act (ADA) minimum 4' wide clear path of travel (exclusive of the 6" curb).
- 14. Projects are encouraged to provide usable open space for its residents. Open space at the ground level is encouraged to contribute to an active and engaging public realm, such as at-grade courtyards or garden spaces. Balconies, terraces, accessible rooftops, green roofs, and other means of providing above-grade amenities are also encouraged.

Docusign Envelope ID: 24065AC1-2C8C-43D6-9941-E80629DF0796

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Building

- 15. No more than 12" of the foundation shall be exposed.
- 16. Masonry: Brick veneer must be at least one full wythe of brick deep. Thin brick will not be allowed.
- 17. Stucco: Stucco must be a traditional hard-coat stucco exterior system. An Exterior Insulation and Finish System (EIFS) is not approved.
- 18. Siding: No vinyl or aluminum siding will be allowed. Clapboards shall be wood or fiber-cement. Shingles shall be wood or fiber-cement. All trim (corner boards, door/window casings, soffit/fascia trim, skirt boards, frieze boards, etc.) shall be wood or fiber cement with a painted finish.
- 19. Doors: All doors including garage doors should be wood. Metal or vinyl doors will not be allowed. Fiberglass doors may be considered as long as the detailing and finish matches wood doors and has a painted finish. All doors facing the street including garage doors shall have translucent panels.
- 20. Windows: Windows should be wood or wood clad in another material, such as aluminum, fiberglass, or vinyl. All vinyl windows will not be allowed. All windows shall have exterior muntins and half screens.
- 21. Window and door trim shall have the following minimum dimensions: 4" casings with 5" or 6" trim at head. Cornerboards shall be 8" wide at minimum.
- 22. All front porches and the rear porches shall have wood (fir, mahogany, redwood, etc.) square edge decking, select painted pine trim at exposed stringers, skirt boards, platform trim, stair risers, column trim, painted fir top and bottom rails and balusters. Porch ceilings shall be bead board and all stairs shall have closed risers. All lattice shall have a painted finish. Pressure treated lumber shall be covered and shielded from the public views on the site. Composite materials can be considered for porches.
- 23. Pressure treated lumber will not be allowed as an externally visible material for exterior decking. All pressure treated wood exposed to public views on the site shall be covered and shielded from view. Use of PVC, composite, and/or natural wood materials is acceptable.
- 24. Access to roof decks shall be through a hatch, not headhouse.
- 25. Where applicable: Dormers: Shed dormers should have a slope ratio of 3.5 to 12 minimum. They shall be held from the sides of the roof 3'-0" and from the edge of the roof (in the direction the dormer faces) 1'-6" or the minimum dimension is necessary to allow a visible portion of roof to pass in front of the dormer.
- 26. Where applicable: Dormers: Gable dormers shall be held down from the roof ridge 1'-0" minimum. They shall be held from the sides of the roof 3'-0" and from the edge

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page 4 of 4

of the roof (in the direction the dormer faces) 1'-6" or whatever minimum dimension is necessary to allow a visible portion of roof to pass in front of the dormer.

Mechanical

- 27. The final location of the HVAC compressors, gas meters, electric meters, generators, switchgear, and transformers shall be adequately screened from public view and will not be allowed in the front yard.
- 28. All mechanical vents shall be through the roof or rear wall and shall not be visible from the public street. Vents located on elevations that do not directly face a public way should be composed on the facade so as to minimize their appearance.

Project Specific

29. All insulated glass windows and doors with mullions and/or muntins must have specifications that state, true simulated divided lites with black spacers. This label must appear on all elevations where these windows occur.



08/28/2025



PROPOSED 14-UNIT RESIDENTIAL DEVELOPMENT 173-175 WALNUT STREET, DORCHESTER, MA

	5/13/25				
	BOSTON ZONING CODE REVIEW				
	1.) Parcel 1602615000 is located within	MFR zoning	sub-district, and		
	Neighborhood Design overlay district				
	2.) The lot is: 19,823 sf+/				
	3.) Existing occupancy: vacant land.				
	4.) The proposed 14-unit residential deve	elopment cor	ntains 19,550.0 FAR sf.		
	5.) In MFR sub-districts, multi-family dwe	elling is an al	lowed use-as is accessory p	arking.	
	6.) The lot is located flood zone AE with	BE: 17.45' E	BCD.		
	Per 780 CMR Sec.1612.4, Design & C	onstruction,	FFE Required: 18.50' BCD.		
	Per City Sea Level Rise - Base Flood I	Elevation Map	o, FFE Proposed: 19.50' BCI	D.	
	And lowest level of living and all critic	al infrastruct	ure, FFE Proposed 21.50' Bo	CD.	
	7.) Article 65 Dimensional Regulations: (a	any other dwe	elling)		
			Table C		
$\sqrt{}$	Item	Zone	Req'd/Allowed	New 14-unit bldg.	Remarks
	a.) Lot size min.	MFR	4,000 sf for 4 units	19,823 sf +/-	
	b.) Lot area min./add'l unit	П	1,000 sf/add'l unit	14,000 sf	
	c.) Lot width/frontage min.	П	30.0'	81.58'	
	d.) Floor to area ratio	п	1	0.98 ~ 1.0	Note 5
	e.) Height of building max.	11	3 st/35 ft	3 st/35 ft	at avg. sidewalk, Note 7
	f.) Usable open space/D.U.	11	400 sf/D.U. (504 sf)	608 sf/D.U.	Table C, note 6
	g.) Front yard min. depth	11	2 ft per modal yard	2 ft per modal plan	Notes 1& 2
	h.) Side yard min. depth	II	10 ft	10' (LT) & 10' (RT)	
	i.) Rear yard min. depth	II	30 ft.	30 ft	
	j.) Rear yard max. occ. bldg.	MFR	25%	N/A	
	k.) Off-street loading	MFR	Area provided on site	Area provided on site	See A02.
	I.) Off-street parking	Table F	18 spaces total	18 spaces	Notes 3 & 4
			(1-3 units: 1.0 or 3 sp)		
	√ denotes zoning relief required		(4-9 units: 1.25 or 7.5 sp)		LT - Left Side
			(10+ units: 1.5 or 7.5 sp)		RT - Right Side
	Note 1: Sec. 65-45.2, Conformity w/e	 xistina buildi	ng alignment See Modal Ali	│ ignment Plan	
	Note 2: Table C, note 3, bay window r				
	Note 3: Sec. 65-41, off-street parking	<u> </u>			
	Note 4: Per 521 CMR 23.2.1, two according		es required.		
	Note 5: 19,500 FAR sf ÷ 19,823 sf lot				
	Note 6: 8,507 sf Open Space ÷ 14 D.U				
	Note 7: Mean level of gable roof per A				



LOCUS: N.T.S.

Net Squ	uare Footage	*		
Level	Bldg SF		FAR GSF*	
G	8,702.0	sf	3,044.0	sf
2	9,028.0	sf	8,253.0	sf
3	9,028.0	sf	8,253.0	sf
Totals	26,758.0	sf	19,550.0	sf
*FAR gro	ss square foota	age	is measured	
to ext. fa	ace of walls and	dir	nising walls	
and exclu	ıdes basement,	sto	orage,	
laundry a	nd mechanical	area	as.	

PROJECT INFO:

Address: 173-175 Walnut Street, Dorchester, MA

Exist. Occupancy: Vacant Land Proposed Occupancy: R-2, Multi-Family

Lot: 19,823 sf +/-Parcel: 1602615000 District: MFR Ward: 16

SCHEDULE OF DRAWINGS

$\Lambda \cap \cap$	PROJECT INFORMATION
AUU	FINOJECT IINI ONMATION
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A0.1 CODE OVERVIEW

CO1 ARCHITECTURAL SITE PLAN

CO2 COASTAL RESILIENCY PLAN

001 MODAL ALIGNMENT PLAN

LO1 LANDSCAPE PLAN

V01 PERSPECTIVE VIEWS

A01 FOUNDATION PLAN A02 GROUND FLOOR PLAN

A03 SECOND FLOOR PLAN

A04 THIRD FLOOR PLAN

A05 ROOF PLAN A06 1-1 BUILDING SECTION

A07 2-2 BUILDING SECTION

A08 3-3 BUILDING SECTION

A09 4-4 BUILDING SECTION

A10 5-5 BUILDING SECTION A11 WEST ELEVTION

A12 EAST ELEVATION

A13 SOUTH & NORTH ELEVATIONS

A14 SCHEDULES

A15 WALL/ FLOOR TYPES A16 WALL/FLOOR TYPES

A17 WALL/ FLOOR TYPES A18 WALL/FLOOR TYPES

A19 WALL/FLOOR TYPES

REVISIONS 11/19/24 08/18/25 05/14/25

05/20/25

07/24/25

08/08/25 Tim Johnson Architect, LLC



PERMIT SET

DRAWING TITLE

PROJECT INFORMATION

DATE: 03/27/24 SC: N. T. S.

Project: New 3-story, 14-unit residential building w/garage

173-175 Walnut St., Boston, MA

Applicable Codes: 2015 International Building Code (IBC) w/780 CMR MA Amends., 9th ed.

2015 International Energy Conservation Code 2015 521 CMR Architectural Access Board 2006 (MAAB)

Third floor living: 8,253 sf

APPROVED

Design Review for the

Board of Appeal

08/28/2025

BOSTON REDEVELOPMENT AUTHORITY

248 CMR Uniform State Plumbing Code 2017

General building areas:

Crawlspace: N/A Ground flr. living: 3,044 sf

Roof: N/A Total living: 19,550 gsf Garage flr. parking: 8,702 sf

Second floor living: 8,253 sf

Type of construction:

Crawlspace: Type VA & Flood resistant materials per ASCE 24-14.

Ground flr. thru third flr.: Type VA

Per Table 506.2, building area: 'A' construction allows 1.0 hr. fire rating of floors & structure; and, 'B' construction allows 0.0 hr. fire rating of floors & structure.

IBC Sec. 310.4, Use and Occupancy:

Ground/garage floor: R-2 & S-2, multi-fam/garage Use per floor: Second thru third floors: R-2, multi-family

Occupancy calculations per IBC Table 1004.1.2:

<u>Floor</u>	No. of pec
Ground/garage floor: 11,746 sf ÷ 200 sf/occ =	59
Second floor: $8,253 \text{ sf} \div 200 \text{ sf/occ} =$	41
Third floor: $8,253 \text{ sf} \div 200 \text{ sf/occ} =$	<u>41</u>
TOTAL OCC:	141

IBC Table 506.2, Building Areas:

Occ. R-2 (SM) Type VA, allowable area: 36,000 sf; 19,550 sf proposed.

Occ. S-2 (SM) Type VA, allowable area: 63,000 sf: 8,702 sf proposed.

Note: SM - building equipped throughout w/an auto sprinkler system per Sec. 903.3.1.1.

IBC Sec. 510.2, Horizontal building separation allowance:

A building shall be considered separate and distinct where all the following conditions are met:

- 1.) The buildings are separated with a horizontal assembly having a fire-rating of not < 3 hrs.
- 2.) The building below the horizontal assembly is of Type IA construction.
- 3.) Shaft, stairway and ramp enclosures through the horizontal assembly shall have not < 2-hr firerating with opening protectives in accordance w/Section 716.5.

IBC Tables 601 & 602:

- Primary frame: IA 3 hr. fire-resistance rating
- Primary frame: VA 1 hr. fire-resistance rating
- Bearing walls: IA (ext/int) 3 hr. fire-resistance rating Bearing walls: VA (ext/int) - 1 hr. fire-resistance rating
- Floor construction & associated struct. members: IA 2 hr. fire-resistance rating Floor construction & associated struct. members: VA - 1 hr. fire-resistance rating
- Exterior walls, non-bearing: IA & VA 1 hr. fire- rating at 0.0' to < 30.0' fire separation distance Note: Per Sec. 705.5, Fire-resistance ratings, exterior walls fire-rated in accordance w/Tables 601 & 602, exterior walls w/fire separation distance > 10 ft rated for exposure to fire from inside only. Exterior walls w/fire separation distance \leq 10 ft rated for exposure to fire from both sides.

IBC Section 701.1, Fire & Smoke Protection Features:

- Sec. 705.8, max. area of exterior wall opngs. based on fire separation for sprinklered buildings: 0'<3' - not permitted; 3'<5' - 15%; 5'<10 - 25%; 10'<15' - 45%; 15'<20' - 75%; 20'<25' - no limit.
- Shaft enclosures per IBC Sec.713.4: Shaft enclosures shall have a fire-resistance rating of not less than 2- hrs. where connecting 4 stories or more, and not less than 1-hr. where connecting less than 4 stories.
- Fire doors per IBC Table 716.5: 1/3 hr. rated at 1- hr. rated corridor walls; 1-hr. rated at 1-hr. rated shafts, exit access stair & passageway walls; 1-1/2 hr. rated at 2-hr. rated shafts & interior exit stairways; and, 1-1/2 hr. rated at 2-hr. rated fire walls.
- Fire partitions per IBC Sec. 708.3: Dwelling unit separation walls or fire partitions shall have a fire-resistance rating of not less than 1- hr.
- Fire partitions per IBC Sec. 708.3, exp. 1: Fire partitions at corridor walls shall have a 1/2 hr. rating in bldgs. w/sprinkler systems per Table 1020.1.
- Horizontal assemblies per IBC Sec. 711.2.4: The fire-resistance rating of horizontal assemblies shall not be less than that required by the building type of construction.

IBC Section 803.1.1, Interior wall and ceiling finish materials:

• Per IBC Table 803.11, Interior wall and ceiling finish requirements by occupancy, stairways, exit passageways, corridors and enclosed spaces for R-2 occupancy sprinklered shall be Class C: = flame spread index 76-200; smoke developed index 0-450.

IBC Section 901.1, Fire Protection Systems:

- Fire protection system all floors per Sec. 903.3.1.1, NFPA 13.
- Per IBC Sec. 905.3.1, Standpipe systems shall be installed in building where floor level of highest story is located more than 30 ft above lowest level of fire truck access.
- Per IBC Sec. 907.2.11.2, Groups R-2, R-3 & R-4, single- or multiple smoke alarms shall be installed regardless of occupant load.
- Per IBC Sec. 915.2, Carbon monoxide detection locations as required.

IBC Section 1001.1, Means of Egress:

- Per IBC Table 1006.3.2(1) Stories w/one exit to 3rd story: Occ. R-2/NFPA 13/4 D.U. per flr/125 ft travel distance.
- Per IBC Sec. 1006.3.2 (2), Stories w/one exit for other occupancies. Occ. S/NFPA 13/max. occ. 29/100 ft travel distance
- Per IBC Table 1006.3.1, Min. number of exits per story: occupant load 1-500 ppl., 2 exits minimum.
- Per IBC Sec. 1006.2.1, Egress from spaces exception 1: In group R-2, one means of egress is permitted within and from individual dwelling units w/max. occ. load 20, 125' max. travel and NFPA 13.

Min. number of exits per Table 1006.3.1: Ground floor: 2 exits required; 2 exits provided

Second floor: 2 exits required; 2 exits provided

Third floor: 2 exits required; 2 exits provided

Garage floor: 2 exits required; 2 provided per Table 1006.3.1

Roof decks: 1 provided per Sec. 1006.2.1

- Per IBC Sec. 1010.1.2.1 & IEBC Sec. 705.4.2, door swing in direction of egress travel where serving a room or area containing an occupancy load of 50 or more persons.
- Per IBC Sec. 1010.1.10, panic hardware not required.
- Per IBC Sec. 1008.3.2, means of egress emergency lighting as required.
- Per IBC Sec. 1013, exit signs as required.
- Per IBC Sec. 1010.1.1, size of doors: 32"min. clear width required.
- Per IBC Sec. 1005.2, min. required egress width based on component: Sec. 1011.2, exp. 2, stairways serving occ. Load of < 50, width not less than 36 in. Sec. 1020.2, corridor width serving occ. Load of < 50, width not less than 36 in.
- Per IBC Sec. 1024.3, exit passageway construction: exit passageway enclosures shall have walls, floors and ceilings of not less than a 1-HR fire-resistance rating, and not less

than that required for any connecting interior exit stairway or ramp.

- Per IBC Sec. 1030.1, emergency escape and rescue openings shall open directly into a public way or to a yard or court that opens to a public way.
- * Sec. 1030.2, Min. size, emergency escape and rescue openings shall have a min. net clear opng. of 5.7 sf. Min. opng. height dimension: 24 in.; min. opng. width dimension: 20 in. (Sec. 1030.2) Max. height from floor to bottom of clear opng: 44 in. (Sec. 1030.3).

IBC Section1101.1, Accessibility

The proposed construction to create 14 dwelling units—not serviced by an elevator— adheres to 521 CMR, Architectural Access Board, specifically:

- Per Sec. 9.3, Group 1 dwelling units, in multiple dwellings that are for rent, lease or sale and are not equipped w/an elevator, only units on the ground flr. must be constructed as Group 1 D.U.
- Per Sec. 9.4, Group 2 dwelling units, in multiple dwellings that are for rent, hire, or lease (but not for sale) and contain 20 or more units, at least 5% of units shall be Group 2A units.
- Per Sec. 10.1, the public use and common use spaces of multiple dwellings in new construction consisting of 3 or more units shall comply w/521 CMR. Public and common use spaces are those spaces inside or outside a building that are used by residents and/or visitors.
- Per Sec. 20.1, Accessible route is provided connecting accessible spaces and elements inside and outside of building.
- Per Sec. 26.5, Door width, all doorways that are required to be accessible shall have a clear opng. of not less than 32 in.

IBC Section 1207, Sound Transmission

- Per Sec. 1207.2, Air-borne sound, wall & floor assemblies between adjacent dwelling units shall have a sound transmission class (STC) rating of not less than 50.
- Per Sec. 1207.3, Structure-borne sound, floor/ceiling assemblies between dwelling units shall have an impact insulation class (IIC) rating of not less than 50.

IBC Section 1601.1, Structural Design

- Per IBC Table 1607.1, Design live loads:
- residential: 40 psf
- balconies & decks: same as occupancy served
- offices: 50 psf
- restaurants: 100 psf

IBC Section 2603, Plastic Foam Insulation

• Per Sec. 2603.3, surface burning characteristics, foam plastic insulation and foam plastic cores of manufactured assemblies shall have a flame spread index of not more than 75 and a smokedeveloped index of not more than 450 in accordance with ASTM E 84 or UL 723.

IBC Section 2701.1, Electrical

New electrical work per electrical code by licensed electrician.

IBC Section 2801.1, Mechanical

New mechanical work per mechanical code by licensed contractor.

IBC Section2901.1, Plumbing Systems

New plumbing work per plumbing code by licensed contractor.

IBC Section1301.1, Energy Efficiency

- Buildings shall be designed and constructed in accordance with the Int'l Energy Conservation Code. Note: The city of Boston adopted the Stretch Energy Code on 7/1/2011. And, the Specialized Energy Code (Passive House, Multi-family > 12,000 sf) on 1/1/24.
- See energy code calculations by project HERS rater.

DJECT ARCHITECT:

1 JOHNSON ARCHITECT, LLC

9 EAST BROADWAY, STE. 102

STON, MA 02127

1: 617-464-4363 PROJ TIM J 599 BOST TEL:

OWNER:
TUARY II DEVELOPMEN
51 THORNEY MEAD
HANOVER, MA (**REVISIONS** 11/19/24 08/18/25

05/14/25 05/20/25 07/24/25 08/08/25 \

Tim Johnson Architect, LLC





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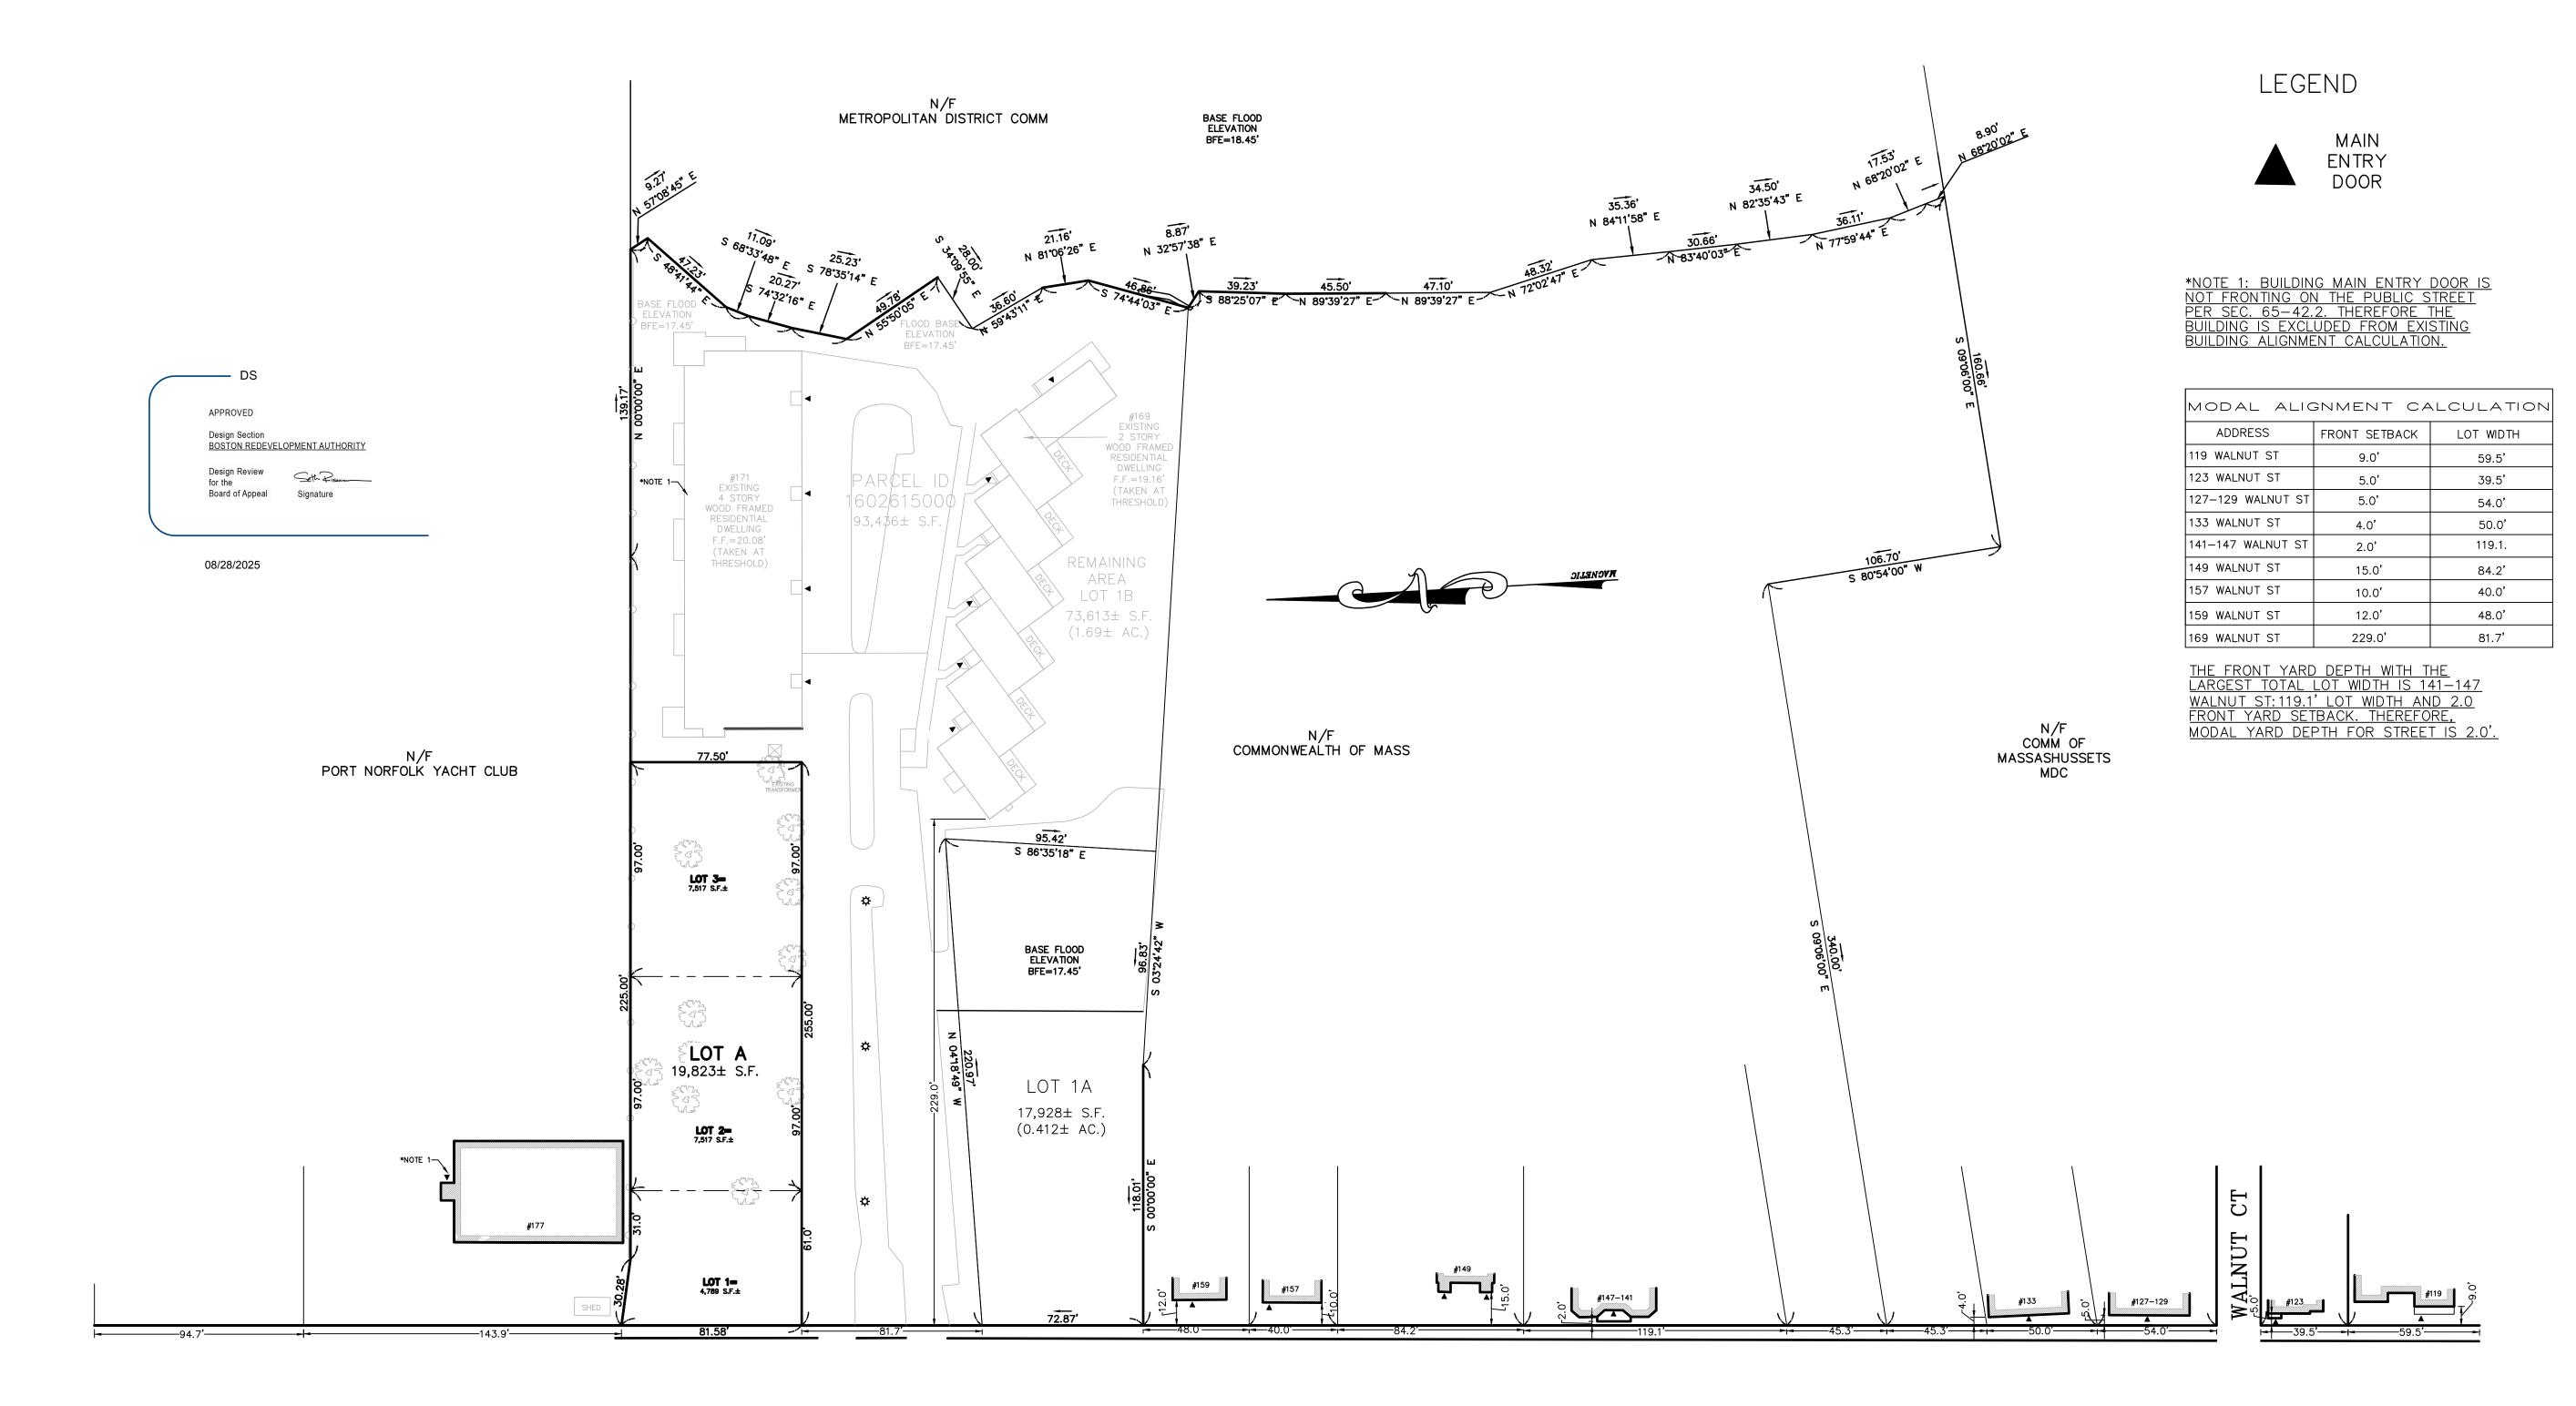
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CODE OVERVIEW


DATE: 03/27/24 | SC: N. T. S.





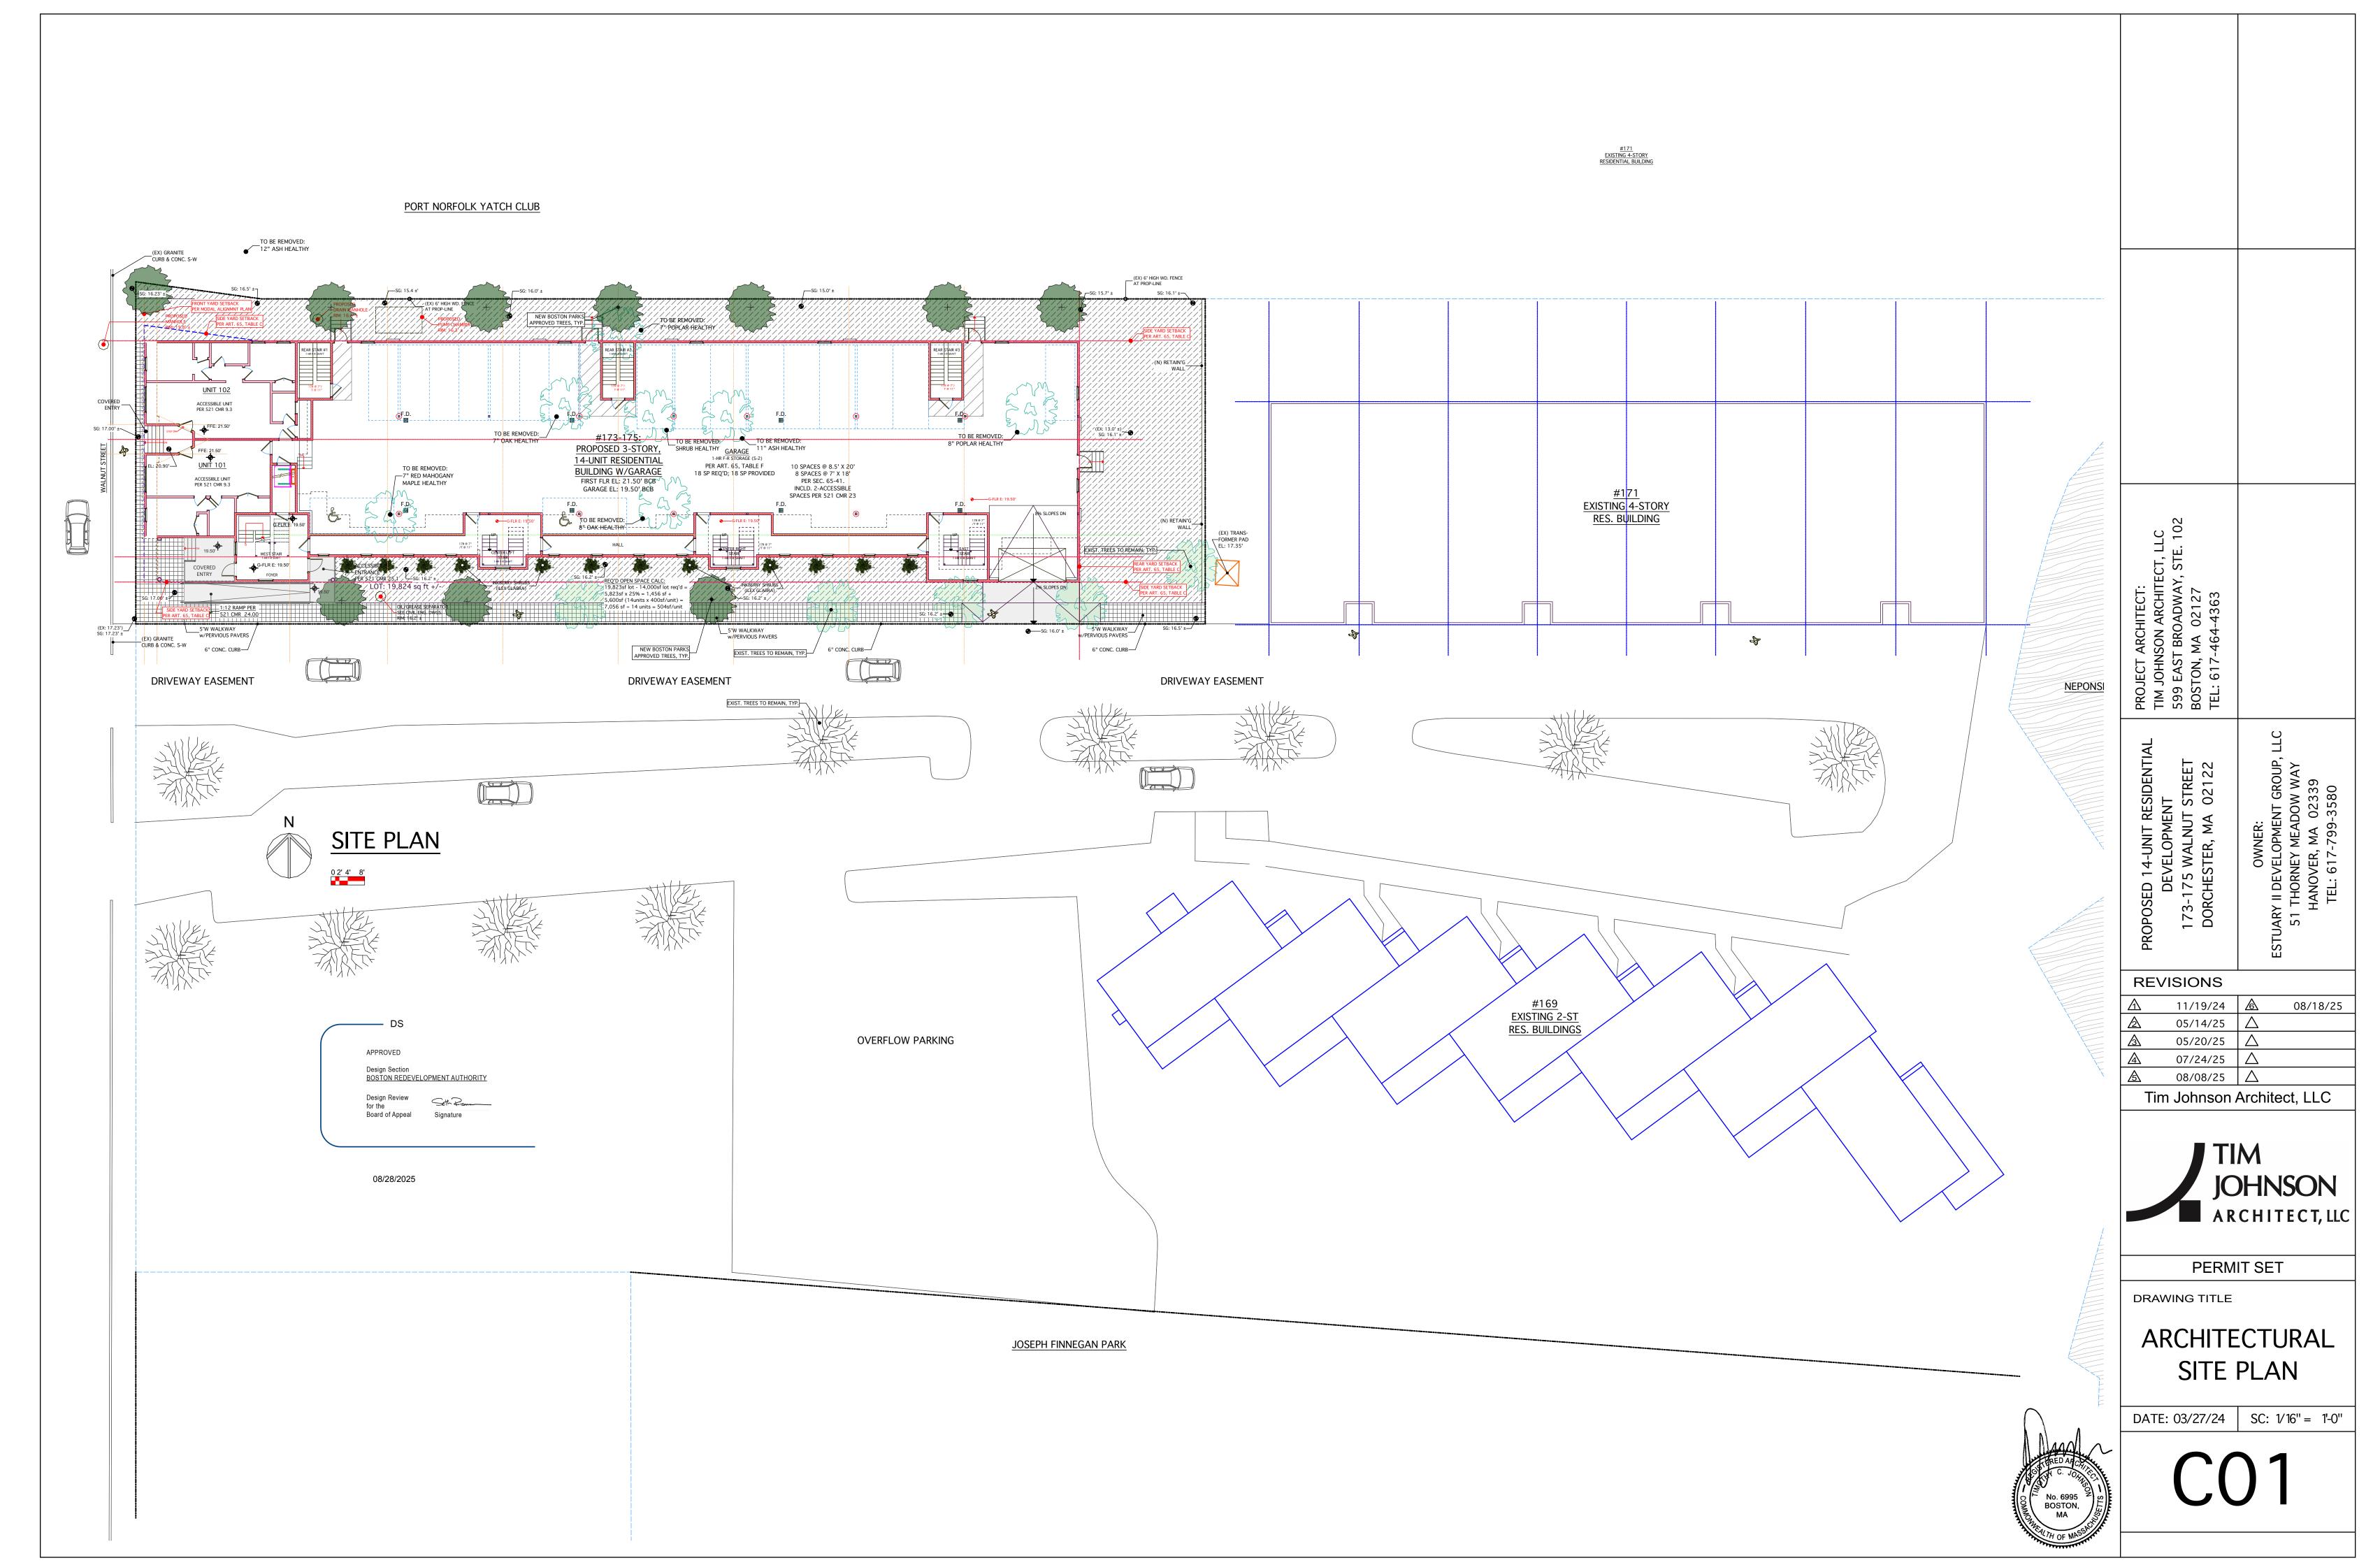

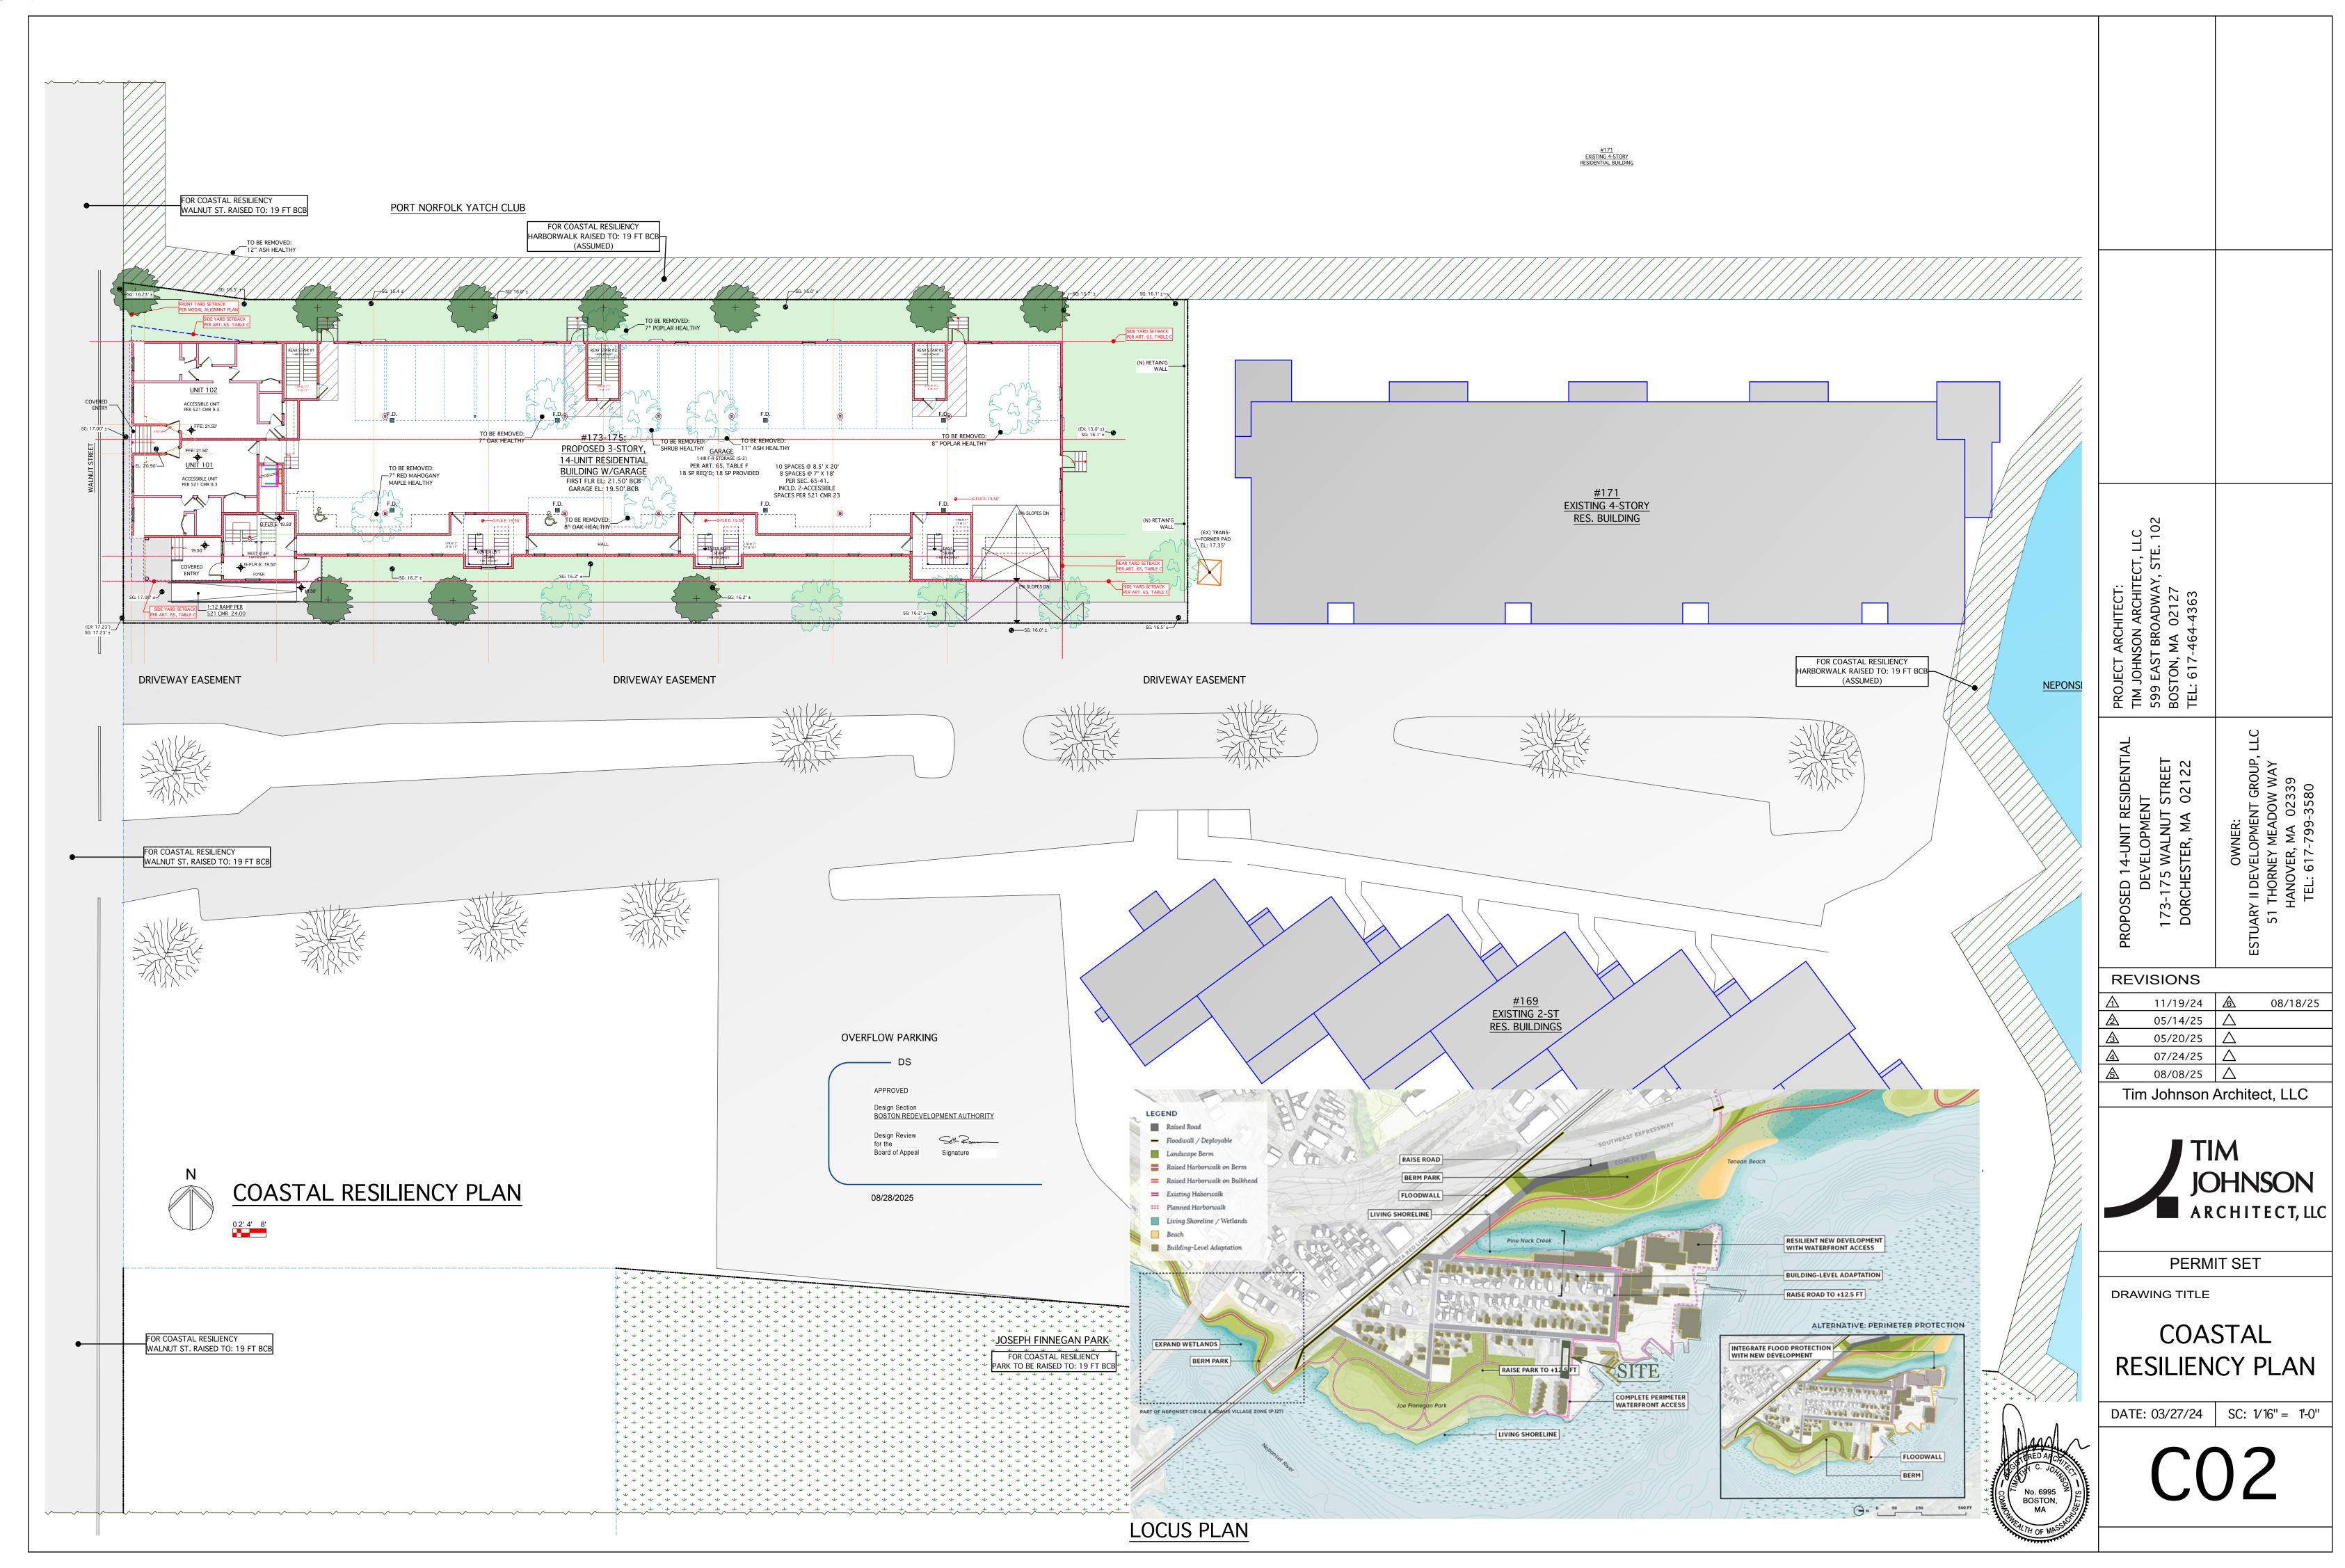WALNUT STREET (PUBLIC WAY-VARIABLE WIDTH)

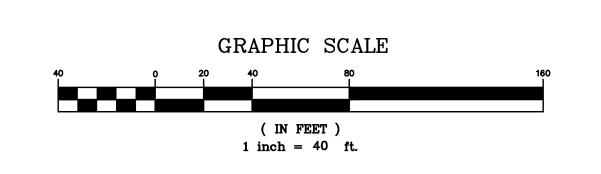

DATE					
/22/2022	REV	DATE	REVISION	BY	
HEET		1	73-175 WALNUT STREET		
PLAN NO. OF 1			DORCHESTER MASSACHUSETTS		
CLIENT:			WI/NOS/NOTIO DE LITO		SHEET NO.
		M (ODAL ALIGNMENT PLAN		.
RAWN BY		1 ¥ 1			
<u> </u>		N PE	TER NOLAN & ASSOCIATES LLO		
CHKD BY TS			ND SURVEYORS/CIVIL ENGINEERING CONSULTANT		
APPD BY		PHONE	697 CAMBRIDGE STREET, SUITE 103 BRIGHTON MA 02135 : 857 891 7478/617 782 1533 FAX: 617 202 56	91	
UN		ŁM/	AlL: pnolan@pnasurveyors.cor	n	

PORT NORFOLK YATCH CLUB TO BE REMOVED: 12" ASH HEALTHY (EX) GRANITE CURB & CONC. S-W ___(EX) 6' HIGH WD. FENCE AT PROP-LINE SG: 16.5' ±¬ ___SG: 15.0' ± SG: 16.1' ±— // (EX) 6' HIGH WD. F AT PROP-LINE NEW BOSTON PARKS 7"/POPLAR/HEALTHY //(N) RETAIN'G/ <u>UNIT 102</u> COVERED ACCESSIBLE UNIT ENTRY PER 521 CMR 9.3 SG: 17.00' ±~ (EX: 13.0' ±) SG: 16.1' ± *#*173-175; TO BE REMOVED: 7" OAK HEALTHY 8" POPLAR HEALTHY SHRUB HEALTHY GARAGE PROPOSED 3-STORY, 11" ASH HEALTHY 1-HR F-R STORAGE (S-2) 14-UNIT RESIDENTIAL PER ART. 65, TABLE F 10 SPACES @ 8.5' X 20' TO BE REMOVED: 18 SP REQ'D; 18 SP PROVIDED 8 SPACES @ 7' X 18' —7" RED MAHOGANY ACCESSIBLE UNIT FIRST FLR EL: 21.50' BCB PER SEC. 65-41. MAPLE HEALTHY PER 521 CMR 9.3 INCLD. 2-ACCESSIBLE GARAGE EL: 19.50' BCB SPACES PER 521 CMR 23 ← G-FLR E: 19.50' TO BE REMOVED: G-FLR E: 19.50' 8"- OAK-HEAL-THY-(EX) TRANS--FORMER PAD \ EL: 17.35' 2% SLOPES DN 19,823sf lot - 14,000sf lot req'd = (ILEX GLABRA) \times 5,823sf x 25% = 1,456 sf + $\sqrt{5,600}$ sf (14units x 400sf/unit) = OIL/GREASE SEPARA' SEE CIVIL ENG. DWGS $7,056 \text{ sf} \div 14 \text{ units} = 504 \text{sf/unit}$ 1:12 RAMP PER STREET 02122 SG: 16.5' ±— 5'W WALKWAY w/PERVIOUS PAVERS w/PERVIOUS PAVERS w/PERVIOUS PAVERS (EX) GRANITE CURB & CONC. S-W NEW BOSTON PARKS 6" CONC. CURB— BOSTON PARKS APPROVED TREES: SITE SURFACES: EXIST. TREES TO REMAIN, TYP. TREE 'A': JAPANESE TREE LILAC SYRUNGA RETICULATA, 3" CALIPER + TREE 'B': CHERRY PRUNUS X. 'AUTUMNALIS', 3" CALIPER + TREE 'C': CRAB APPLE, MALUS X. 'SUGARTYME' APPROVED TREES, TYP. TRADITIONAL LED LIGHT POST DOWNLIGHTING NATIVE & SALT TOLERANT SHRUBS & GRASSES DRIVEWAY EASEMENT DRIVEWAY EASEMENT DRIVEWAY EASEMENT 3' HIGH LED BOLLARDS DOWNLIGHTING IMPERVIOUS SURFACE EXIST. TREES TO REMAIN, TYP. **REVISIONS** 11/19/24 08/18/25 05/14/25 BOSTON REDEVELOPMENT AUTHORITY 05/20/25 07/24/25 Seth Pisenn 08/08/25 🛆 LANDSCAPE PLAN Tim Johnson Architect, LLC **JOHNSON** PERMIT SET DRAWING TITLE LANDSCAPE PLAN **OVERFLOW PARKING** DATE: 03/27/24 SC: 3/32" = 1'-0"



REVISIONS

11/19/24 08/18/25 05/14/25 🛆 05/20/25 07/24/25 🛆


Tim Johnson Architect, LLC





PERMIT SET

PERSPECTIVE **VIEWS**

DATE: 03/27/24 SC: N. T. S.

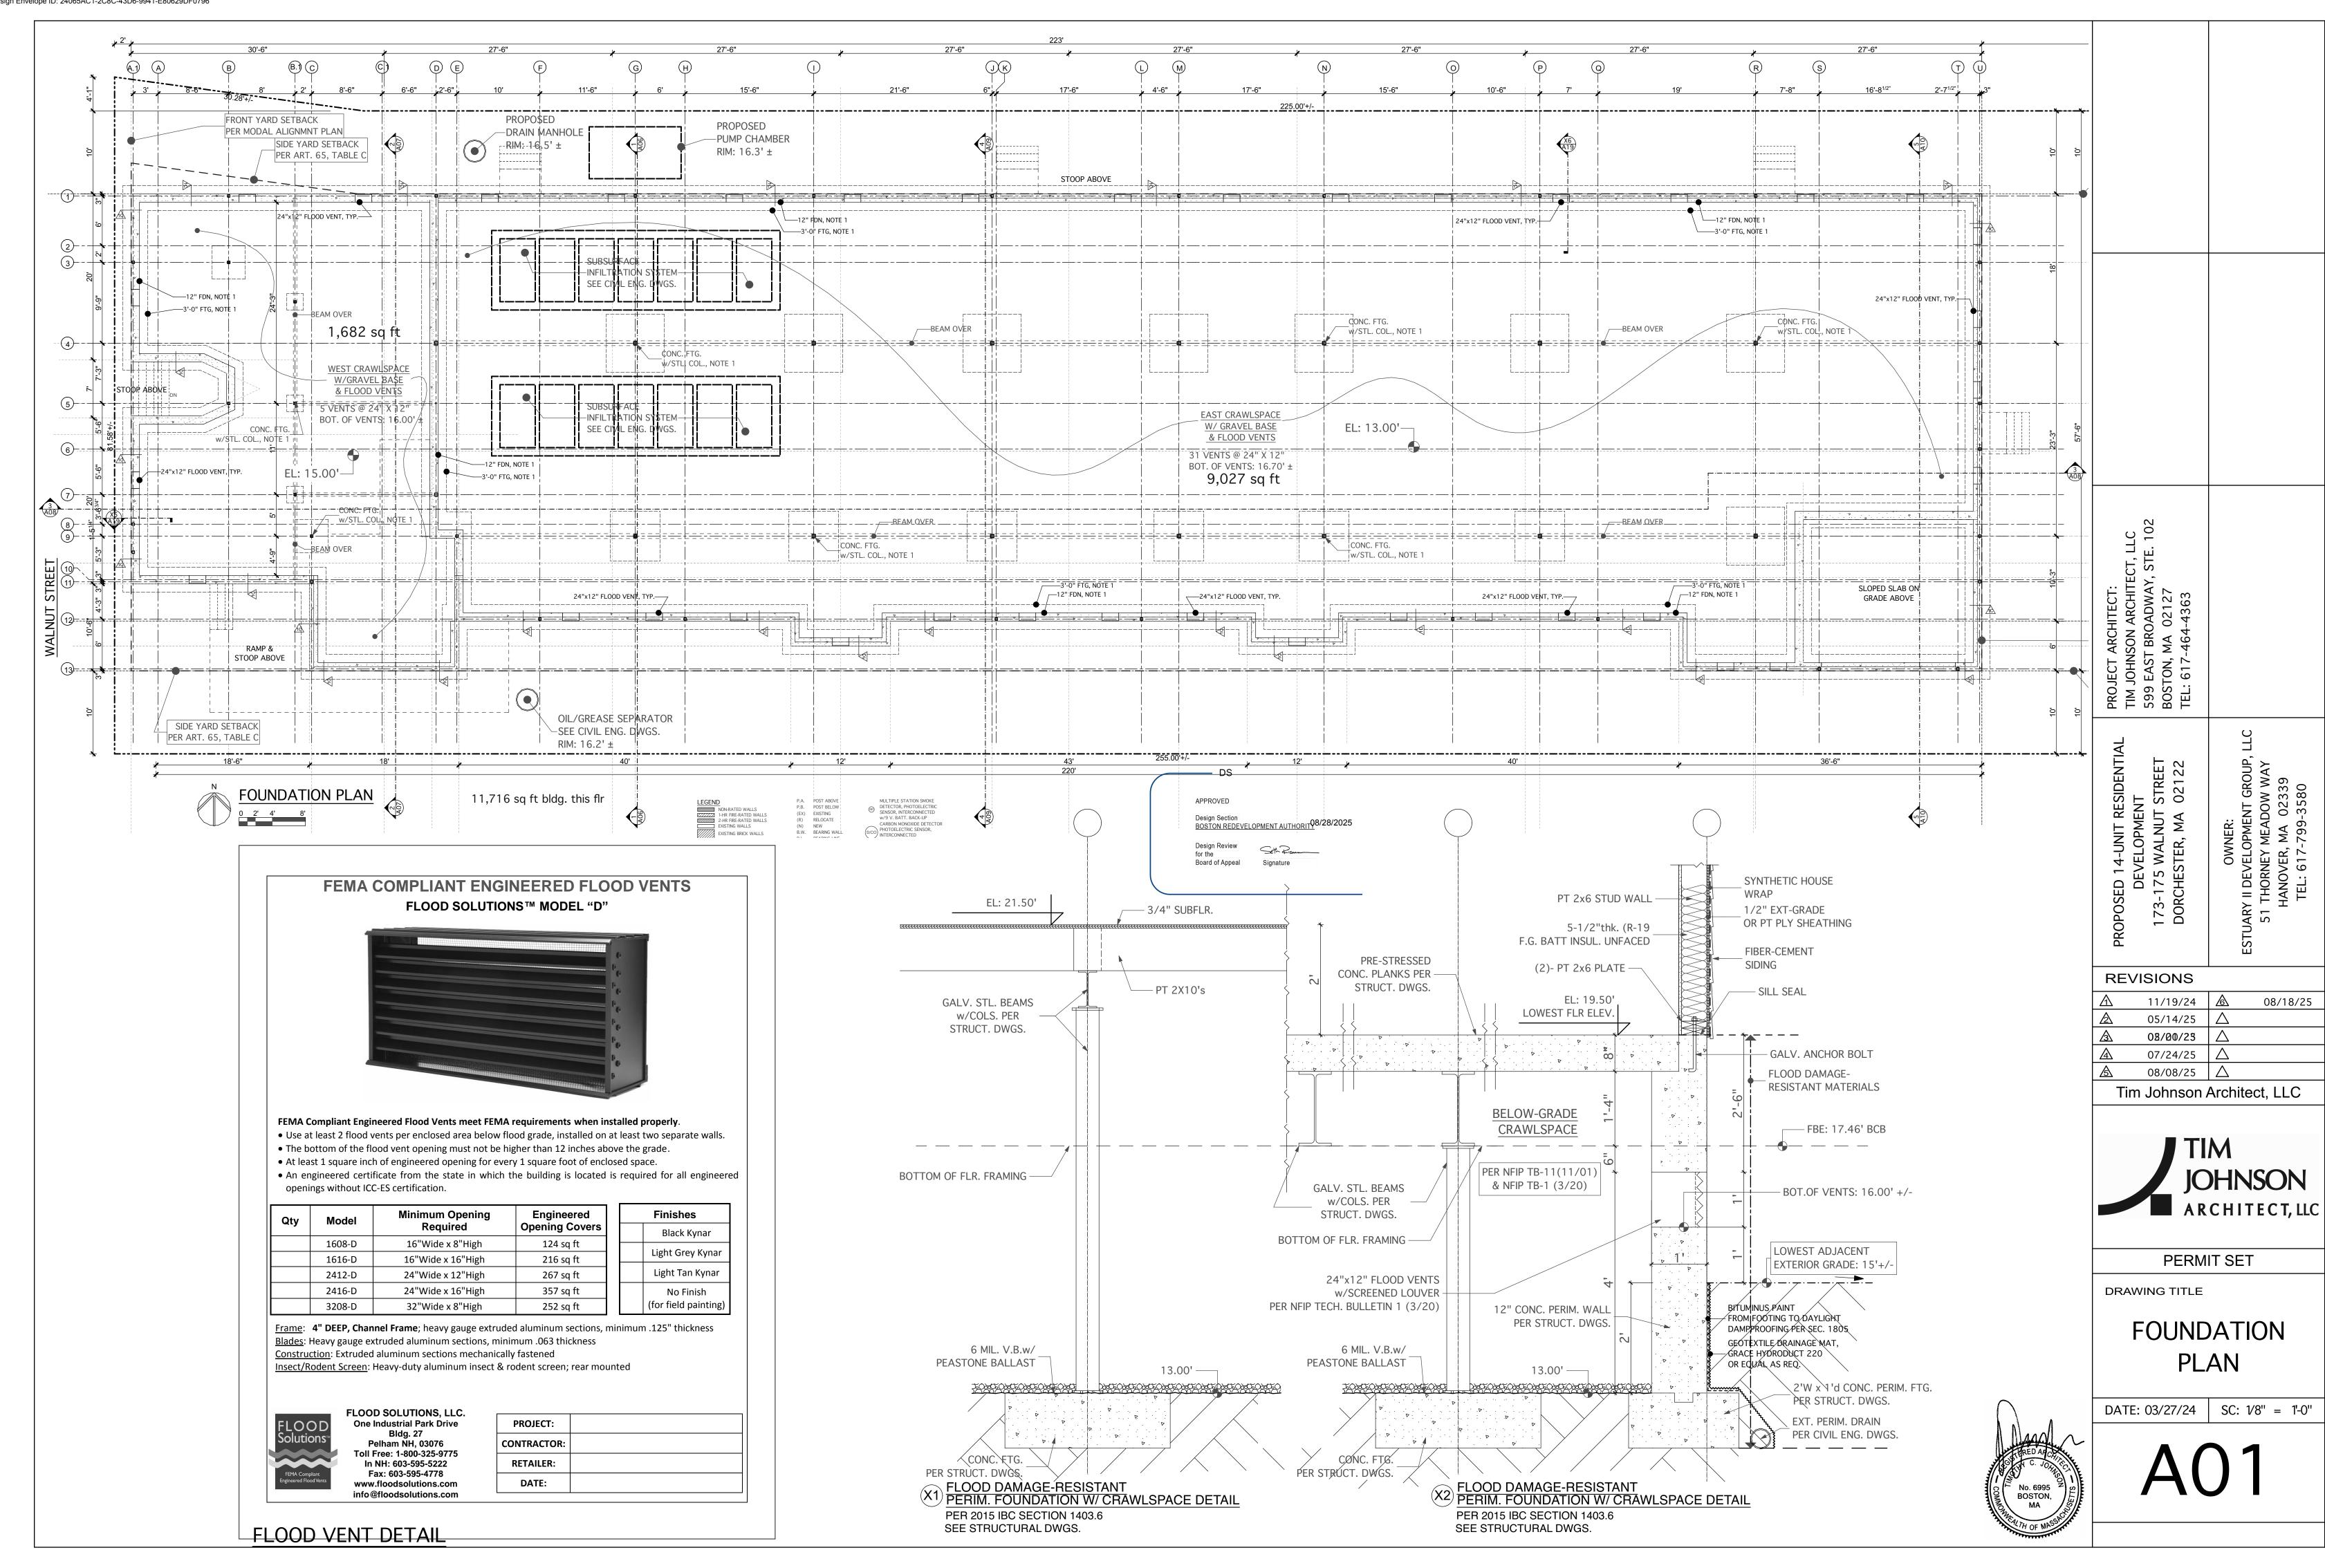

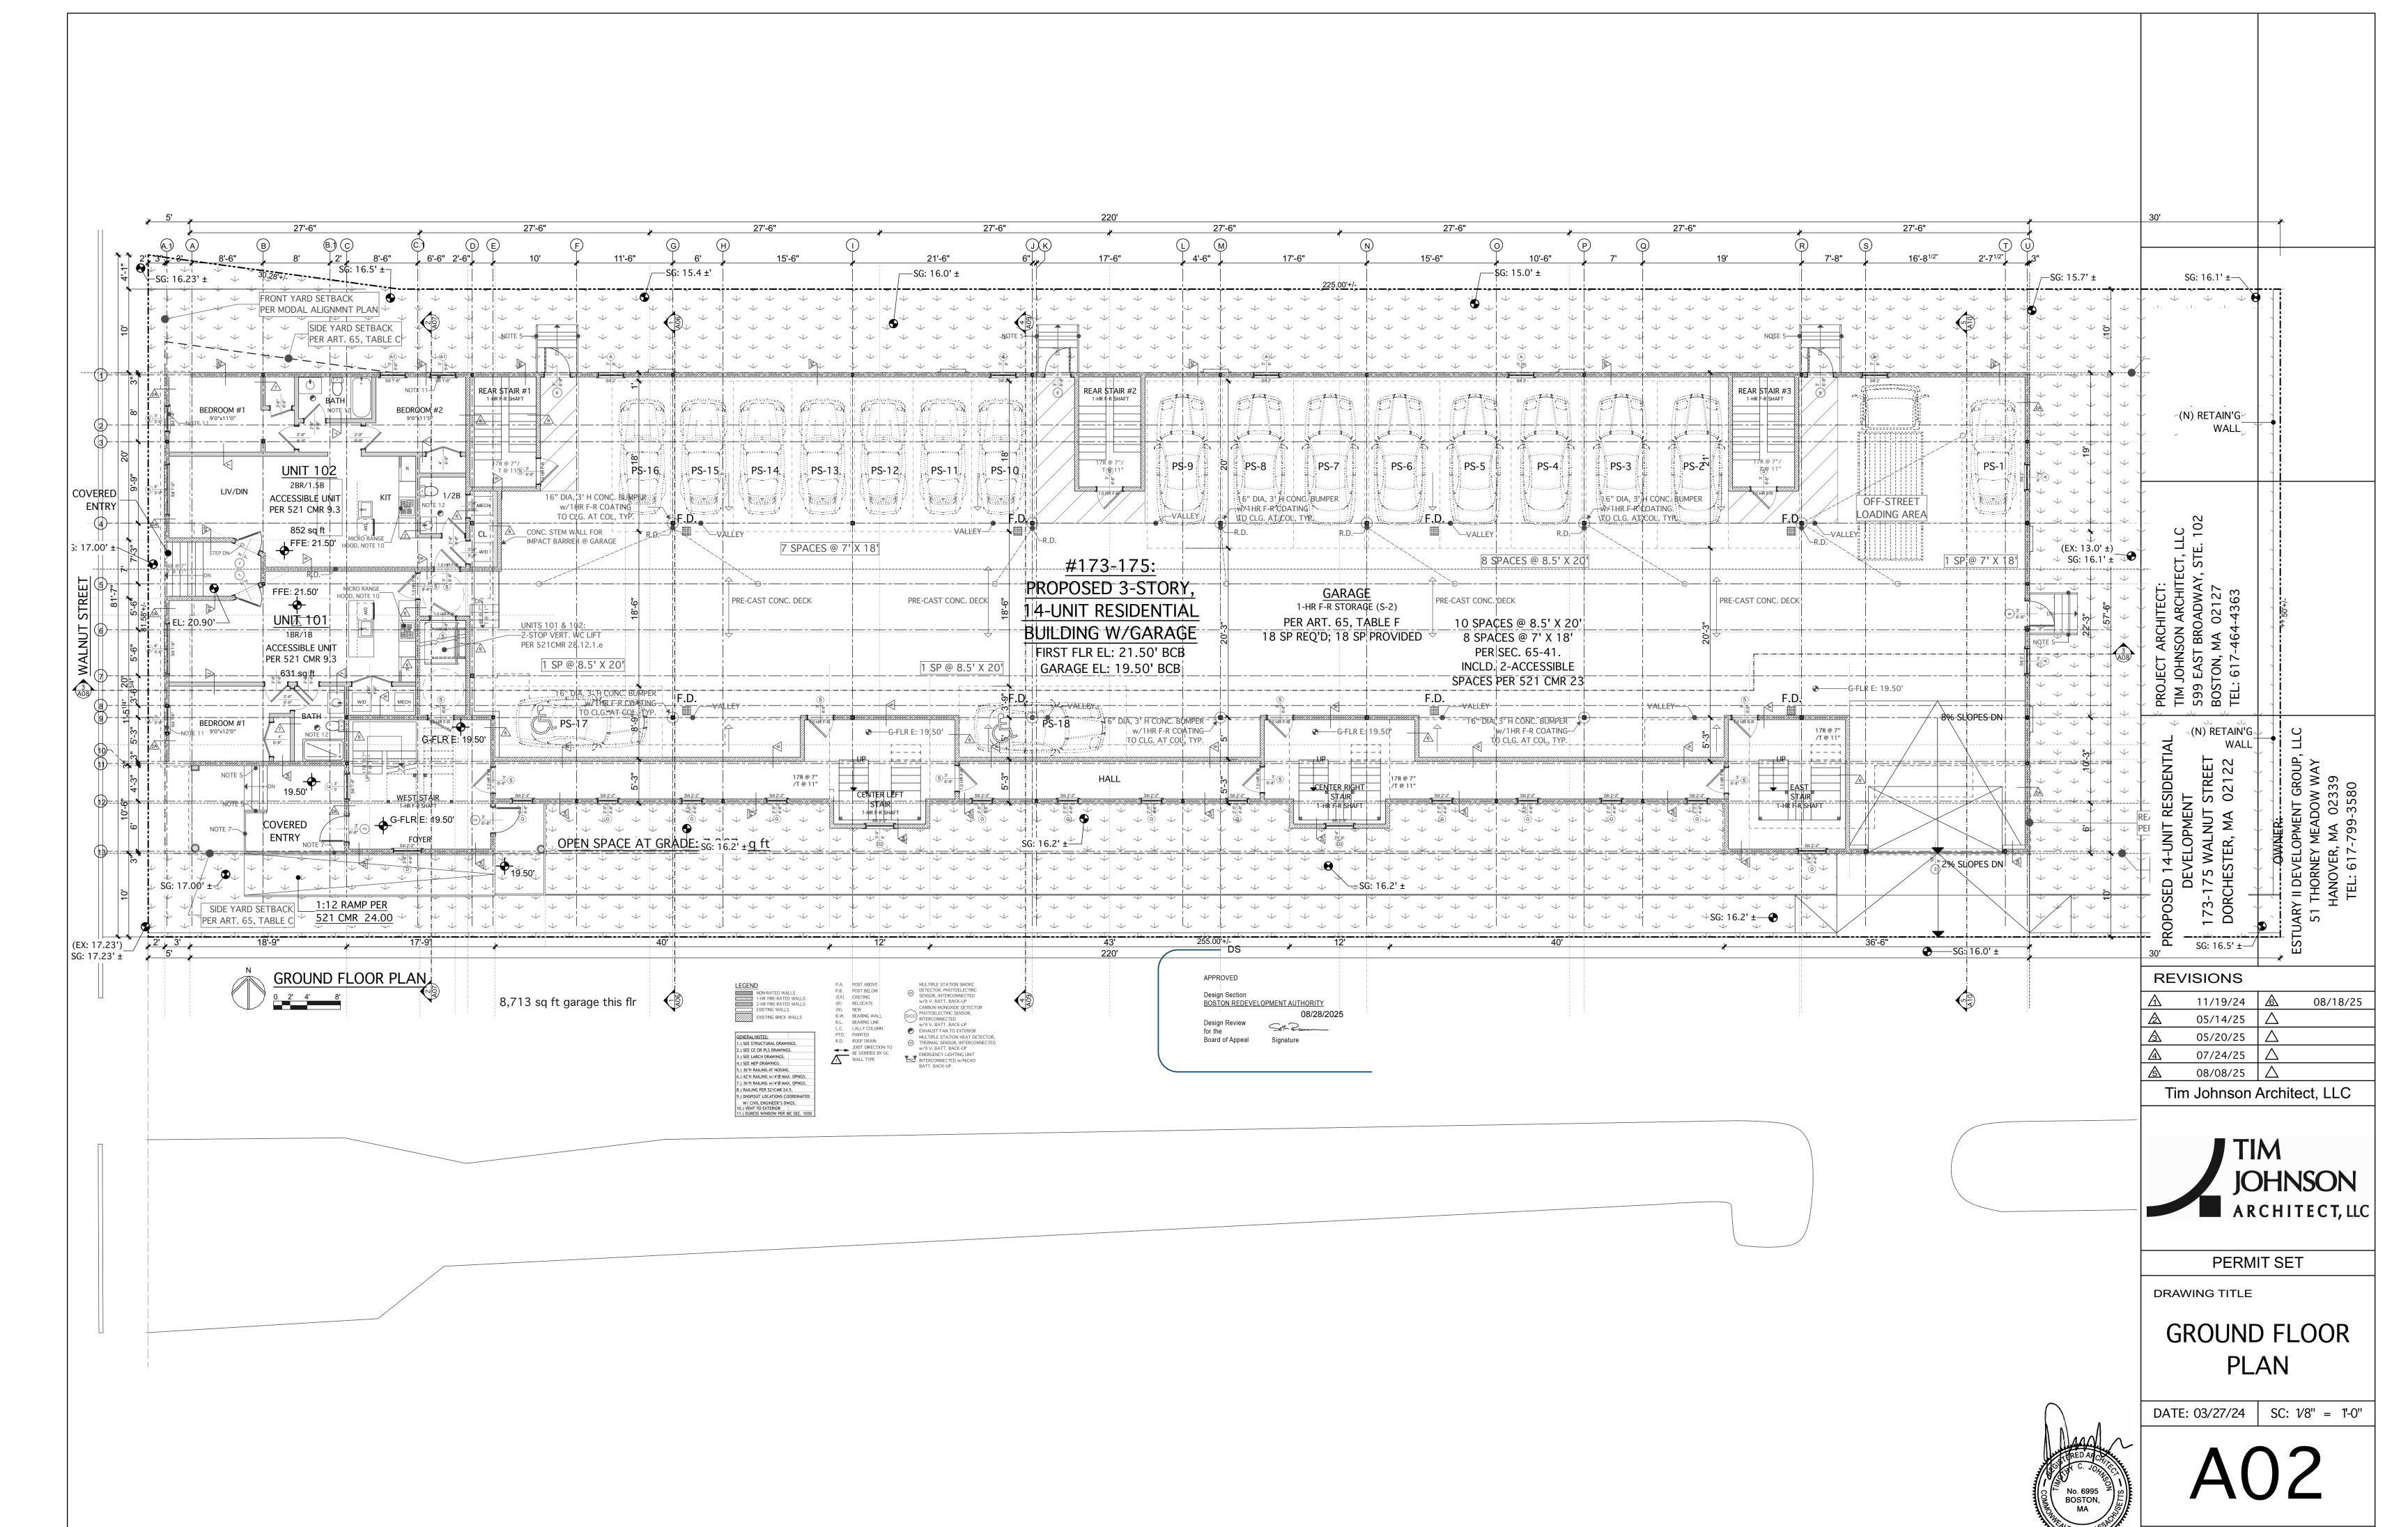


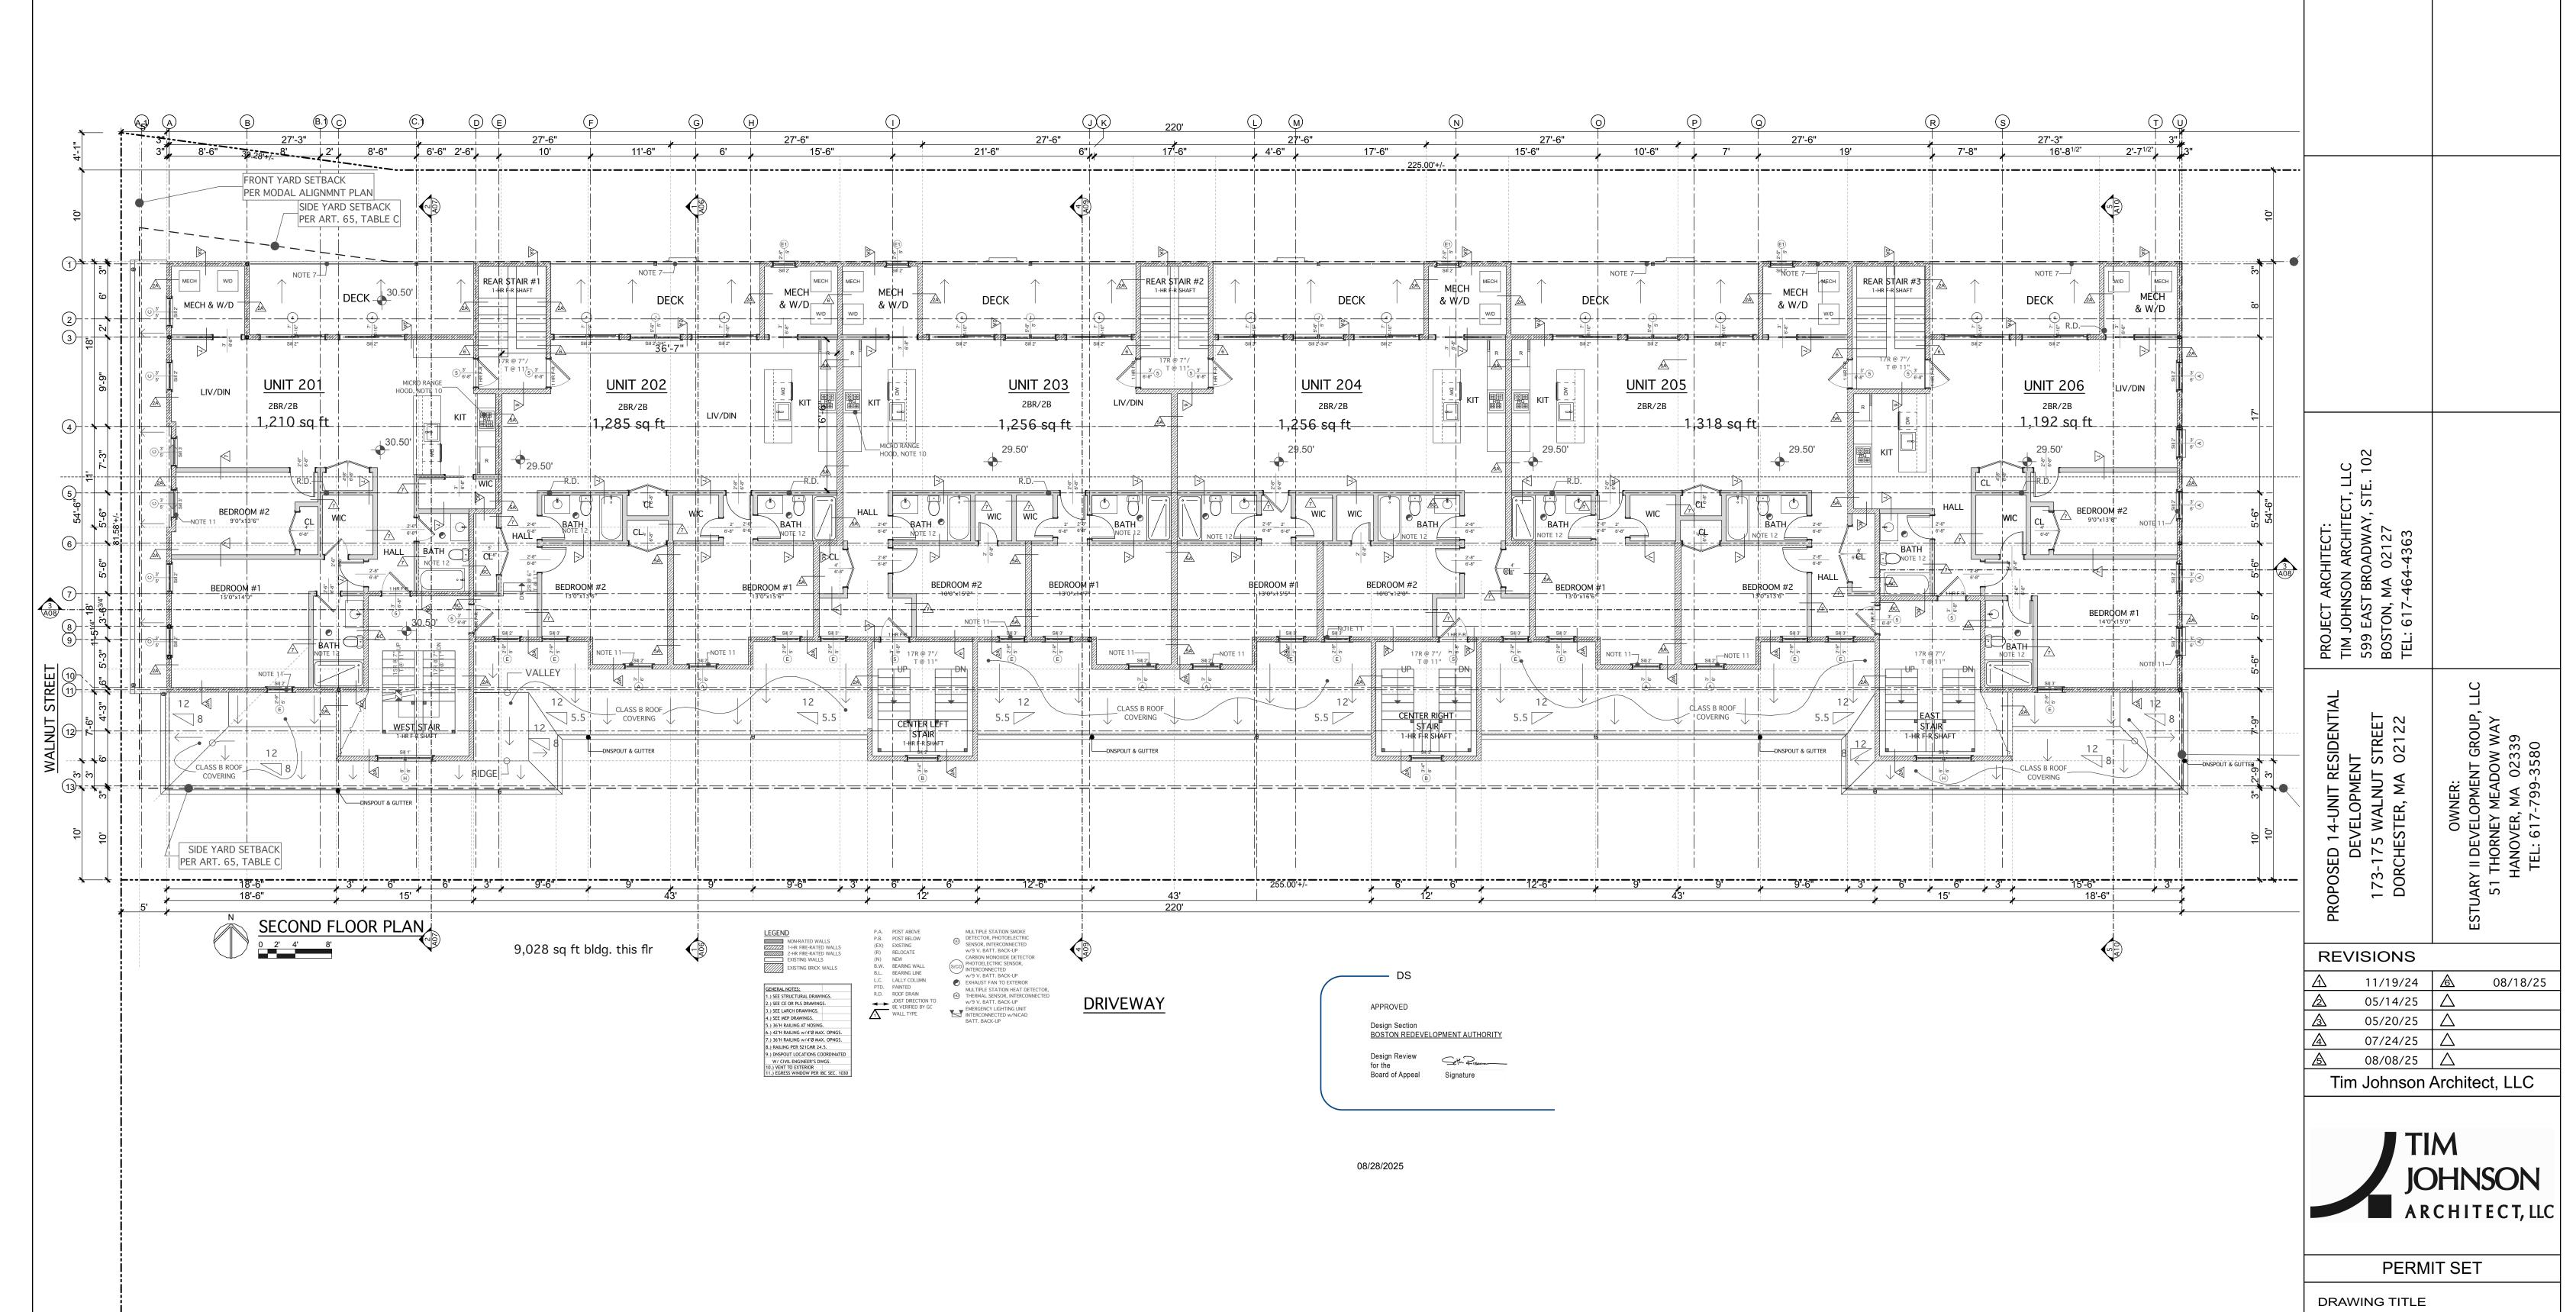

No. 6995 BOSTON, MA

SECOND FLOOR PLAN


DATE: 03/27/24 | SC: 1/8" = 1'-0"

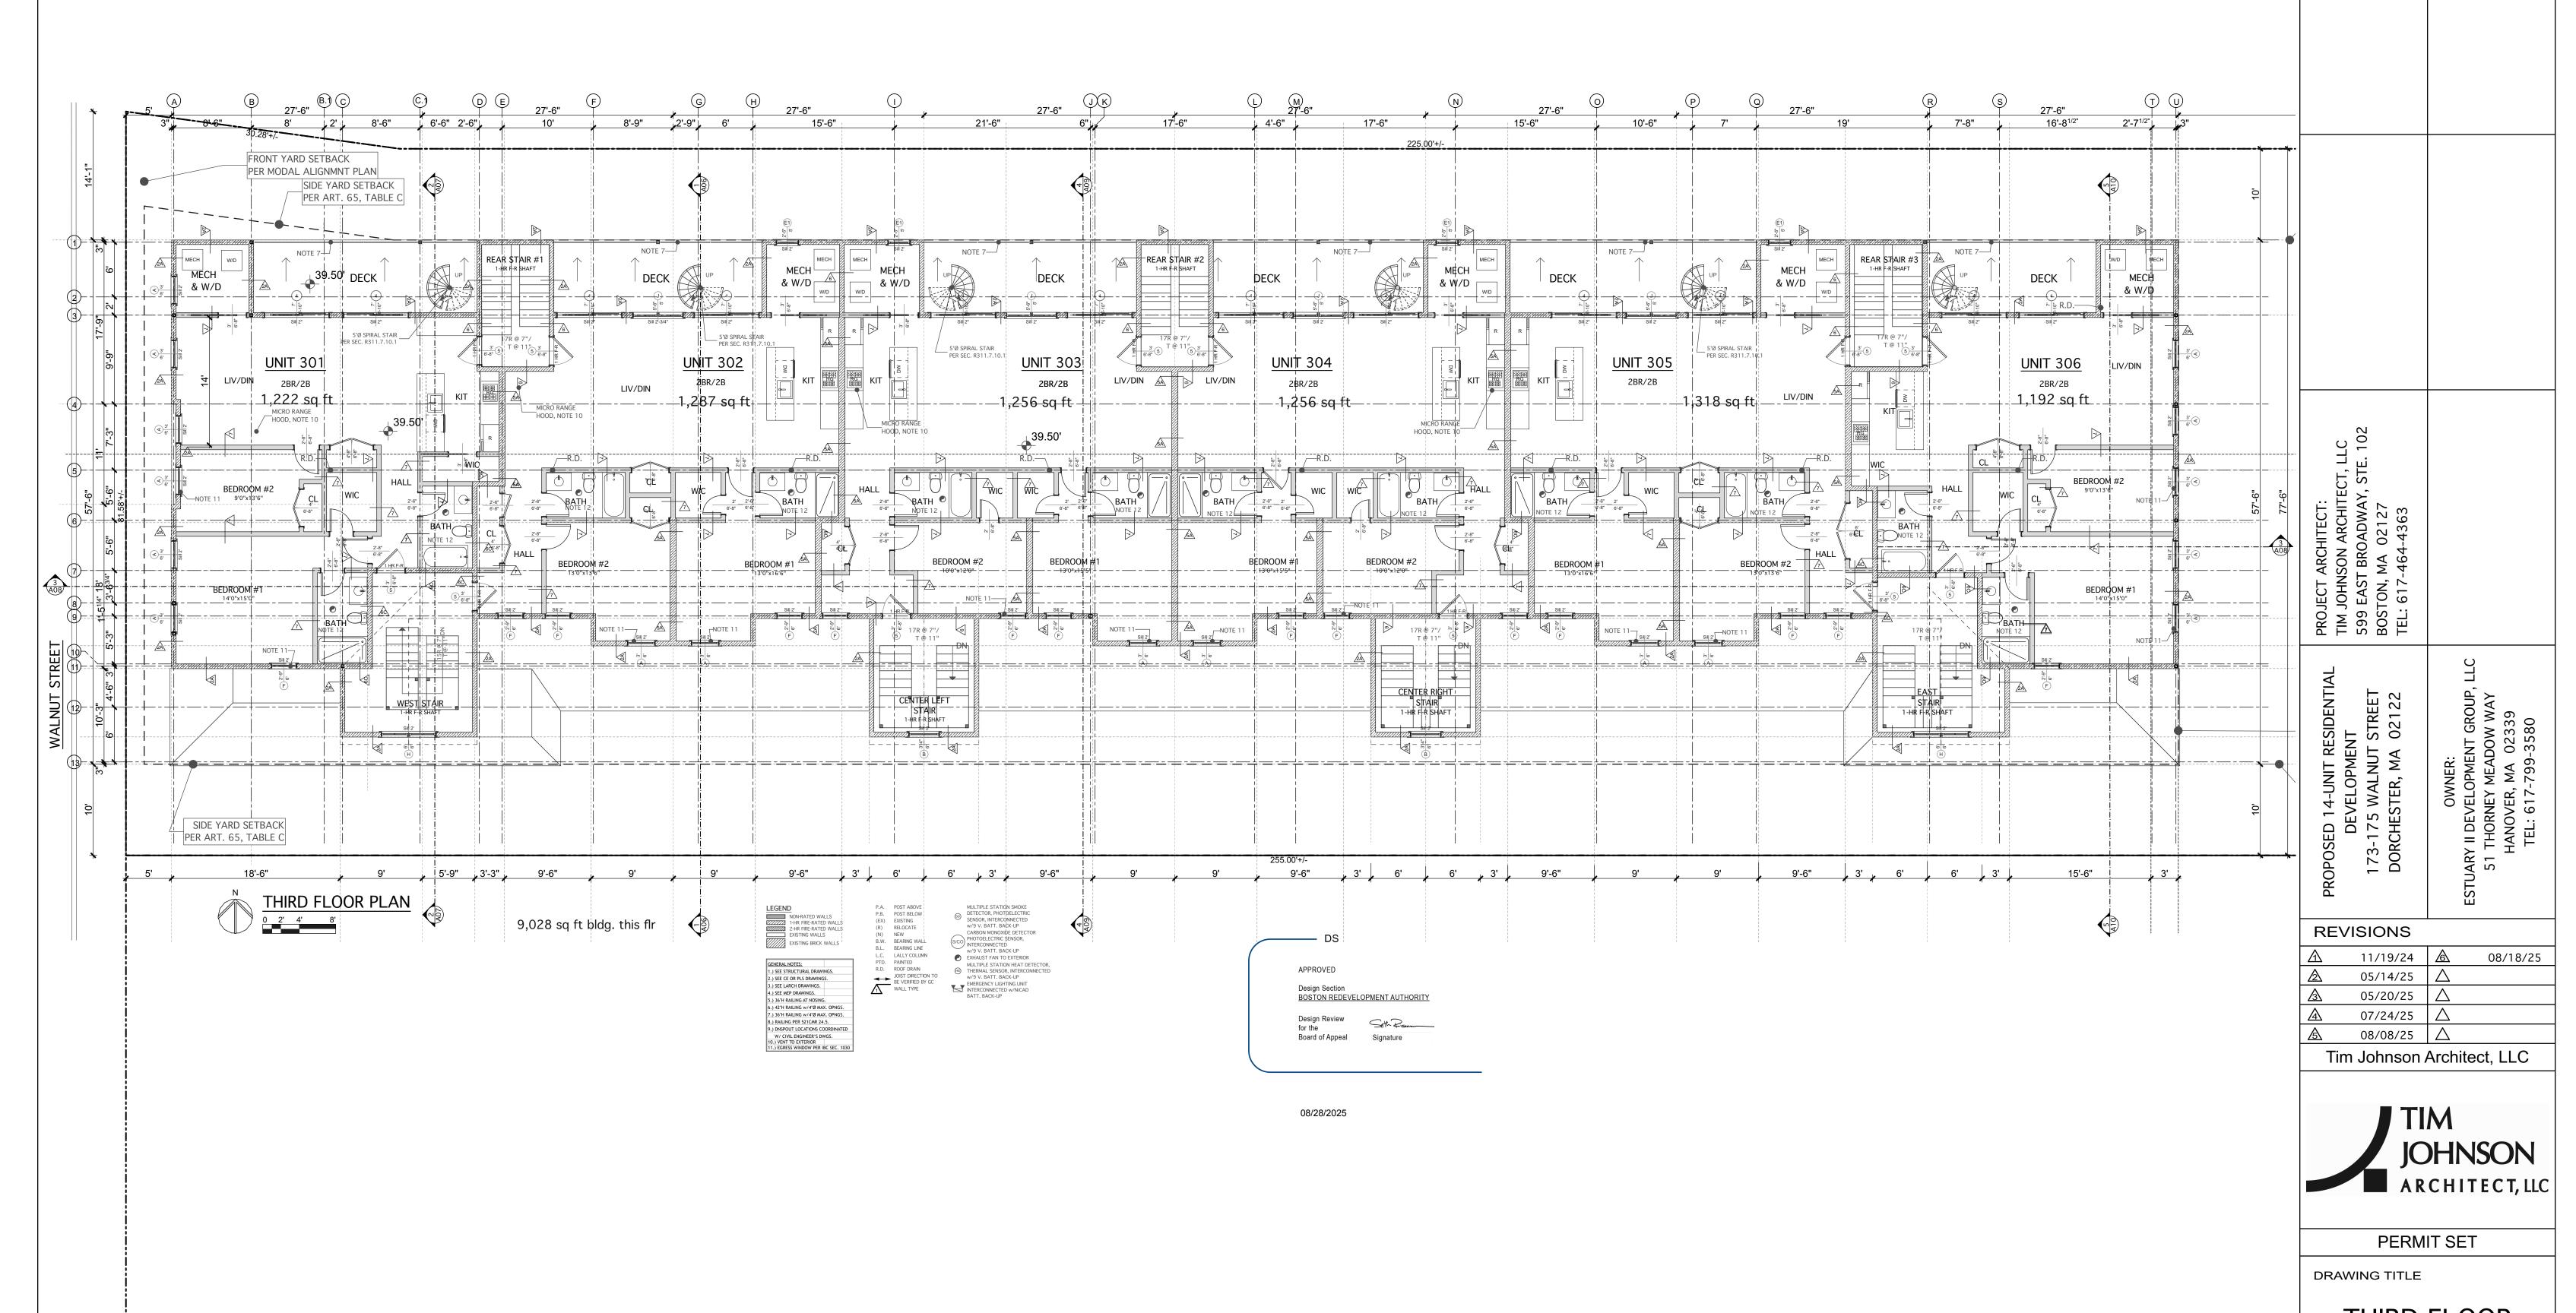


THIRD FLOOR PLAN

DATE: 03/27/24 | SC: 1/8" = 1'-0"

No. 6995 BOSTON, MA A04

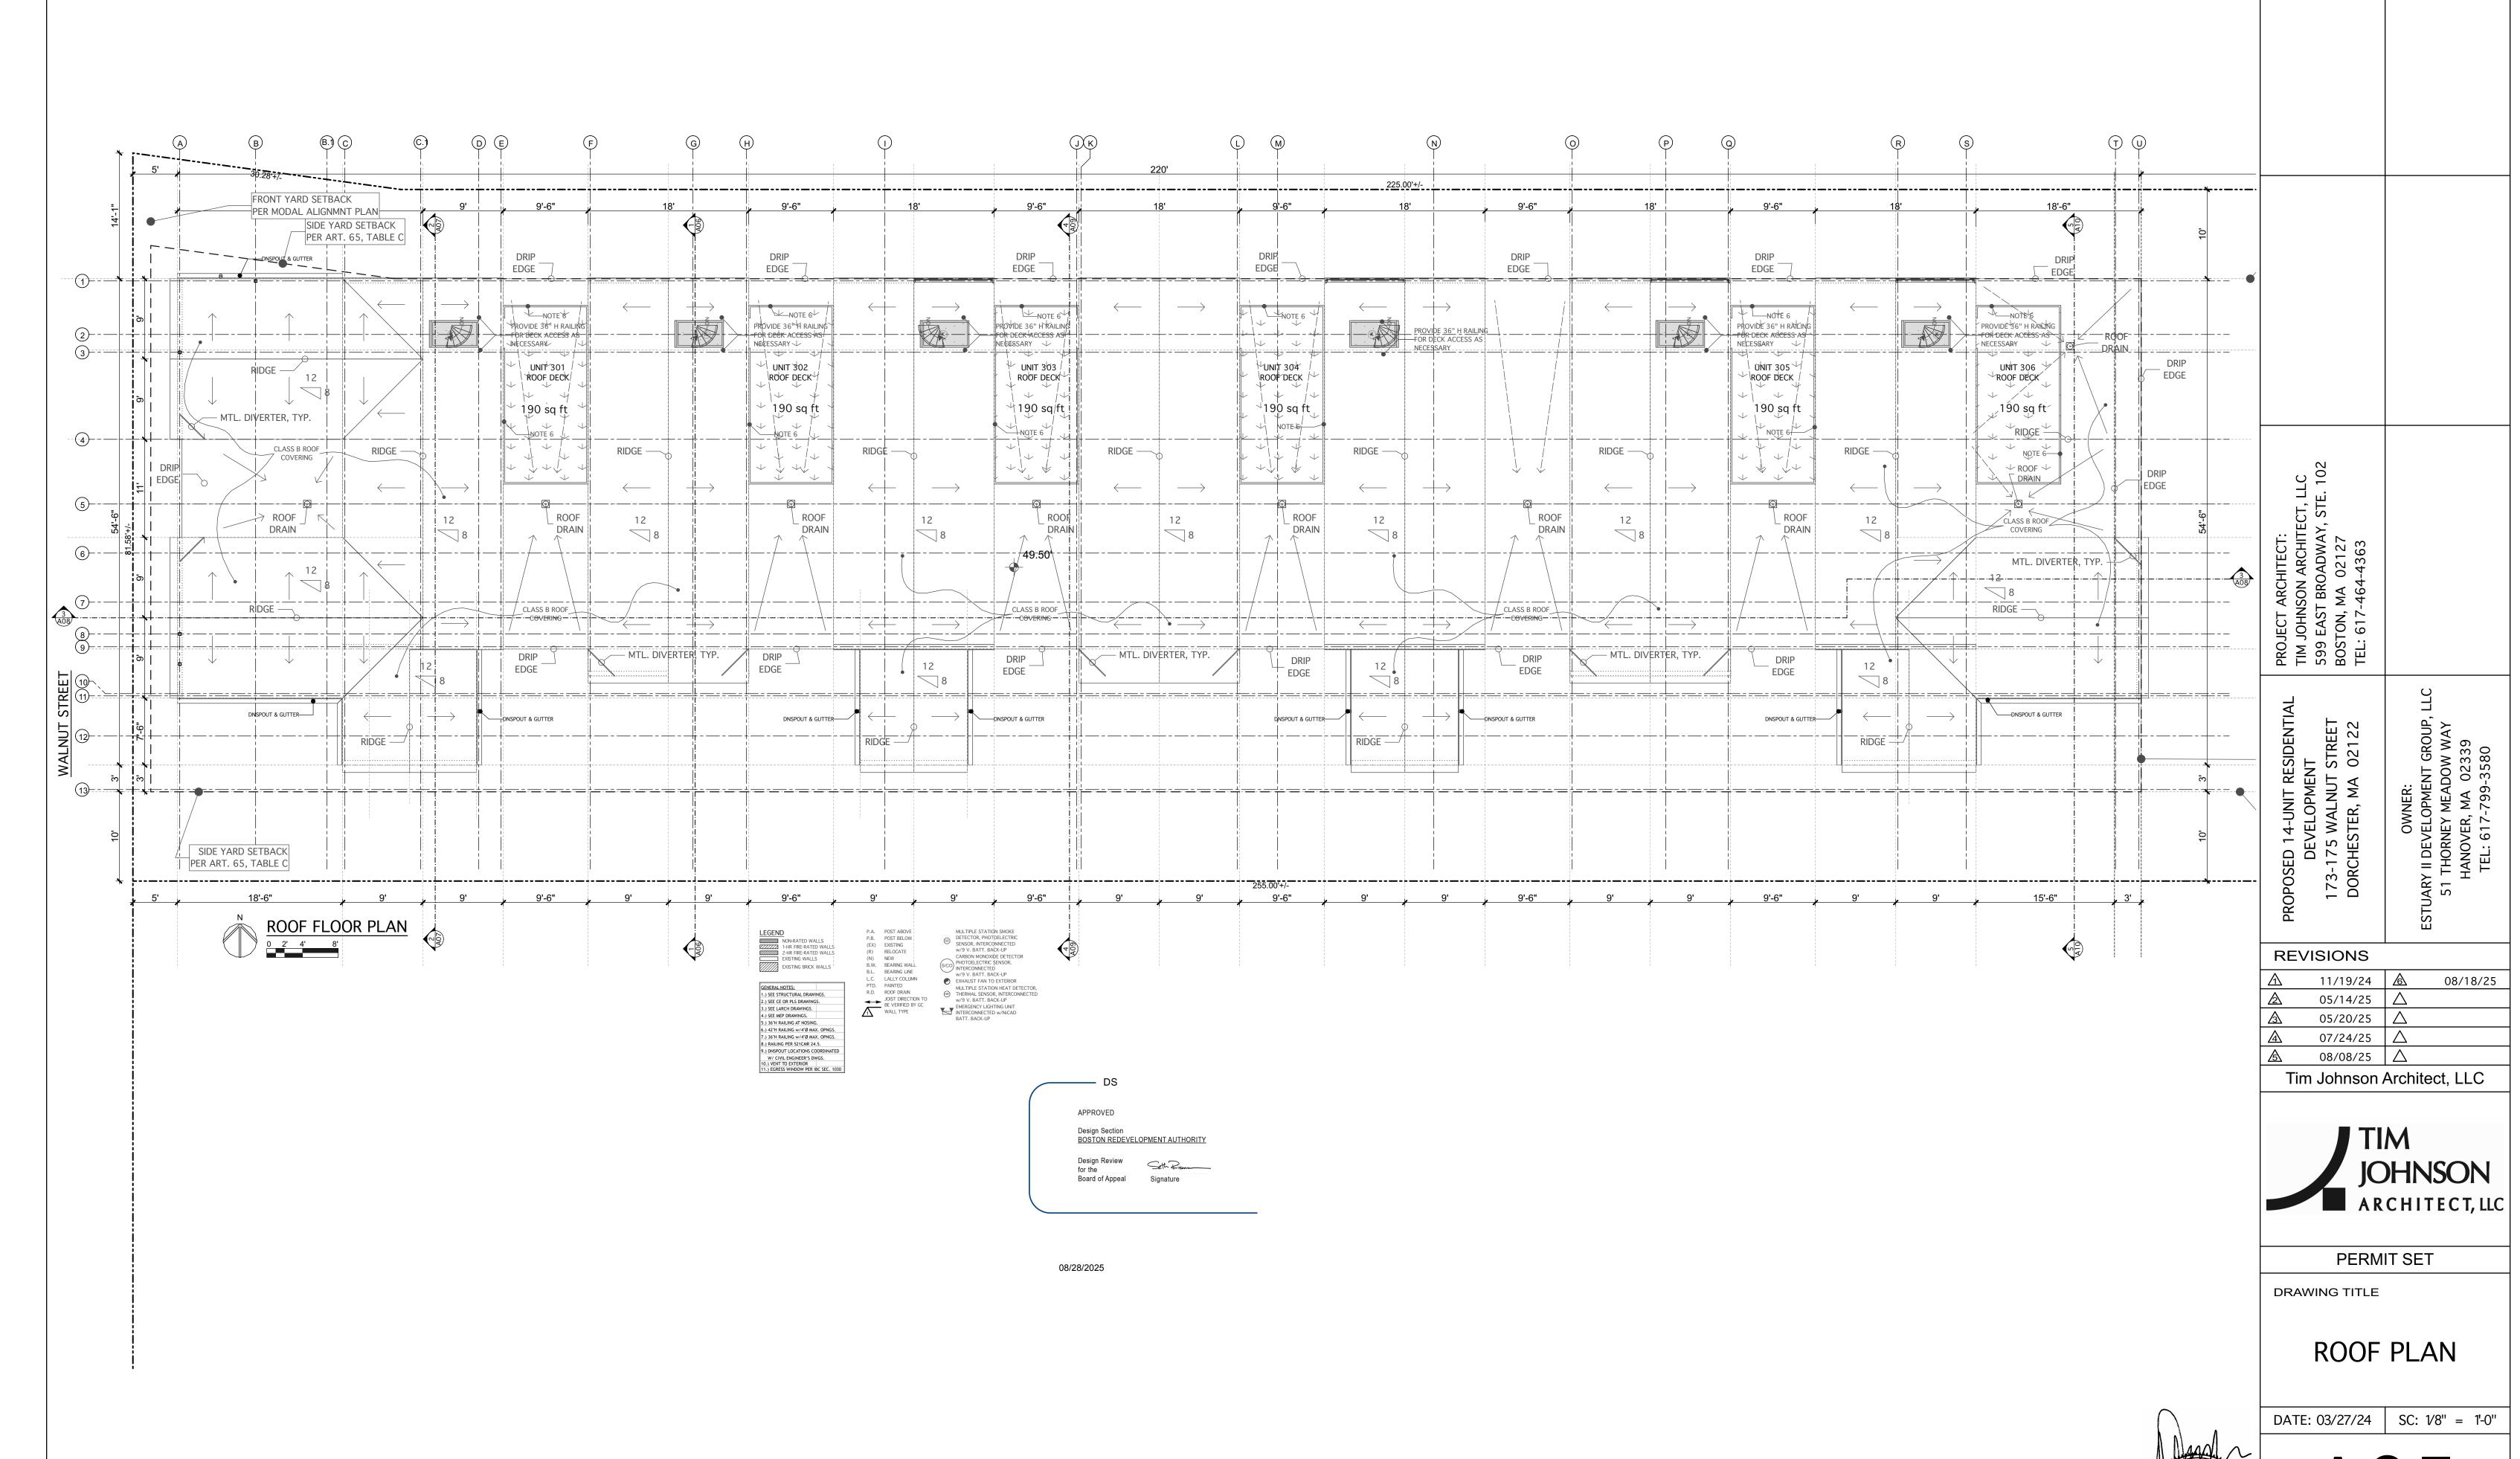

A05

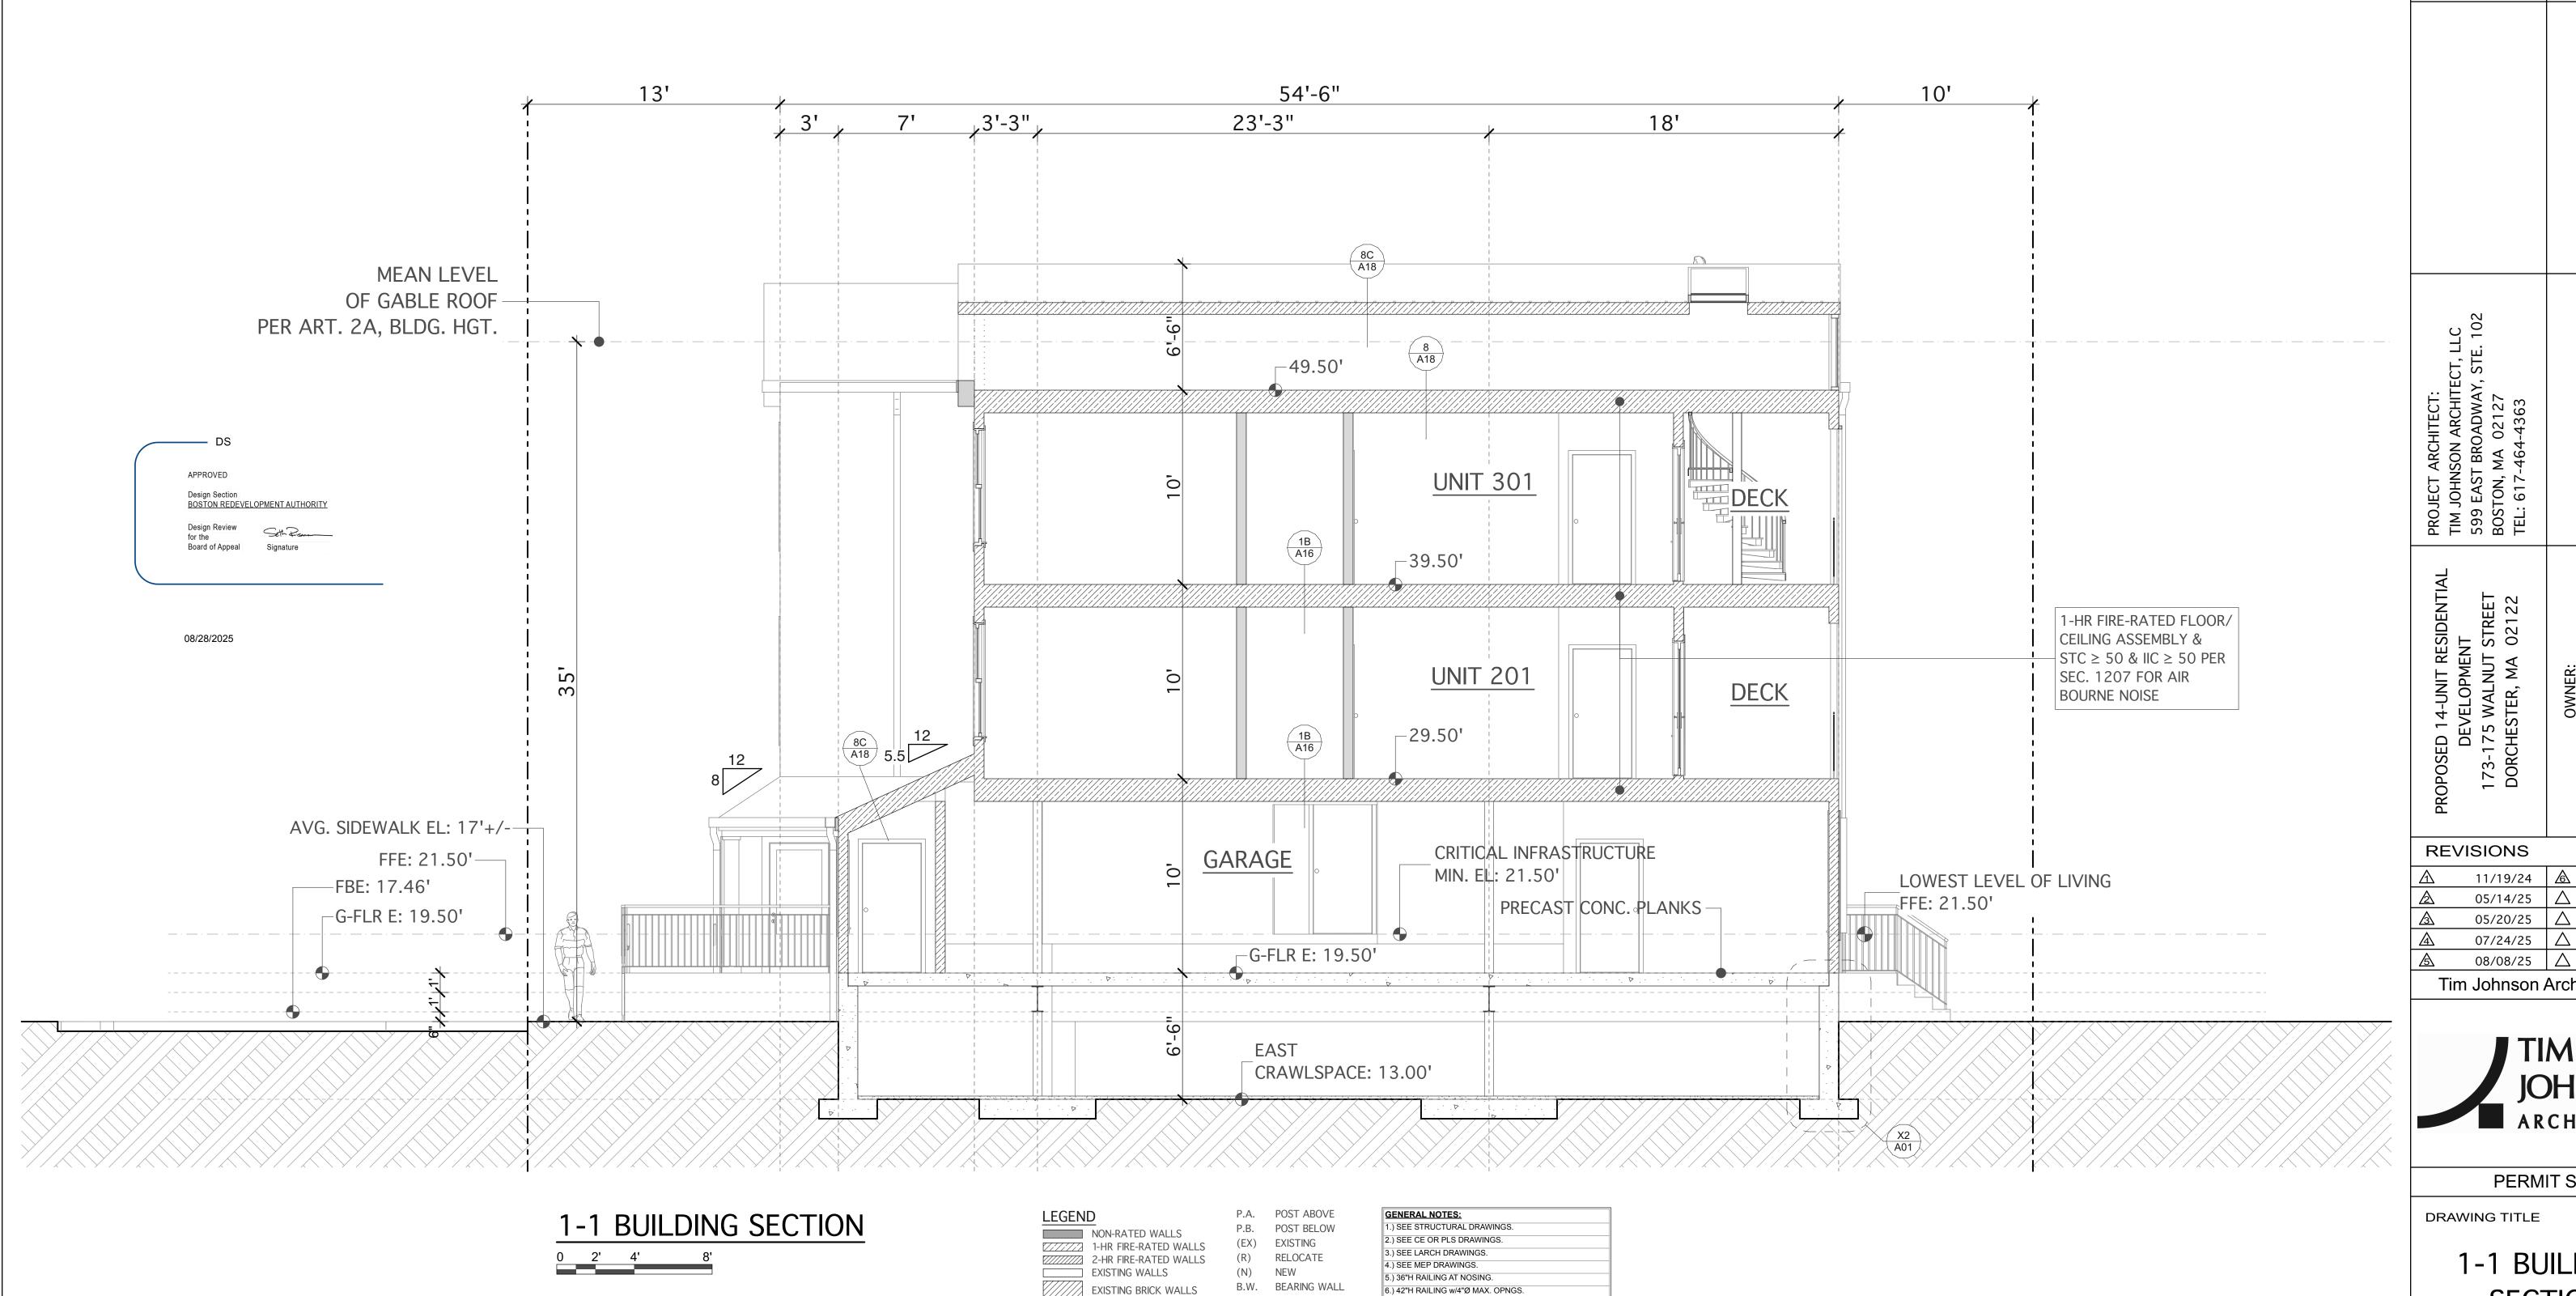

B.L. BEARING LINE

L.C. LALLY COLUMN

JOIST DIRECTION TO BE VERIFIED BY GC

PTD. PAINTED

R.D. ROOF DRAIN

1 FLOOR ASSEMBLY TYPE

7.) 36"H RAILING w/4"Ø MAX. OPNGS.

W/ CIVIL ENGINEER'S DWGS.

9.) DNSPOUT LOCATIONS COORDINATED

10.) MECH. VENT TO EXTERIOR PER 780 CMR 1203.5.2.1 11.) EGRESS WINDOW PER IBC SEC. 1030

. 2.) PROVIDE WALL REINFORCEMENT FOR FUTURE GRAB BARS FROM 32" TO 28" ALL SIDES PER 521 CMR

42.7.2 (c) FOR SHOWERS 42.5.3 FOR TOILETS

8.) RAILING PER 521CMR 24.5.

STREET 02122

11/19/24 08/18/25 05/14/25 🛆 05/20/25 07/24/25

Tim Johnson Architect, LLC




PERMIT SET

1-1 BUILDING SECTION

No. 6995 BOSTON, MA

DATE: 03/27/24 | SC: 1/4" = 1'-0"

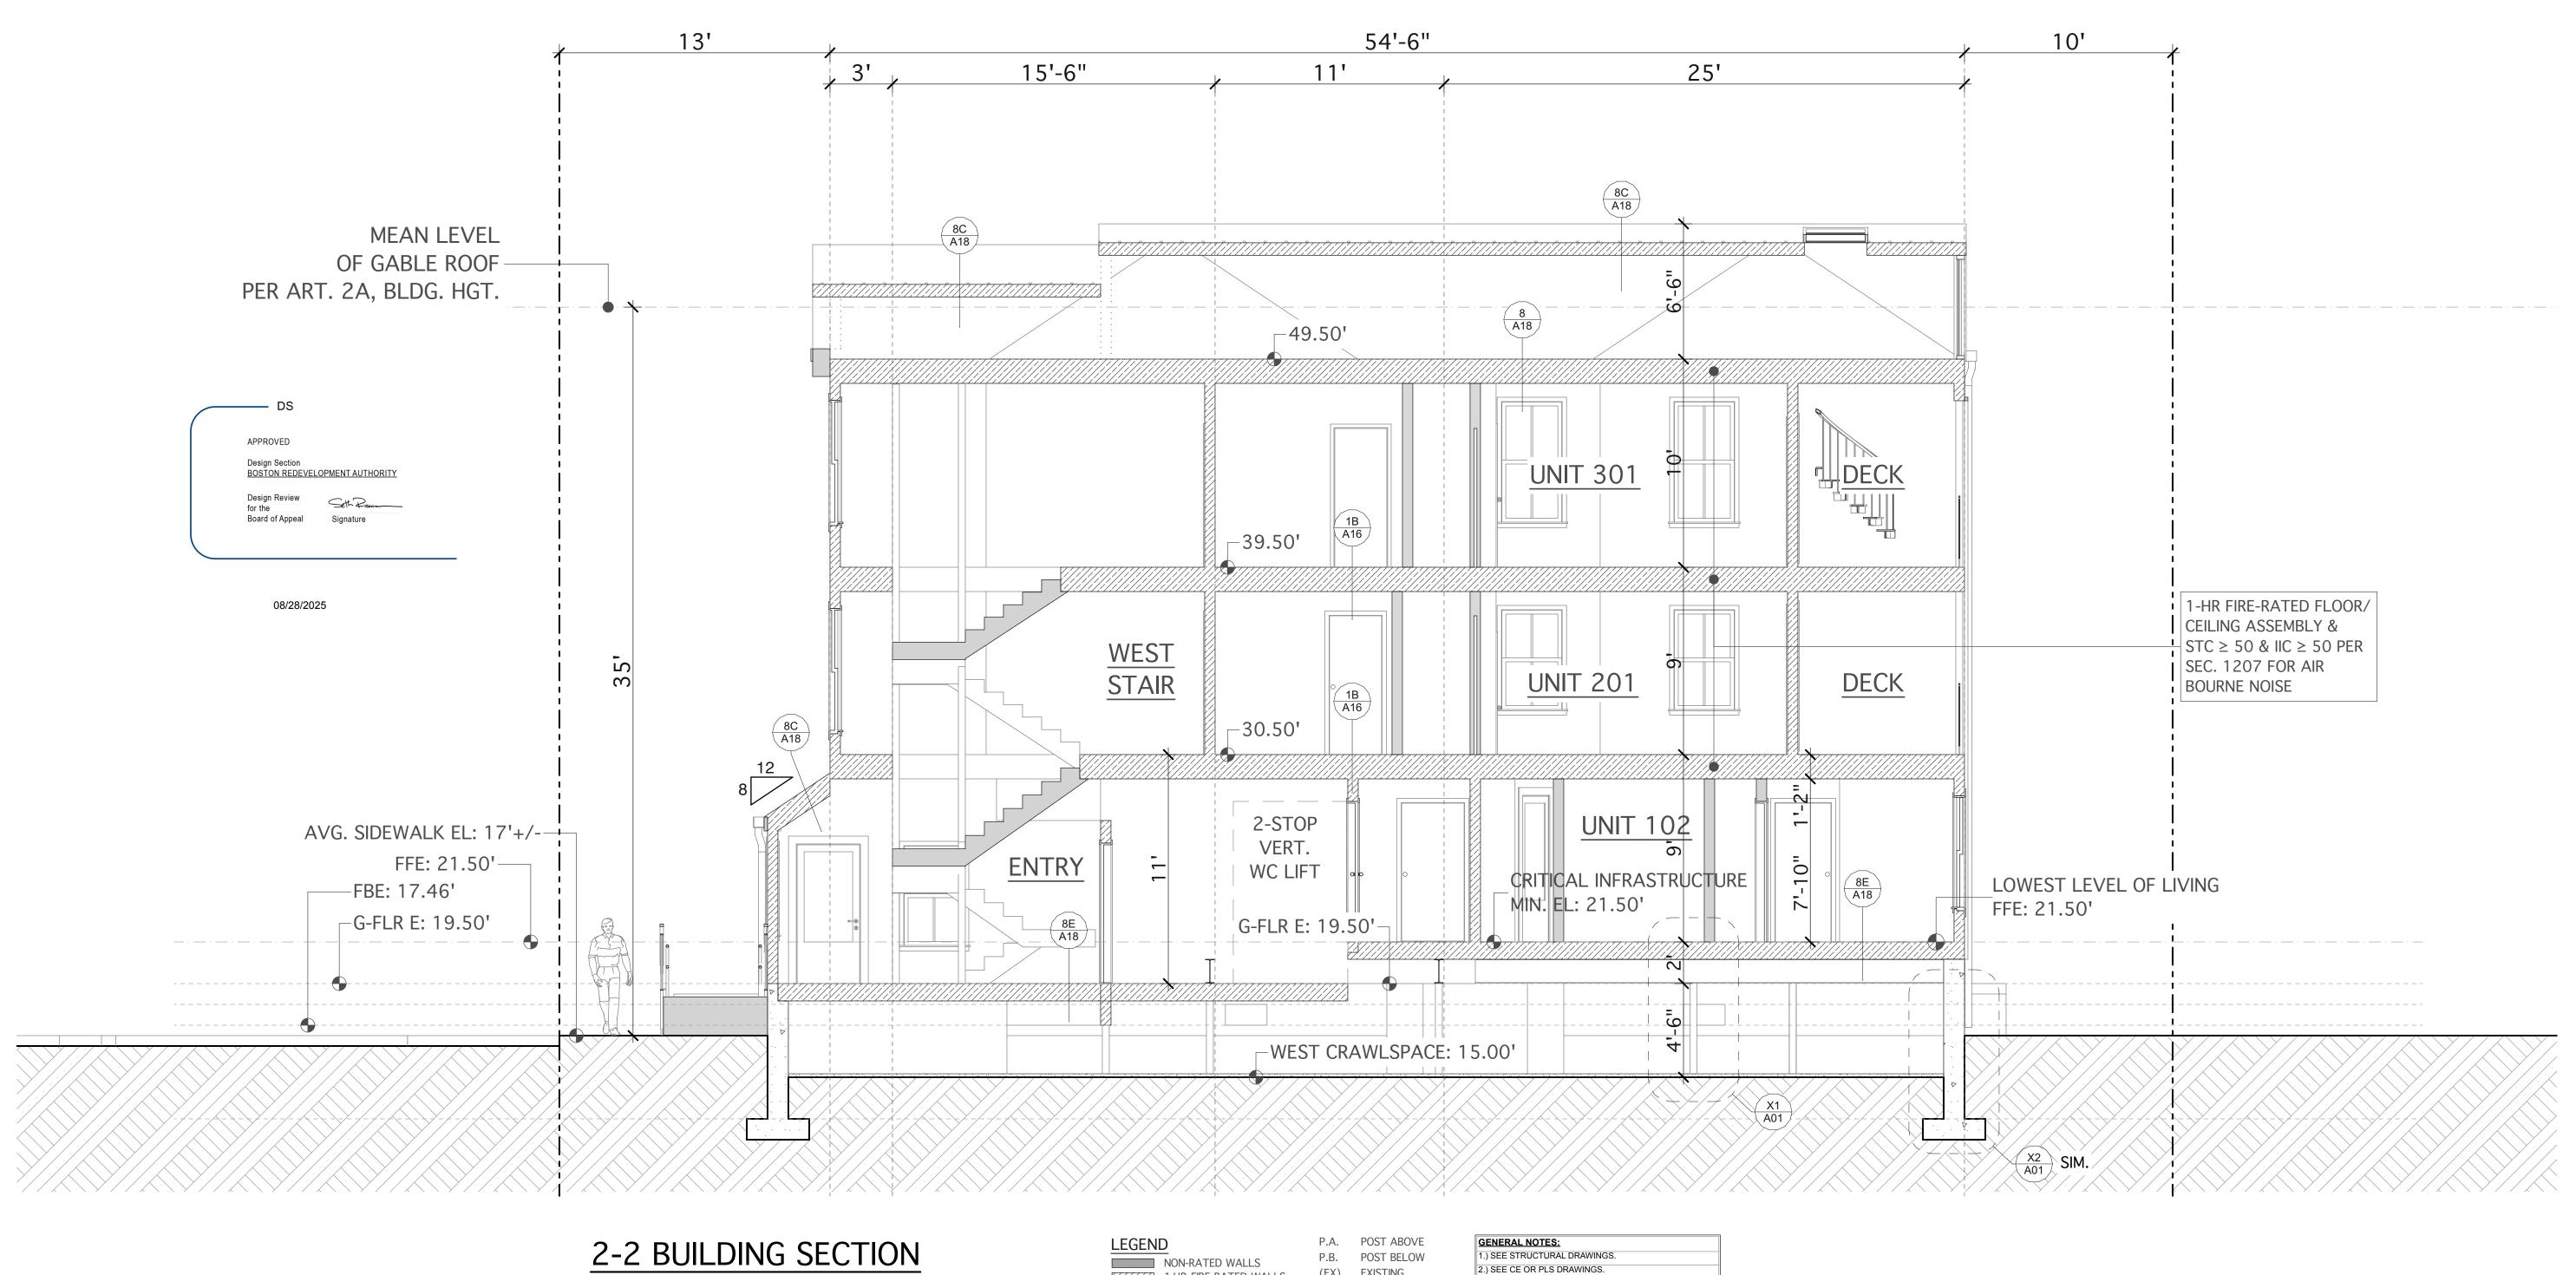

(EX) EXISTING

(R) RELOCATE

B.W. BEARING WALL

B.L. BEARING LINE

L.C. LALLY COLUMN

JOIST DIRECTION TO BE VERIFIED BY GC

PTD. PAINTED

R.D. ROOF DRAIN

(N) NEW

3.) SEE LARCH DRAWINGS.
4.) SEE MEP DRAWINGS.

5.) 36"H RAILING AT NOSING.

8.) RAILING PER 521CMR 24.5.

6.) 42"H RAILING w/4"Ø MAX. OPNGS.

7.) 36"H RAILING w/4"Ø MAX. OPNGS.

W/ CIVIL ENGINEER'S DWGS.

9.) DNSPOUT LOCATIONS COORDINATED

10.) MECH. VENT TO EXTERIOR PER 780 CMR 1203.5.2.1 11.) EGRESS WINDOW PER IBC SEC. 1030

. 2.) PROVIDE WALL REINFORCEMENT FOR FUTURE GRAB BARS FROM 32" TO 28" ALL SIDES PER 521 CMR

42.7.2 (c) FOR SHOWERS 42.5.3 FOR TOILETS

7///// 1-HR FIRE-RATED WALLS

2-HR FIRE-RATED WALLS EXISTING WALLS

1 FLOOR ASSEMBLY TYPE

EXISTING BRICK WALLS

0 2' 4' 8'

STREET 02122 OWNER:
ESTUARY II DEVELOPMEN
51 THORNEY MEADO
HANOVER, MA 0
TEL: 617-799-3 **REVISIONS**

TIM **JOHNSON**

Tim Johnson Architect, LLC

11/19/24

05/14/25 🛆

07/24/25 08/08/25 🛆

05/20/25

08/18/25


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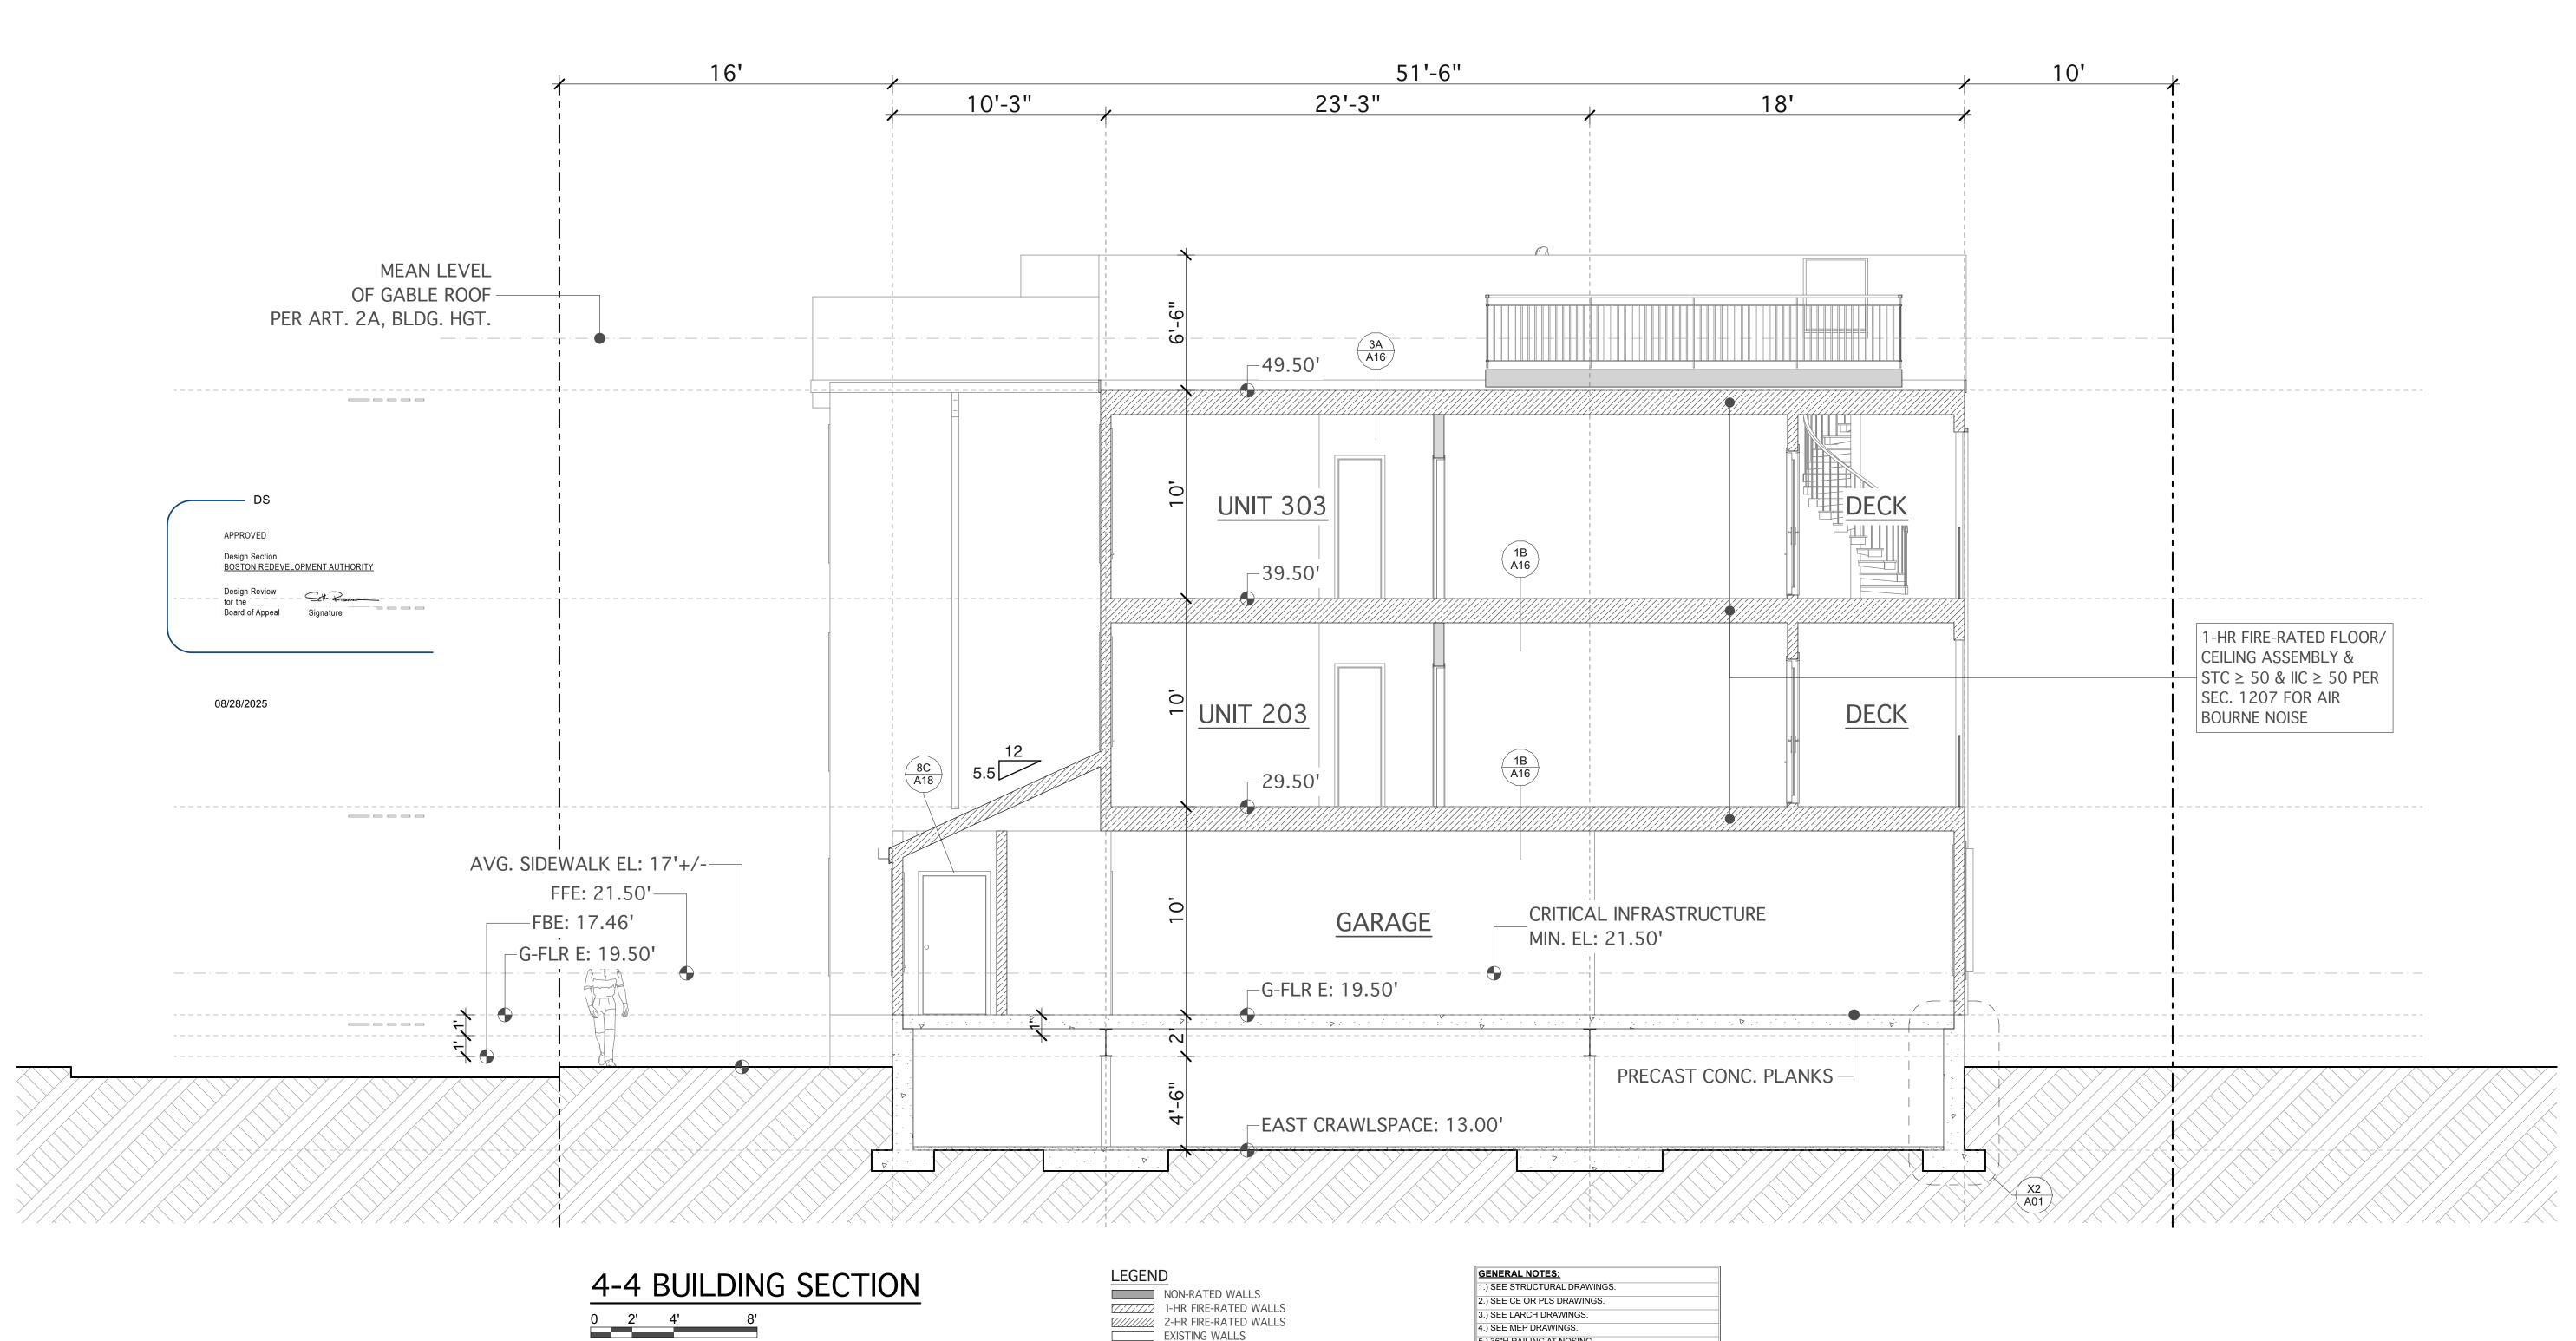
DRAWING TITLE

2-2 BUILDING SECTION

DATE: 03/27/24 | SC: 1/4" = 1'-0"

No. 6995 BOSTON, MA



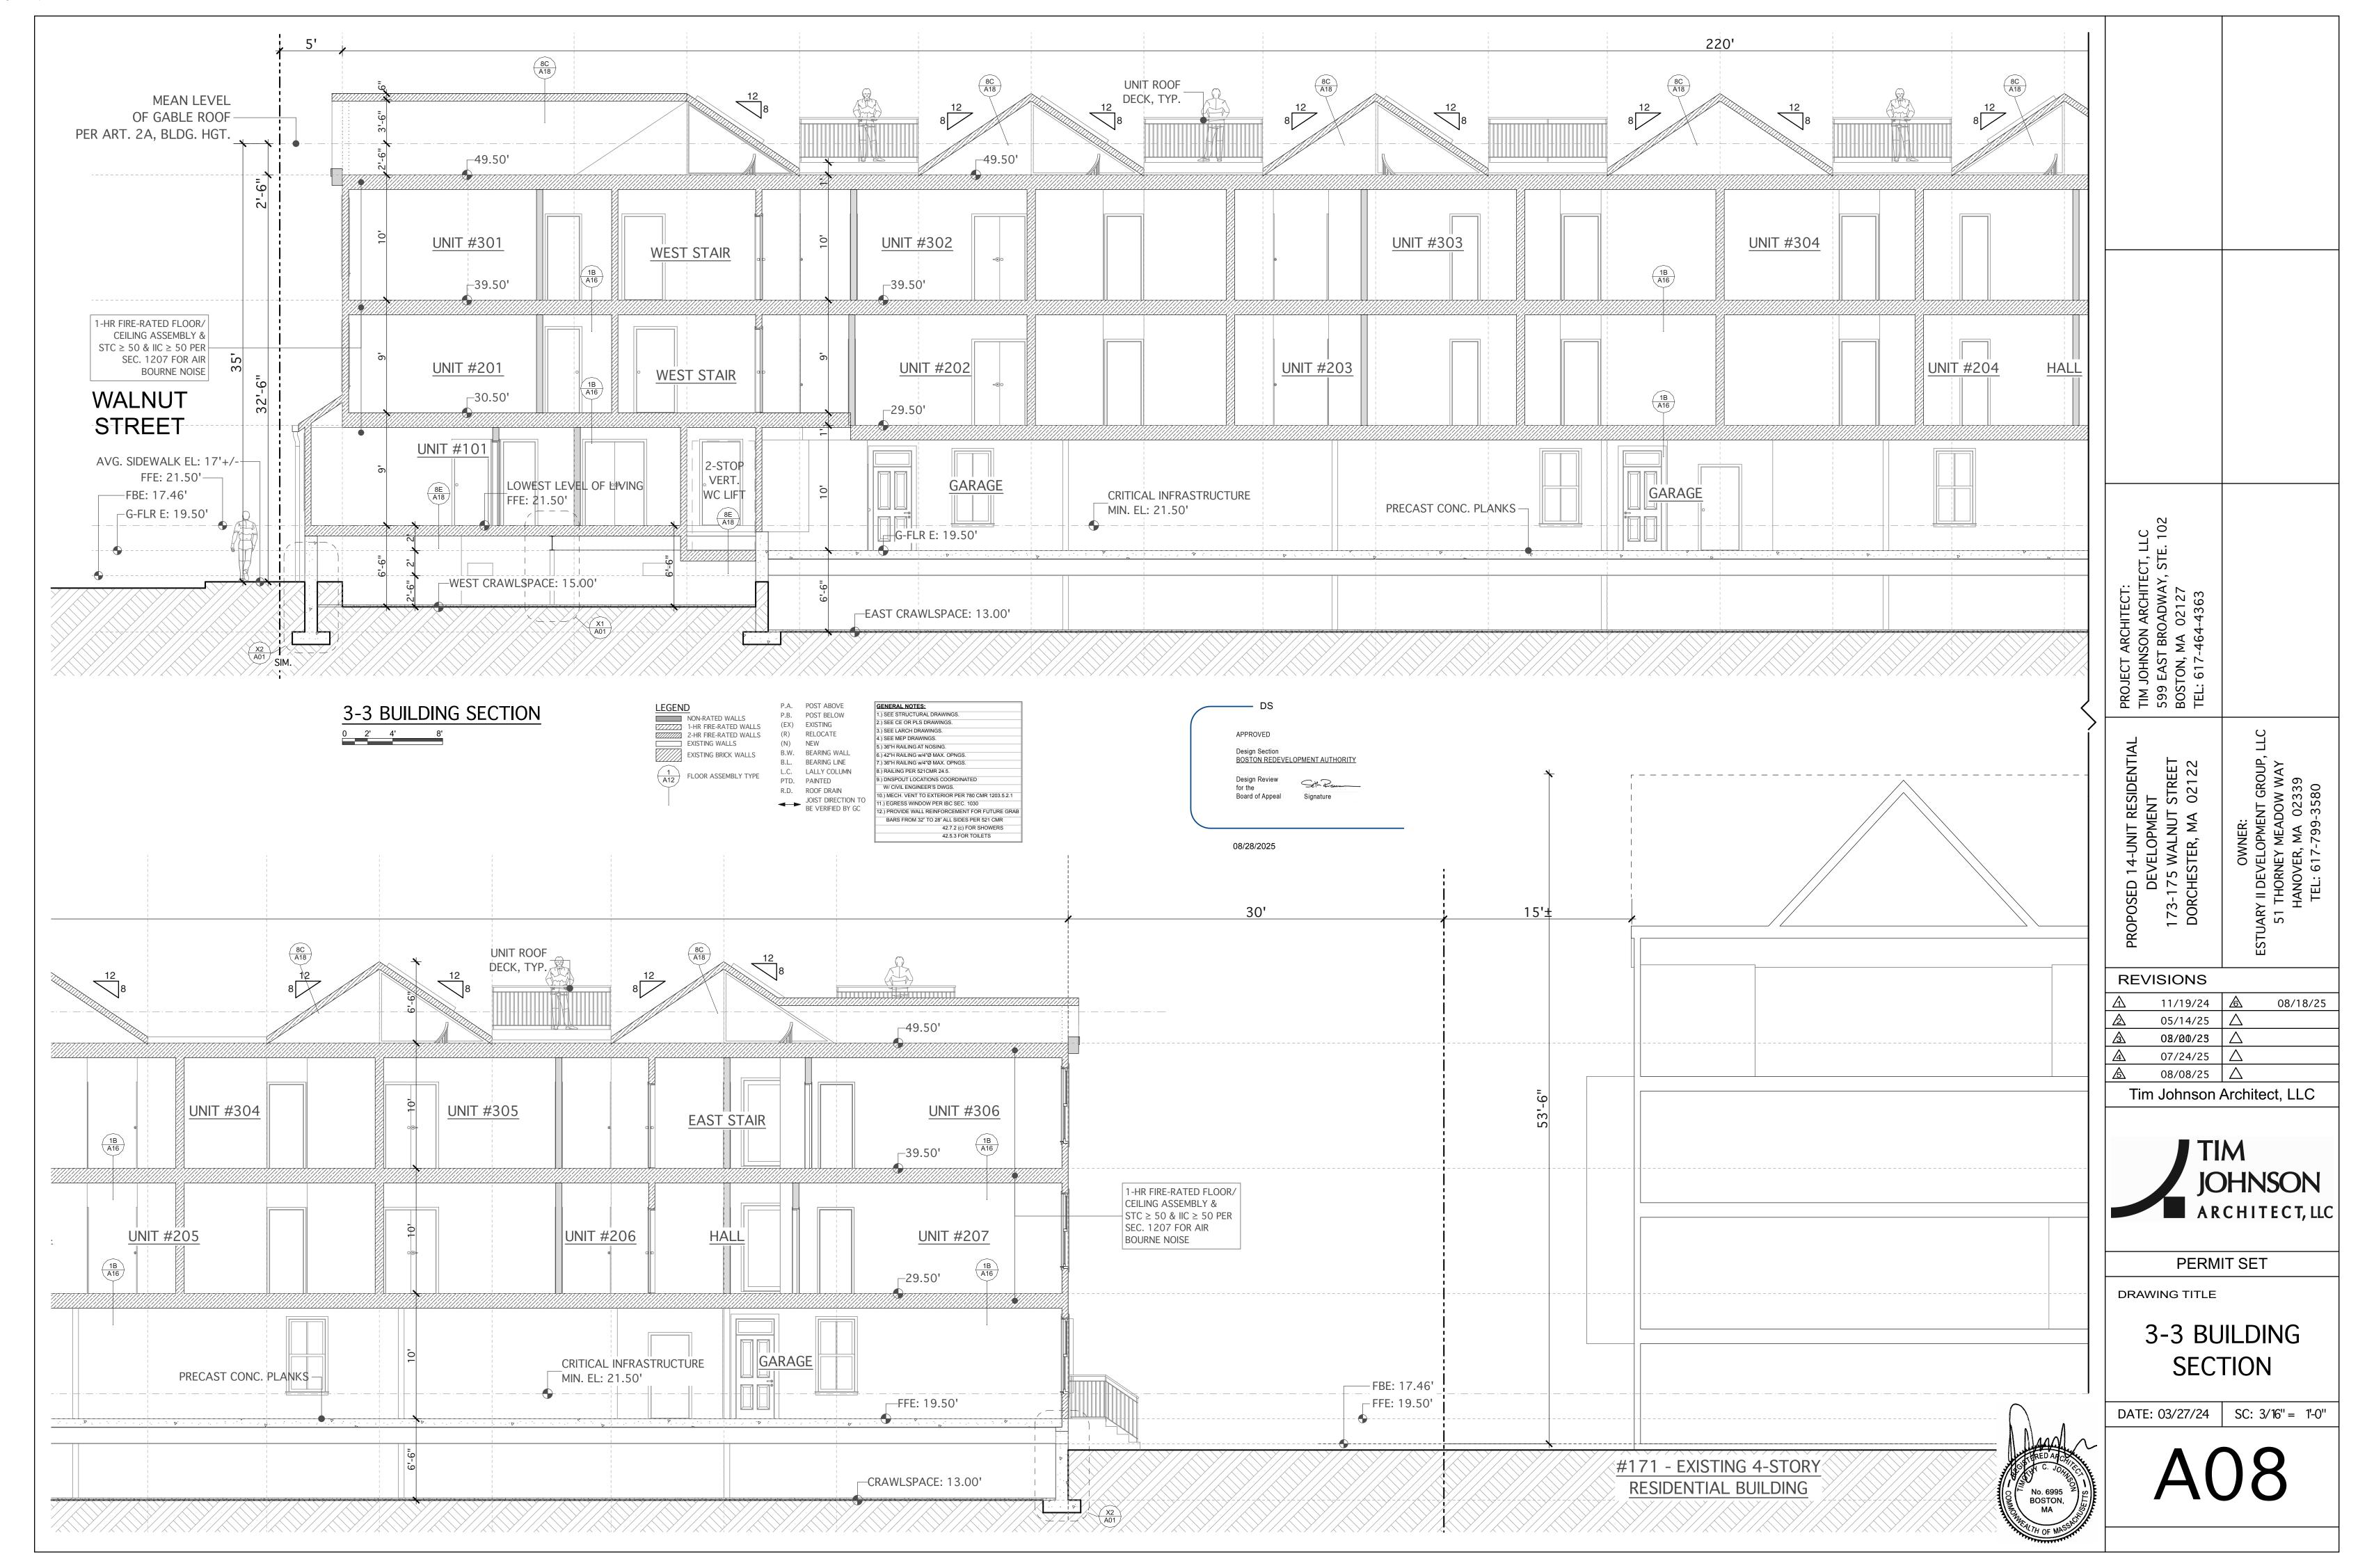

EXISTING WALLS

1 FLOOR ASSEMBLY TYPE

EXISTING BRICK WALLS

5.) 36"H RAILING AT NOSING.

6.) 42"H RAILING w/4"Ø MAX. OPNGS.

7.) 36"H RAILING w/4"Ø MAX. OPNGS. 8.) RAILING PER 521CMR 24.5.

9.) DNSPOUT LOCATIONS COORDINATED W/ CIVIL ENGINEER'S DWGS.

11.) EGRESS WINDOW PER IBC SEC. 1030

10.) MECH. VENT TO EXTERIOR PER 780 CMR 1203.5.2.1

(2.) PROVIDE WALL REINFORCEMENT FOR FUTURE GRAB BARS FROM 32" TO 28" ALL SIDES PER 521 CMR

42.7.2 (c) FOR SHOWERS 42.5.3 FOR TOILETS

STREET 02122 **REVISIONS** 11/19/24 08/18/25 05/14/25 🛆 05/20/25 07/24/25 🛆 08/08/25 🛆 Tim Johnson Architect, LLC


TIM **JOHNSON**


PERMIT SET

DRAWING TITLE

4-4 BUILDING SECTION

DATE: 03/27/24 | SC: 1/4" = 1'-0"

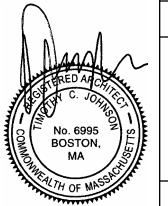

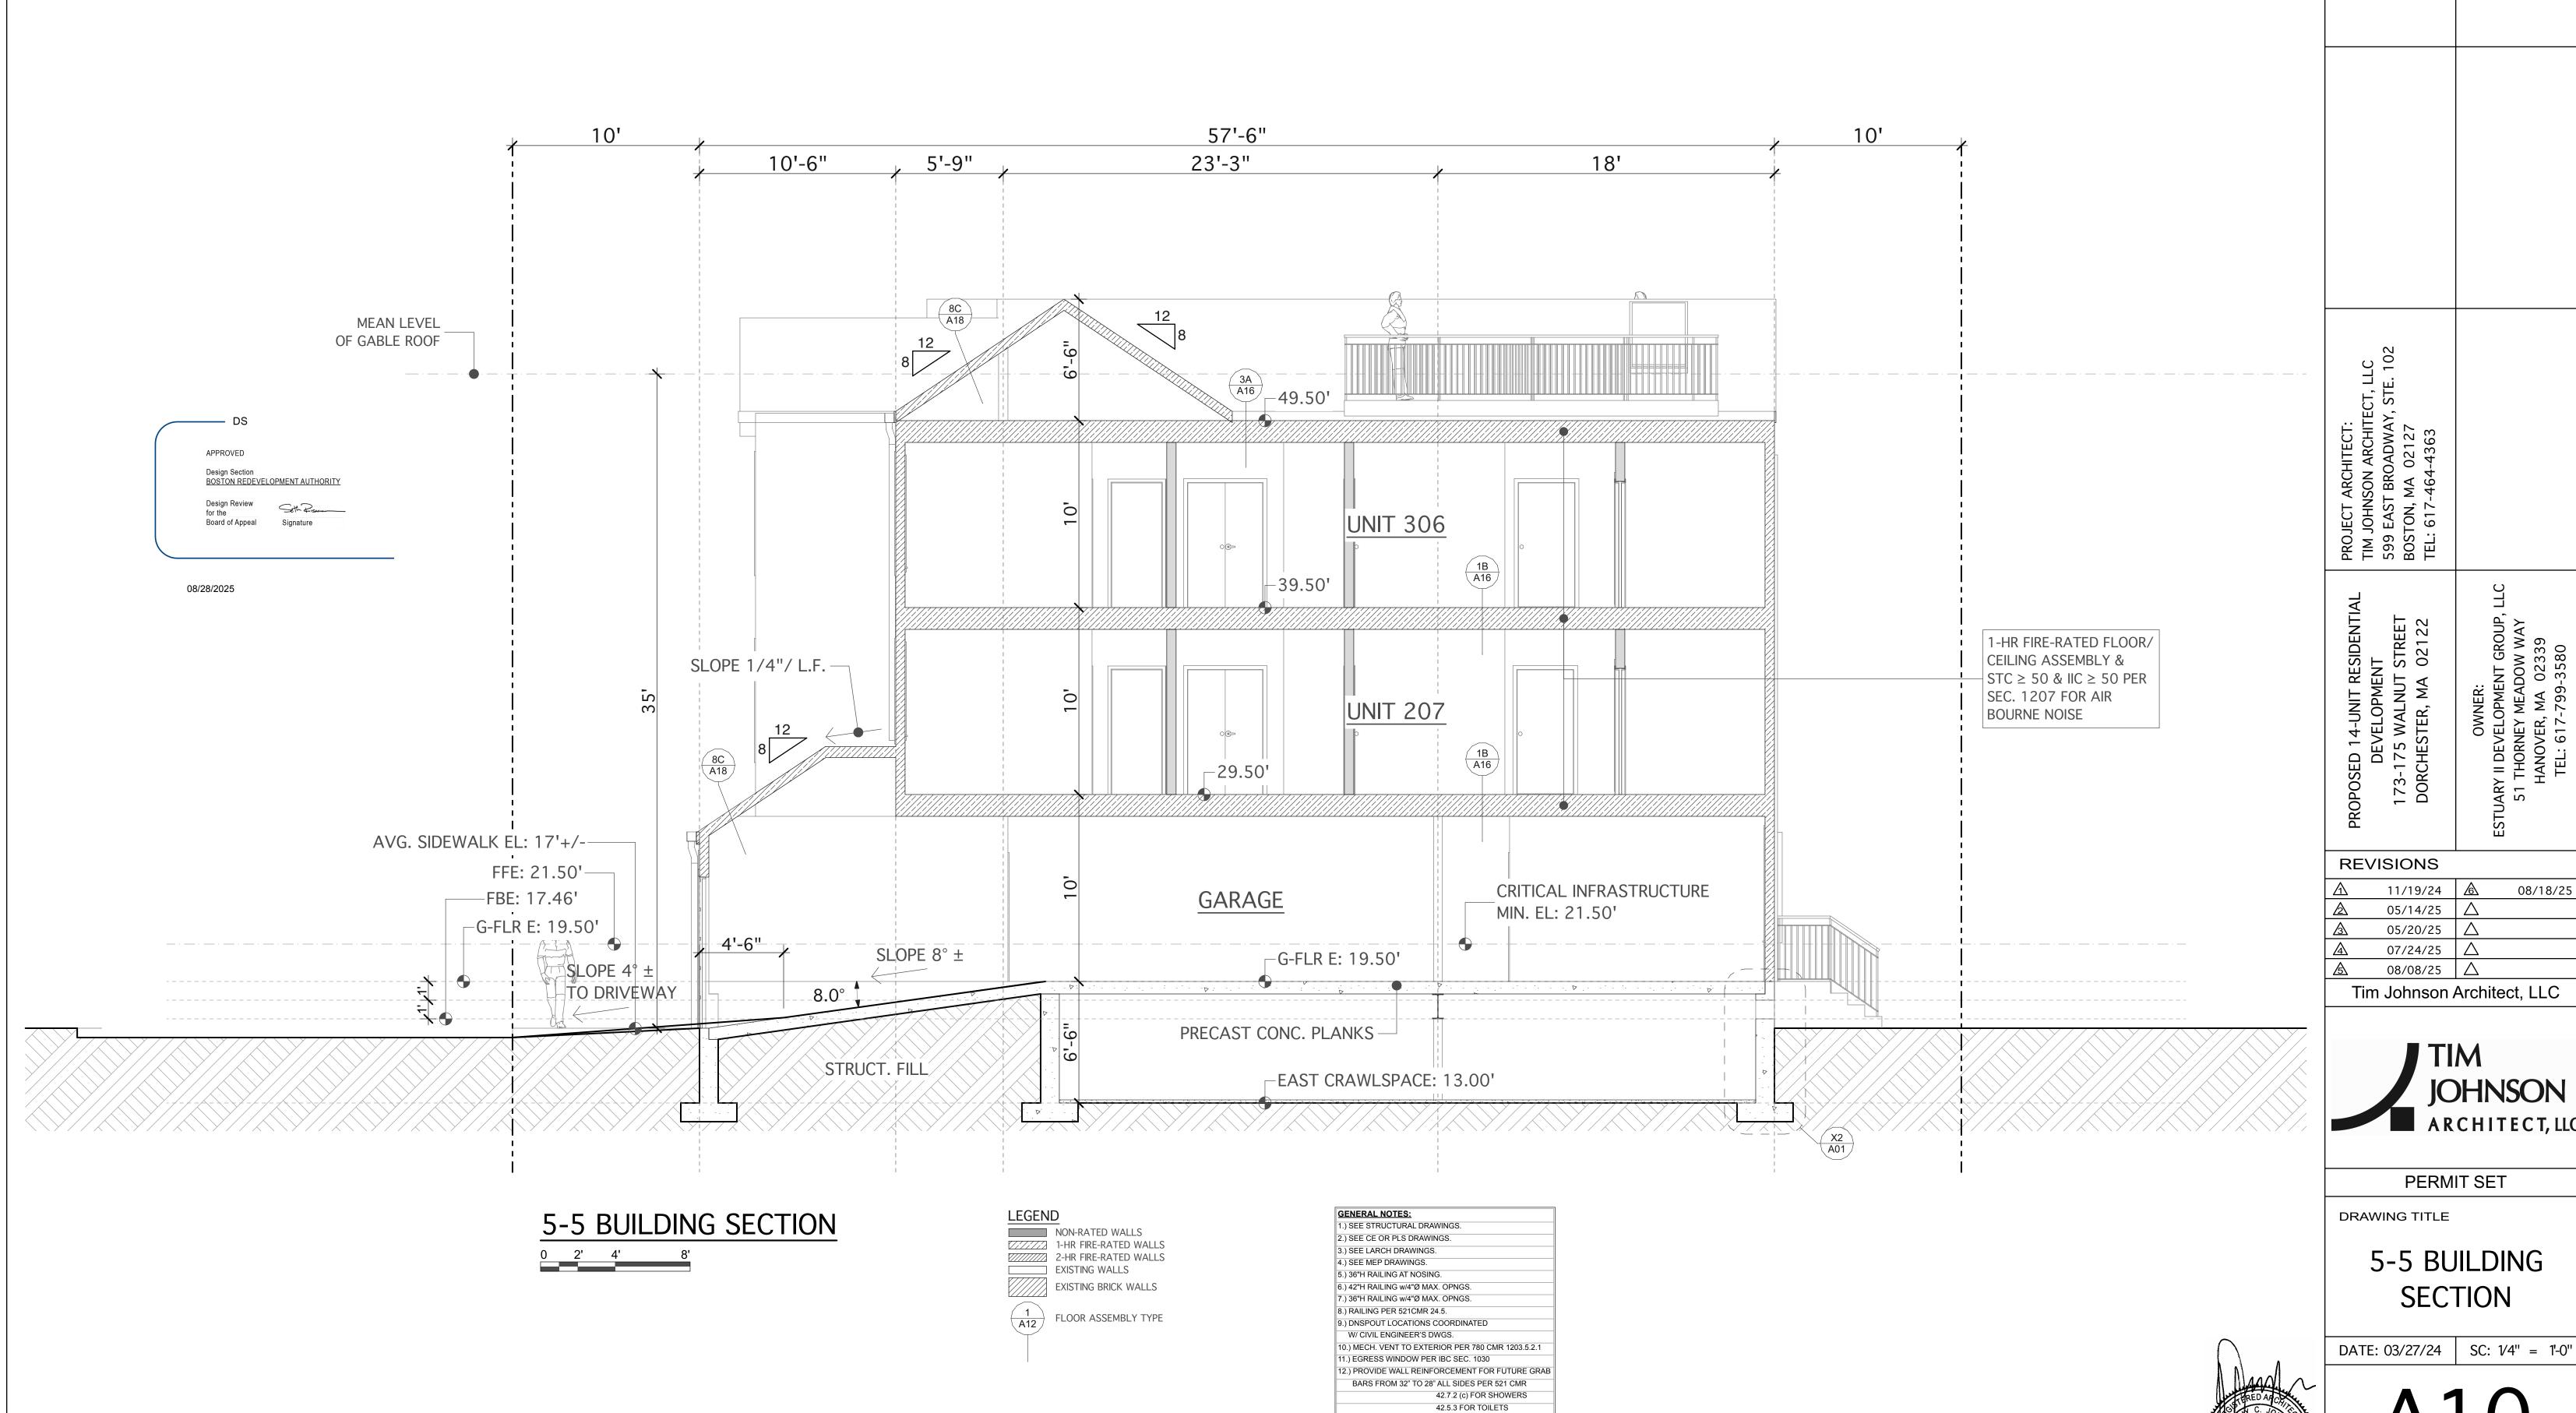


OWNER:
ESTUARY II DEVELOPMEN
51 THORNEY MEAD
HANOVER, MA (

08/18/25



5-5 BUILDING

No. 6995 BOSTON, MA

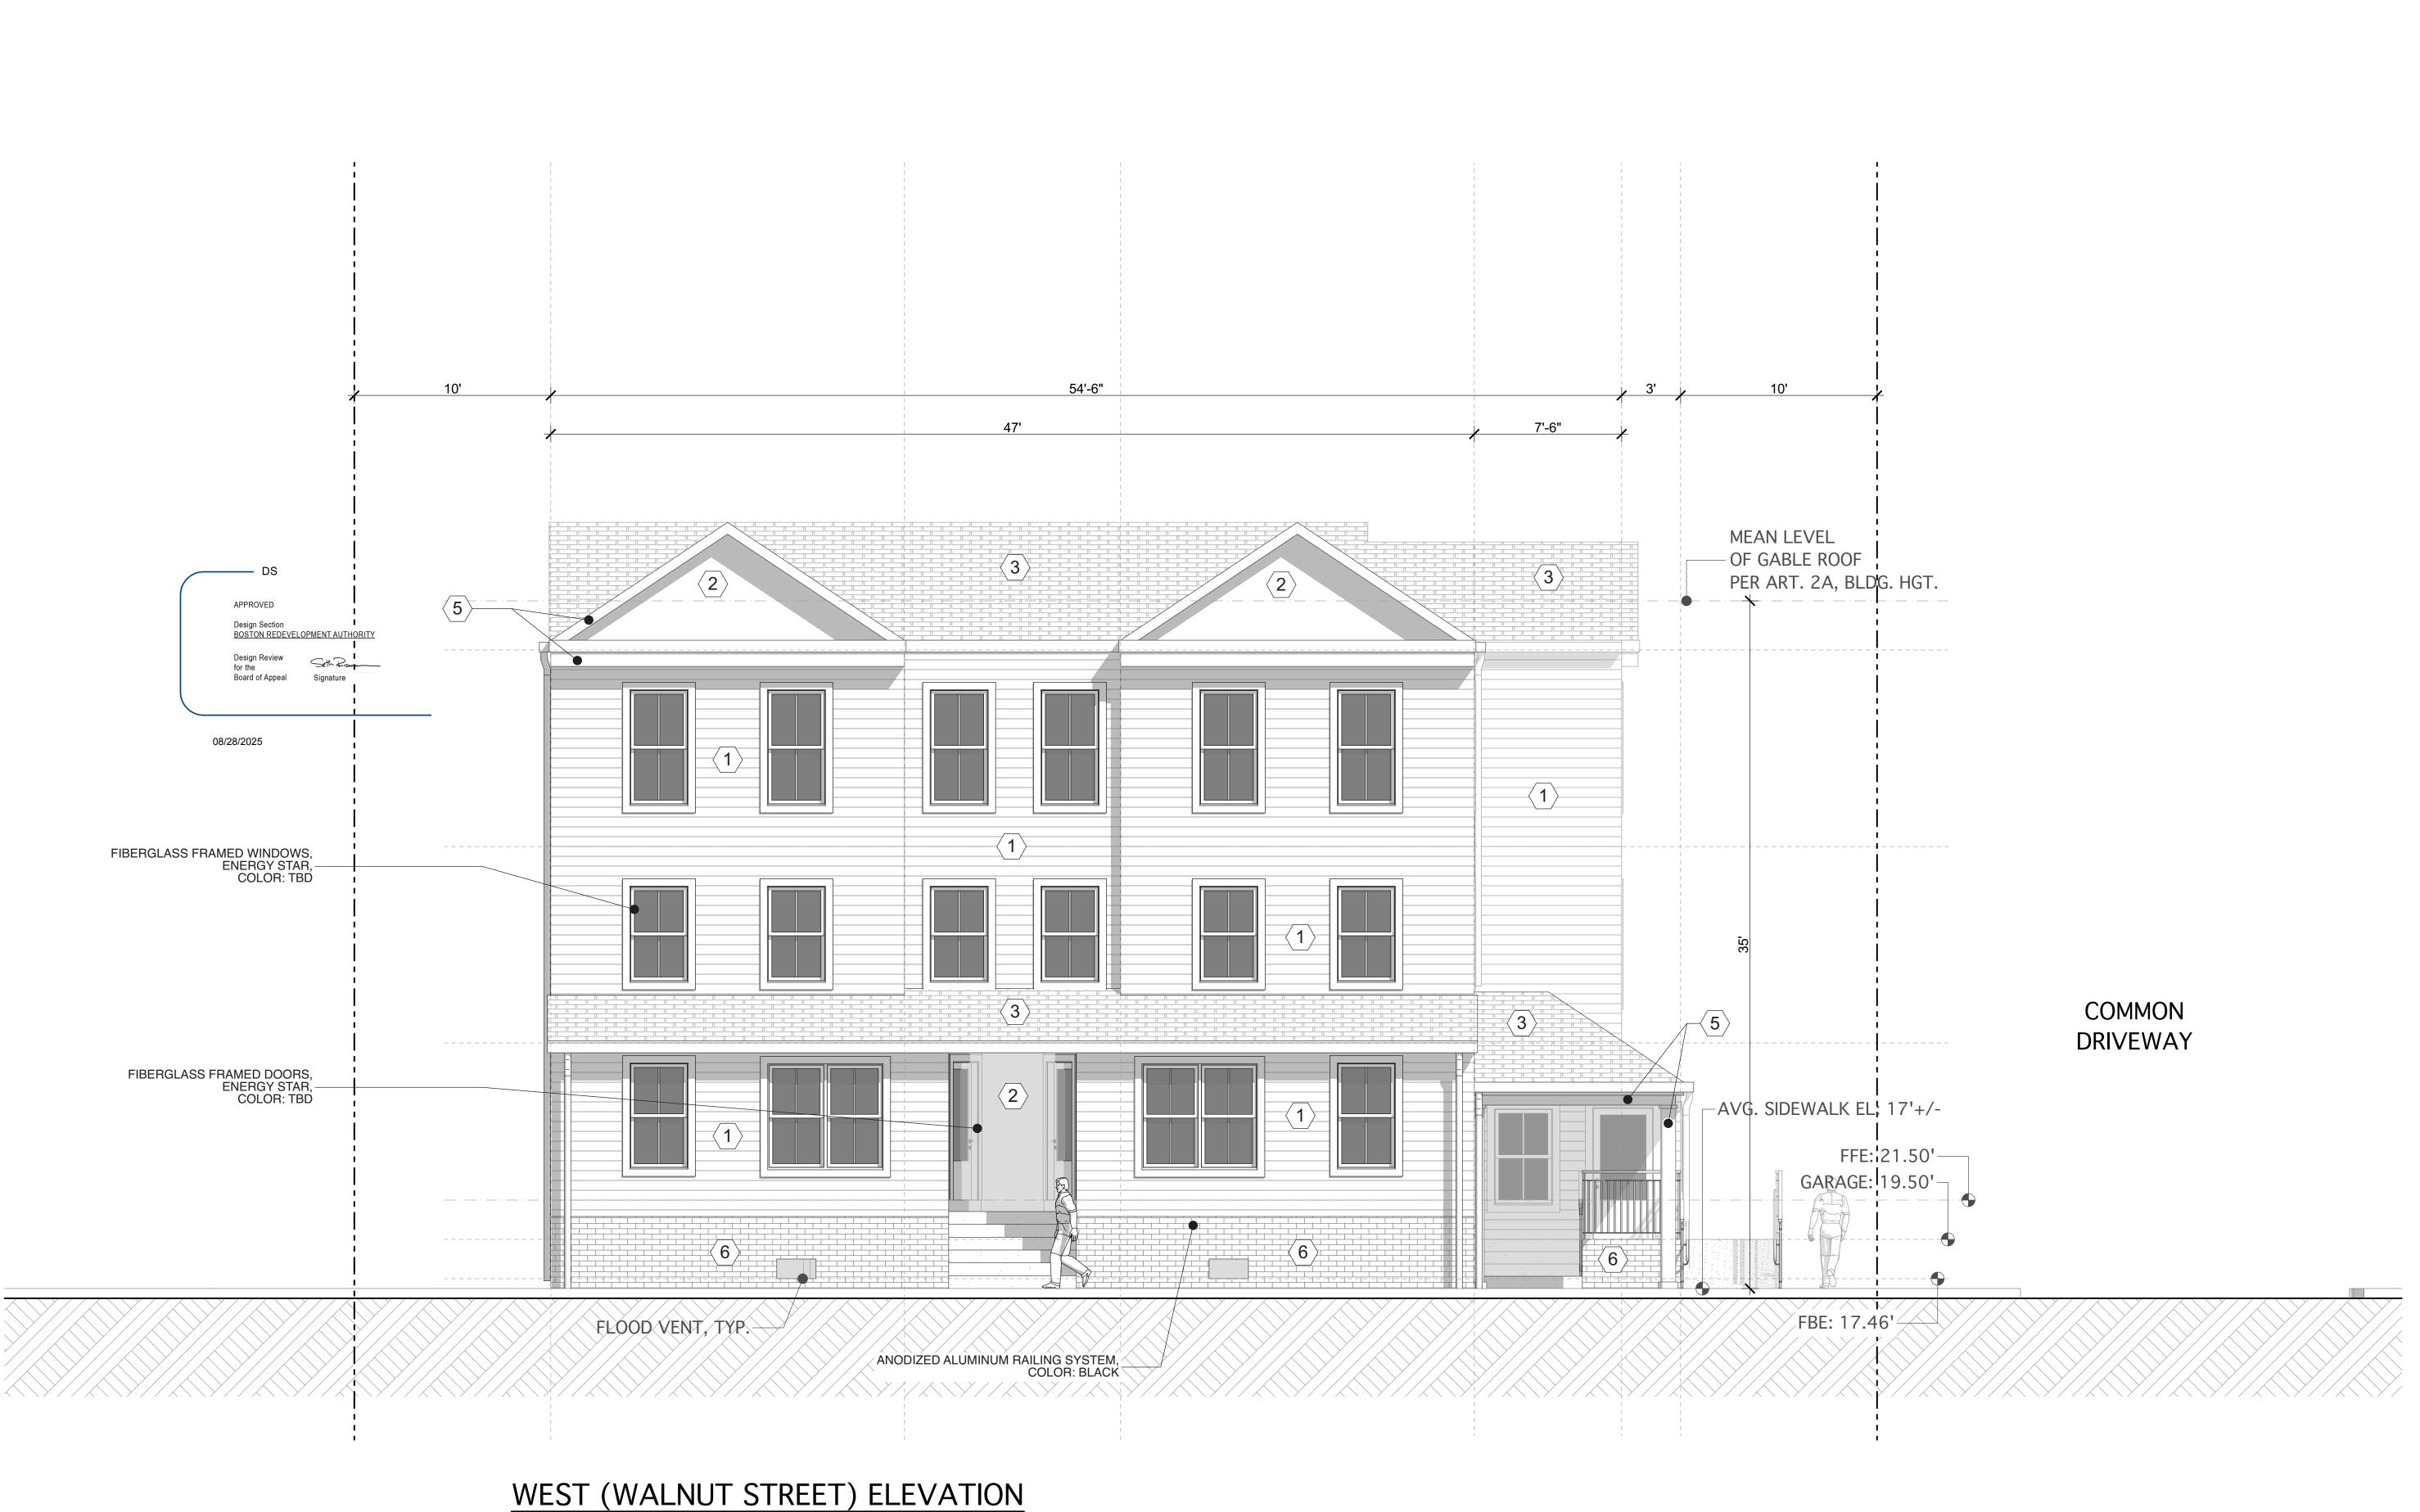

EXTERIOR FINISH MATERIALS LEGEND

FIBER CEMENT LAP SIDING, SMOOTH,
6" EXPOSURE, HARDIE PLANK OR SIMILAR,
COLOR: TBD

FIBER CEMENT LAP SIDING, SMOOTH,
9" EXPOSURE, HARDIE PLANK OR SIMILAR,
COLOR: TBD

2 5/16" FIBER CEMENT PANELS, COLOR: TBD

FIBERGLASS ROOF SHINGLES, ARCH. GRADE, COLOR: TBD

4 CONCRETE FINISH

POLY-ASH TRIM BOARD, PAINTED, COLOR: TBD

6 BRICK VENEER, COLOR: TBD



Tim Johnson Architect, LLC TIM **JOHNSON**

PERMIT SET

REVISIONS

11/19/24

05/14/25 🛆

07/24/25 🛆 08/08/25 🛆


05/20/25

08/18/25

DRAWING TITLE

WEST ELEVTION

DATE: 03/27/24 | SC: 1/4" = 1'-0"

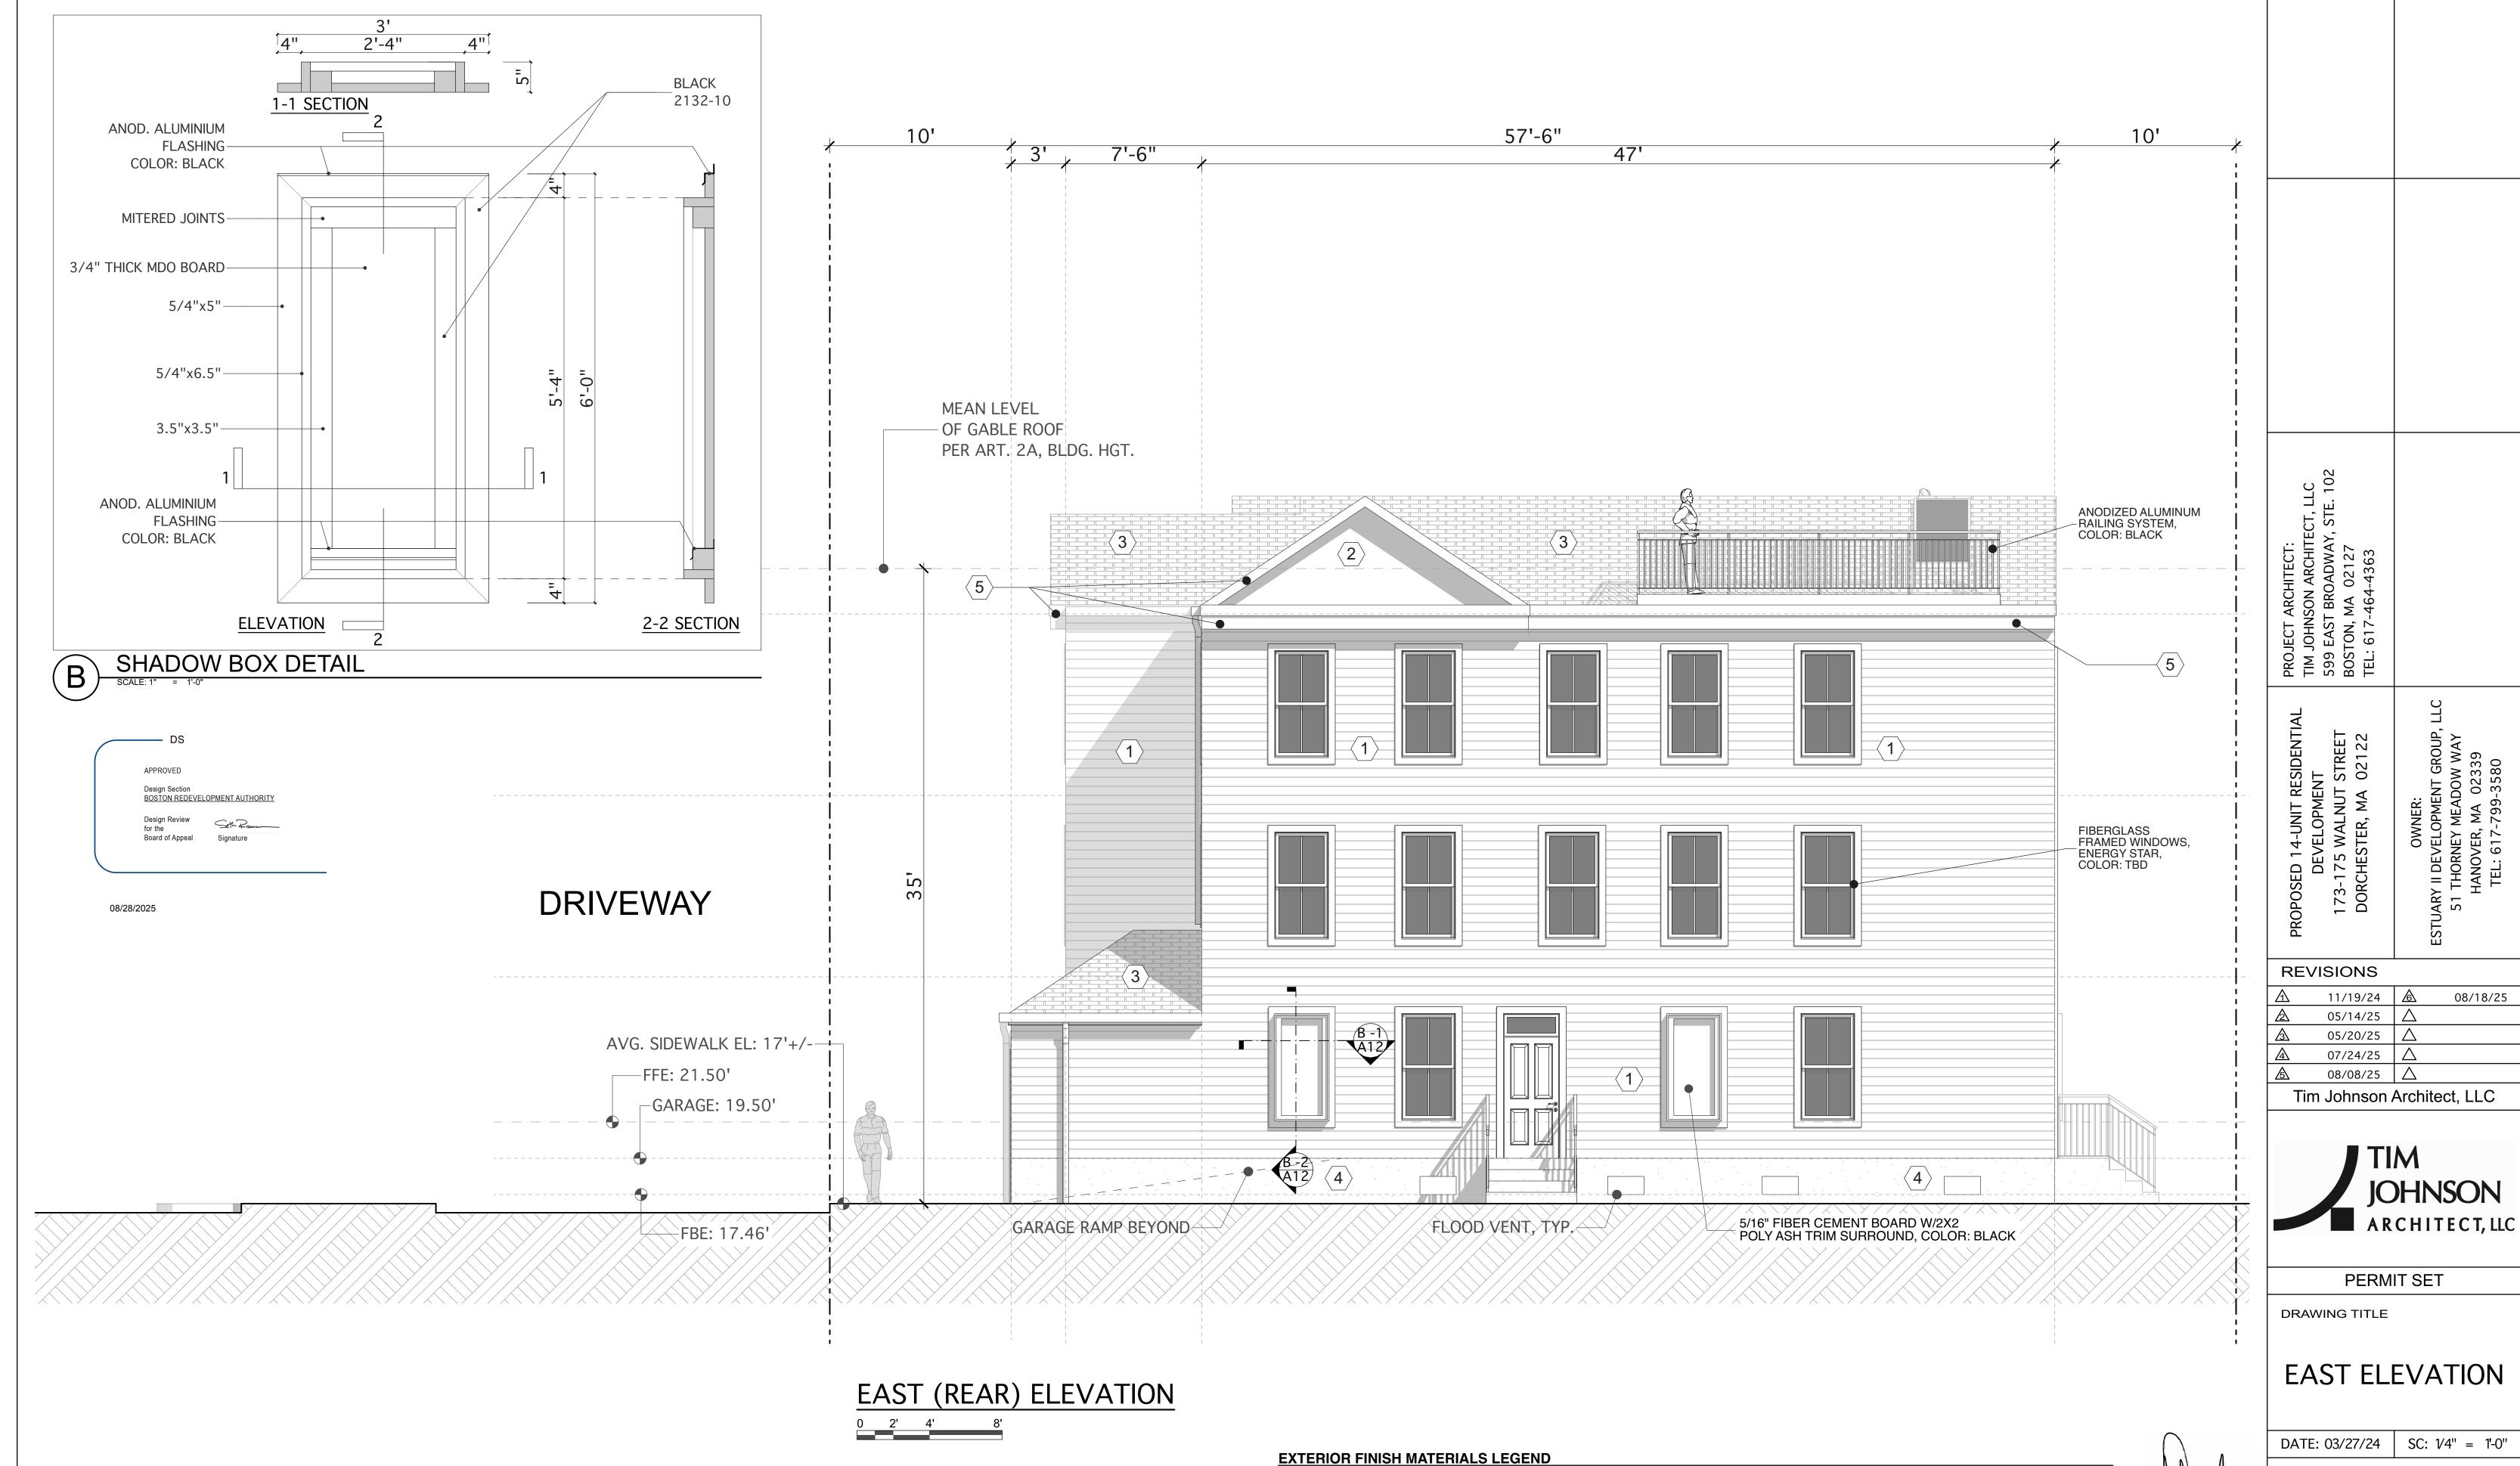

FIBER CEMENT LAP SIDING, SMOOTH, 6" EXPOSURE, HARDIE PLANK OR SIMILAR, COLOR: TBD

FIBER CEMENT LAP SIDING, SMOOTH, 9" EXPOSURE, HARDIE PLANK OR SIMILAR,

COLOR: TBD

No. 6995
BOSTON,
MA

THOE MINESER

RED ANCHITECT

SOLUTION

OF MINESER

OF MIN


POLY-ASH TRIM BOARD, PAINTED, COLOR: TBD

6 BRICK VENEER, COLOR: TBD

2 5/16" FIBER CEMENT PANELS, COLOR: TBD

FIBERGLASS ROOF SHINGLES, ARCH. GRADE, COLOR: TBD

4 CONCRETE FINISH

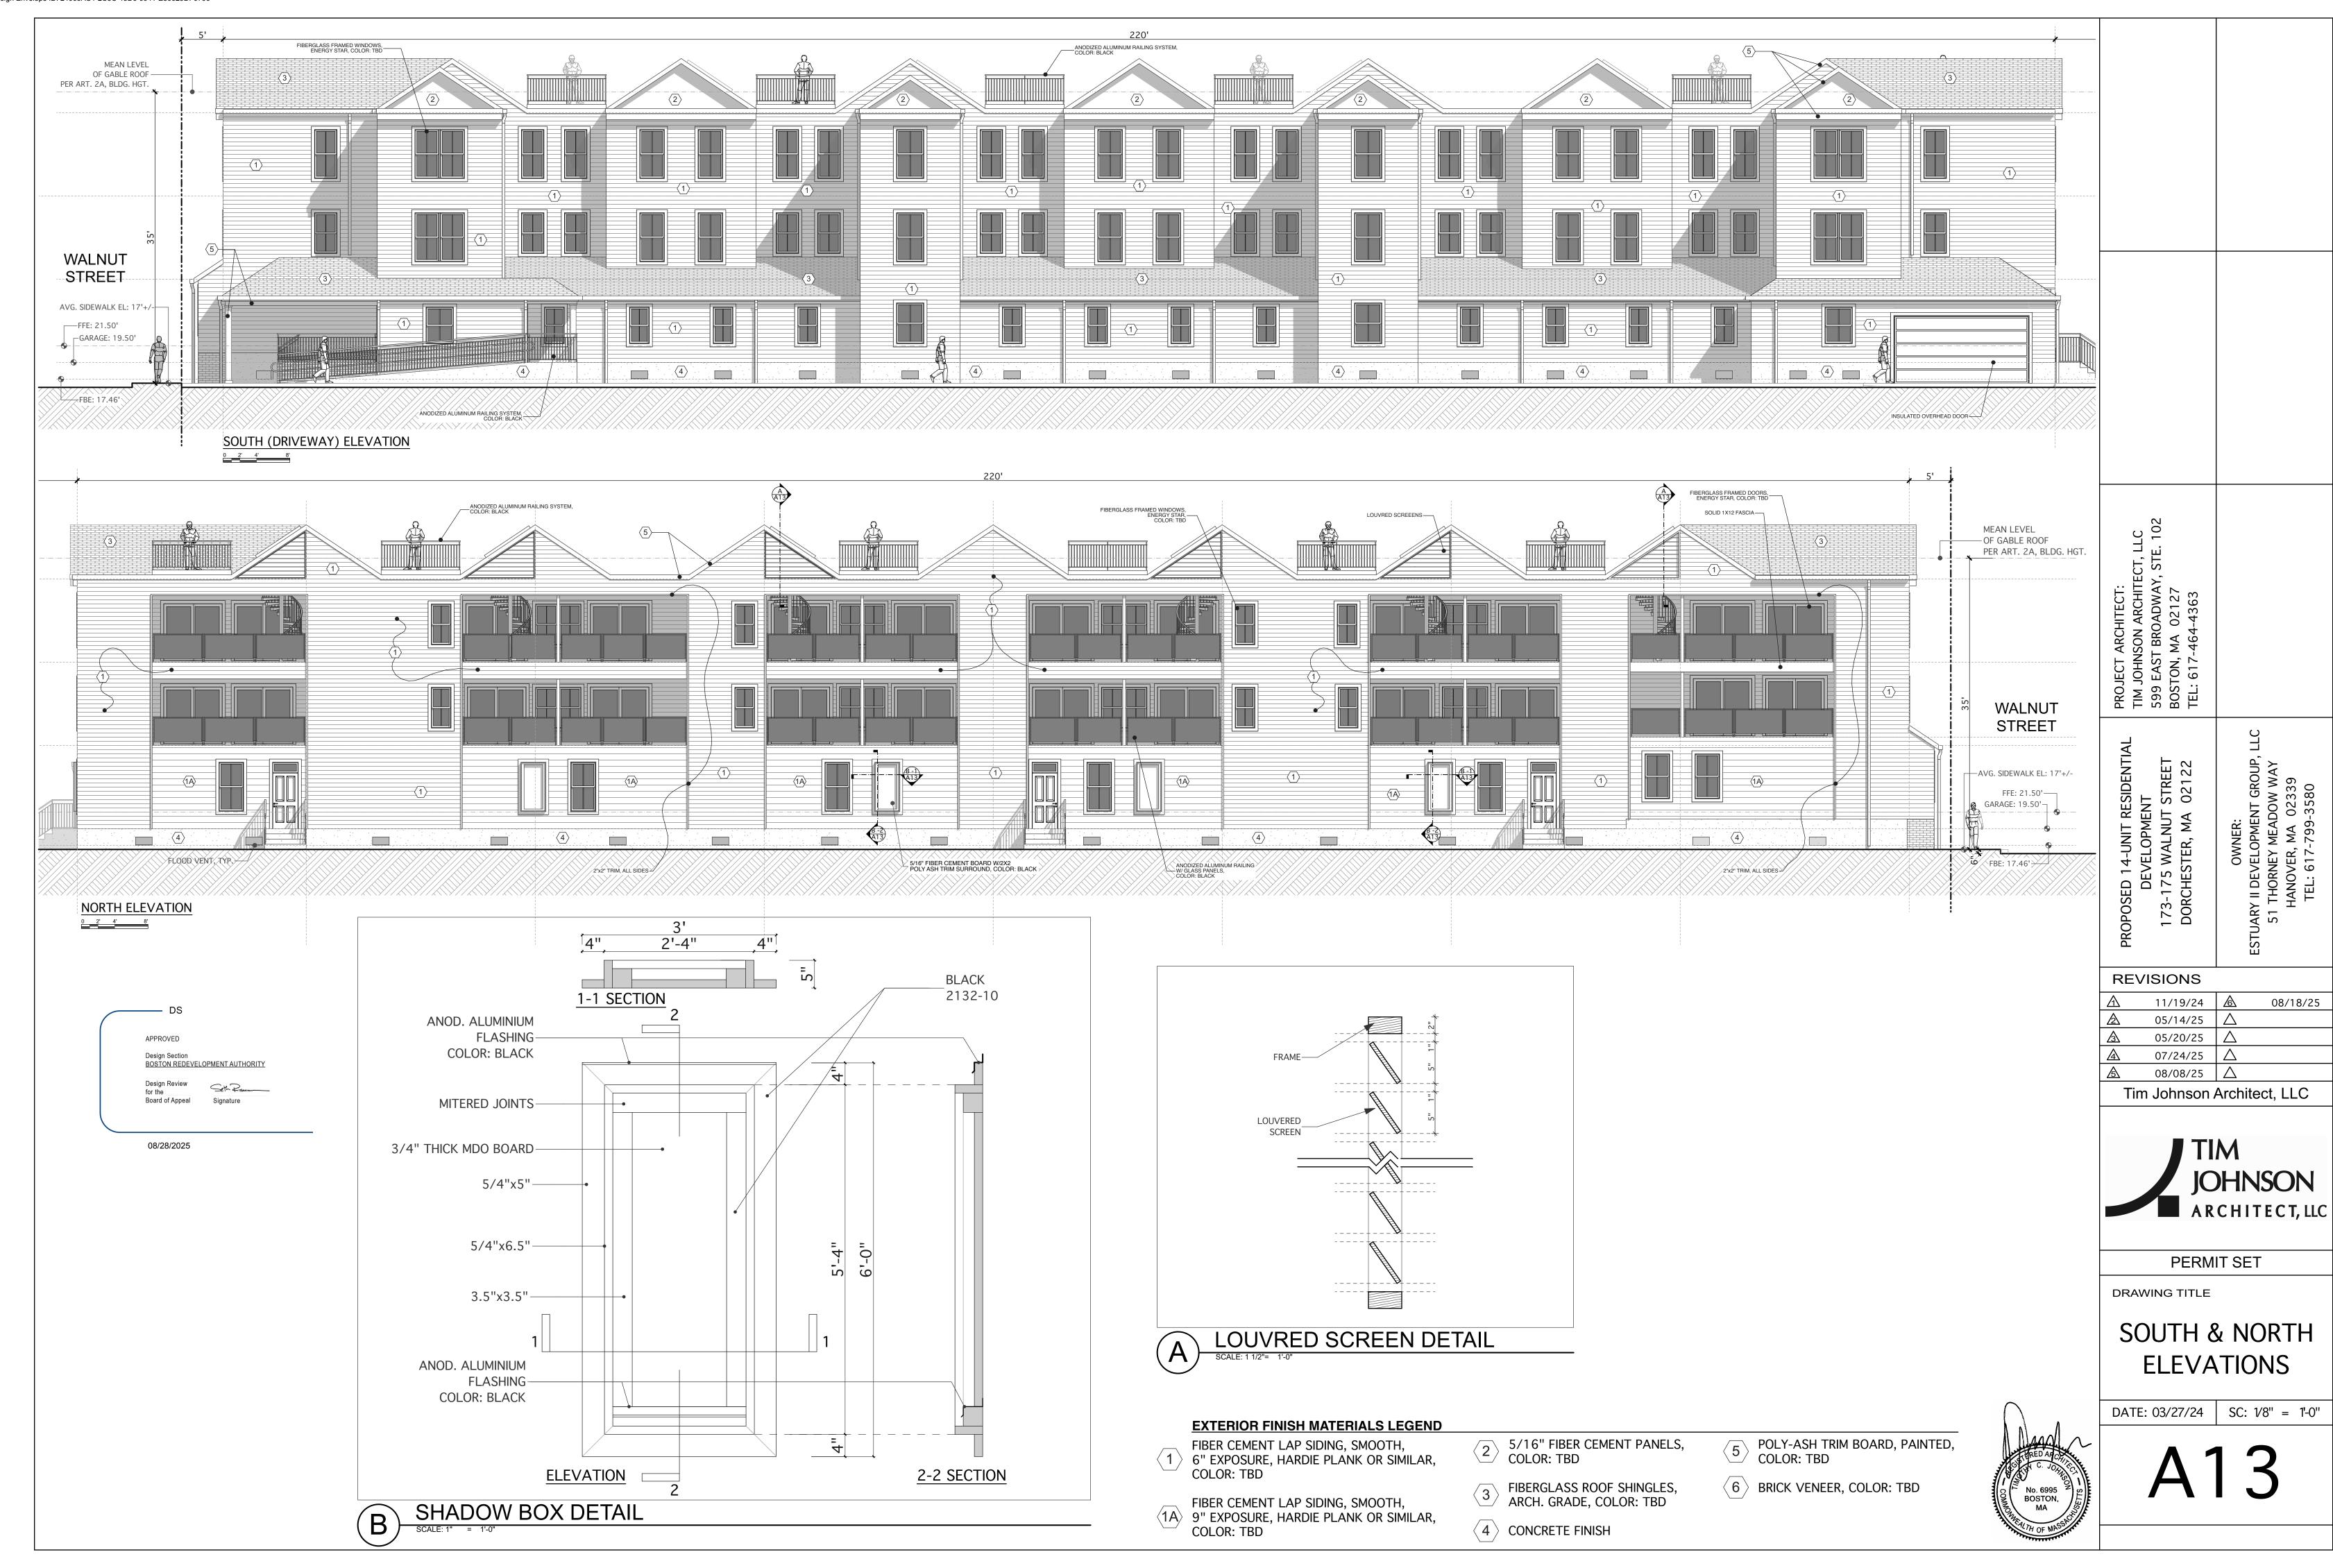

DS		
APPROVED		
Design Section BOSTON REDEVEL	OPMENT AUTHORITY	
Design Review for the Board of Appeal	Seth Roman	_

08/28/2025

DOC	R SCI	HEDUI	<u>.E</u>											Page 1 of 1
Job Na	me: 173-1	75 Walnut	Street											
Date: 0	7/22/25													
*REVIS	ED:													
	Location	1	Door	Nominal	Sizes	Rough O	penings	Frame		Manufacturer		Misc.	Glazing	
*REV.	Symbol	Qty.	Туре	Width	Height	Width	Height	Jamb	Treshld.	Company	Product No.	Hdwre.		Remarks
	1	2	D	3'-0"	7'-0"				T-4				u-0.30, Low-E	3/4-Lite Entry Door w/ Temp. Gl.
	2	2	D	3'-0"	6'-8"				T-4]			u-0.30, Low-E	3/4-Lite Entry Door w/ Temp. Gl.
	3	1	S	16'-0"	8'-0"								u-0.30, Low-E	Overhead Garage Door
	4	24	F	7'-0"	6'-10"				T-3				u-0.30, Low-E	Full-Lite Sliding Door w/ Temp. Gl.
	5	38	А	3'-0"	6'-8"			J-4	T-4					1 Hour Fire-Rated Door
	6	4	Α	3'-0"	6'-8"			J-4	T-4				-	Non-Rated Door
	HARDV	<u> </u>	HEDULE		MISC. SC	HEDULE				DOOR SCHEDUL	<u>. E</u>			NOTES:
	L-1	Cylinder	lockset, passa	ige lock	T-1	Clr. oak, l	beveled edge	S		А	Panel door			
	L-2	Cylinder	lockset, privac	cy lock	T-2	White ma	arble, beveled	edges		В	Flush door			
	L-3	Dummy	trim		T-3	Clr. anod	. alum., bevel	ed edges		С	Louvre door			
	L-4	Mortise-	type entry lock	set	T-4	Std. alum	n.sill,adjust. h	ardwd. thrl	nd.	D	Patio door			
	L-5	_	pe entry locks				<u> </u>			Е	French door			
	L-6		t cylinder		W-1	Weathers	trip, bulb-typ	е		F	Sliding door			
	C-1	Heavy-d	uty closer		J-1	Solid dim	ension board	l, stain gra	de	G	Bi-fold door			
	C-2	Standard	d-duty closer		J-2	Finger-joi	inted board, p	paint grade		Н	Pocket door			
	H-1	Plain be	aring hinges, 3	-butts	J-3	Split-woo	od frame			J	Sidelights			
	H-2	Ball bea	ring hinges, 3-l	outts	J-4	Hollow m	etal frame			S	Special			
										K	1/2 Lite Door			
										Т	Transom			

<u>WINI</u>	DOW S	SCHE	DULE								Page 1 of 1
Job Na	me: 173-1	75 Waln	ut Street								
Date: 08	3/08/25										
REVISI	 ΞD:										
			Manufacturer			Nominal	Sizes	Rough Op	penings	Window	
REV.	Symbol	Qty.	Company	Product No.	Туре	Width	Height	Width	Height	Glazing	Remarks
V	Α	35	Pella		DH	3'-0"	6'-0"			u-0.30, Low-E	SDL, Screens
✓	A1	4	Pella		DH	3'-0"	5'-6"			u-0.30, Low-E	SDL, Screens
	В	4	Pella		DH	3'-4"	6'-0"			u-0.30, Low-E	SDL, Screens
	С	7	Pella		DH	3'-0"	5'-0"			u-0.30, Low-E	SDL, Screens
	D	2	Pella		DH	3'-4"	4'-6"			u-0.30, Low-E	SDL, Screens
	D2	2	Pella		DH	3'-4"	5'-0"			u-0.30, Low-E	SDL, Screens
	Е	14	Pella		DH	2'-9"	5'-0"			u-0.30, Low-E	SDL, Screens
	E1	8	Pella		DH	2'-5"	5'-0"			u-0.30, Low-E	SDL, Screens
	F	14	Pella		DH	2'-9"	6'-0"			u-0.30, Low-E	SDL, Screens
v	G	12	Pella		DH	2'-5"	4'-6"			u-0.30, Low-E	SDL, Screens
	Н	4	Pella		DH	6'-0"	6'-0"			u-0.30, Low-E	SDL, Screens, Ganged
	J	8	Pella		DH	5'-6"	5'-0"			u-0.30, Low-E	SDL, Screens, Ganged
	J1	2	Pella		DH	6'-0"	5'-6"				SDL, Screens, Ganged
	K	6	Daylighter	4280	Roof	36.75"	74.50"				Roof Door

Note 1: Window openings in group R2 & R3 where top of sill is located <36" above finished floor and >72" above finished grade shall comply with 780 CMR sec. 1015.8, Window Opening Control Devices

ΙΔΙ	PROJECT ARCHITECT:	
<u>{</u> T	TIM JOHNSON ARCHITECT, LLC	
	599 EAST BROADWAY, STE. 102	
	BOSTON, MA 02127	
	TEL: 617-464-4363	

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Tim Johnson Architect, LLC



PERMIT SET

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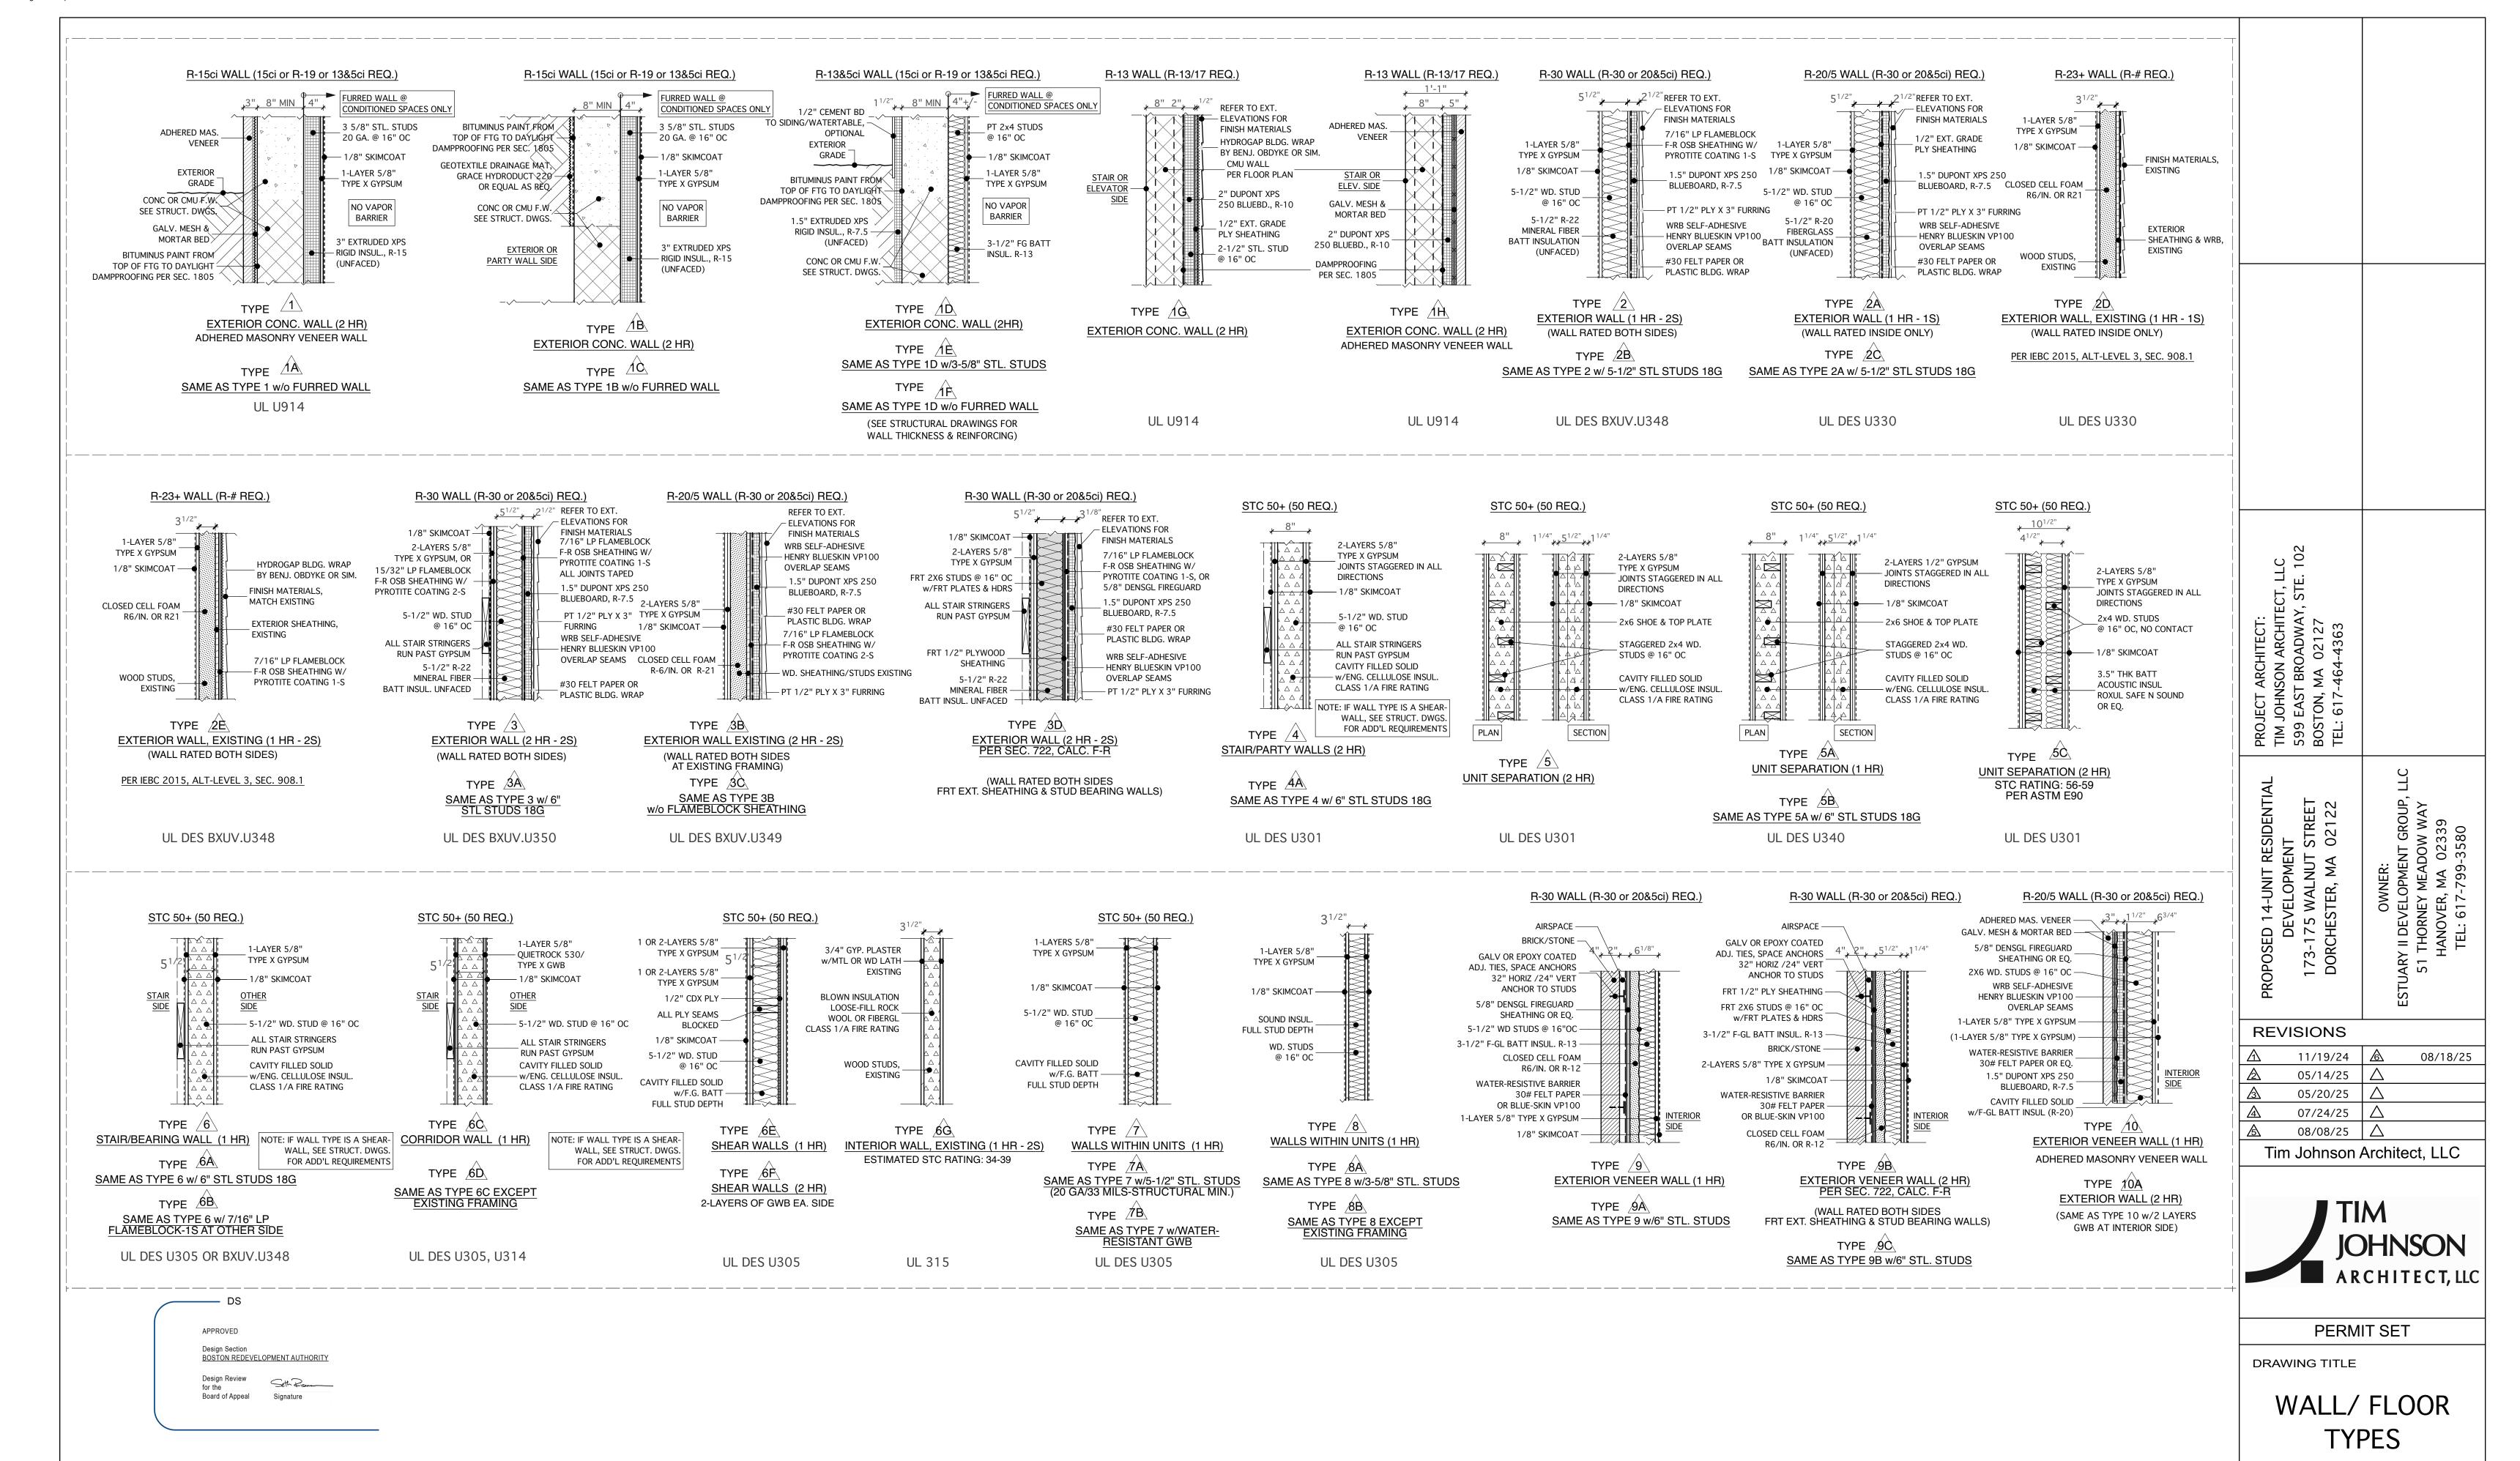
SCHEDULES

DATE: 03/27/24 SC: N. T. S.


No. 6995 BOSTON, MA



08/28/2025



DATE: 03/27/24 | SC: N. T. S. BOSTON,

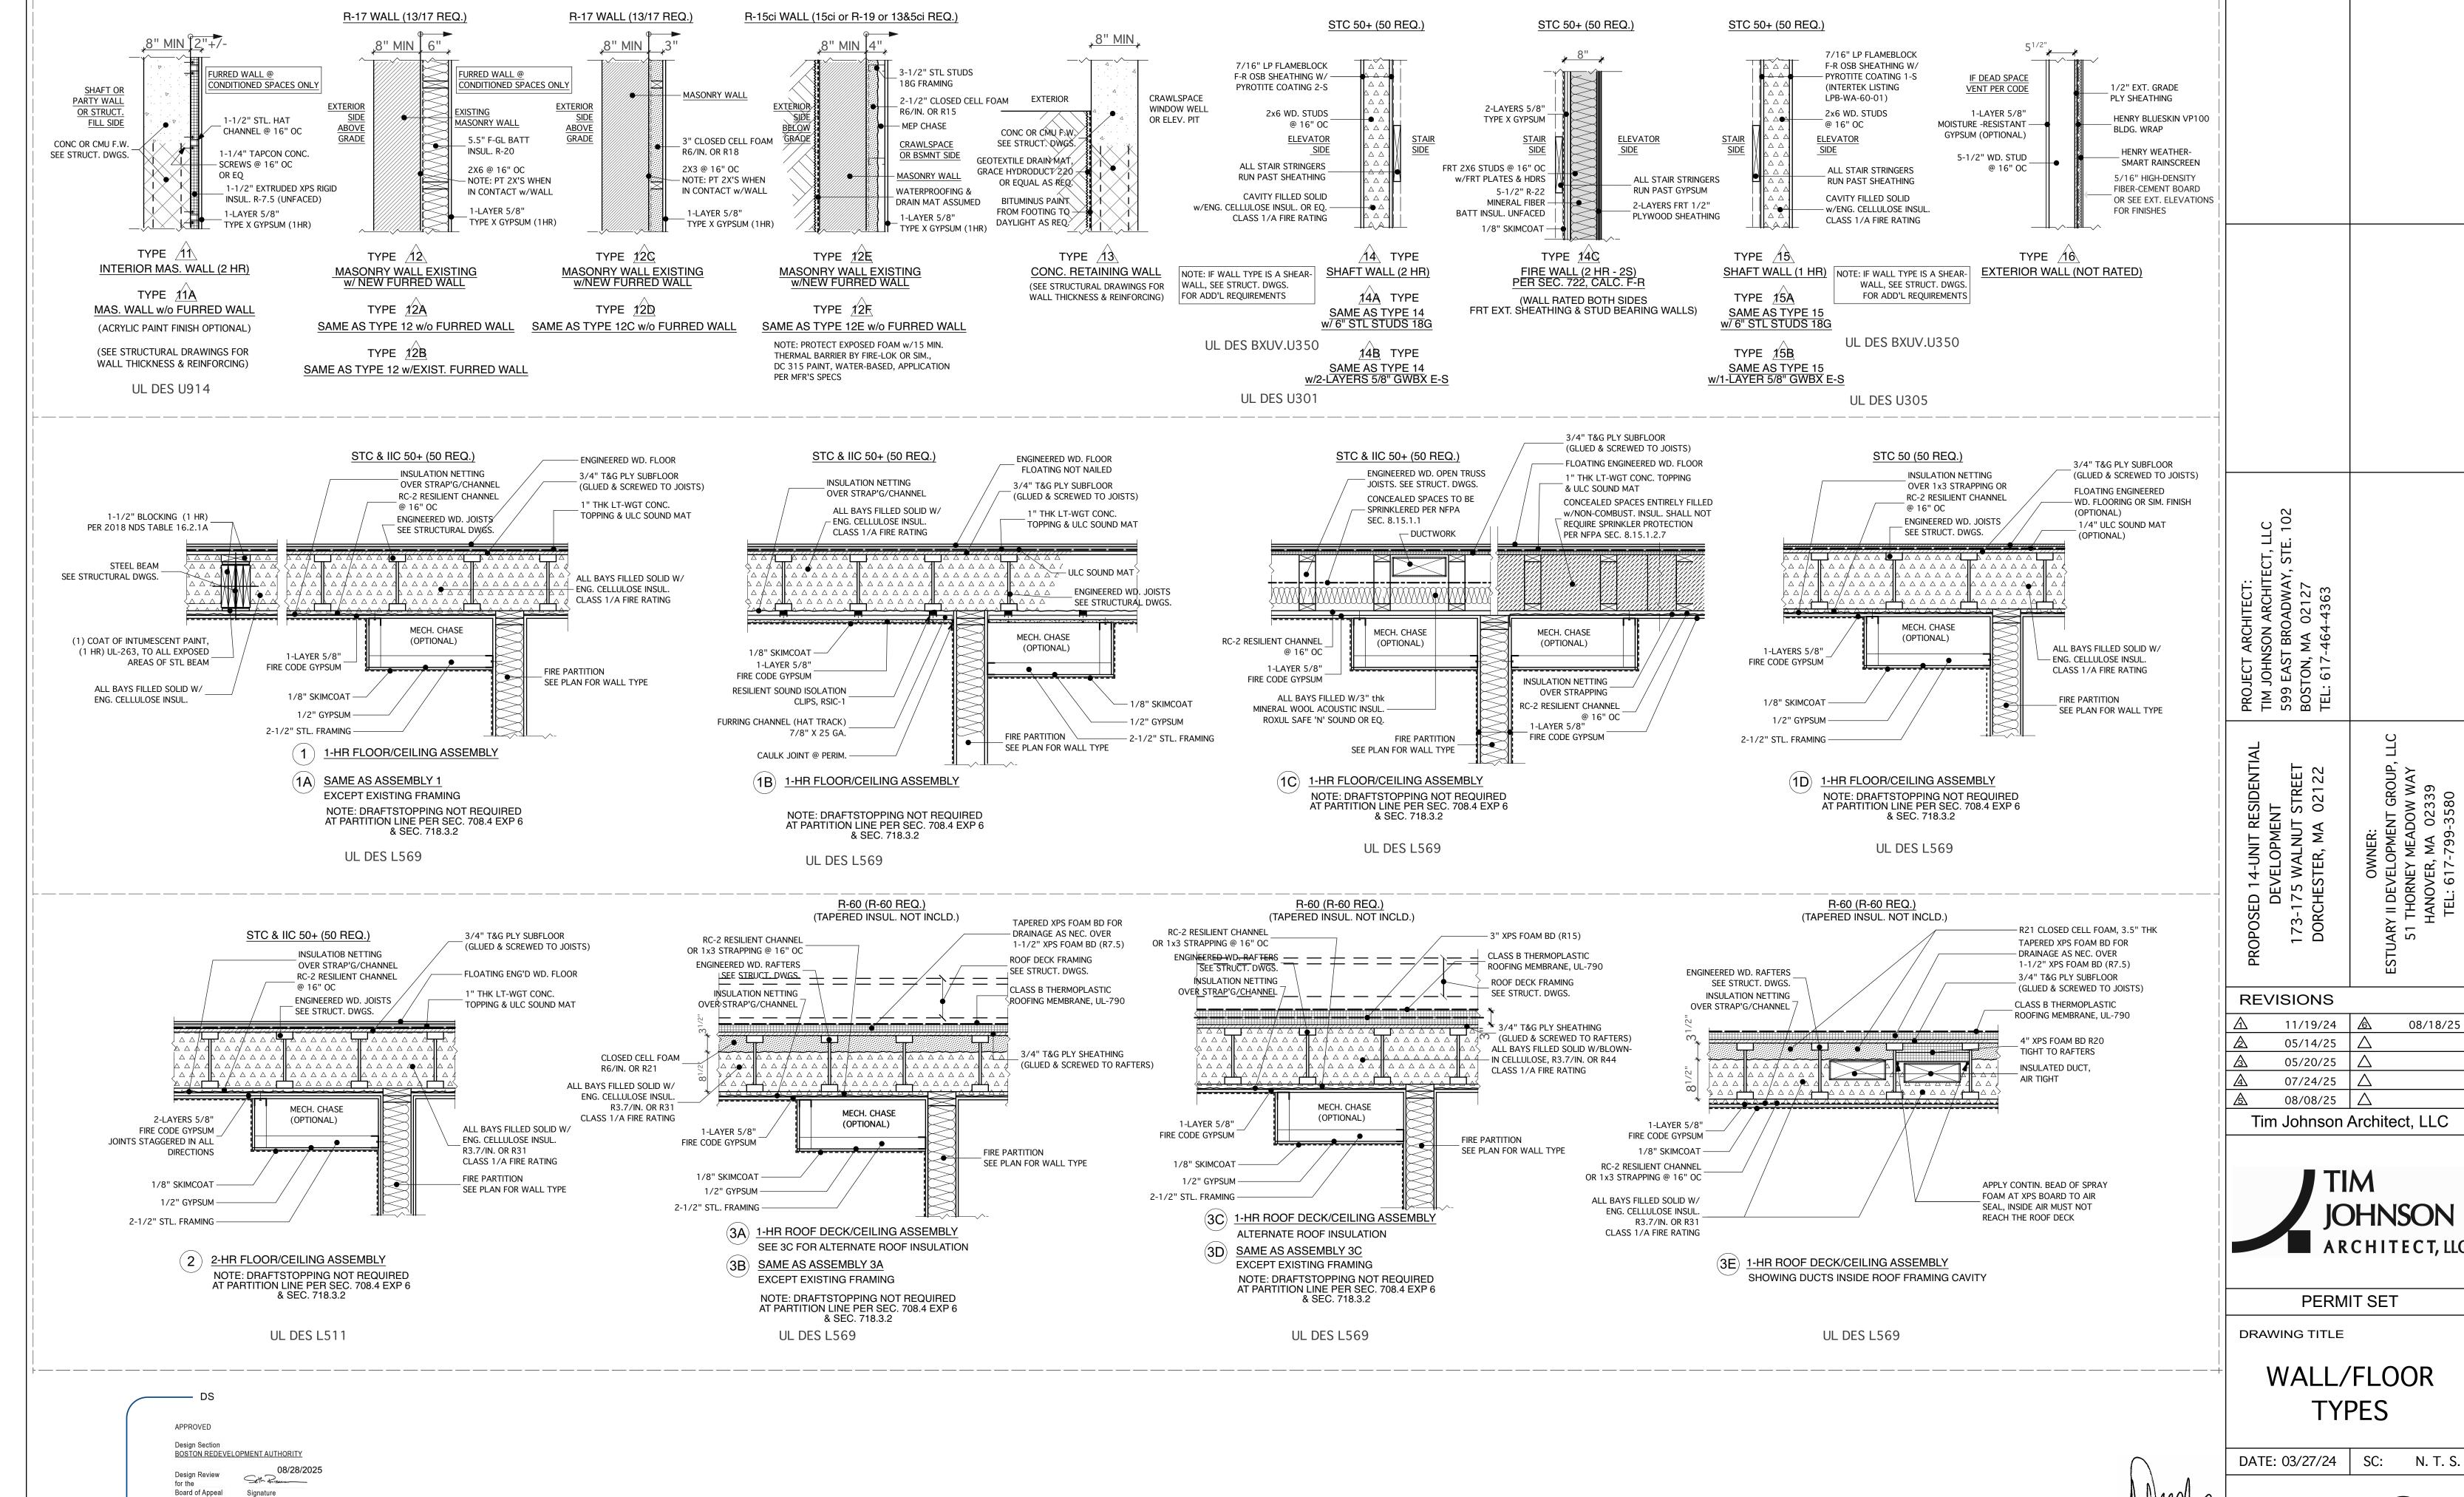


A16

BOSTON,

STC & IIC 50+ (50 REQ.)

- ENGINEERED WD. FLOOR

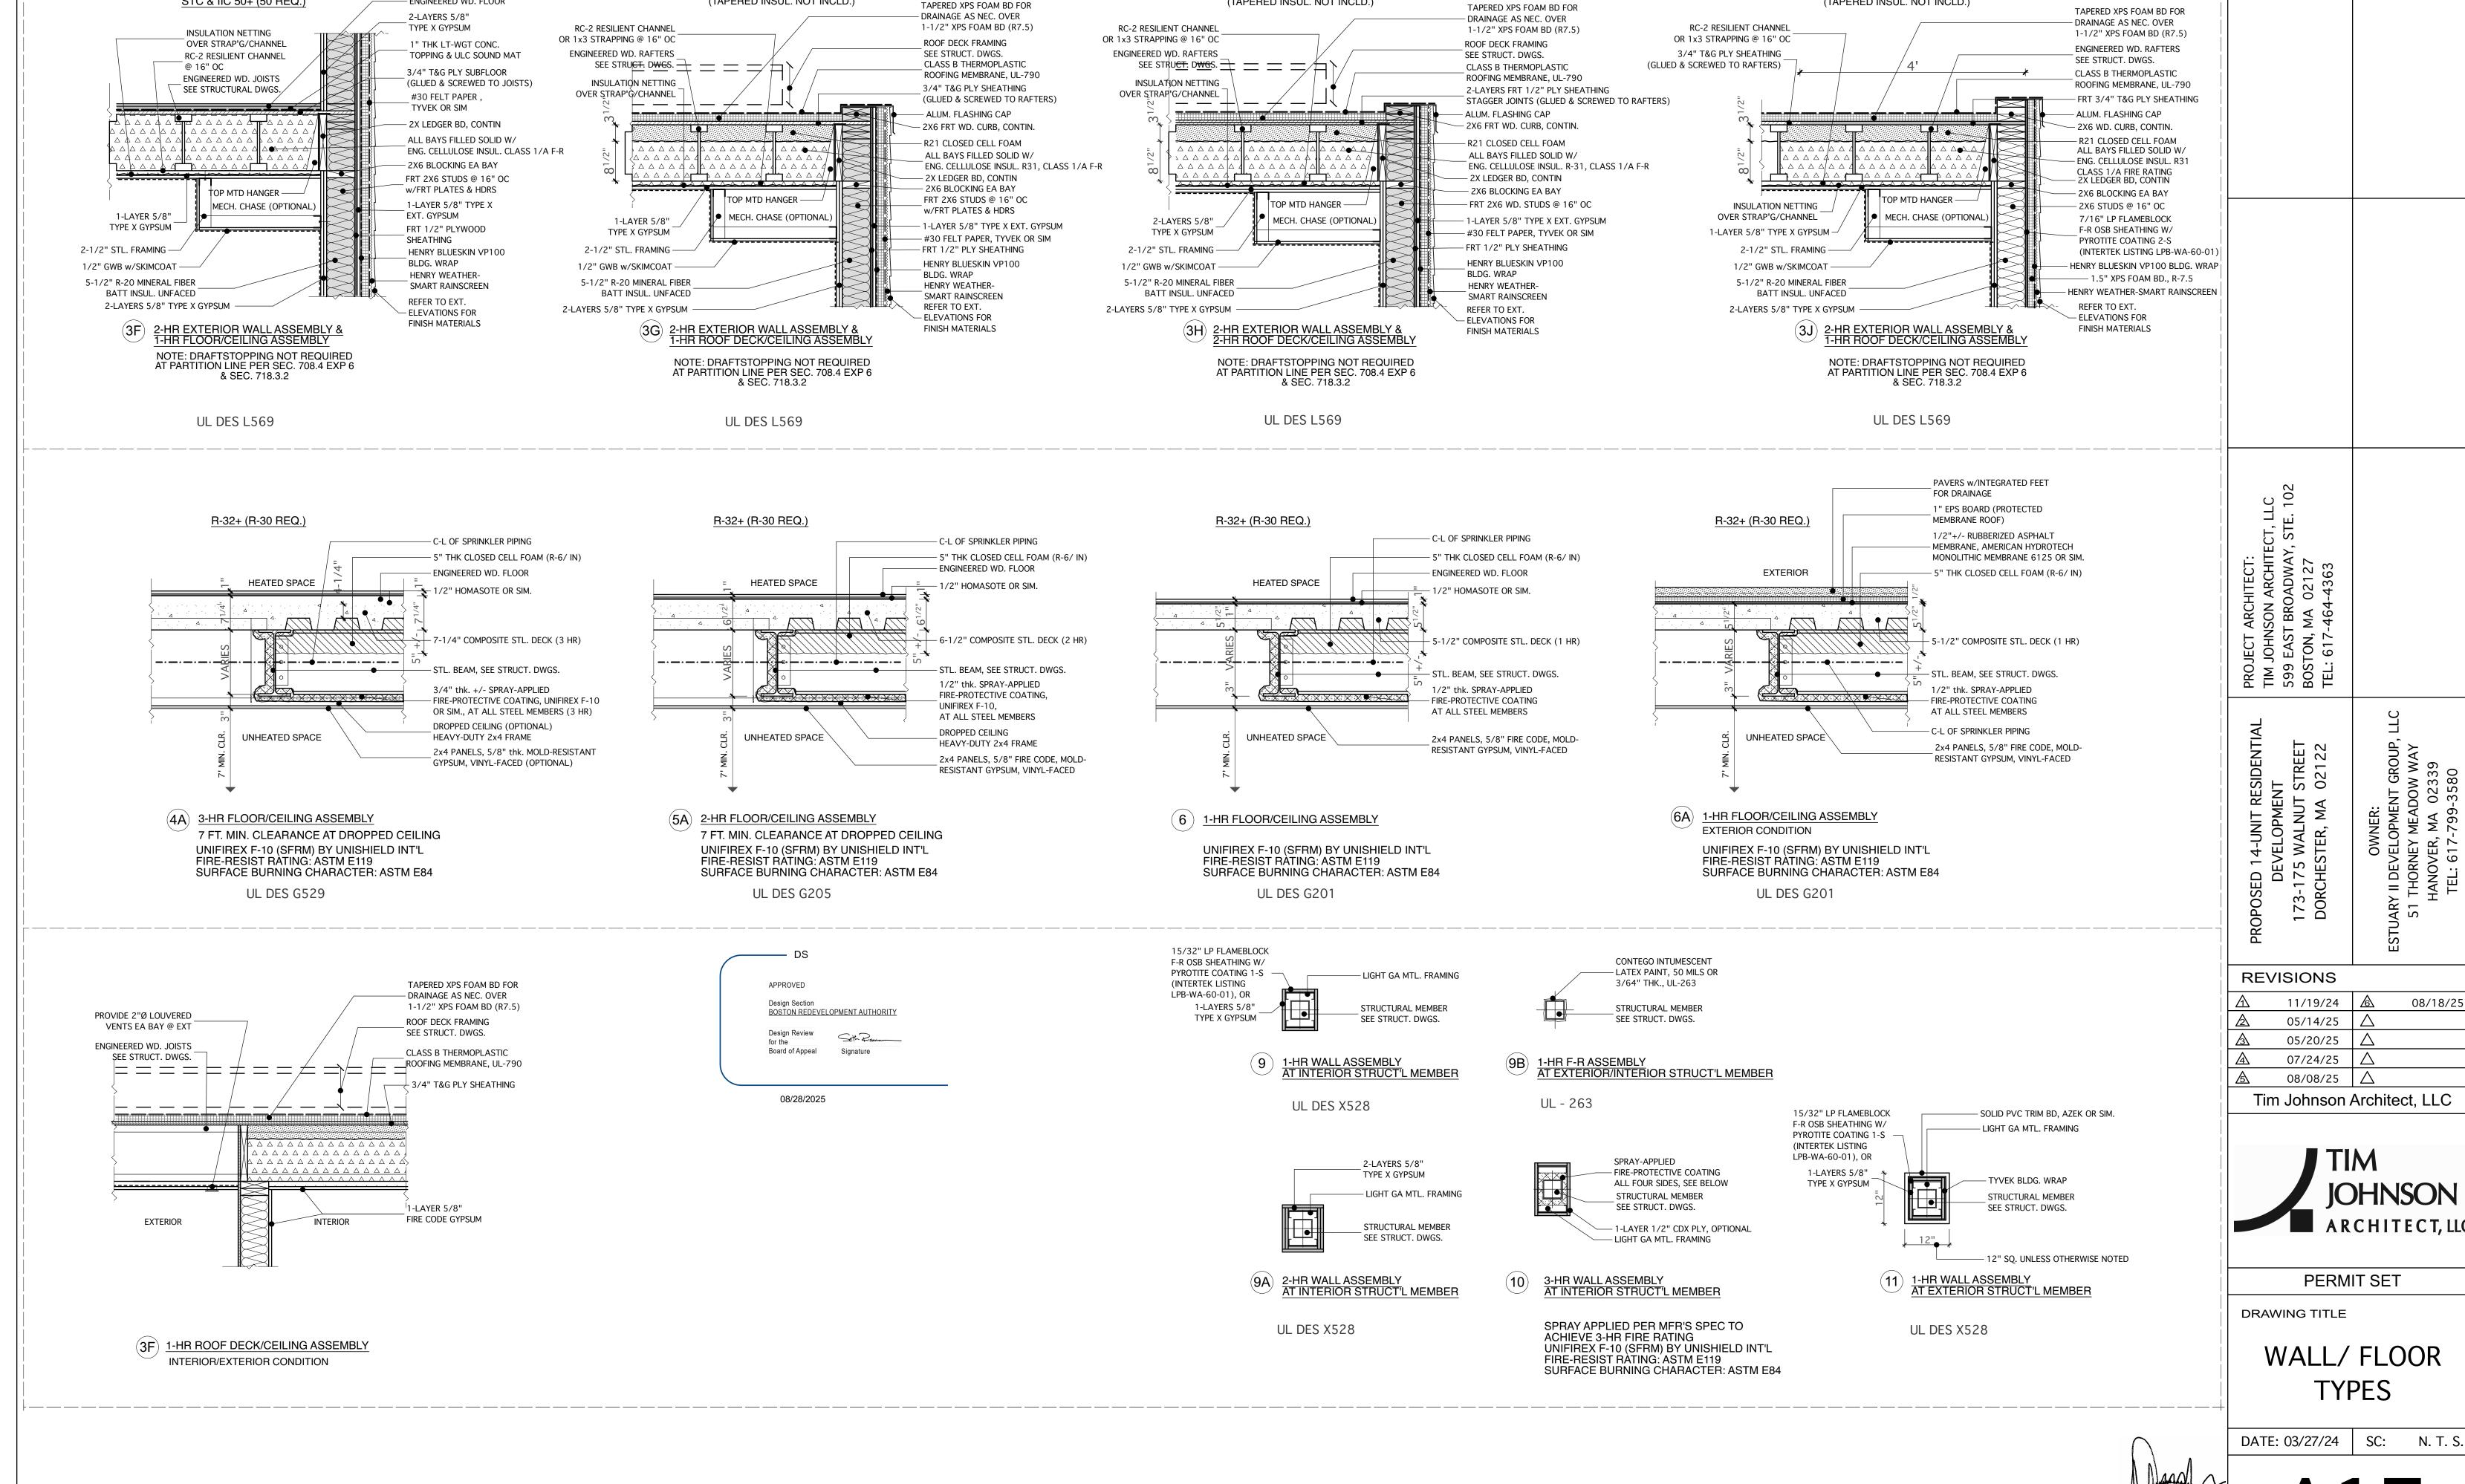

R-60 (R-60 REQ.)

(TAPERED INSUL. NOT INCLD.)


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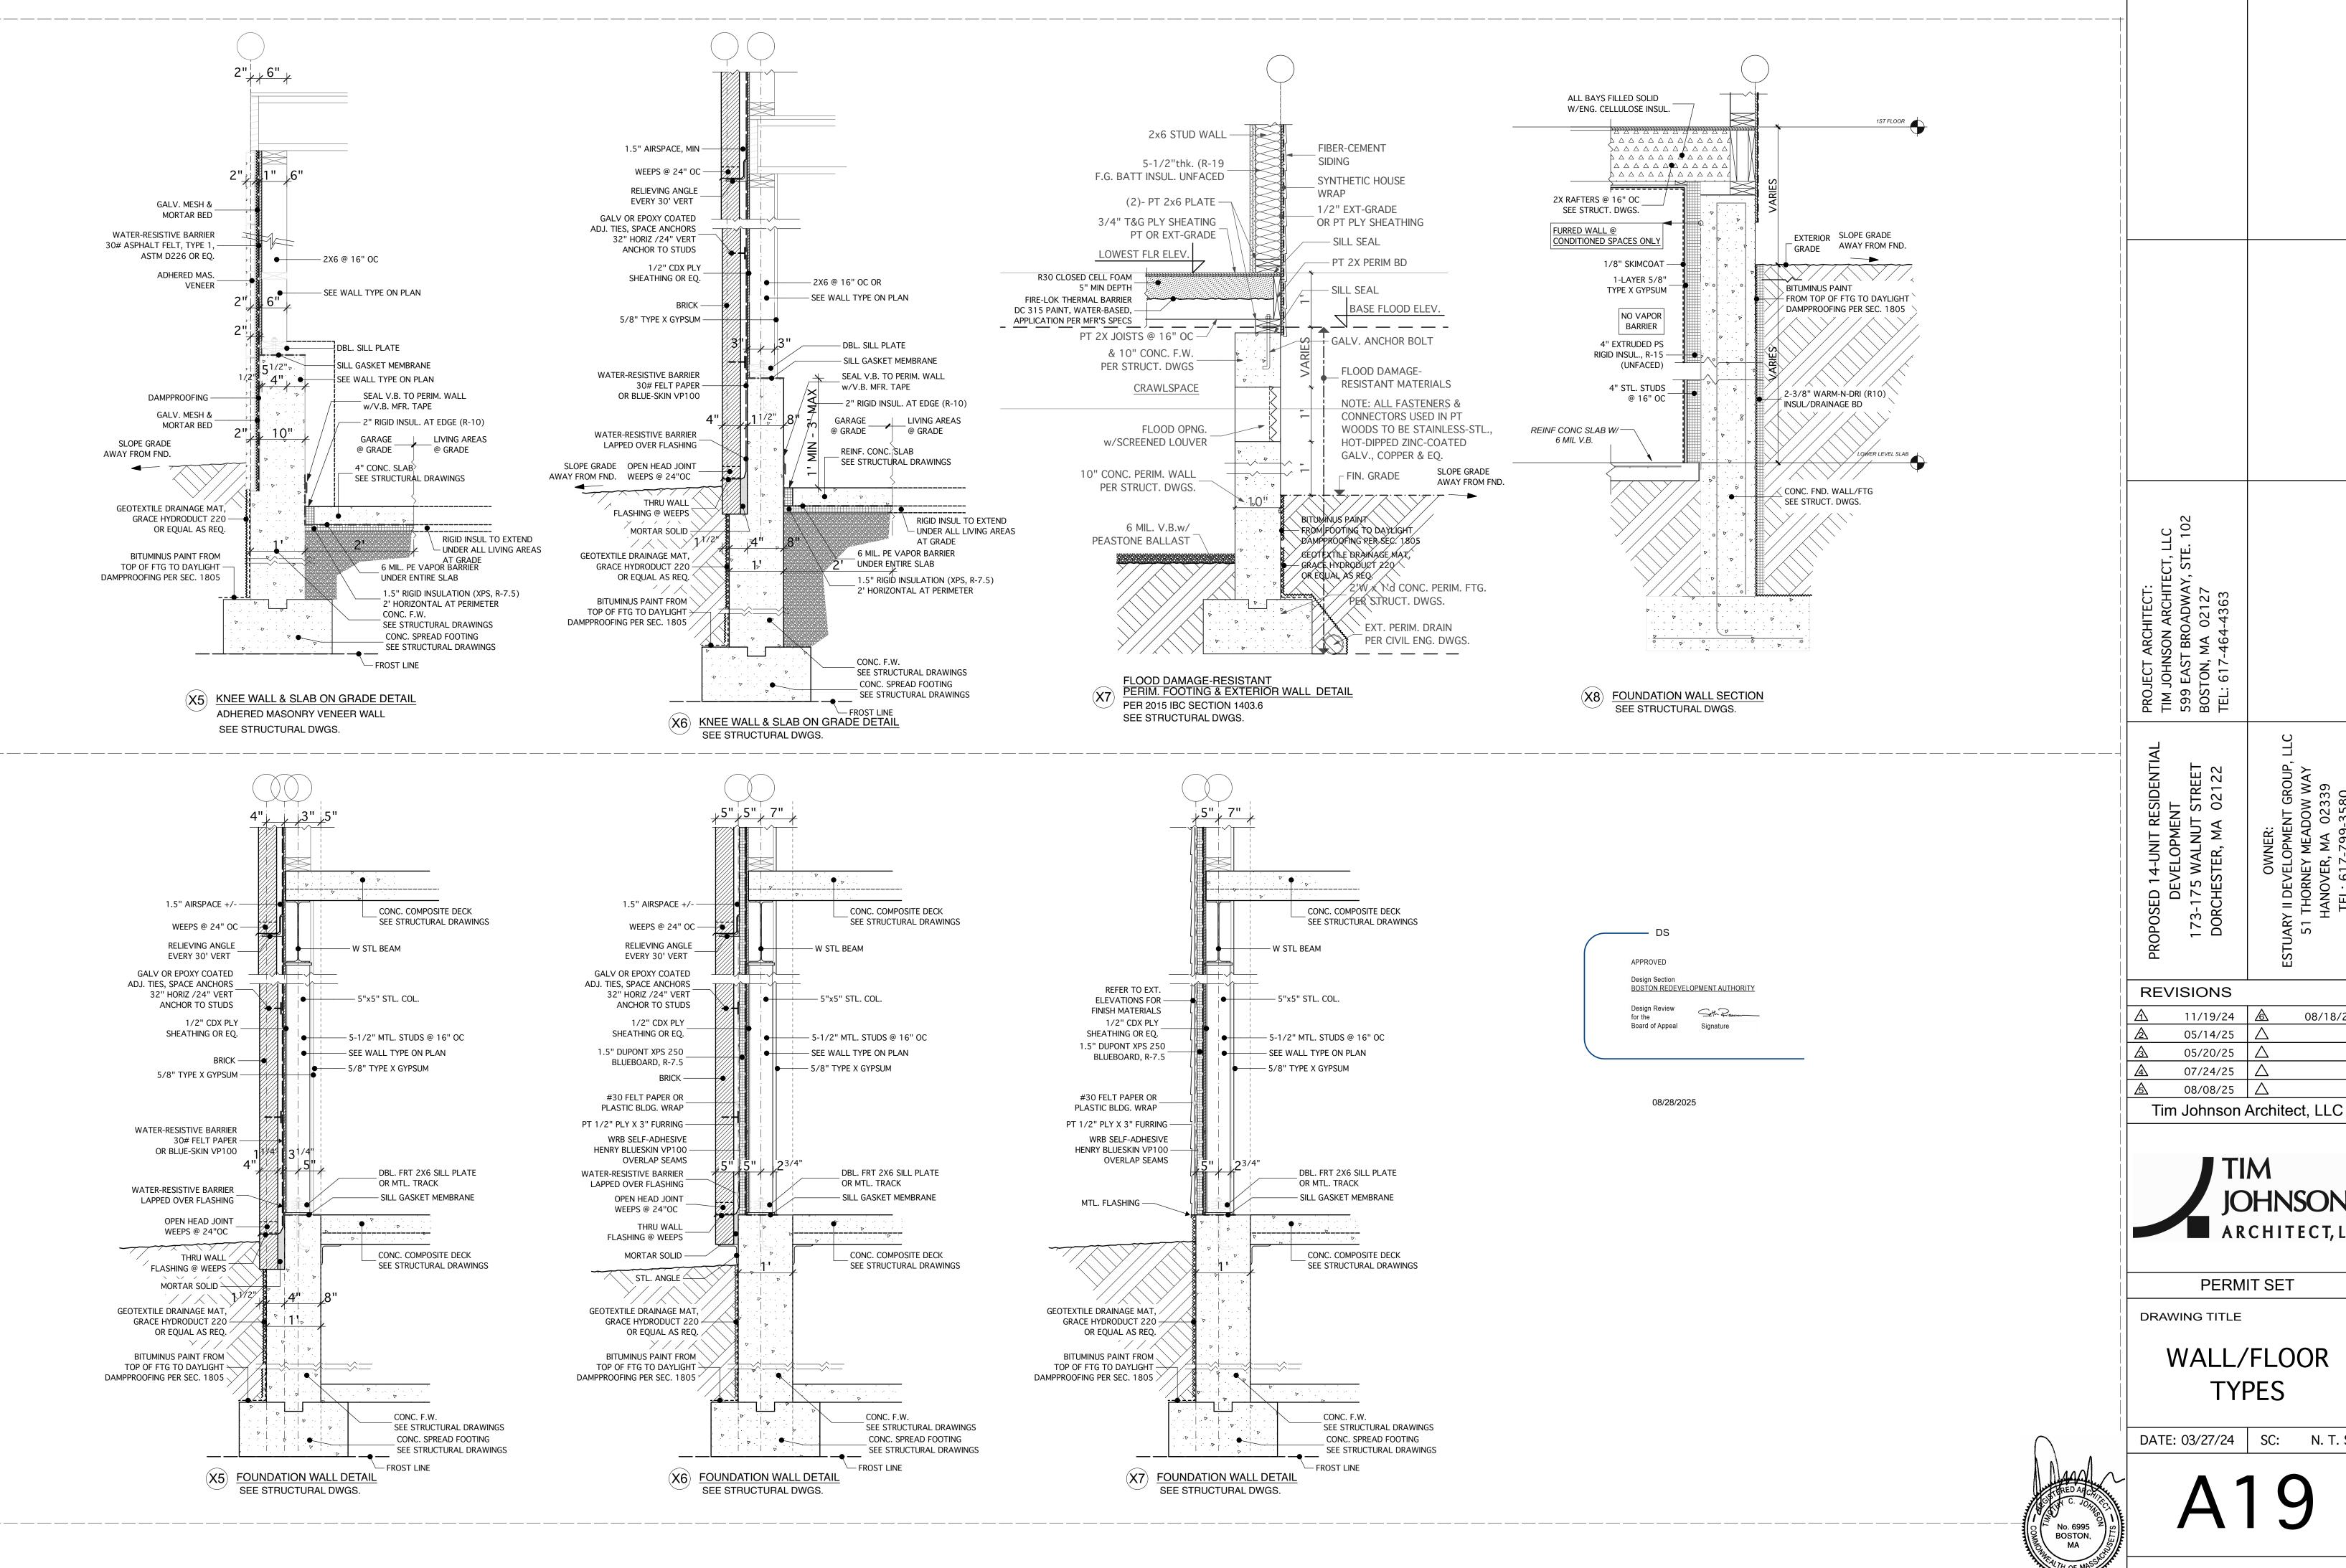
BOSTON,

R-60 (R-60 REQ.)

(TAPERED INSUL. NOT INCLD.)



BOSTON,

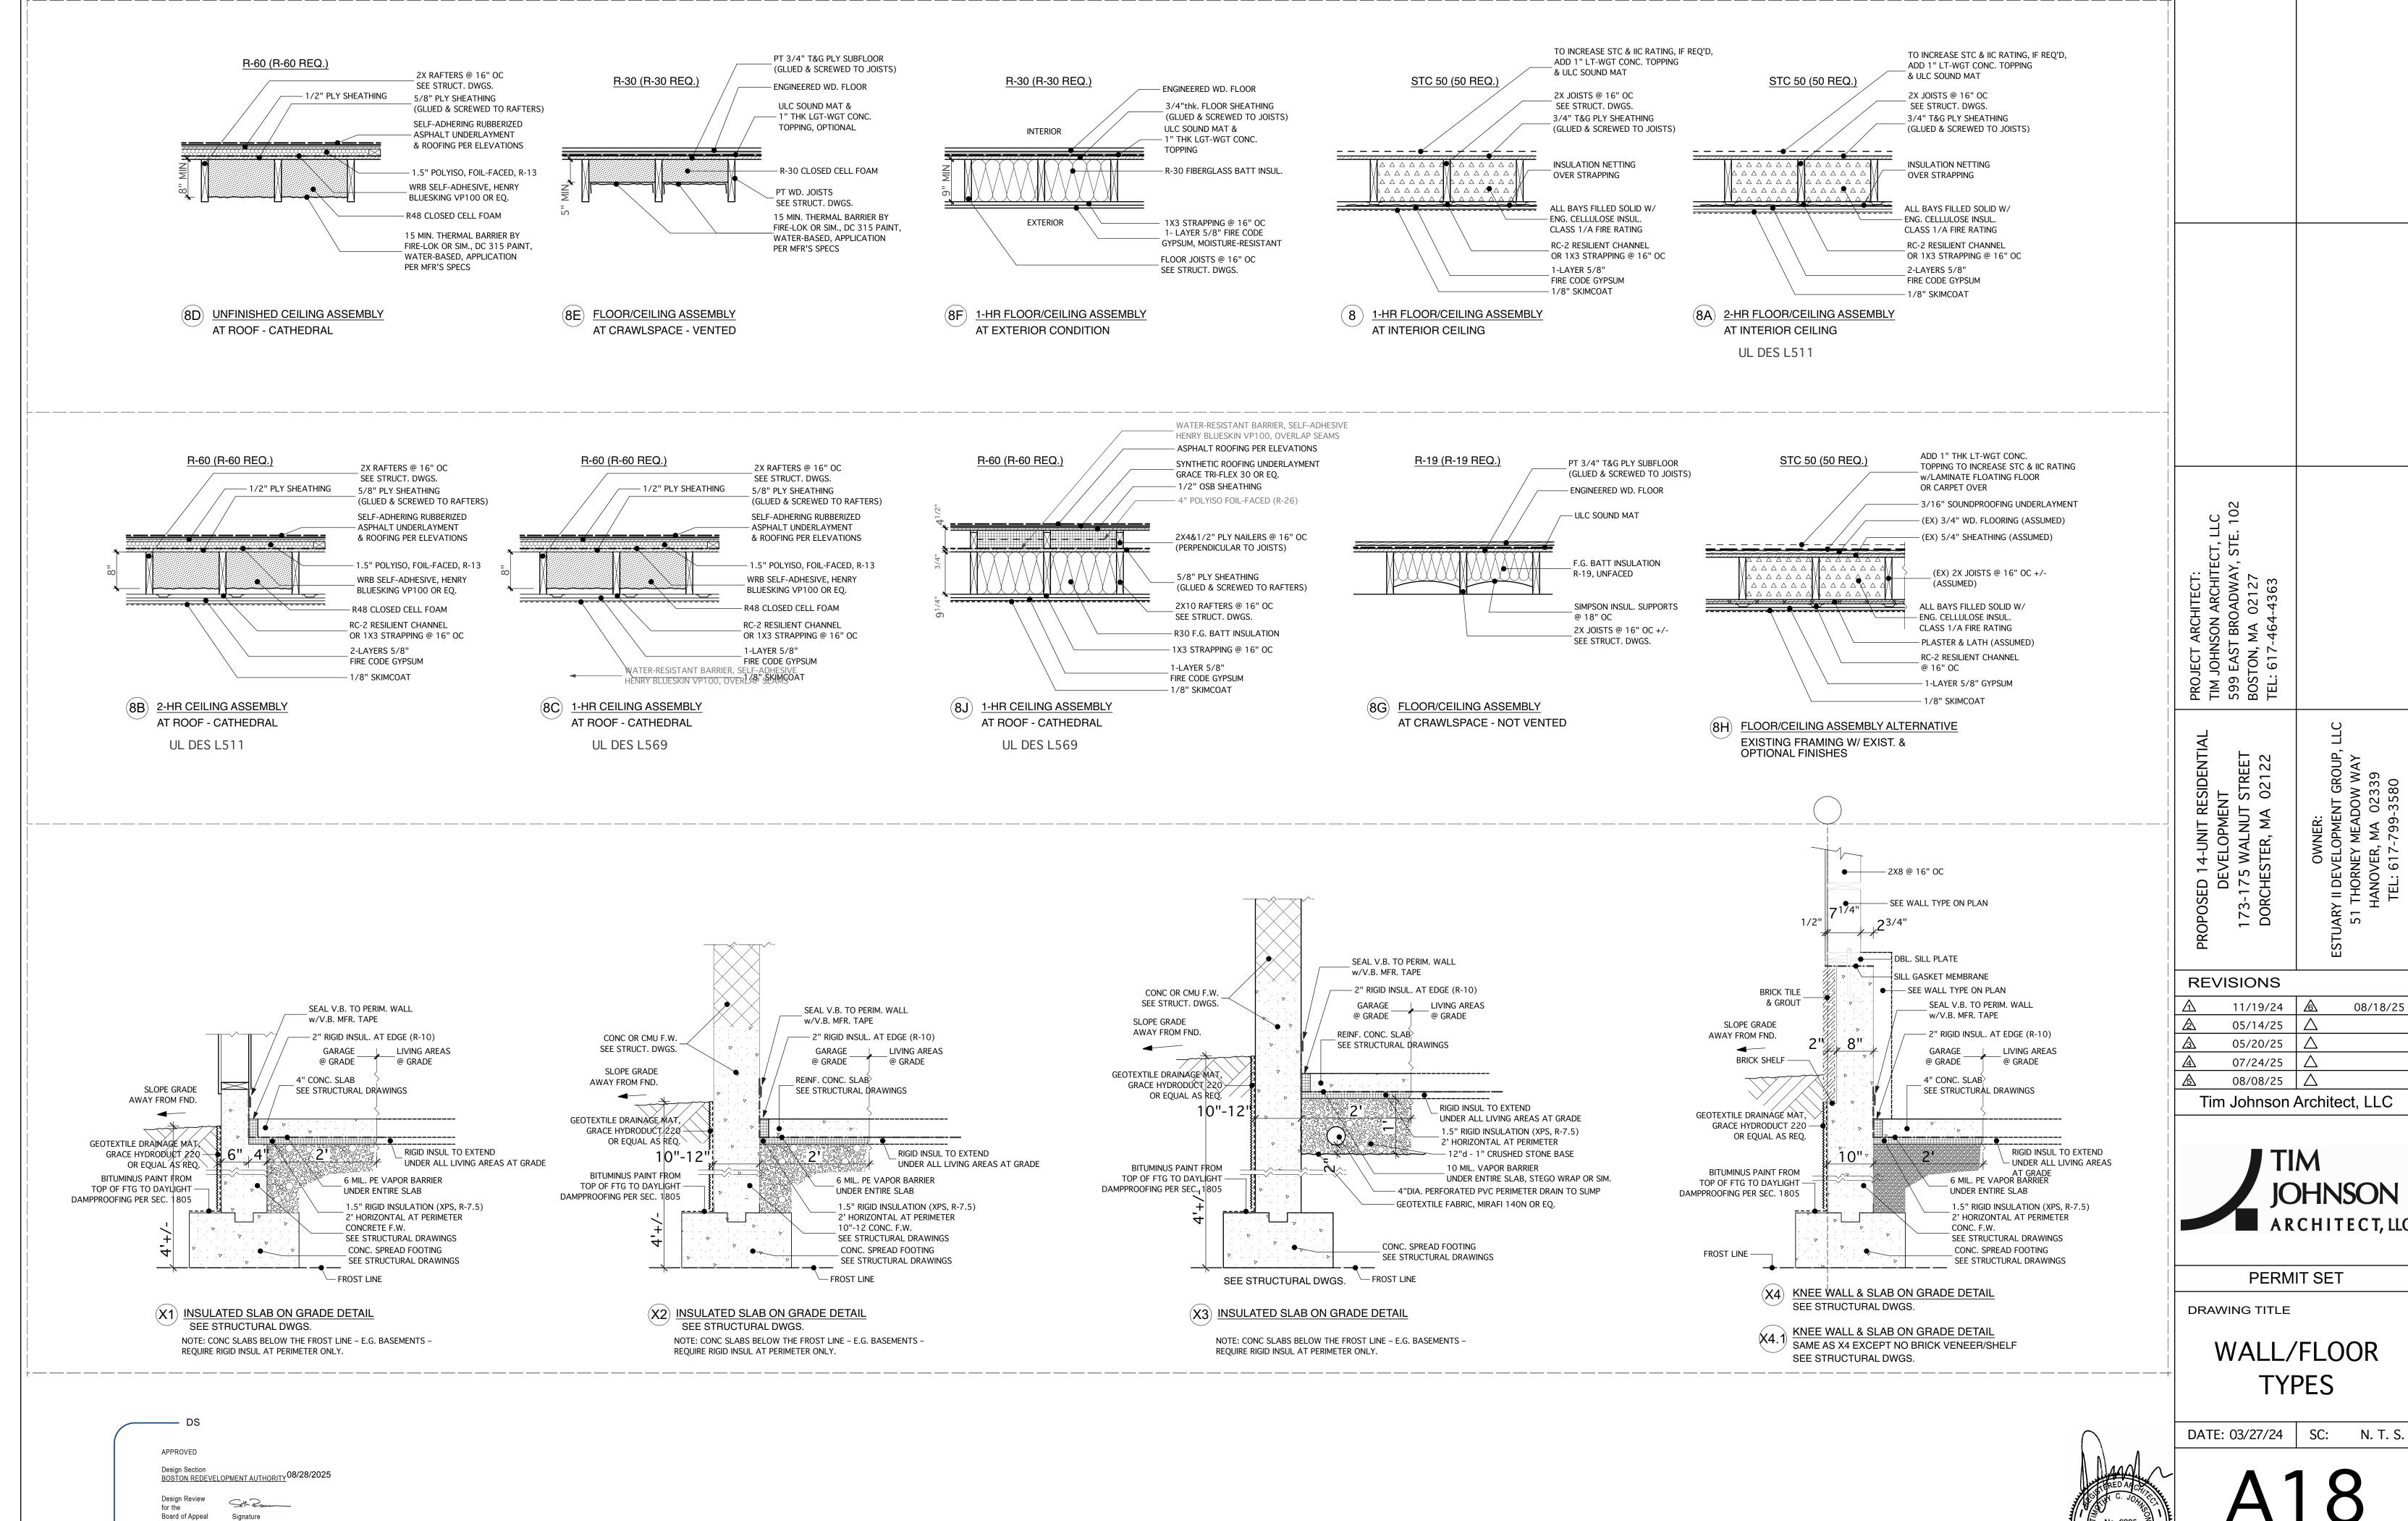

DJECT ARCHITECT:
1 JOHNSON ARCHITECT, LLC
9 EAST BROADWAY, STE. 102
STON, MA 02127
-: 617-464-4363 STREET 02122

08/18/25



PERMIT SET

DRAWING TITLE

WALL/FLOOR **TYPES**

DATE: 03/27/24 SC: N. T. S.