

## **GENERAL NOTES:**

## **CONTRACTOR RESPONSIBILITY-**

## CONTRACTOR IS SOLELY RESPONSIBLE FOR:

- 1. VIEWING SITE AND INCLUDING ANY SPECIAL CONDITIONS NECESSARY TO PERFORM THE WORK AS DESCRIBED IN THE DRAWINGS.
- 2. ESTABLISHING CONTROL OF THE SITE VIA SURVEY, AND LAYOUT.
- 3. OBTAINING AND PAYING FOR ALL PERMITS.
- 4. PAYING FOR ALL TEMPORARY UTILITIES AND FACILITIES
- 5. CHECKING AND CONFIRMING ALL DIMENSIONS, AND LAYOUTS.
- 6. SCHEDULING AND SEQUENCING.
- 7. CONSTRUCTION MEANS, METHODS AND TECHNIQUES
- 8. MAINTAINING DRAWINGS AND PERMITS ON SITE.
- 10. COORDINATION BETWEEN TRADES, AND SUPPLIERS
- 11. PROVIDE SCHEDULE TO OWNER AND ARCHITECT,
- 12. PROVIDE A SCHEDULE OF VALUES TO THE OWNER AND ARCHITECT
- 13. TEMPORARY HEAT, ICE AND SNOWPLOWING IS THE RESPONSIBILITY OF THE
- 14. SITE CLEANLINESS AND CONFORMANCE TO NFPA 241 REQUIREMENTS.
- 15. REPAIRING ANY WORK DAMAGED BY HIS FORCES WHILE PERFORMING THIS
- 16. GIVING WARRANTY FOR HIS WORK FOR A PERIOD OF ONE YEAR FROM THE DATE OF FINAL COMPLETION.

## **REVIEW OF WORK BY DESIGNERS-**

CONTRACTOR SHALL NOTIFY ARCHITECT BEFORE PROJECT STARTS.

CONTRACTOR SHALL NOTIFY ARCHITECT. ONE WEEK PRIOR TO:

- 17. POURING CONCRETE
- 18. INSULATING
- 19. INSTALLING DRYWALL
- 20. FINAL INSPECTION

## **SHOP DRAWINGS-**

ALL SHOP DRAWINGS SHALL BE SUBMITTED 30 DAYS AFTER CONTRACT AWARD.

GENERAL CONTRACTOR SHALL APPROVE SHOP DRAWINGS, PRIOR TO SUBMITTING TO ARCHITECT OR ENGINEER.

NON SUBMISSION DOES NOT CONSTITUTE APPROVAL OF ANY WORK.

NO EXCEPTIONS TAKEN DOES NOT RELIEVE THE CONTRACTOR OF PERFORMING ANY OTHER WORK ON THE DRAWINGS.

CONTRACTOR SHALL EXPECT A MINIMUM OF 2 WEEKS FOR DESIGNERS' REVIEW

ANY VARIANCE FROM THE ORIGINAL DESIGN SHALL BE NOTED.

ANY SUBSTITUTION NOT INDICATED SHALL NOT CONSTITUTE APPROVAL OF A

SHOP DRAWINGS ARE NOT COORDINATION DRAWINGS.

DESIGNERS ARE NOT RESPONSIBLE FOR DIMENSIONS.

## **CHANGE ORDERS-**

CONTRACTOR SHALL VISIT THE SITE AND BE THOROUGHLY ACQUAINTED WITH THE PROJECT PRIOR TO SUBMITTING A PRICE. ADDITIONAL MONEY WILL NOT BE GRANTED FOR WORK NOT CLARIFIED PRIOR TO BIDDING.

DESIGNER SHALL BE NOTIFIED OF ANY CHANGE TO THE DRAWINGS, UNFORESEEN FIELD CONDITIONS OR DISCREPANCIES PRIOR TO PERFORMING WORK.

ANY PROPOSED CHANGES SHALL BE ACCOMPANIED WITH A WRITTEN DESCRIPTION OR A SKETCH FOR CLARIFICATION.

ALL CHANGE ORDERS SHALL BE APPROVED PRIOR TO PERFORMING WORK.

CHANGE ORDERS SHALL BE PRICED EITHER LUMP SUM OR UNIT PRICE OR TIME AND MATERIALS.

ANY SUBSTITUTION REQUEST SHALL BE MADE VIA CHANGE ORDER, AND NOT VIA SHOP DRAWINGS UNLESS AGREED TO.

ANY CHANGE SHALL STATE THE CREDIT OR COST ADD AND/OR ANY CHANGE TO THE SCHEDULE.

## **REQUISITIONS-**

ANY REQUISITION REQUIRED TO BE SIGNED BY THE ARCHITECTED SHALL BE SUBMITTED A MINIMUM OF ONE WEEK PRIOR TO BEING SUBMITTED TO THE BANK FOR REVIEW.

CONTRACTOR SHALL PROVIDE RECEIPTS AND INSURANCE CERTIFICATES FOR ANY MATERIALS FOR PAYMENT FOR ANY UNINSTALLED MATERIALS.

NOTE: THERE HAS BEEN NO SOIL TESTING PROVIDED TO THIS OFFICE FOR THIS PROJECT. THE DESIGNING ARCHITECT OR STRUCTURAL ENGINEER ACCEPTS NO RESPONSIBILITY FOR EXISTING SOIL CONDITIONS. ANY SOIL BEARING CAPACITY OF THIS FOUNDATION SYSTEM IS DESIGNED BASED ON A 2 TON MINIMUM SOIL BEARING CAPACITY. IT SHALL BE THE CONTRACTORS OR OWNERS' RESPONSIBILITY TO DETERMINE SUITABLE SOIL CONDITIONS AND VERIFY THE BEARING PRESSURE. IF A SUITABLE SOIL THAT CAN WITHSTAND A 2 TON BEARING CAPACITY IS NOT AVAILABLE, THIS OFFICE SHOULD BE CONTACTED BY THE CONTRACTOR OR OWNER FOR A FOUNDATION REDESIGN.

## WOOD NOTES:

- 1. ALL LUMBER SHALL HAVE A MOISTURE CONTENT OF NOT MORE THAN 19%.
- 2. ALL FRAMING LUMBER SHALL BE #2 SPF, OR BETTER, HAVING A MINIMUM:

FB=875 PSI, FV=135 PSI, E=1,300,000 PSI

- 3. ALL JOIST SPANS SHALL HAVE ONE ROW OF 1" X 3: CROSS BRIDGING AT MID SPAN AND NOT MORE THAN 8'-O" O.C.
- 4. ALL STUD BEARING WALLS SHALL HAVE ONE ROW OF 2X HORIZONTAL BLOCKING AT 1/2 STUD HEIGHT, AND NOT MORE THAN 6'-O" O.C. MAXIMUM.
- 5. PROVIDE AND INSTALL ALL NECESSARY TIMBER CONNECTORS WITH ADEQUATE STRENGTH.
- 6. PROVIDE DOUBLE JOIST BELOW PARTITIONS PARALLEL TO JOIST
- 7. PROVIDE SOLID BRIDGING BELOW PARTITIONS PERPENDICULAR TO JOIST FRAMING.
- 8. PROVIDE SOLID BRIDGING BETWEEN JOIST FRAMING MEMBERS WHEN BEARING ON STUD PARTITIONS OR BEAMS.
- 9. PROVIDE A CONTINUOUS BAND JOIST AT EXTERIOR STUD WALLS.
- 10. PROVIDE DIAGONAL METAL STRAP BRACING AT ALL CORNERS AND WALL INTERSECTIONS, AT THE INSIDE FACE OF STUDS, FROM TOP PLATE TO FLOOR PLATE AT A 45 DEGREE ANGLE WITH A SIMPSON TYPE "RCWB" STRAP, OR EQUAL.
- 11. ALL BUILT-UP BEAMS SHALL BE BOLTED WITH ½" Ø THRU BOLTS, MEETING A307 STANDARDS, OR, AS NOTED ON DRAWINGS

## WOOD LINTEL SCHEDULE:

Lintels over openings in bearing walls shall be as follows; or as noted on drawings.

Span of	opening:	Size: 2x6 studs	Size: 2x4 stud
less tha	n 4'-0"	3 - 2x4	2 - 2x4
up to	6'-0"	3 - 2x6	2 - 2x6
up to	8'-0"	3 - 2x8	2 - 2x8
up to	10'-0"	3 - 2x10	2 - 2x10

## **DESIGN CRITERIA:**

ALL WORK PERFORMED UNDER THIS CONTRACT SHALL CONFORM TO THE NINTH EDITION OF THE MASSACHUSETTS BUILDING CODE.

DESIGN LIVE LOAD = 40 POUNDS PER SQUARE FOOT

- FLOORS
- PRIVATE DECK

DESIGN SNOW LOAD = 40 POUNDS PER SQUARE FOOT

ALL LUMBER SHALL BE #2 SPF, Fb= 875 PSI, Fv=135 PSI.

WITH SNOW DRIFT

WHERE APPLICABLE. WIND LOAD = 128 MILES PER HOUR

SEISMIC:  $S_S = 0.217$ 

S1 = 0.069

Governing Article: 65 2f-5000 **Subdistrict:** 

**ZONING CODE ANALYSIS** 

| **Dimensional Regulations**: Table

Use Regulations: Section Table						
Existing	Proposed					
2 FAMILY	2 FAMILY					

6 Davitt

	Code Requirement		Existing Condition	Proposed Project	Notes		
Lot Area Minimum	5000						
Min Lot Area for Additional Units							
Total Required Lot Size	5000		3210	3210	EX'G NON CONFORMANCE NO CHANGE		
Min Required Lot Width and Frontage	40		40	40	NO CHANGE		
Max FAR	0.5		2228/3210=.69	2228/3210=.69	EX'G NON CONFORMANCE REMAINS- NO CHANGE		
Max Building Height / Stories	2.5/ 35'		2.5/28'	2.5/28'	NO CHANGE		
Usable Open Space	750		1748 TOTAL/ 874 PER UNIT	1748 TOTAL/ 874 PER UNIT	NO CHANGE		
Min Front Yard	modal		4.75 (PORCH)	4.75 (PORCH)	NO CHANGE		
Min Side Yard	10		2.7/12.25	2.7/12.25	NO CHANGE		
Min Rear Yard	<del>20</del> / 10 feet reduction		32.3	19.5	SHALLOW LOT REDUCTION ALLOWS FOR 10' REAR YARD		
Max Use of Rear Yard	25%		NA	NA	17		

PROPOSED

RENOVAULON

6-8 DAVIII SI

DORCHESTER,

MASSACHUSEUS

Overlays:	Parking:
NDOD	1 per unit
	EX'G 2 TANDEM
	PROPOSED 2 TANDEM REMAINS

## Other Non-Dimensional Zoning Issues:

Proposed dormers only increase the head room of ex'g floor area on the building- No floor area is proposed to be added.

**NO CHANGE** 

## REN 山

## ST ER

## KEY

(HD)	HEAT DETECTOR
	CARBON MONOXIDE DETECTOR
	EMERGENCY LIGHT
P	HORN/ STROBE/ PULL STATION
	HORN/ STROBE
<u></u>	1 HOUR WALL(SEE W.T.1/A-3.1)
<u></u>	2 HOUR WALL(SEE W.T.2/A-3.1)
10)	3 HOUR WALL(SEE W.T.3/A-3.1)
$\boxtimes$	FAN
©	45 MIN. DOOR
$^{\odot}$	1-1/2 HOUR DOOR
FACP	FIRE ALARM CONTROL PANEL
?	WINDOW TYPE
1	1 HOUR CLG. ABOVE (SEE C.T.1/A-3.1
2	2 HOUR CLG. WALL(SEE C.T.2/A-3.1)
3	3 HOUR CLG. WALL(SEE C.T.2/A-3.1)

FIRE EXTINGUISHER

SMOKE DETECTOR

## CODE SUMMARY

(FE)

EX'G TYPE 5B CONSTRUCTION PROPOSED REMAINS 2.5 STORIES PROPOSED REMAINS R-3 2 RES UNITS PROPOSED REMAINS

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One Billings Road Quincy, MA 02171 617-786-7727 fax 617-786-7715													

Revision Date

2020156 roject No: AS NOTED Pate: 07-16-2020

Orawing Name

**COVER** SHEET

Sheet No.



## RENOVATION PROPOSED




0.	Revision Date


2020156 AS NOTED 07-16-2020


REFERENCE IMAGES





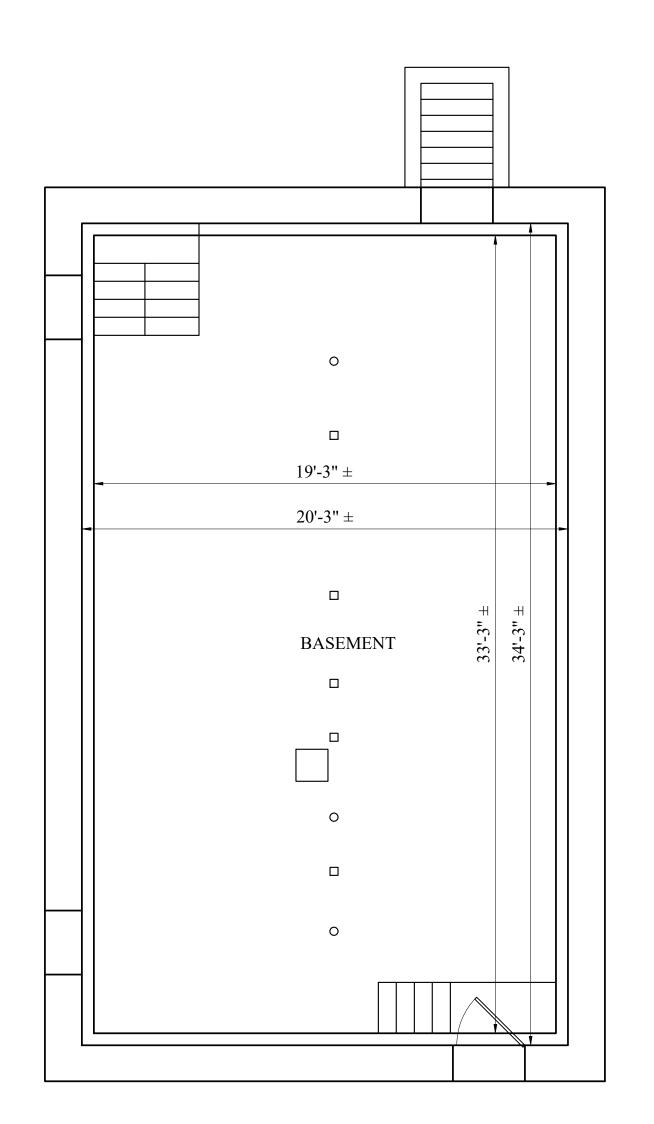

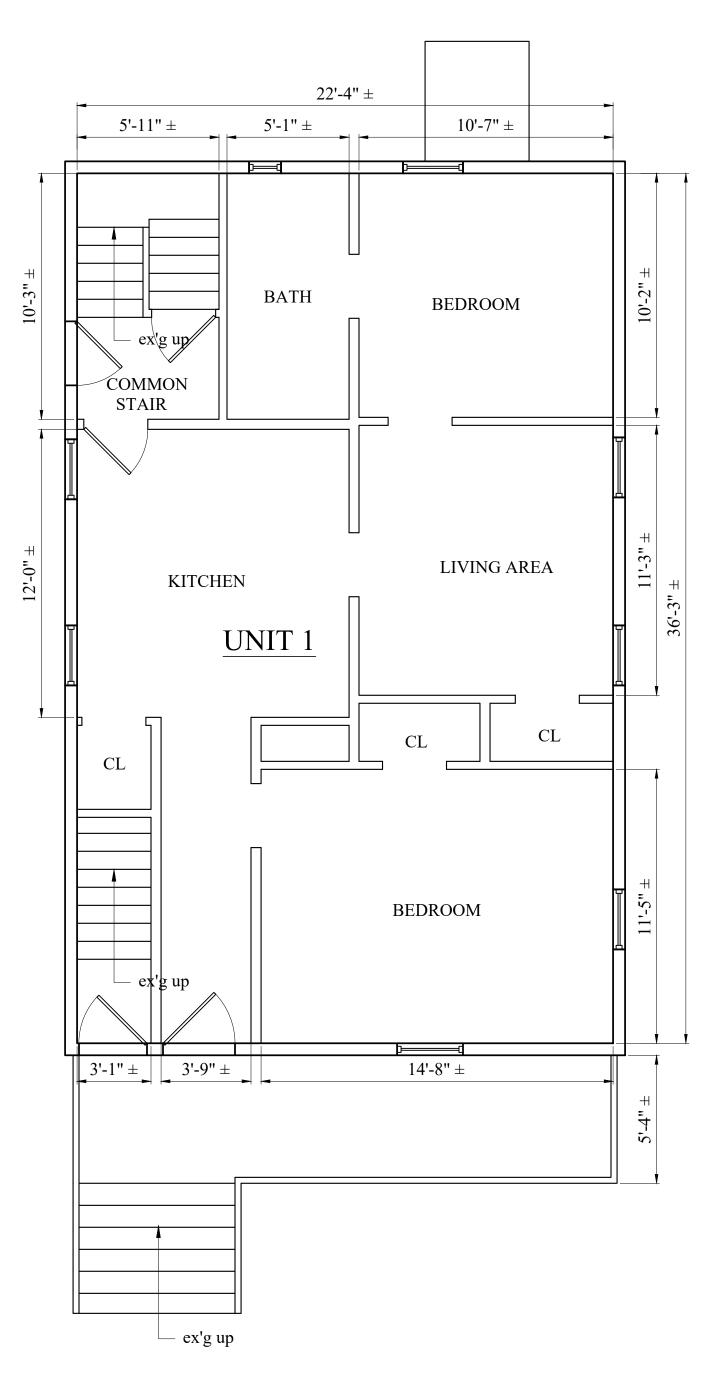

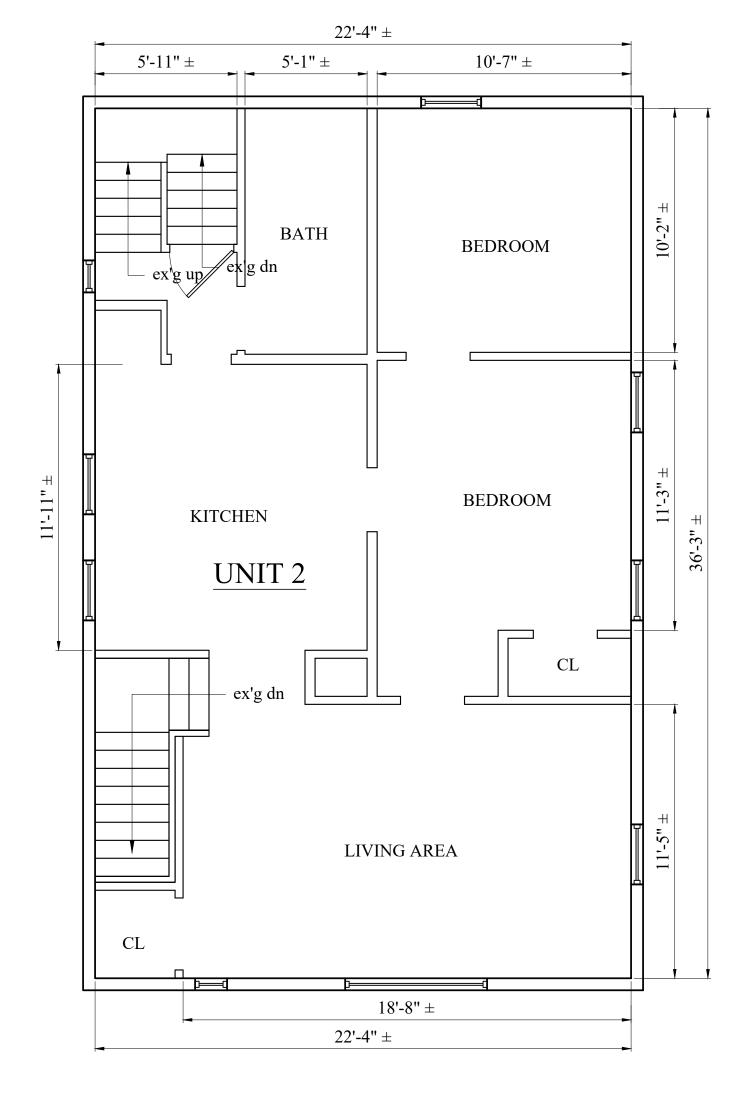

## DAVITT STREET



## DAVITT STREET



## DAVITT STREET

7	EXISTING SECOND FLOOR PLAN
	/4" =  '-0"

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# PROPOSED RENOVATIO

No.

Revision Date


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Scale: AS NOTED
Date: 07-16-2020
Drawn By: SL


Drawing Name

EXISTING

PLANS

Sheet No.

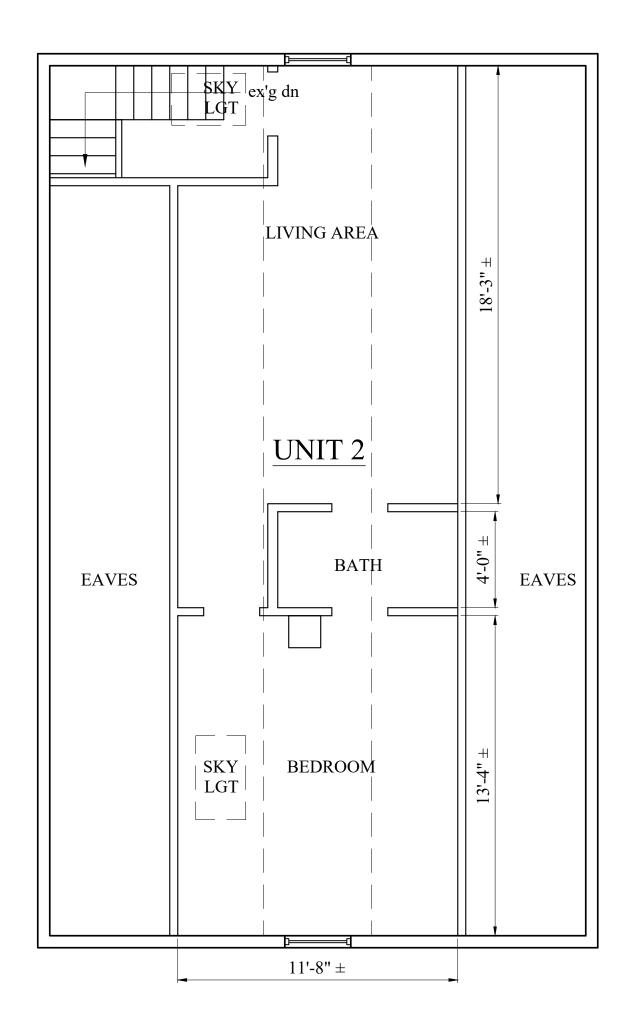

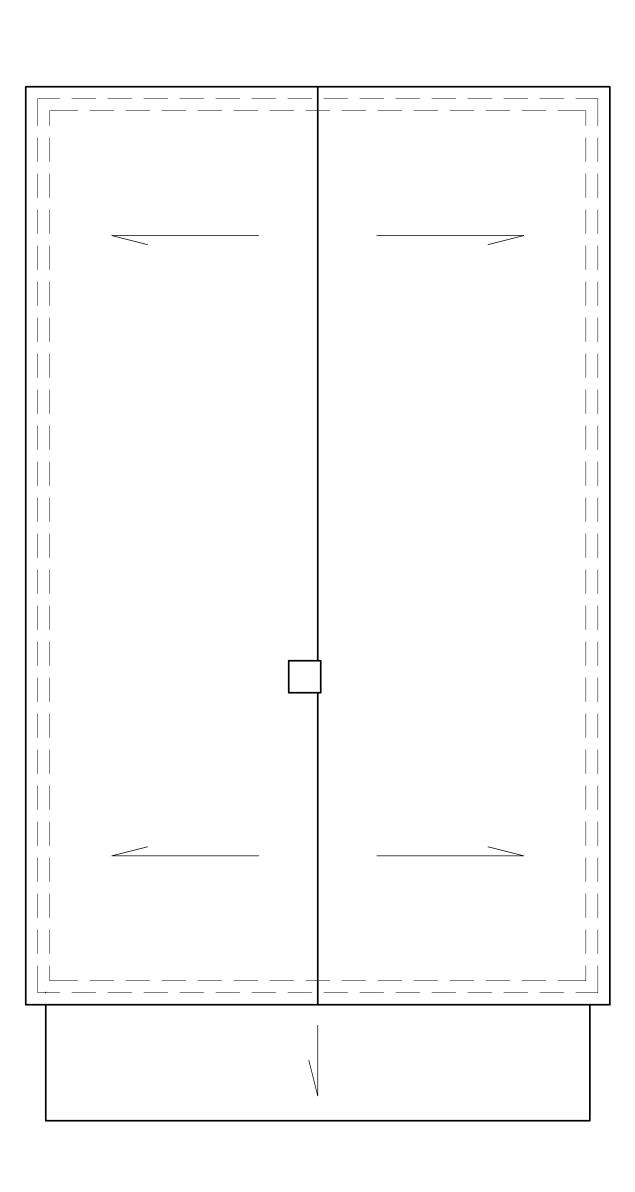

DAVITT STREET

DAVITT STREET



<u>(</u> 5)	EXISTING ROOF PLAN
	/4" =  '-0"

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PROPOSED RENOVATION

One Billings Road Quincy, MA 02171
617-786-7727 fax 617-786-7715

Project No: 2020156
Scale: AS NOTED
Date: 07-16-2020

Drawing Name

EXISTING PLANS

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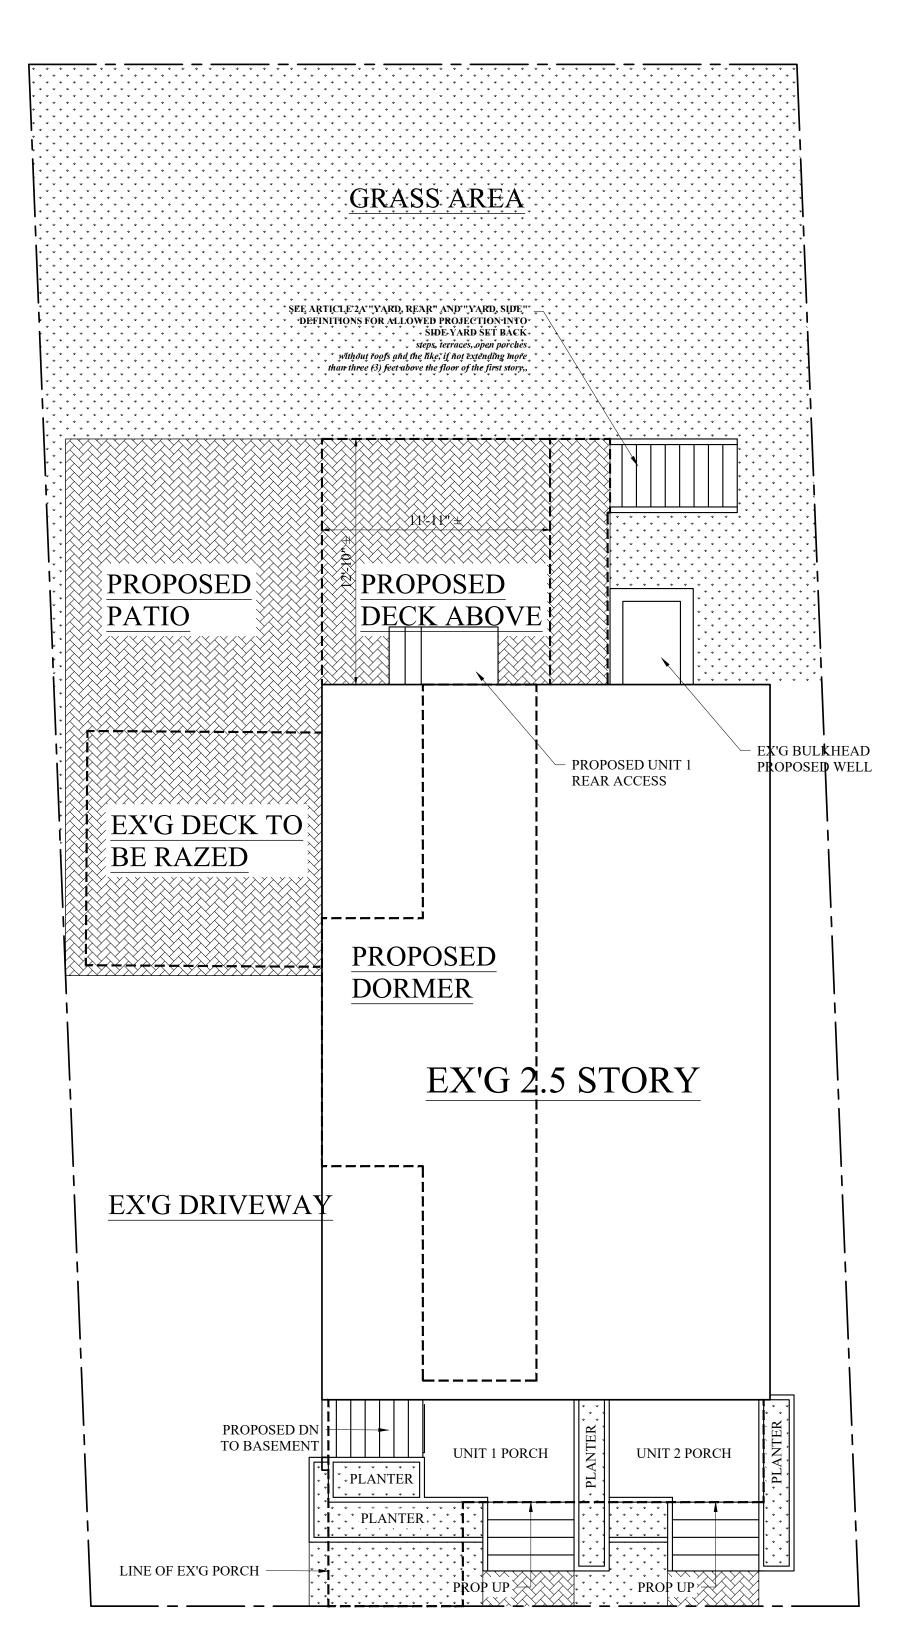
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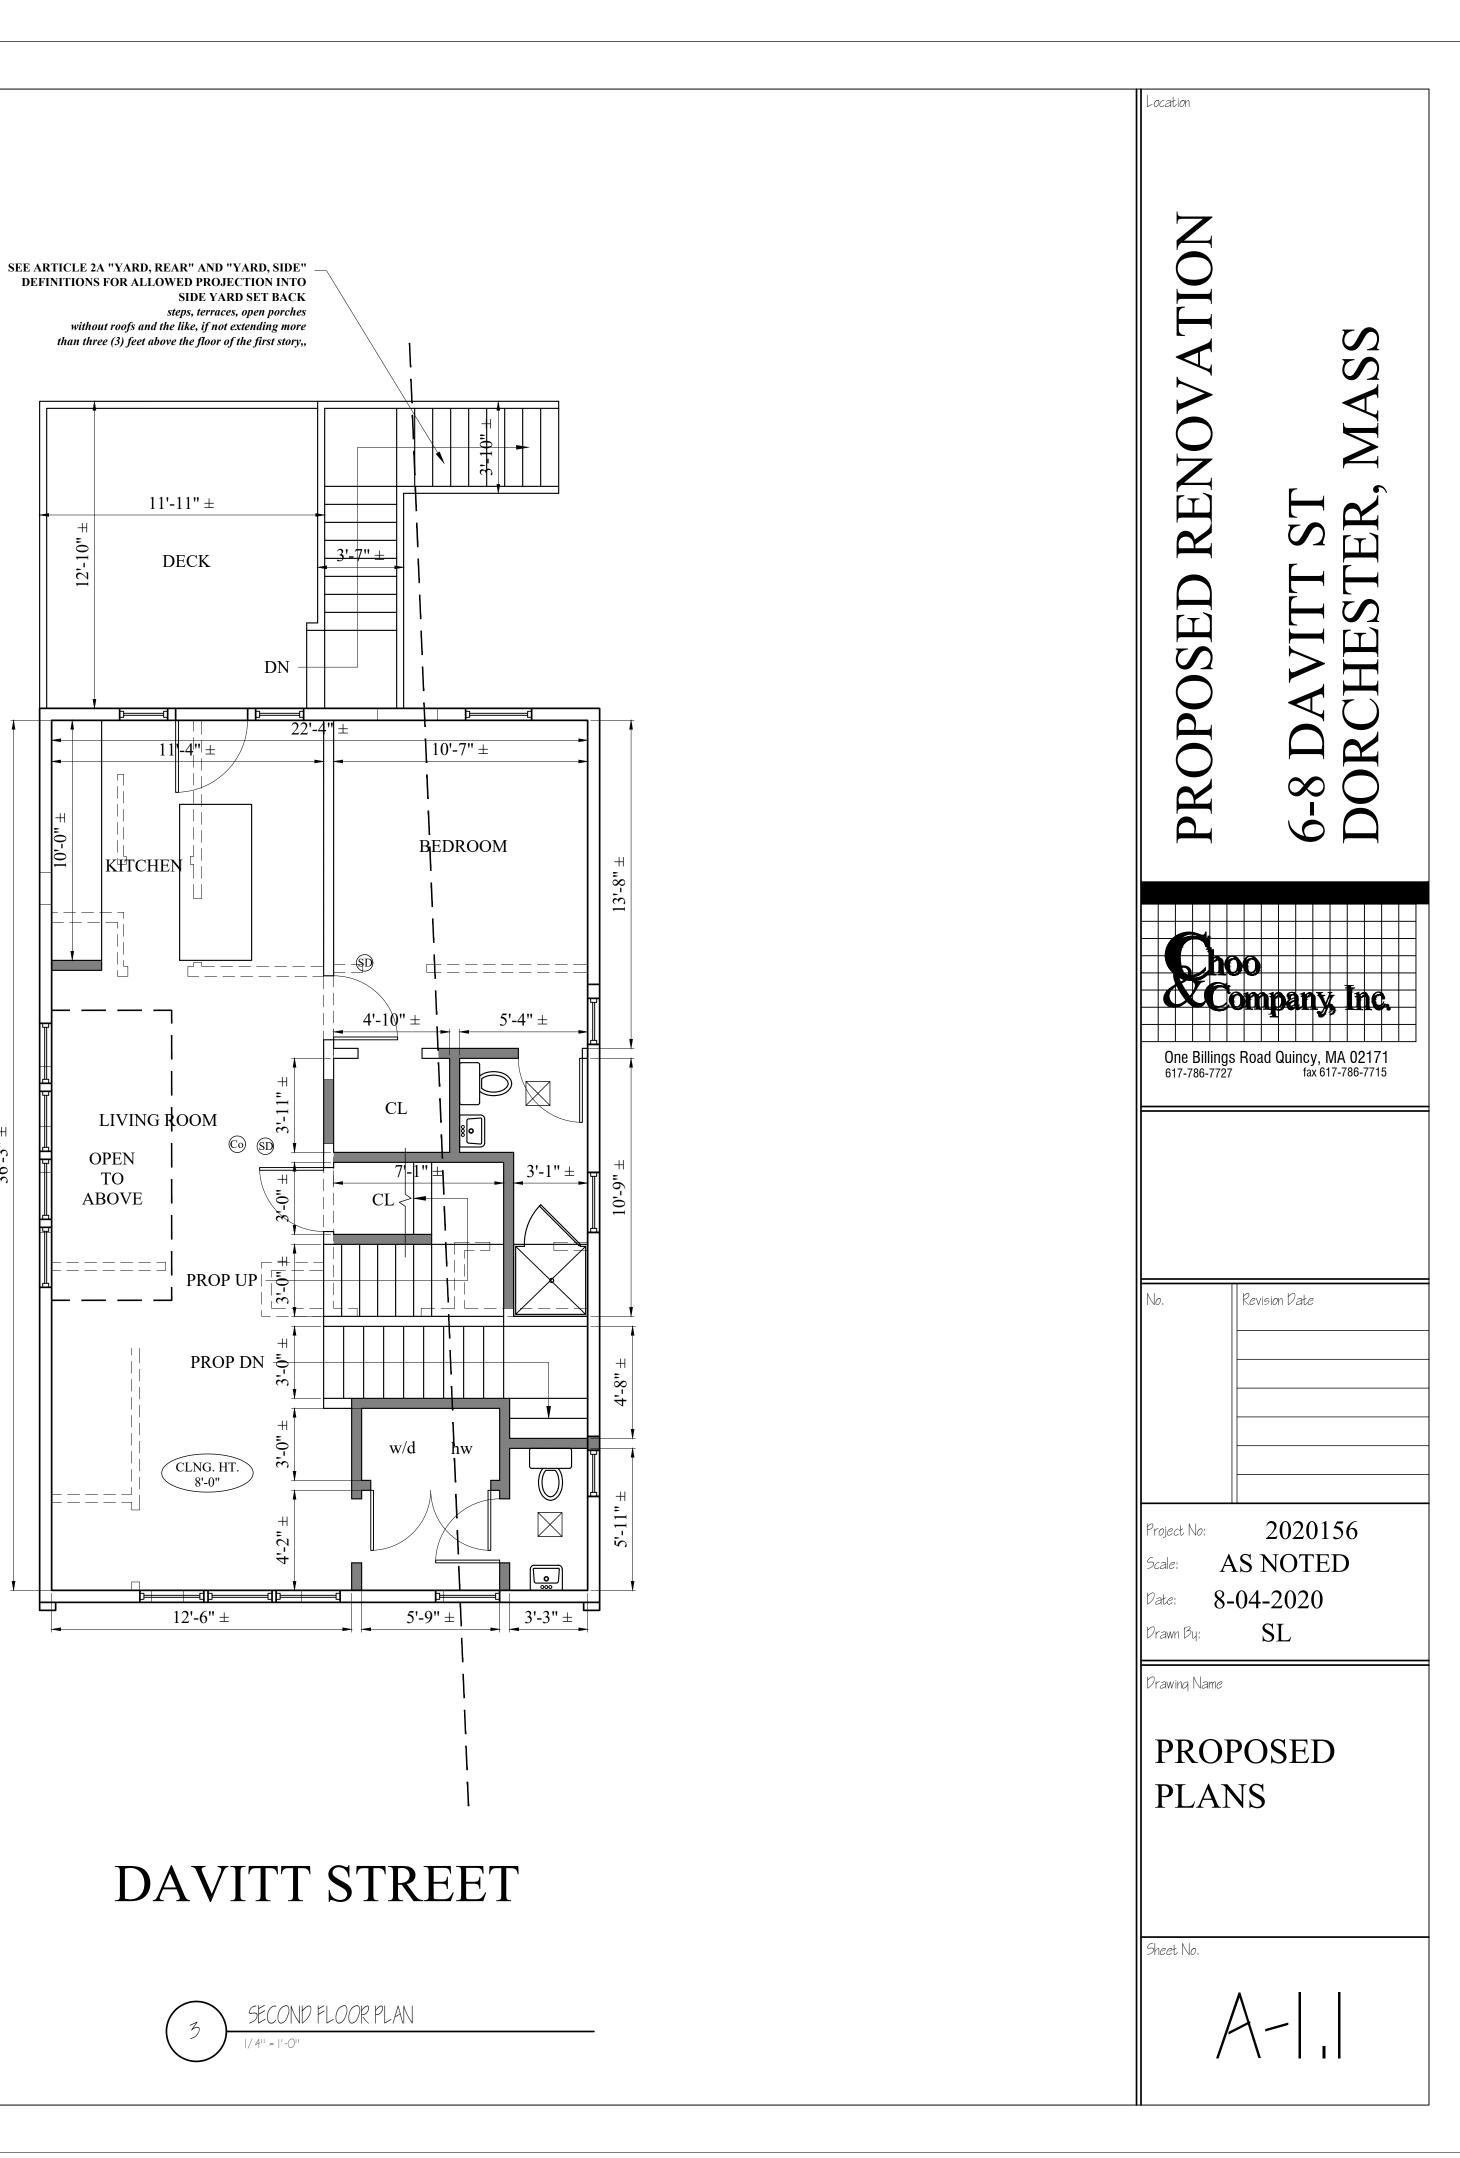
2020156 Scale: AS NOTED Date: 07-16-2020


PROPOSED PLANS



DAVITT STREET





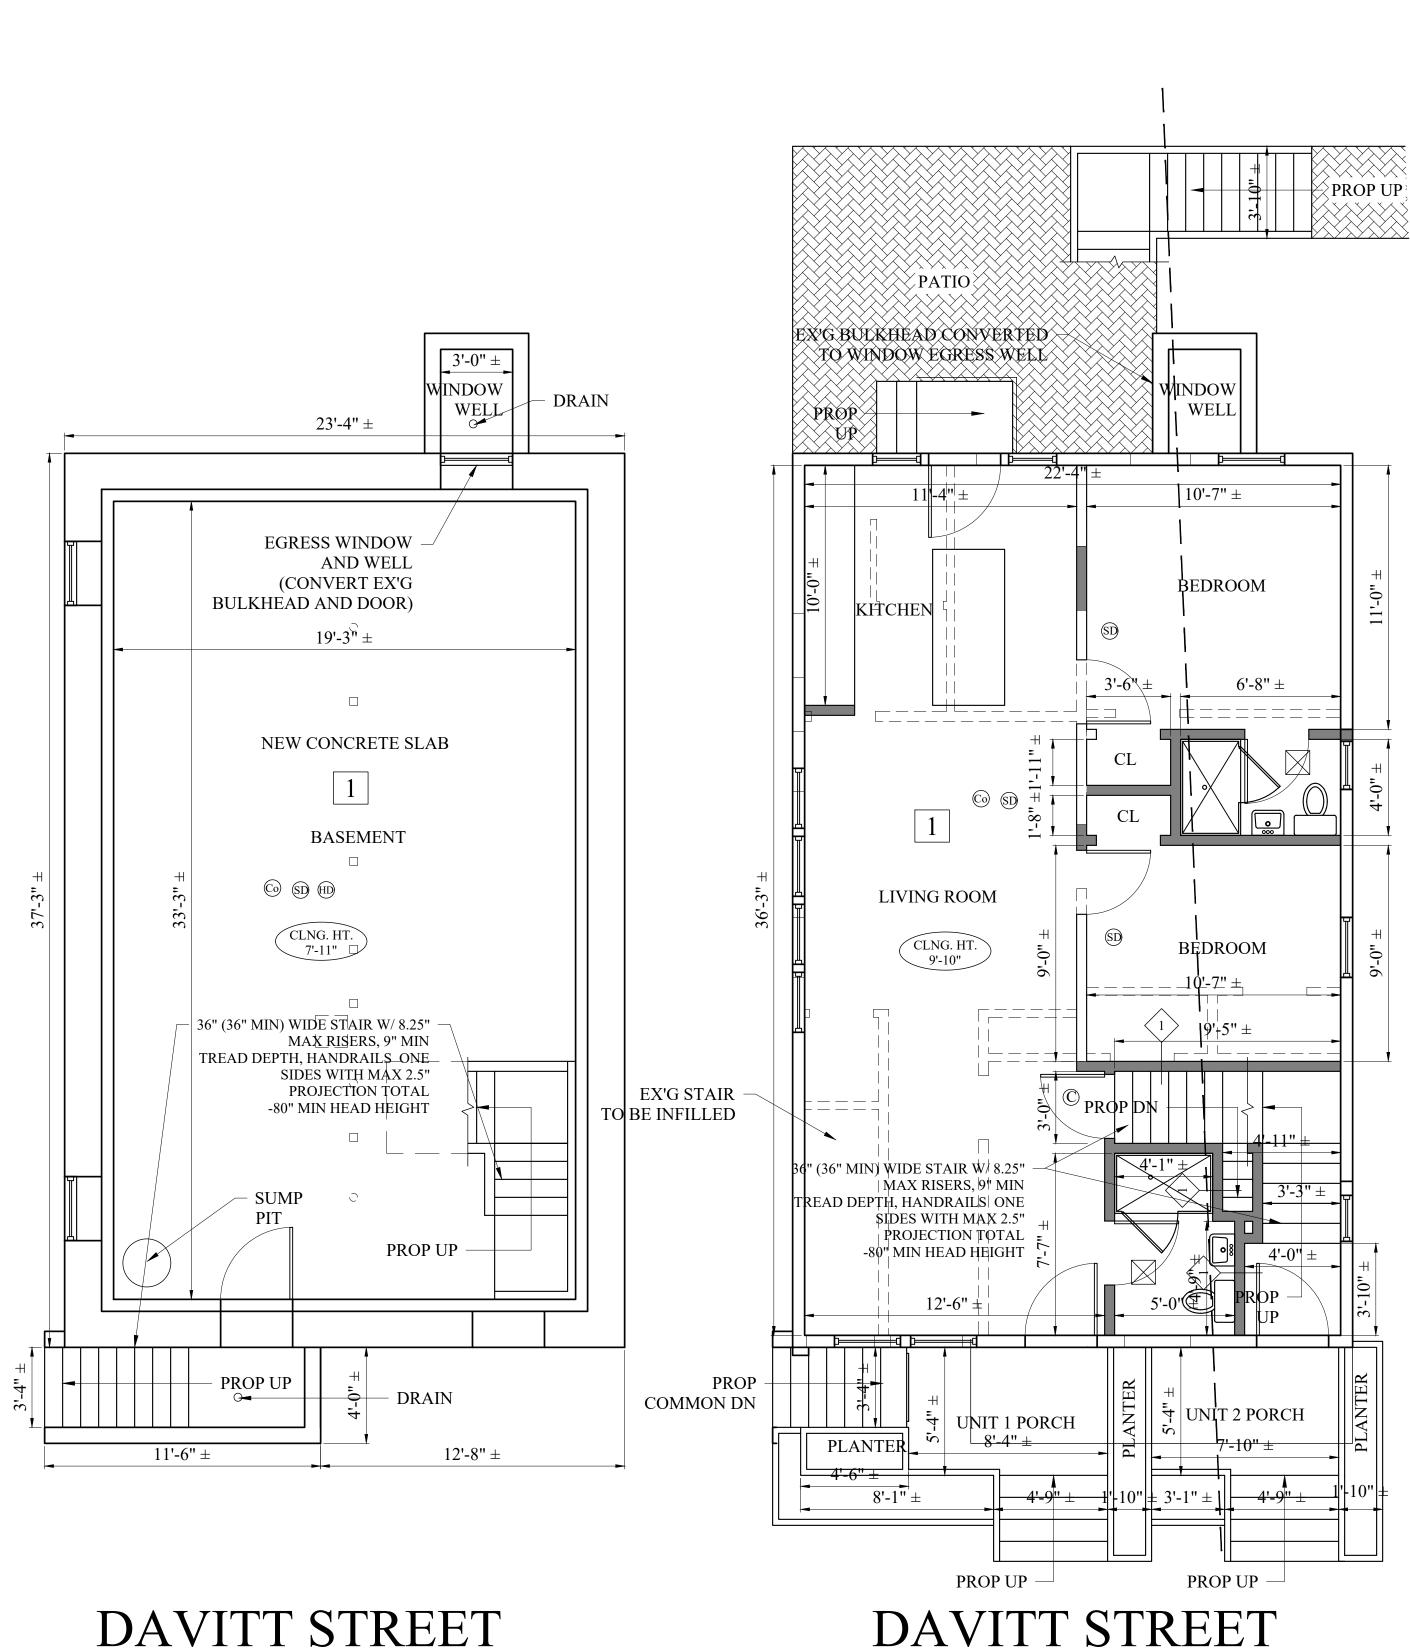

BASEMENT FLOOR PLAN

DAVITT STREET

Location

# 6-8 DAVITT ST

One Billings Road Quincy, MA 02171
617-786-7727 fax 617-786-7715

No.	Revision Date

Project No: 2020156

Scale: AS NOTED

Date: 8-04-2020


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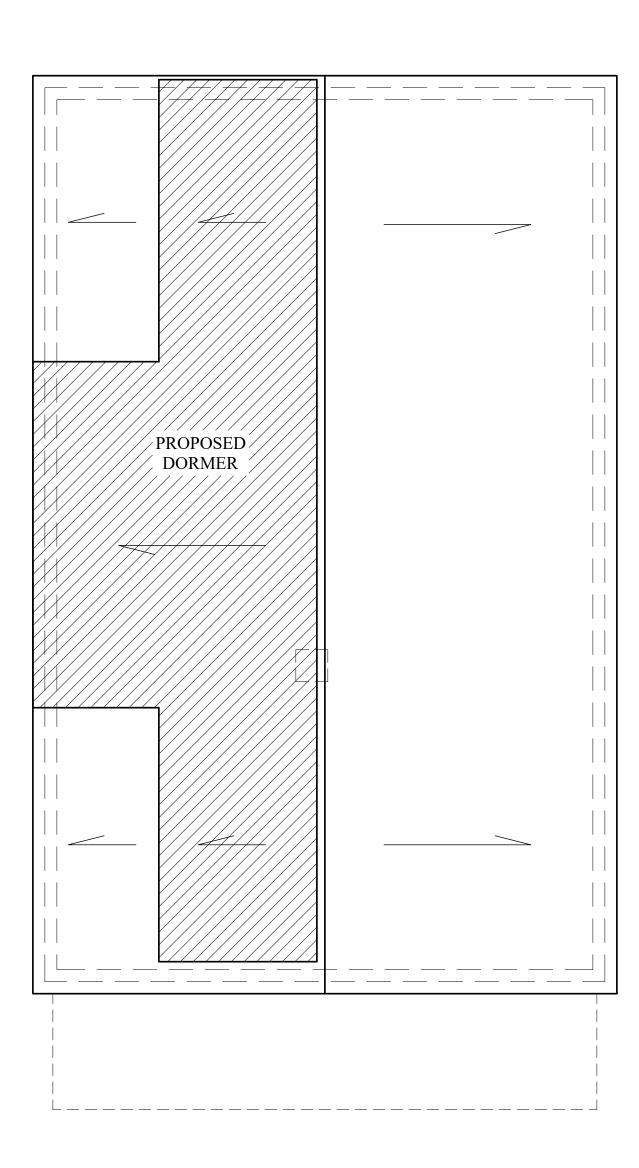
PROPOSED PLANS

T . A.I.

A-12

- NOTE: NEW DORMERS IN LINE WITH EXISTING EAVE WALLS - NO INCREASE IN EXISTING FLOOR AREA



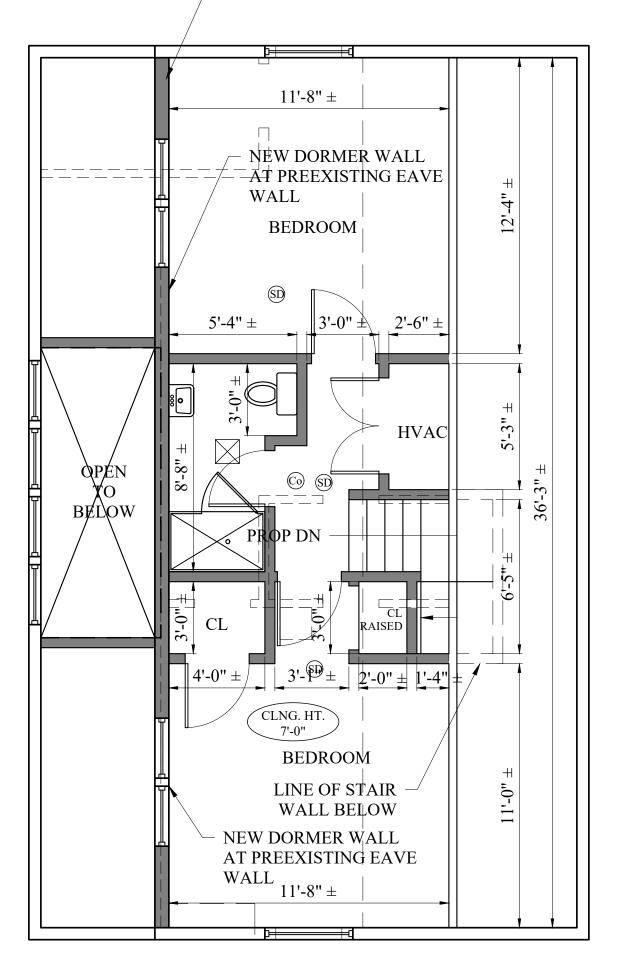

## DAVITT STREET

DAVITT STREET



