

RCA, LCC Telephone: 617sachusetts 02122 Fax: 617-

r Street MA 02122

PROJECT # 16-158

DATE: 1-9-17 REV:


SCALE: 1/4" = 1'-0" DRAWN BY:

DM CHECKED BY: R.P.B


SZ

EXISTING FLOOR PLAN

EX1

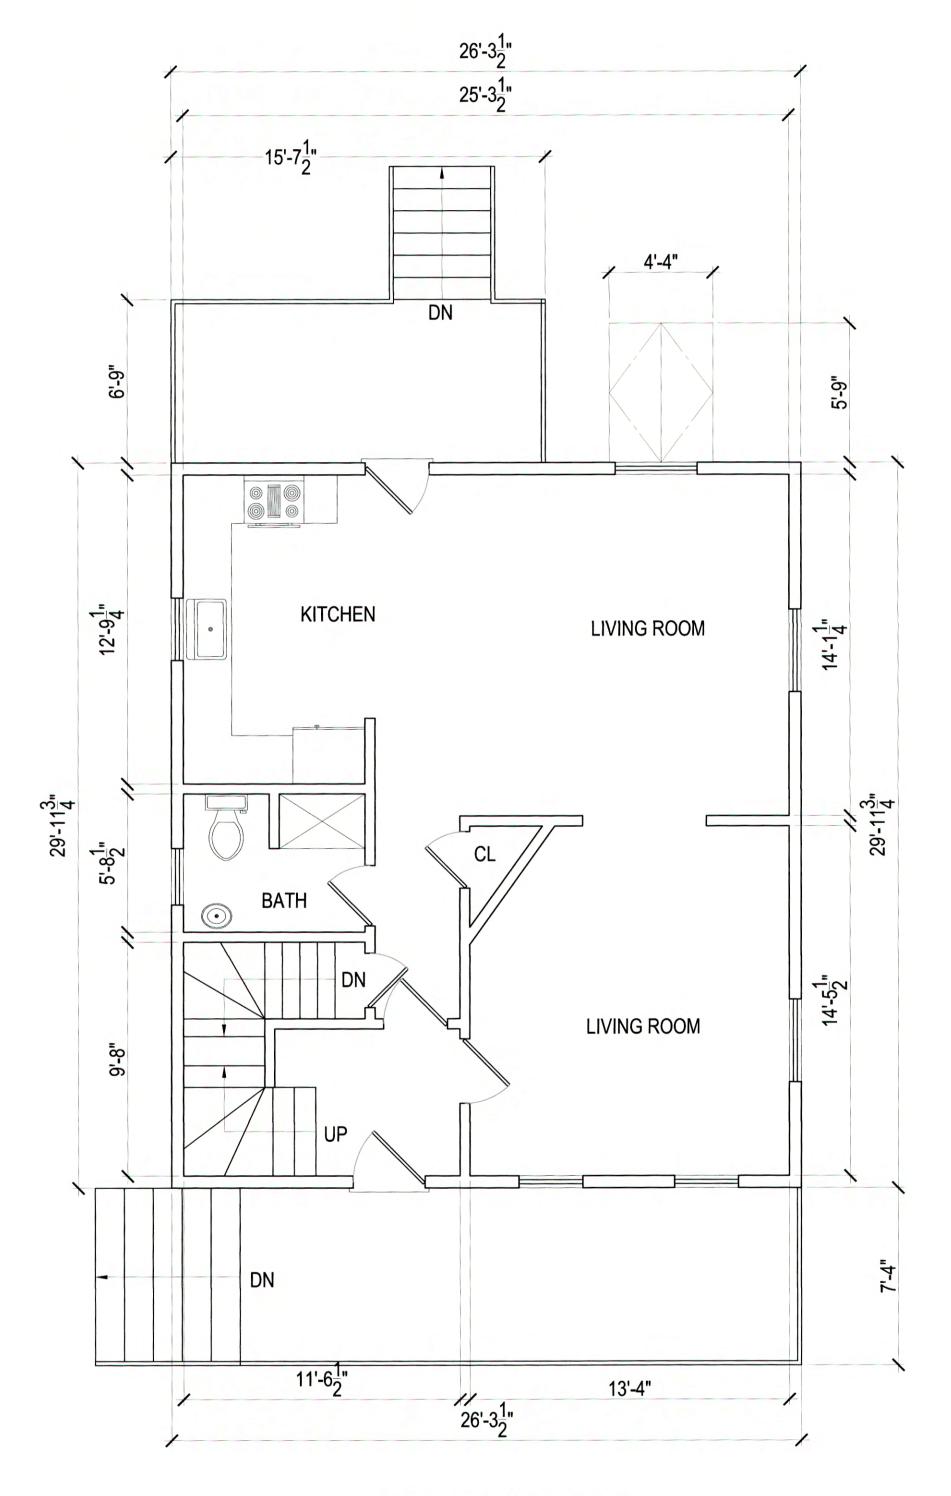

FIRST FLOOR PLAN

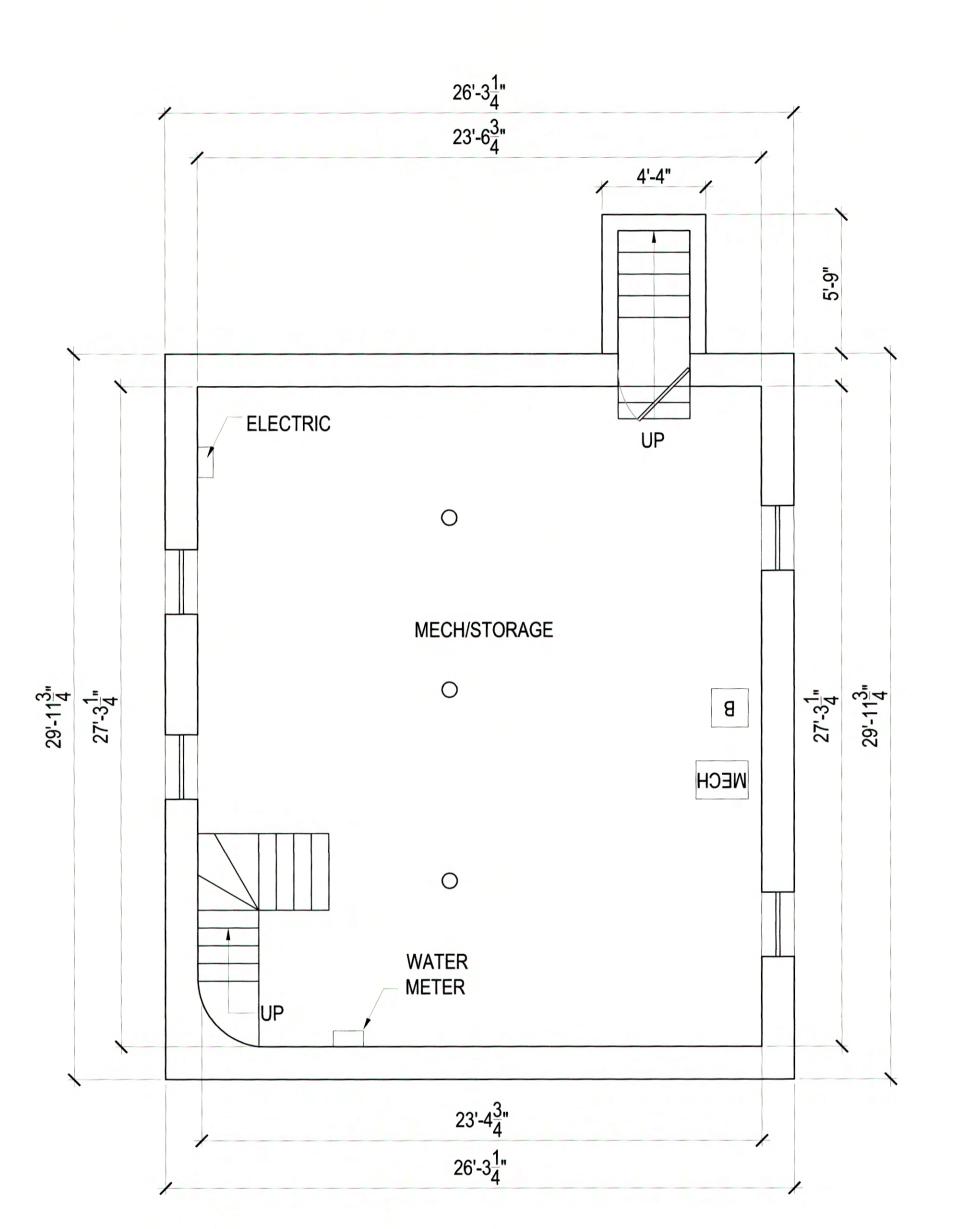


BASEMENT PLAN




VERIFY AND CONFIRM ALL CONDITIONS AND/OR DIMENSIONS SHOWN PRIOR TO COMMENCING CONSTRUCTION OR ORDERING MATERIALS. NOTIFY ARCHITECT OF ANY INCONSISTENCIES FOR REVIEW AND APPROVAL BEFORE PROCEEDING WITH CONSTRUCTION.


| REV. | DATE | DESCRIPTION | |
|----------|---------|-------------|--|
| <u>1</u> | X-XX-XX | XXX | |

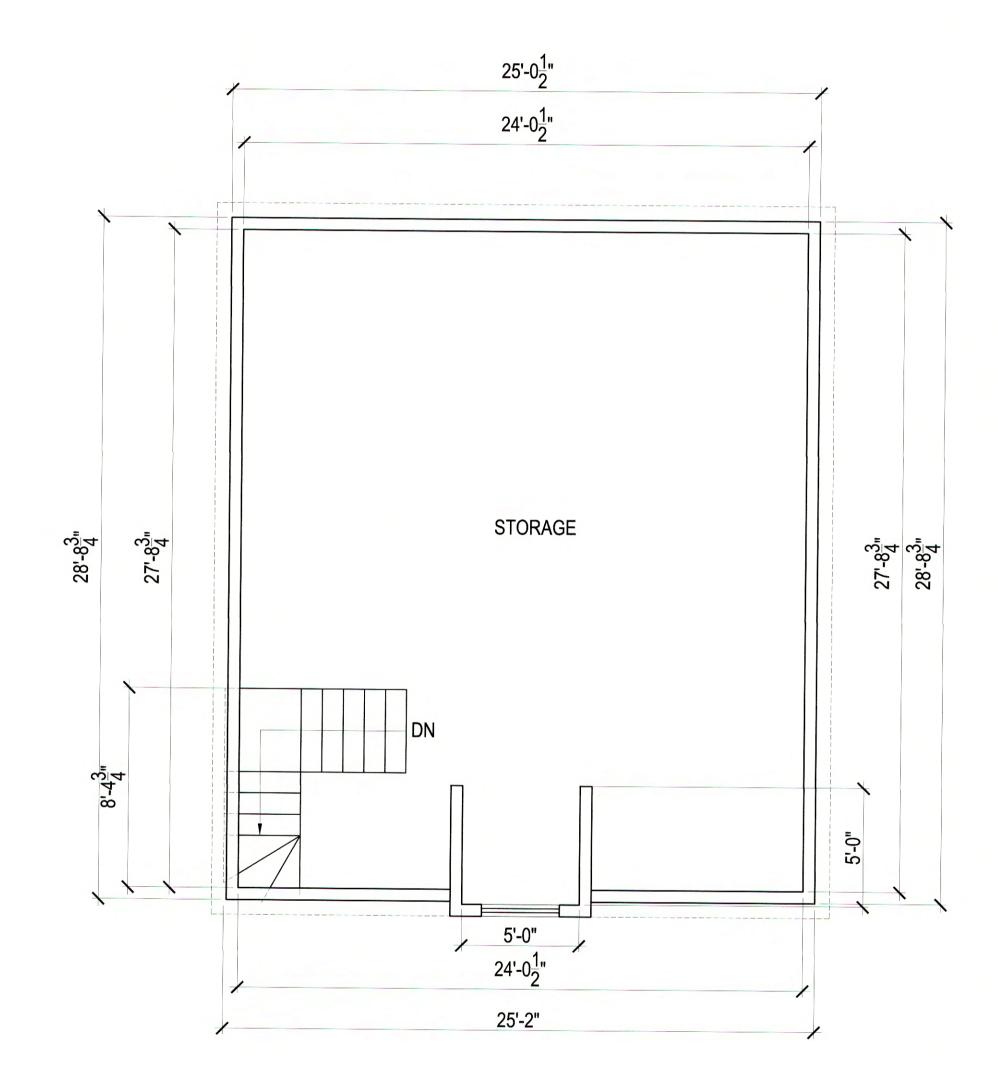

ATTIC FLOOR PLAN

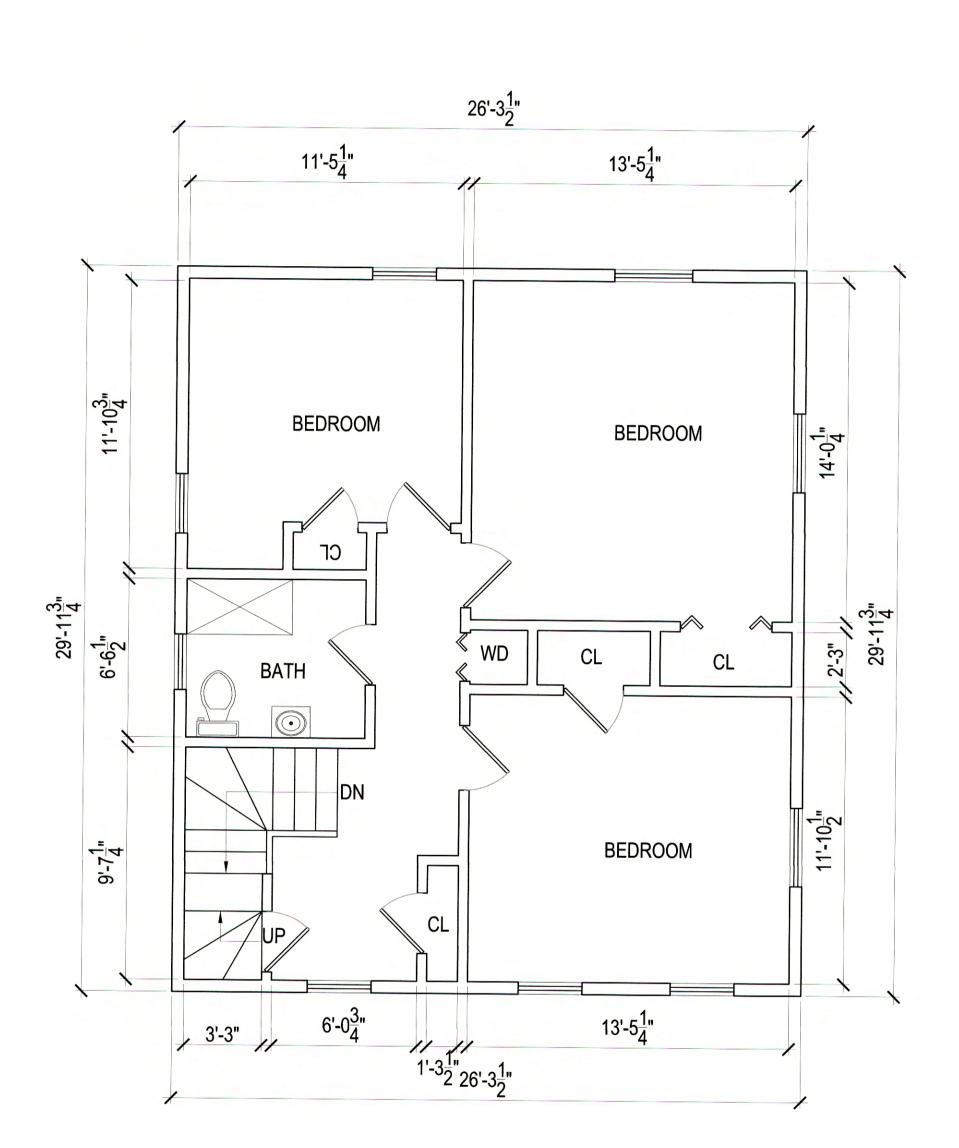

SECOND FLOOR PLAN

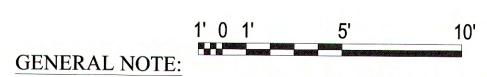

VERIFY AND CONFIRM ALL CONDITIONS AND/OR DIMENSIONS SHOWN PRIOR TO COMMENCING CONSTRUCTION OR ORDERING MATERIALS. NOTIFY ARCHITECT OF ANY INCONSISTENCIES FOR REVIEW AND APPROVAL BEFORE PROCEEDING WITH CONSTRUCTION.

No. 7320
WEYMOUTH.

Sephone: 617-282-0030 Fax: 617-282-1080

www.roche-christopher.com Telephone: 617

415 Neponset Ave. www.roche-christopher..

Dorchester, Massachusetts 02122

James Neal 6 Butler Street Dorchester, MA 02122

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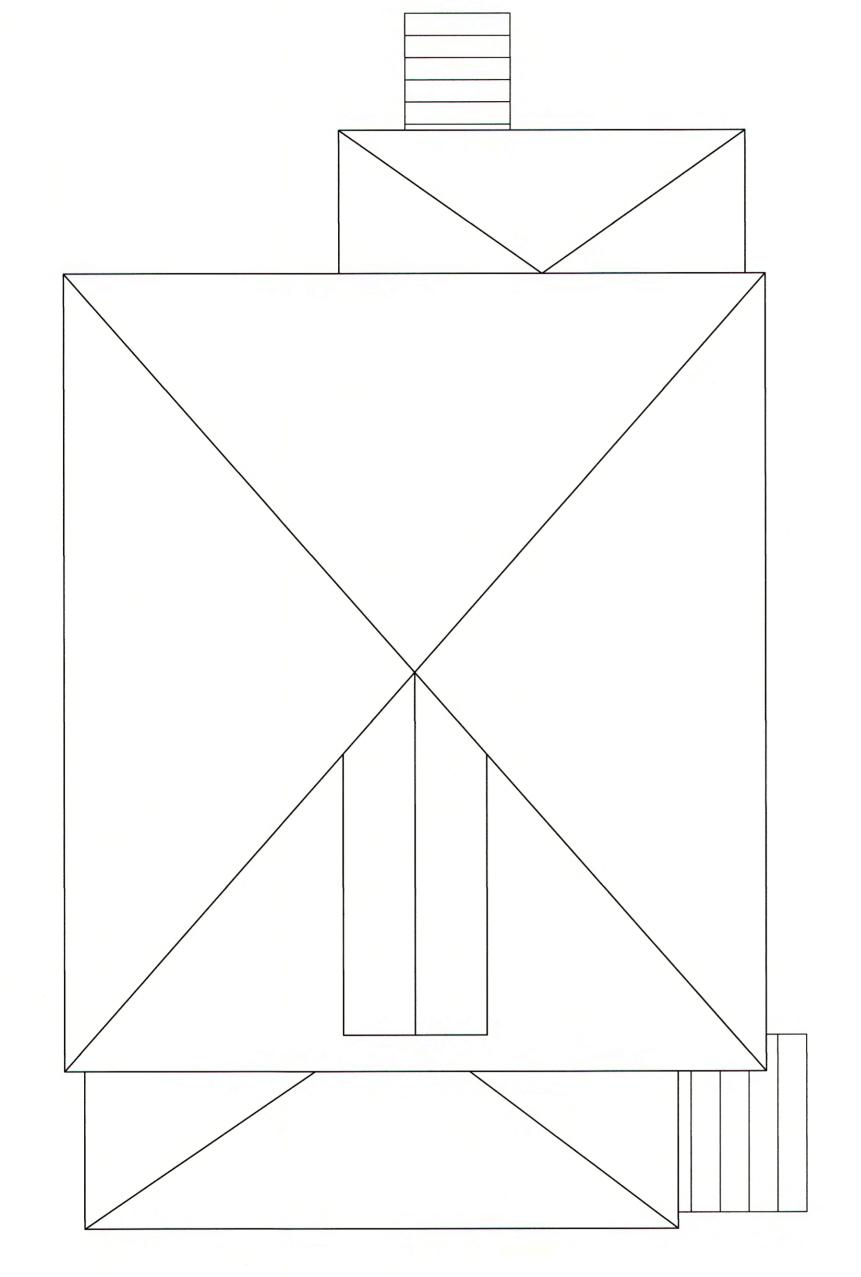
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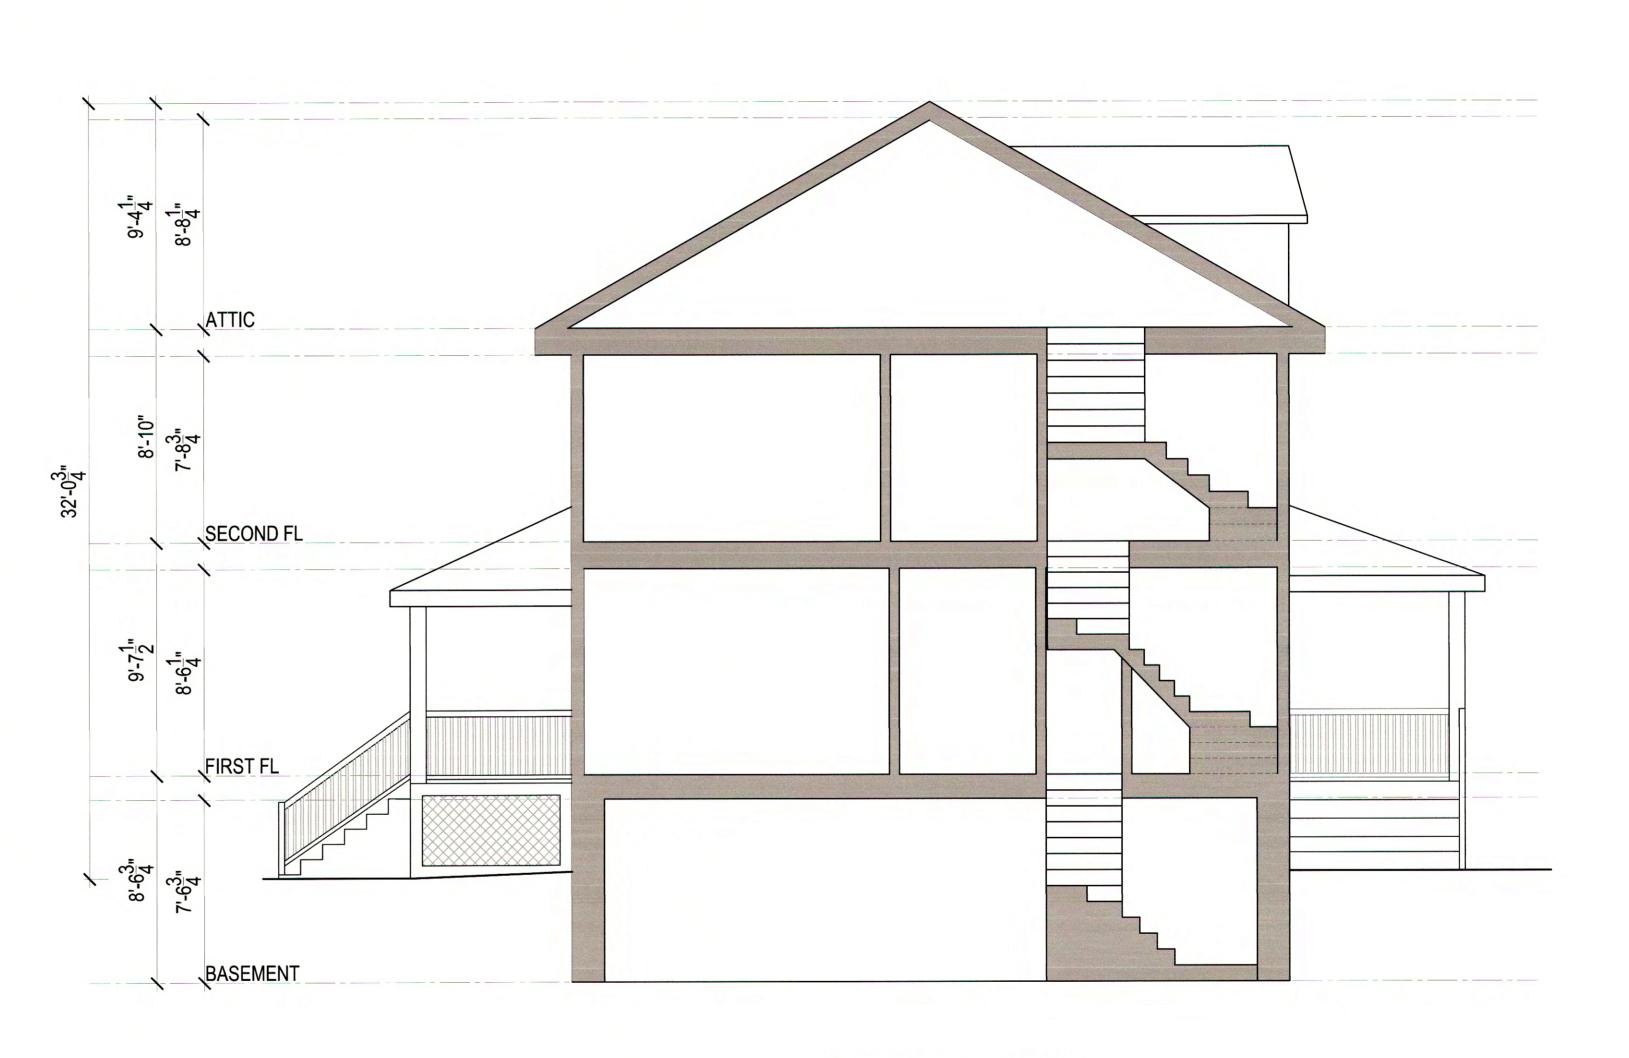
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EXISTING FLOOR PLANS

EX2

REV. DATE DESCRIPTION XXX





BUILDING SECTION

ROOF PLAN

GENERAL NOTE:

VERNEY AND CONFIDM ALL CONDITIONS AND OR DIMENSIONS SHOW

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MA

088

Telephone: 617-282-0030

RCA, LLC

James Neal 6 Butler Street Dorchester, MA 02122

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CHECKED BY: R.P.B

R.P.B

ROOF PLAN AND BUILDING SECTION

EX3



PROJECT # DATE: 1-9-17


SCALE: 1/4" = 1'-0"

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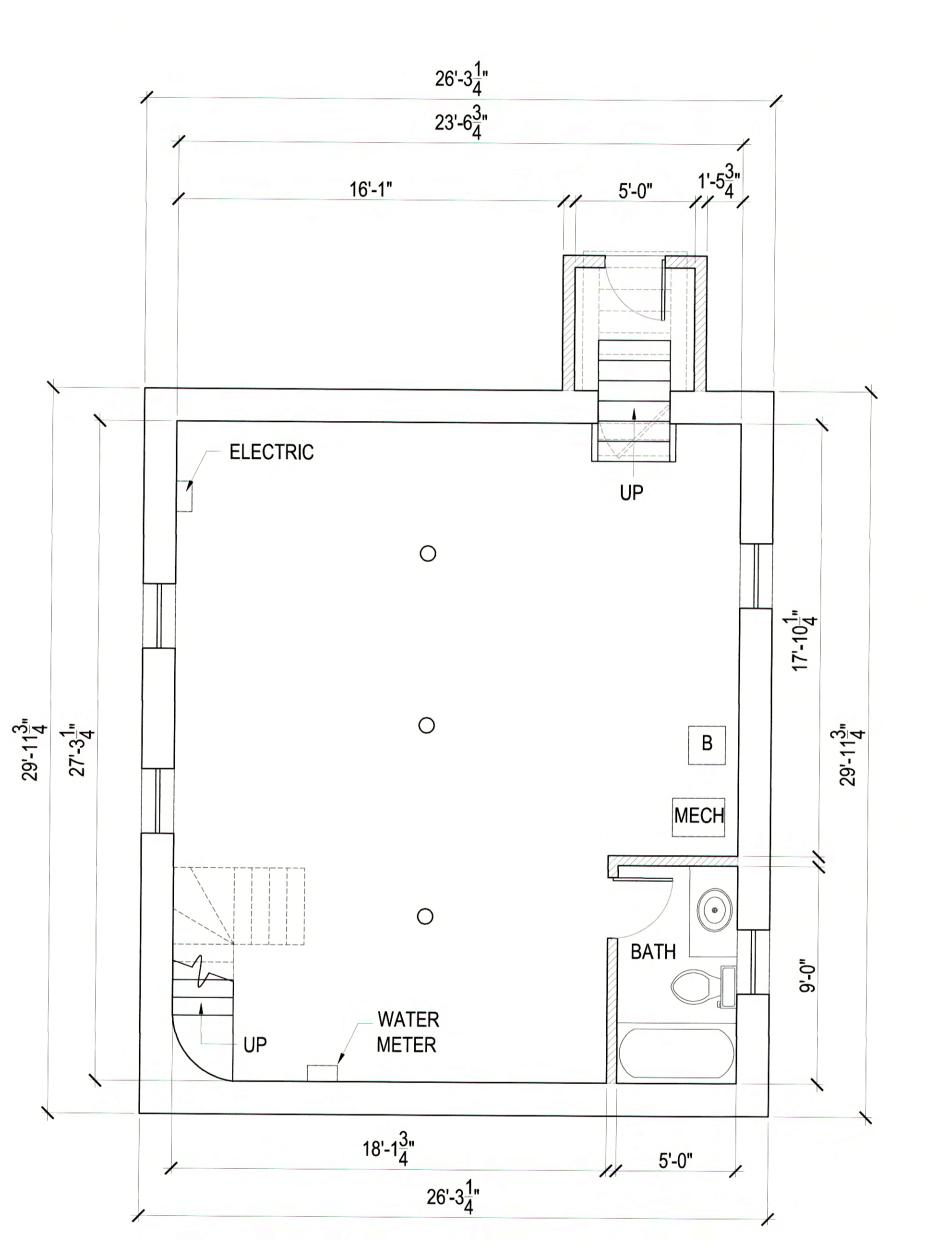
R.P.B

EXISTING ELEVATIONS

| REV. | DATE | DESCRIPTION | |
|------|---------|-------------|--|
| 1 | X-XX-XX | XXX | |

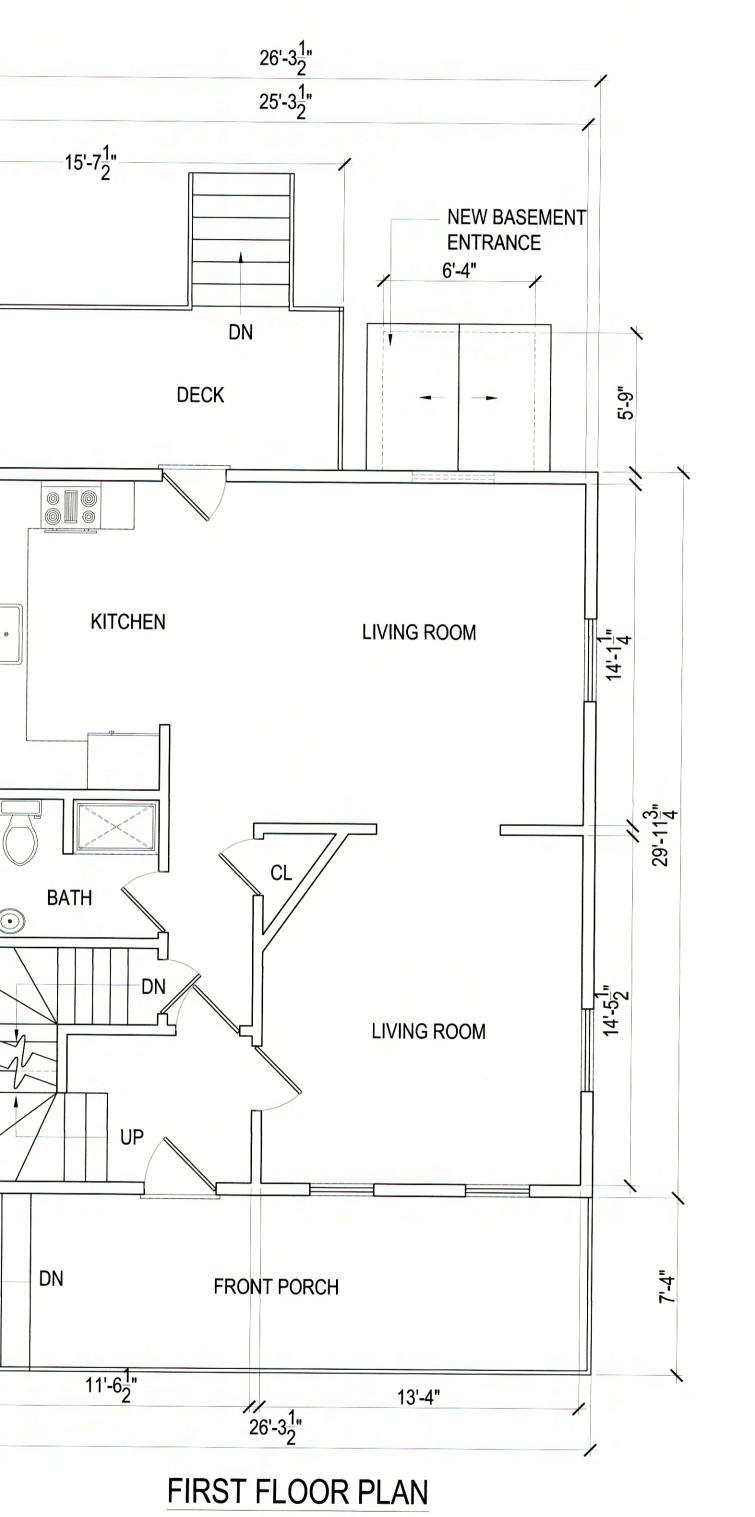

12'-9<mark>1</mark>"



BASEMENT PLAN

6 BUTLER STREET DORCHESTER, MA ZONING REVEIW

| ITEM | |
|----------------------------|------------------------|
| ZONING DISTRICT | 1F-5000 |
| EXISTING USE | RESIDENTIAL - 1 FAMILY |
| PROPOSED USE | RESIDENTIAL - 1 FAMILY |
| LOT SIZE | 5,124 S.F. |
| PROPOSED GROSS SQ. FOOTAGE | 5,124 S.F. |

DIMENSIONAL REGULATIONS TABLE F

| ITEM | REQUIRED | PROPOSED |
|--------------------------------|---------------|----------------|
| MIN. LOT SIZE | 5,000 S.F. | 5,124 S.F. |
| MIN. LOT WIDTH | 40 | 51' |
| MIN. LOT FRONTAGE | 40' | 14'-10" |
| MAX. FLOOR AREA RATIO | 0.5 | 0.44 |
| MAX. ALLOWABLE BUILDING HEIGHT | 35'-0" | 32'-6" |
| MAX. BLDG STORIES | 2 1/2 STORIES | 2 1/2 |
| MIN. SIDE YARD | 10' | 18'-0" / 6'-7" |
| MIN. REAR YARD | 20' | 49' |
| MIN. FRONT YARD | 15' | 23'-8" |
| MIN. USABLE OPEN SPACE | N/A | N/A |

TOTAL FAR = .41

LEGEND


EXISTING WALL TO REMAIN

EXISTING WALL TO BE REMOVED

PROPOSED WALL

EXISTING DOOR TO REMAIN

EXISTING DOOR TO BE REMOVED

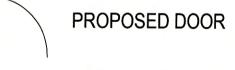





CM HARDWIRED & INTERCONNECTED CARBON MONOXIDE DETECTOR



VERIFY AND CONFIRM ALL CONDITIONS AND/OR DIMENSIONS SHOWN PRIOR TO COMMENCING CONSTRUCTION OR ORDERING MATERIALS. NOTIFY ARCHITECT OF ANY INCONSISTENCIES FOR REVIEW AND APPROVAL BEFORE PROCEEDING WITH CONSTRUCTION.

No. 7320 WEYMOUTH, MA

17-282-0030 17-282-0030 17-282-1080

CA, LLC

5 Neponset Ave. www.roche-christophe

6 Butler Street orchester, MA 02122

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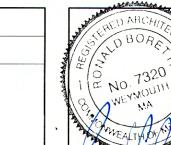
SCALE: 1/4" = 1'-0" DRAWN BY:

MM CHECKED BY: R.P.B

> PROPOSED FLOOR PLANS

A1

| REV. DA | DATE | DESCRIPTION | |
|---------|---------|-------------|--|
| 1 | X-XX-XX | XXX | |



PROJECT# 16-158

DATE:5-30-17 SCALE:

1/4" = 1'-0" DRAWN BY: MM

CHECKED BY: R.P.B

PROPOSED FLOOR PLANS

EXISTING DOOR TO REMAIN

EXISTING WALL TO BE REMOVED

EXISTING DOOR TO BE REMOVED

PROPOSED DOOR

EXISTING WALL TO REMAIN

PROPOSED WALL

LEGEND


HARDWIRED & INTERCONNECTED SMOKE DETECTOR


HEAT DETECTOR

CARBON MONOXIDE DETECTOR

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ATTIC FLOOR PLAN

SECOND FLOOR PLAN

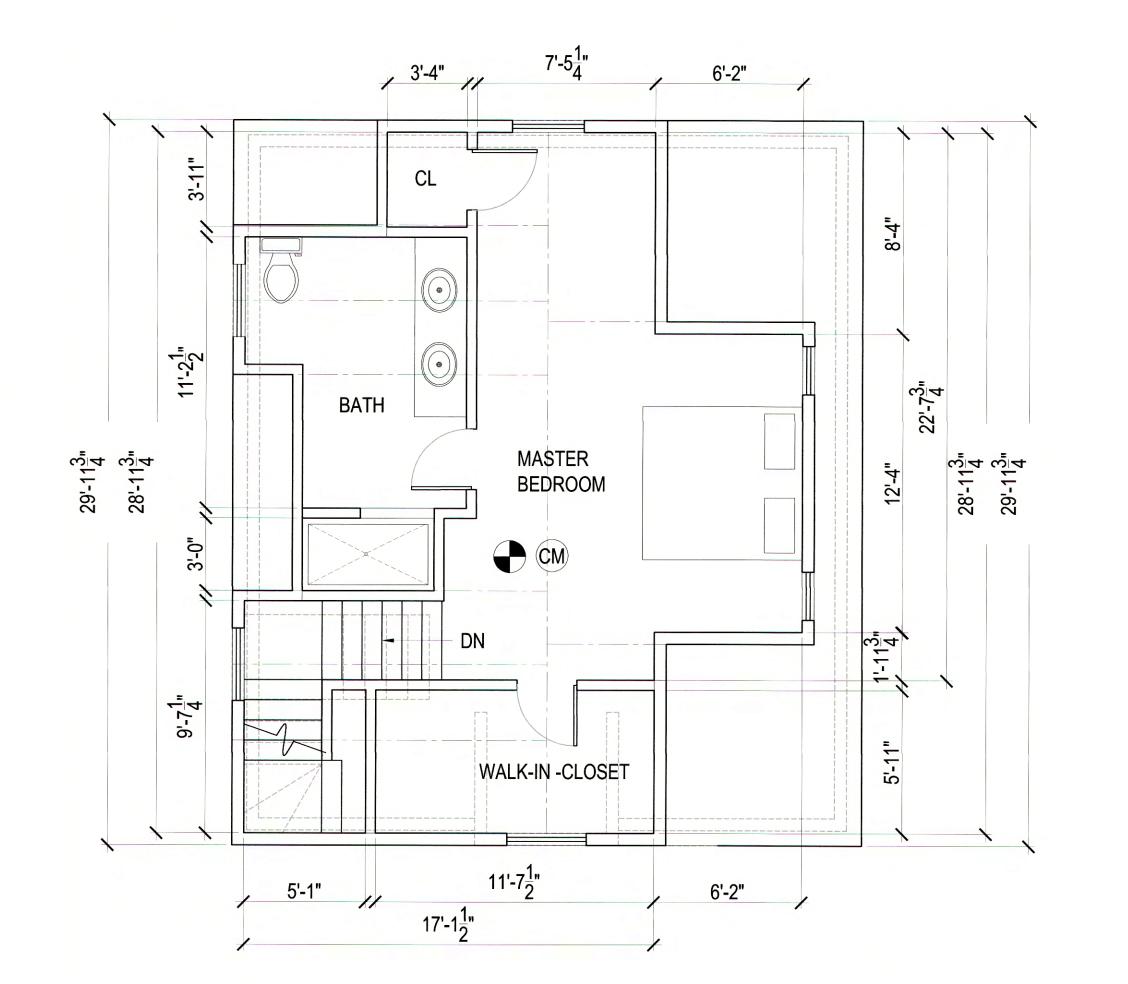HARDWIRED & INTERCONNECTED

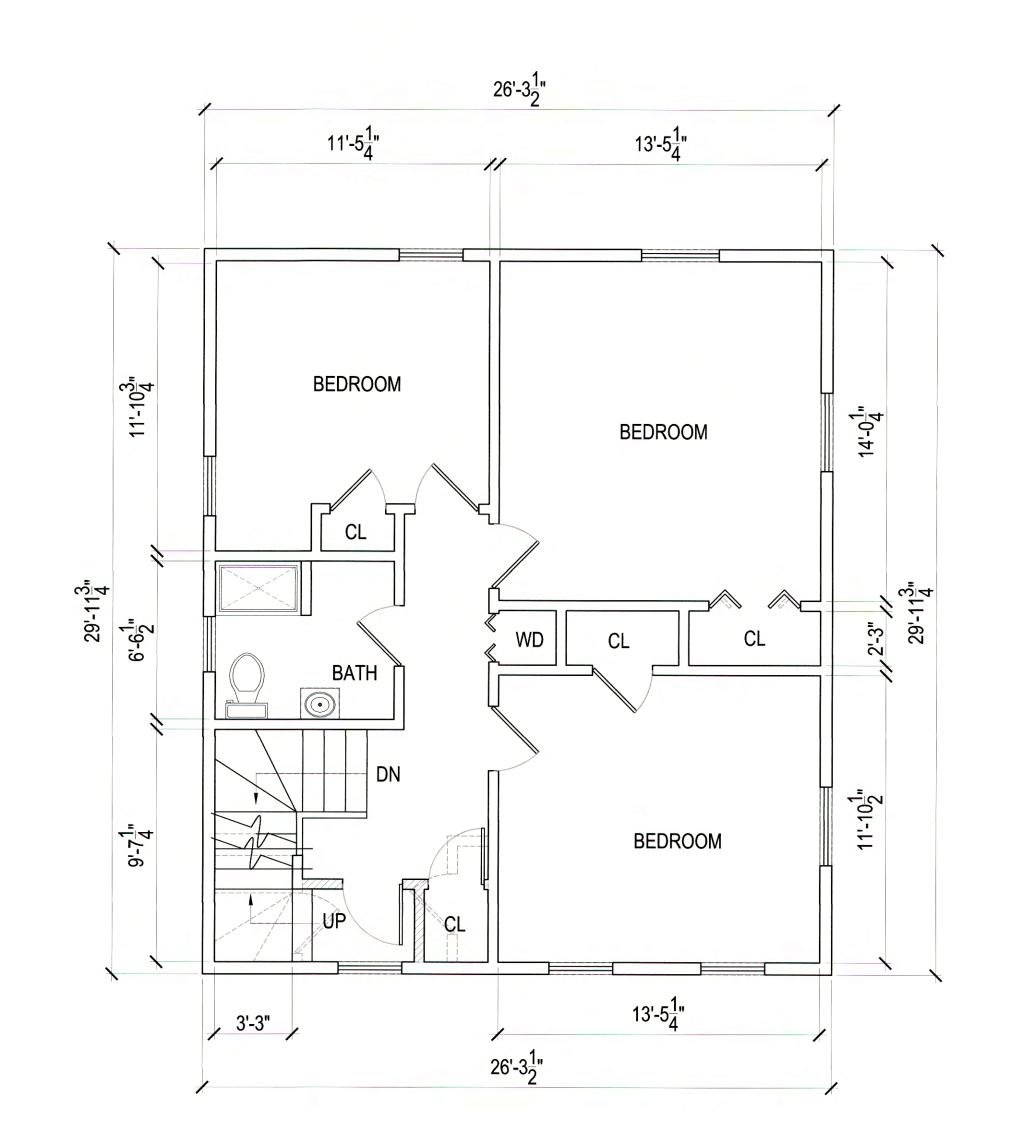HARDWIRED & INTERCONNECTED

James Neal 6 Butler Street Dorchester, MA 02122

PROJECT #

DATE: 5-30-17 SCALE:

1/4" = 1'-0"DRAWN BY:

CHECKED BY:

PROPOSED ROOF PLAN AND BUILDING SECTION

GENERAL NOTE:

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NEW ROOFING NOTES

PROVIDE NEW SHINGLE ROOFING SYSTEM OVER ENTIRE BUILDING ROOF SHEATHING TO INCLUDE THE FOLLOWING:

NEW FELT UNDERLAYMENT: 15 LB BUILDING FELT, ASTM D 226. INSTALL AT ALL AREAS NOT COVERED BY ICE AND WATERSHIELD.


NEW ICE AND WATER SHIELD: BITUTHANE ICE AND WATERSHIELD BY W.R. GRACE. APPLY 3'-0" WIDE AT RAKE EDGE, RIDGE AND VALLEYS. PROVIDE TWO LAYERS OF 3'-0" WIDE PRODUCT AT ROOF EAVE. OVERLAP TO SHED WATER.

NEW ASPHALT SHINGLE ROOFING: LANDMARK SERIES BY CERTAINTEED. COLOR TO BE SELECTED BY OWNER.

PAINTED ALUMINUM FLASHING: PROVIDE NEW PAINTED ALUMINUM ROOF EDGE TRIM, STEP FLASHING, GUTTERS AND DOWNSPOUTS. INSTALL ROOFING AND FLASHING IN ACCORDANCE WITH THE NRCA ROOFING MANUAL, CHAPTER 6 FOR ASPHALT SLOPED ROOF SYSTEM.

HANGING GUTTERS SHALL BE 6" WIDE SEAMLESS REFINISHED ALUMINUM. PROVIDE FOR THERMAL EXPANSION. ATTACH GUTTERS TO EAVE OR FASCIA WITH FIRMLY ANCHORED STRAPS NOT MORE THAN 36" APART. PROVIDE NED CLOSURE AND SEAL WATER TIGHT WITH SEALANT. SLOPE GUTTERS TO DOWNSPOUTS. DO NOT PAINT GUTTERS IN THE FIELDS. INSTALL CONTINUOUS GUTTER SCREEN ON GUTTERS WITH REMOVABLE NON-CORROSIVE FASTENERS. PROVIDE SPLASH GUARD TO PREVENT CORNER SPLASHING.


DOWNSPOUTS SHALL BE 4 X 5 PREFINISHED ALUMINUM. JOIN SECTION WITH 1-1/2" TELESCOPING JOINTS. PROVIDE HANGERS WITH FASTENERS DESIGN TO HOLD DOWNSPOUTS SECURELY TO WALLS AT TOP AND BOTTOM AND 60" O.C. MAXIMUM. DO NOT PAINT DOWNSPOUTS IN THE FIELD.

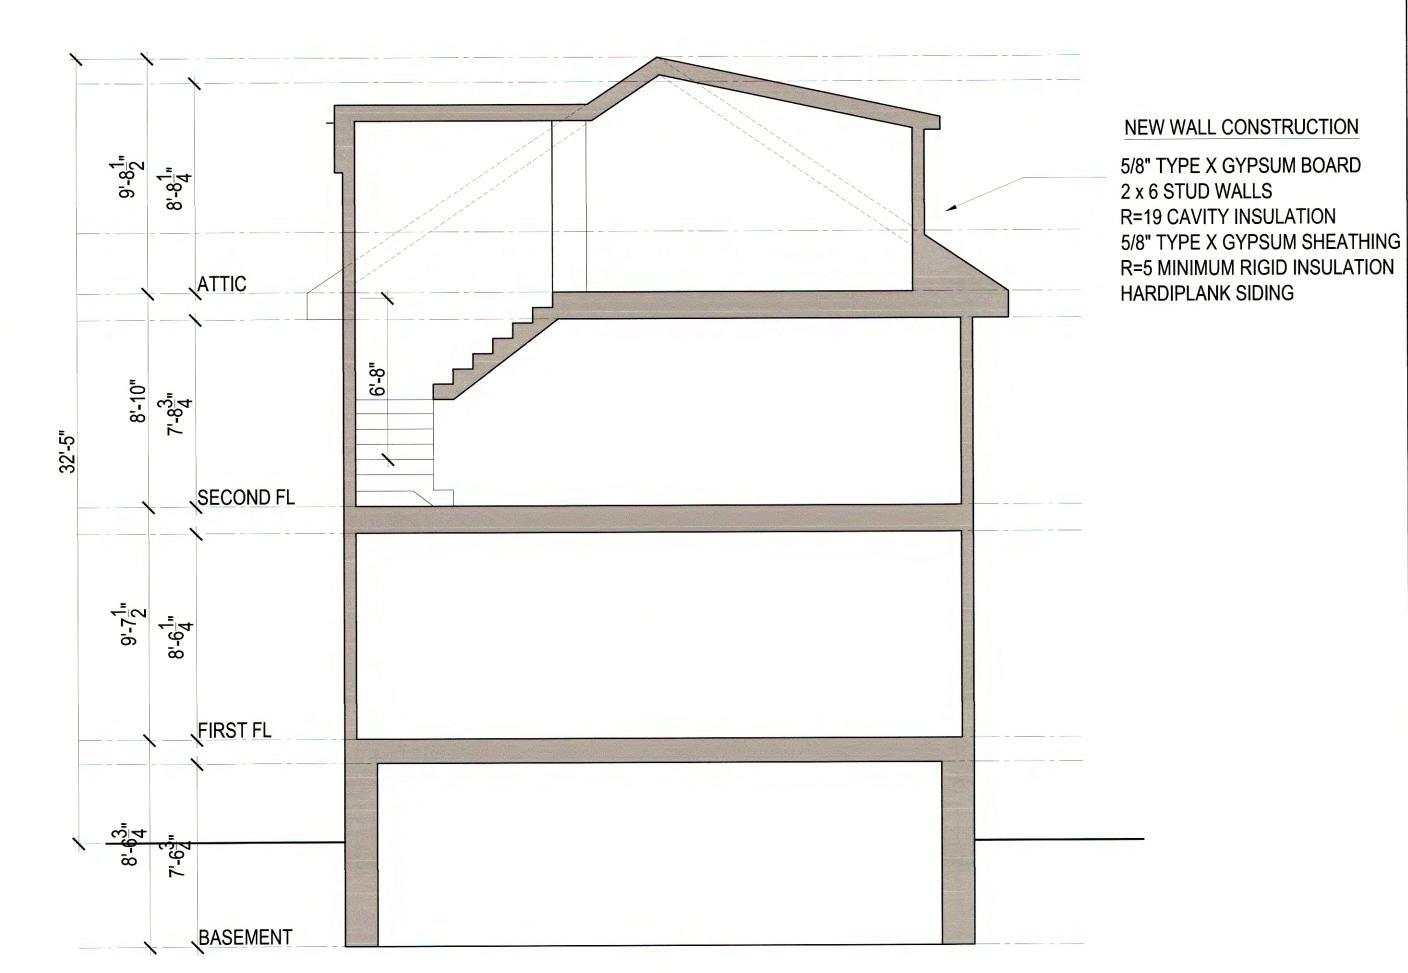

BUILDING SECTION A

ROOF PLAN

A

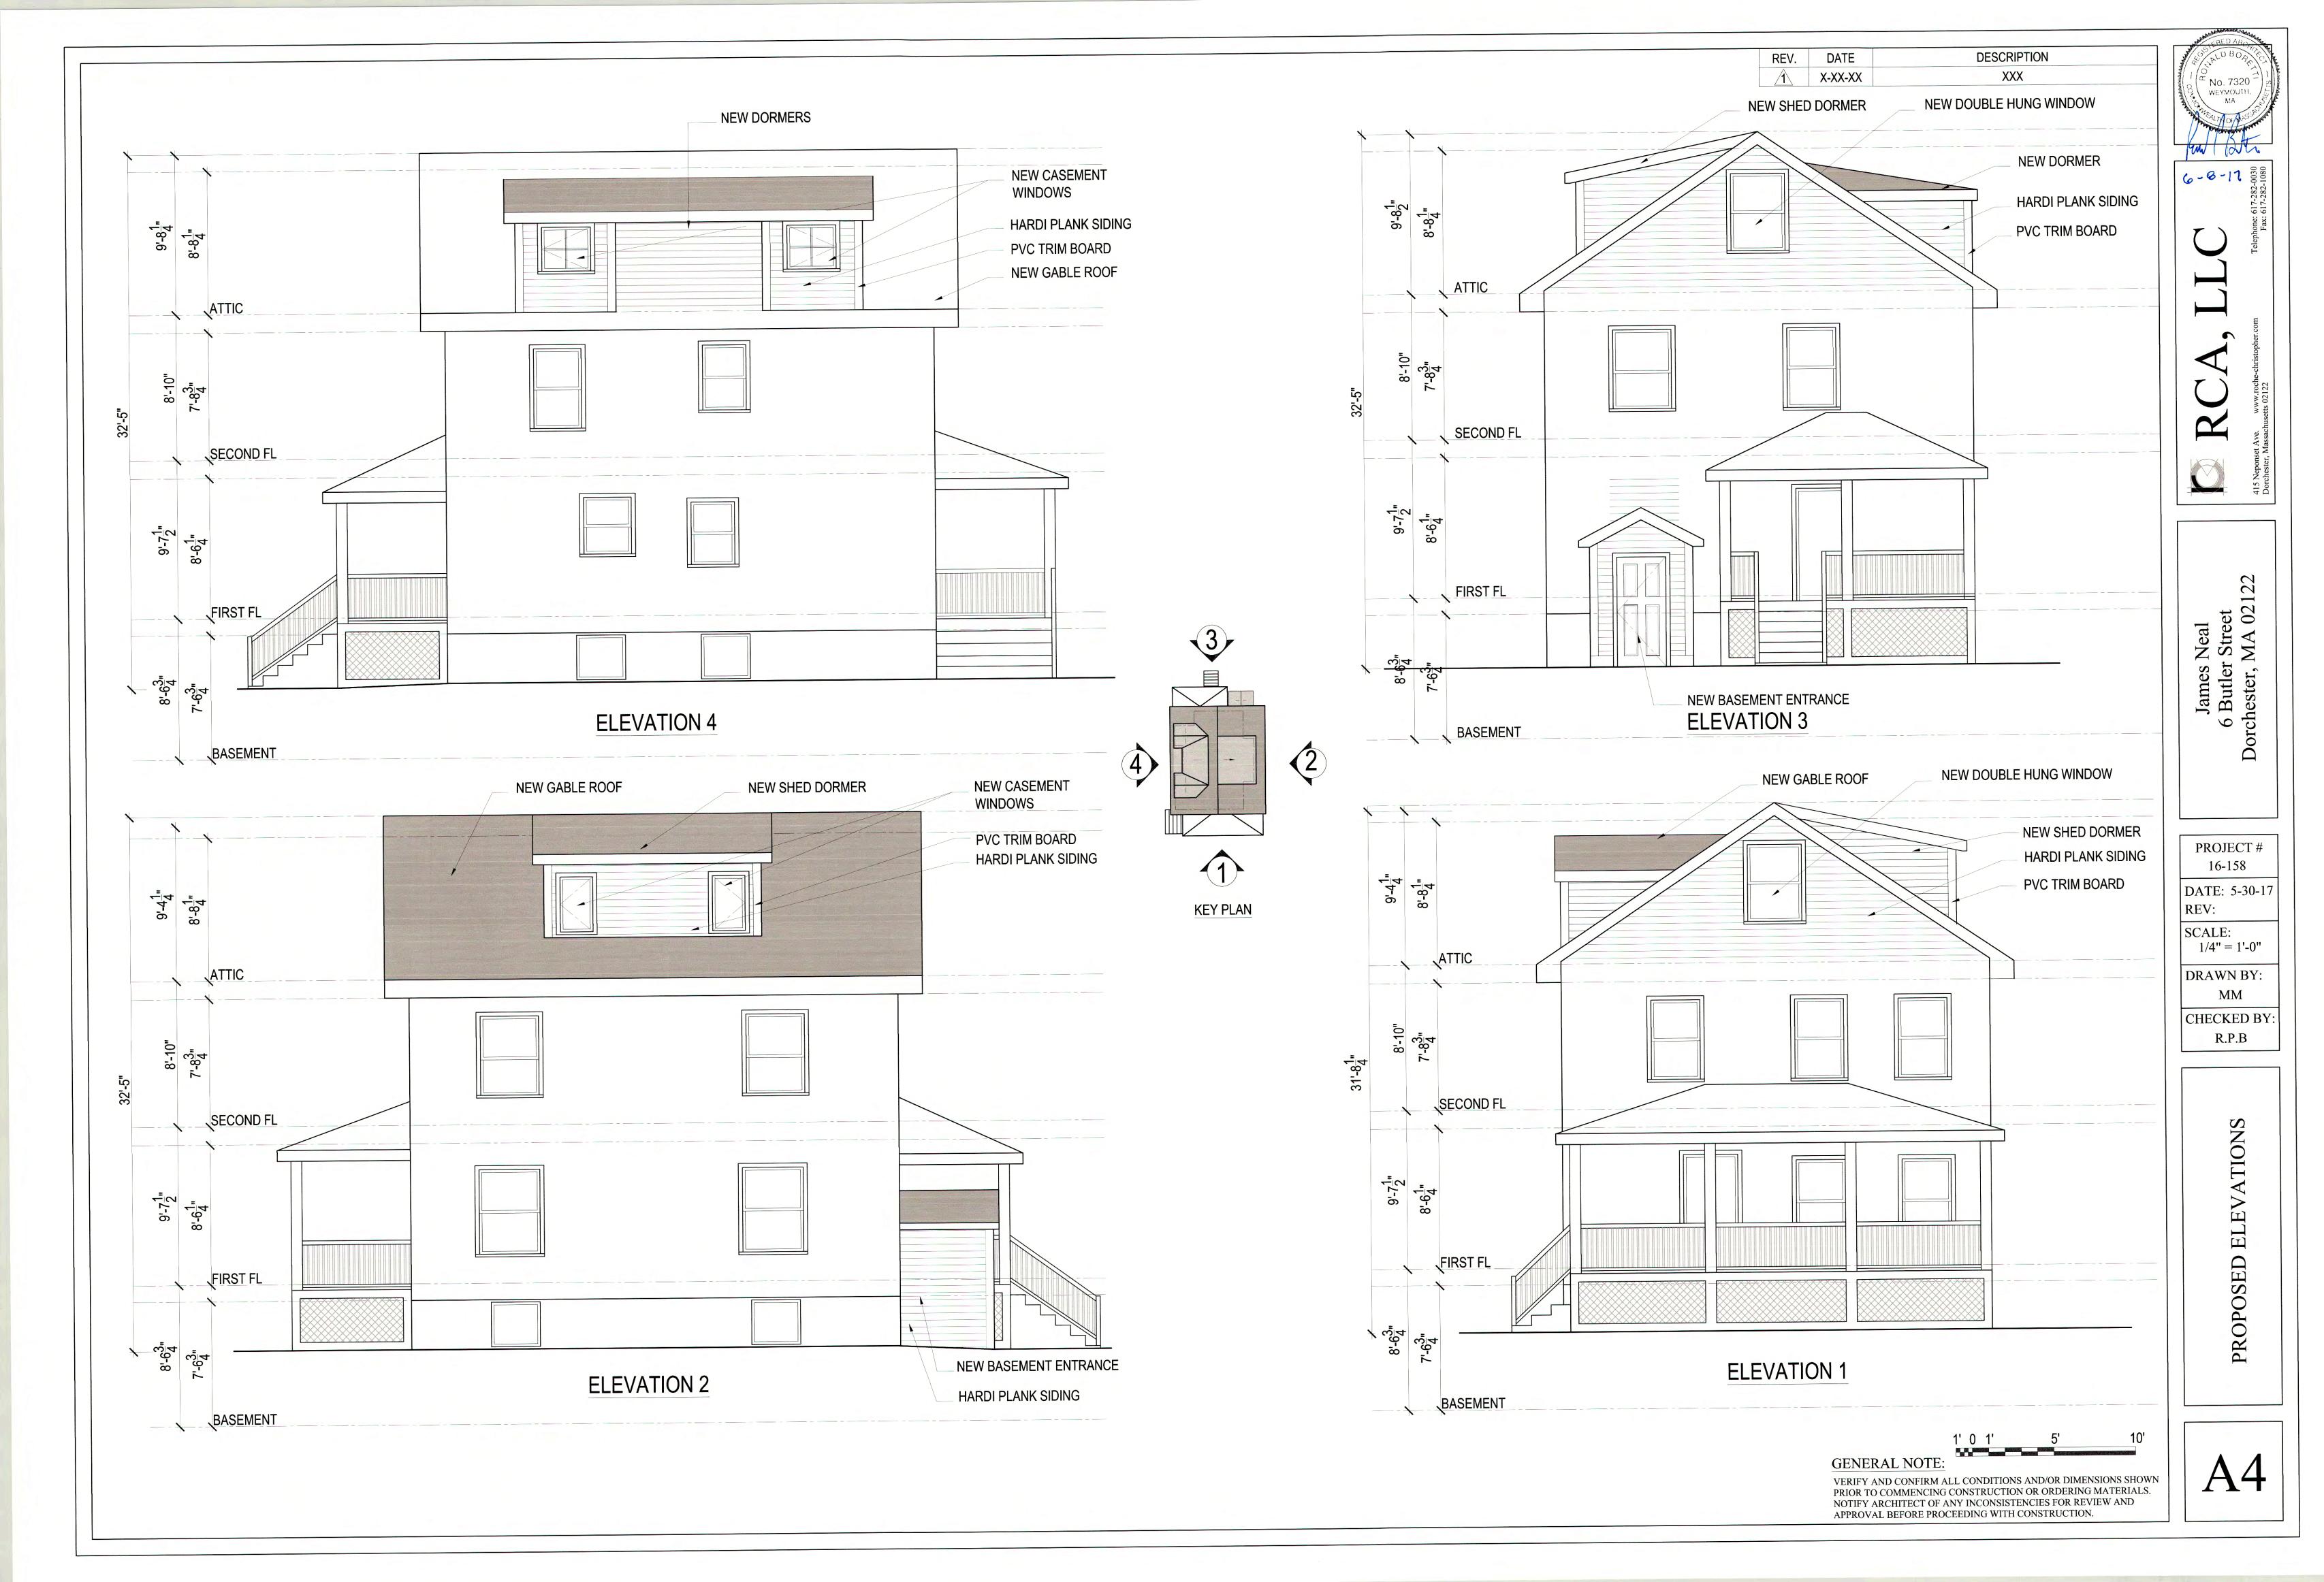


REV. DATE DESCRIPTION XXX

EVAN L, HANKIN No. 28679

> Evan Harkin, P.E. Structural Engineer


NOTE:

 $.\frac{3}{4}$ " PLYWOOD SHEATHING GLUED & SCREWED

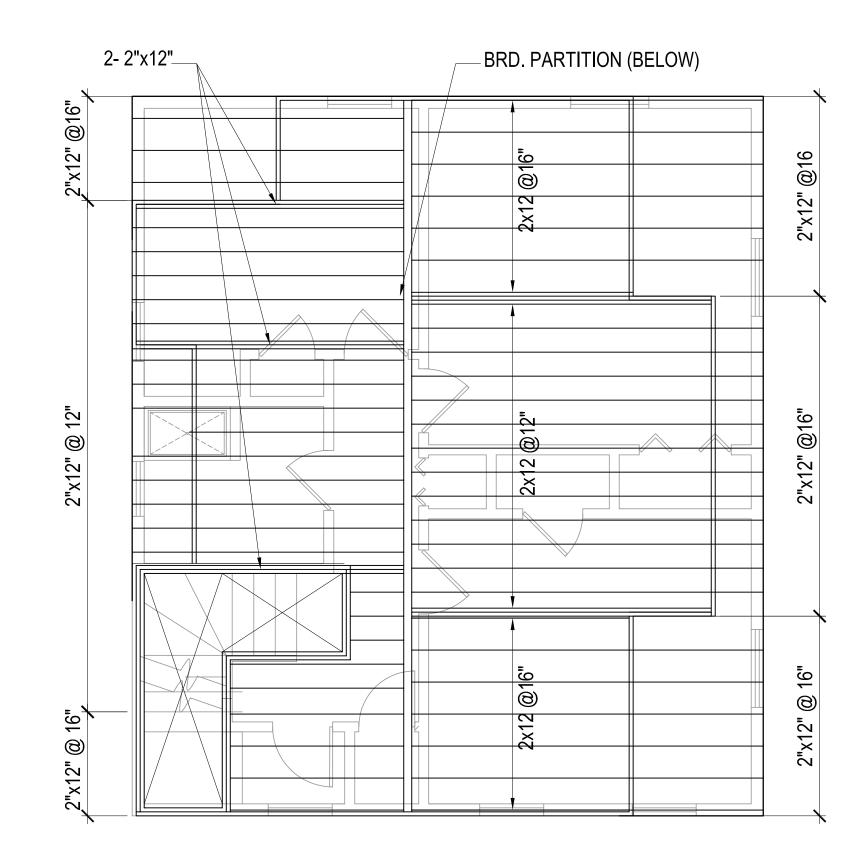

ATTIC FRAMMING PLAN

NOTE: . 5/8" PLYWOOD SHEATHING . HURRICAN TILES @ EACH RAFTER

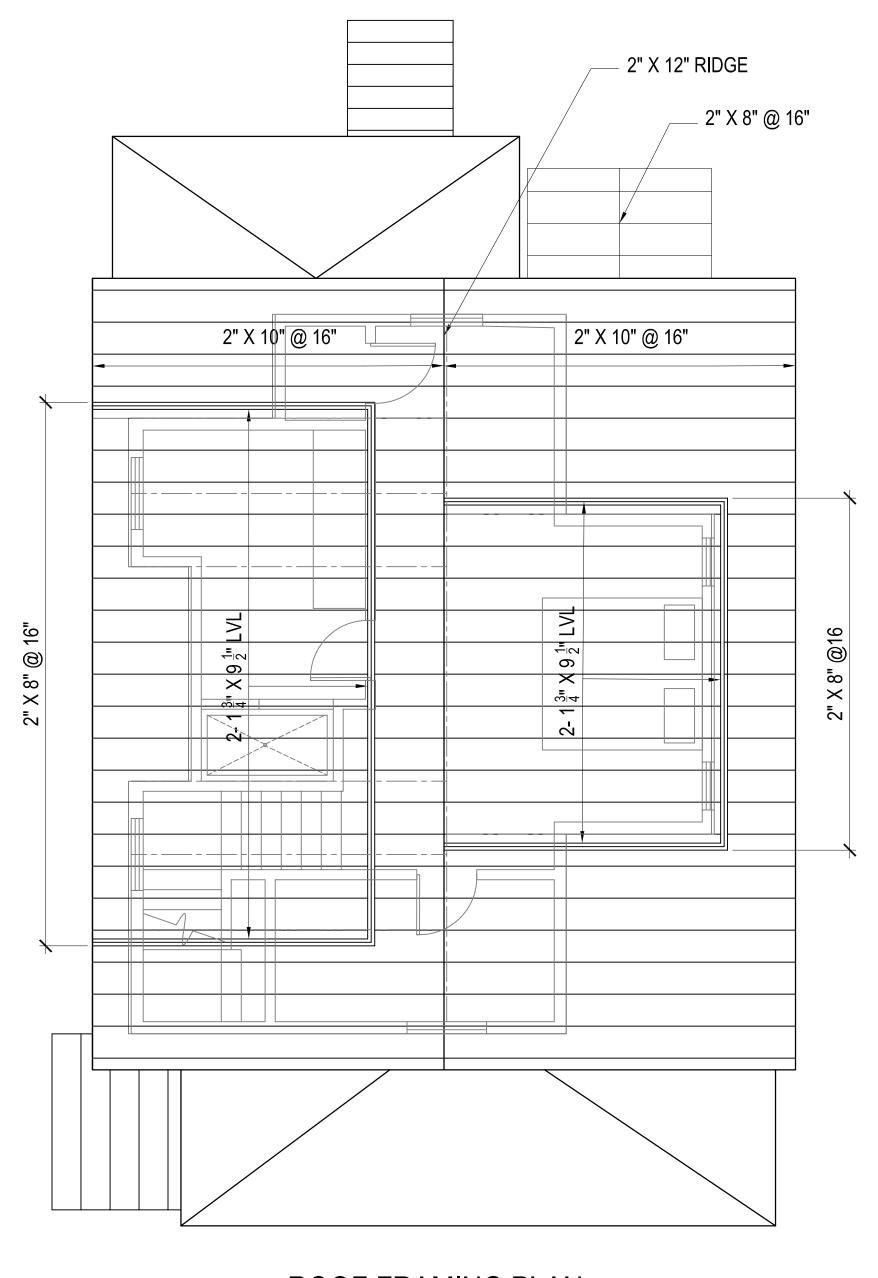

ROOF FRAMING PLAN

STRUCTURAL NOTES:

- 1. ALL WORK SHALL BE DONE IN ACCORDANCE WITH THE MSBC, 8TH EDITION.
- 2. LOADING: LL = $40 \text{ PSF.: } P_G = 40 \text{ PSF. } (GROUND SNOW).$ V = 100 MPH.
- 3. PROVIDE TEMPORARY SHORING PRIOR TO DEMOLITION.
- 4. MATERIAL:
- A. LUMBER: LVL: $F_B = 2,600 \, \text{PSI}$; $E = 2.0 \, \text{X} \, 10^6 \, \text{PSI}$ POSTS: PSL WOOD: HEM-FIR NO.1 & BTR. JOISTS: TJI SERIES OR APPROVED EQUAL
- B. METAL CONNECTORS: SIMPSON OR APPROVED EQUAL

nes Neal tler Street er, MA 0212

PROJECT # 16-158

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1/4" = 1'-0"

DRAWN BY:

MM
CHECKED BY:

CHECKED E E.H.

ROPOSED FRAMING

1' 0 1' 5' GENERAL NOTE:

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