# **MORTGAGE INSPECTION PLAN**



05-07889

P.O. Box 290220 Charlestown, MA 02129 (617) 242-1313 MAIN (617) 242-1616 FAX

APPLICANT: LOCATION:


PINA

18 LINCOLN STREET CITY, STATE: HYDE PARK, MA

DEED/CERT:

PLAN REF:

36454-92

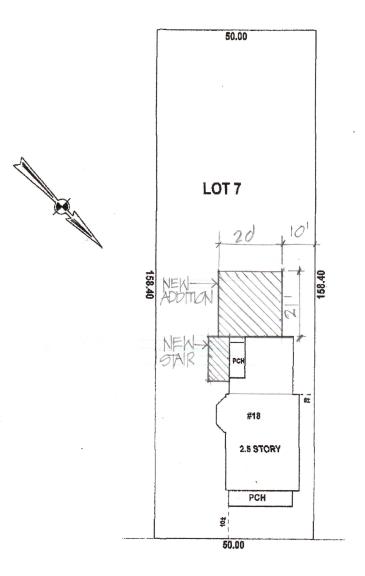

LINCOLN STREET

SCALE: 1 inch = 30 feet 1994 (c) Boston Survey Software CERTIFIED TO: PREPARED: 10-12-2005

The permanent structures are approximately located on the ground as shown. They either conformed to the setback requirements of the local zoning ordinances in effect at the time of construction, or are exempt from violation enforcement action under M.G.L. Title VII, Chapter 40A, Section 7, and that there are no encroachments of major improvements either way across property lines except as shown and noted hereon.

GEOR**G**E COLLINS Effective Date:

According to Federal Emergency Management Agency maps, the major improvements on this property fall in ar

rea designated as Zone. Community Panel No. 250286 0003C

NOTE: Zone C is areas of minimal flooding (no shading). This designation is not based on an elevation certificate.

NOTE: This is not a boundary or title insurance survey. This plan was preparation to procedural and technical standards for Mortgage Loan Inspections as adopted by the Massachusetts Board of Registration of professional engineers and land surveyors, 250 CMR 6.05, and use for any other purpose is prohibited. This plan is not to be used for recording, preparing deed descriptions, or construction.













# Proiec

# 18 LINCOLN STREET

# **Proposed Renovations and New Rear Addition**

18 Lincoln Street, Hyde Park, MA 02136

# **DRAWINGS LIST**

COVER

PLOT PLAN

L1.0 SITE PLAN

EX1 EXISTING BASEMENT & FIRST FLOOR PLANS

EX2 EXISTING SECOND & THIRD FLOOR PLANS

D1.0 BASEMENT & FIRST FLOOR DEMOLITION PLANS

D2.0 SECOND & THIRD FLOOR DEMOLITION PLANS

A1.0 BASEMENT & FIRST FLOOR PLANS

A2.0 SECOND & THIRD FLOOR PLANS

A3.0 ROOF PLAN

A4.0 FINISH SCHEDULE

A5.0 FRONT & RIGHT SIDE ELEVATIONS & WINDOW & DOOR SCHEDULES

A6.0 REAR & LEFT SIDE ELEVATIONS

A7.0 BUILDING SECTIONS & TYPICAL WALL/FLOOR SECTION

S1.0 FIRST & SECOND FLOOR FRAMING PLANS

S2.0 THIRD FLOOR & ROOF FRAMING PLANS

E1.0 BASEMENT & FIRST FLOOR ELECTRICAL PLANS


E2.0 SECOND & THIRD FLOOR ELECTRICAL PLANS


OWNERS: REUDY AND YESENIA PINA

ARCHITECT:

HEZEKIAH PRATT ARCHITECTURE + DESIGN 454 Lowell Avenue, Newton, MA 02460 Tel: 617.320.3749 hezpratt@gmail.com

PERMIT PLANS: 2-2-18

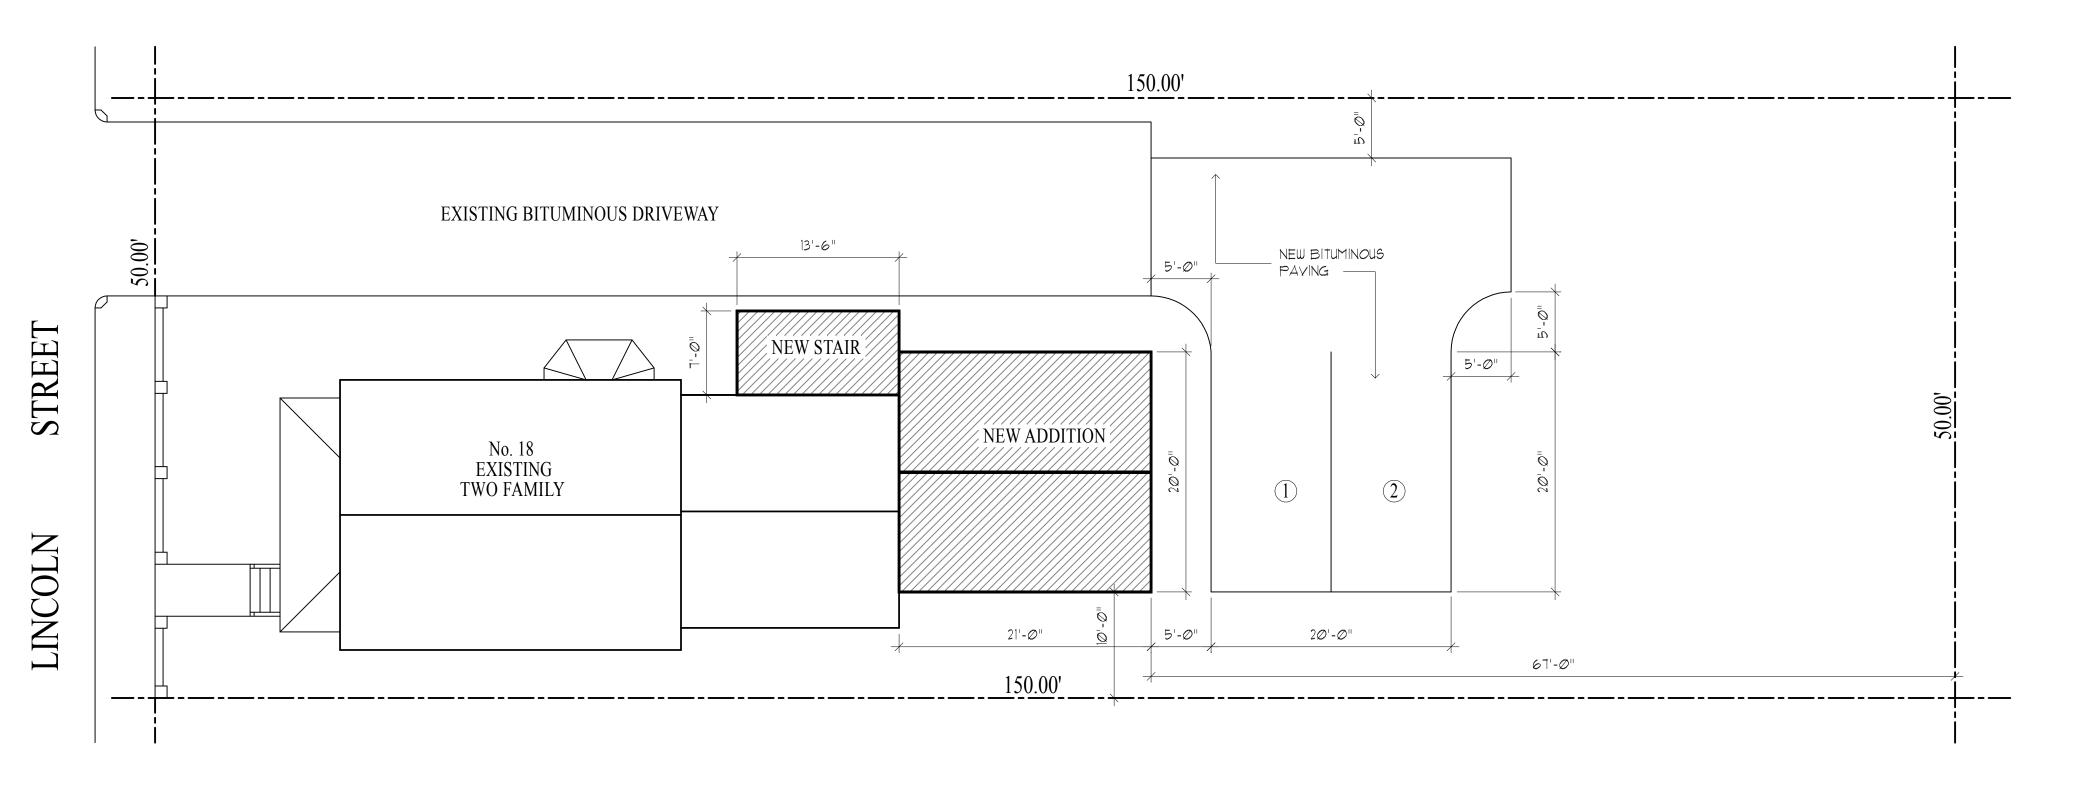

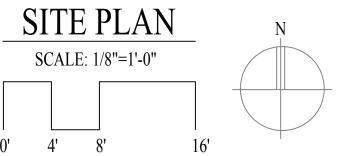

ZONING CODE ANALYSIS	10 I DIGOLN CEDEFE		
PROJECT ADDRESS	18 LINCOLN STREET		
NEIGHBORHOOD	HYDE PARK		
ZONING SUBDISTRICT	2F - 5000		
ZONING ARTICLE	69		
MAP NUMBER	12		
BUILDING USE TYPE	TWO FAMILY		
BUILDING FOOTPRINT			1526 SF
EXISTING GROSS SF			2288 SF
ADDITIONAL GROSS SF			3148 SF
TOTAL PROPOSED GROSS SF			
	REQUIRED	EXISTING	PROPOSED
MINIMUM LOT FRONTAGE	50 FT	50 FT	UNCHANGED
MINIMUM LOT SIZE	5,000 SF	7920 SF	UNCHANGED
MINIMUM LOT WIDTH	50 FT	50 FT	UNCHANGED
HEIGHT LIMITATIONS	2 1/2 STORIES, 35 FEET	35 FT	UNCHANGED
MAXIMUM FLOOR AREA RATIO	.5		.39
OPEN SPACE REQUIREMENTS	3,500 SF		3,880 SF
FRONT YARD SETBACK	20 FT	20 FT	UNCHANGED
SIDE YARD SETBACK-NEW REAR ADDITION	10 FT	50 FT	10 FT
REAR YARD SETBACK-NEW REAR ADDITION	40 FT		67 FT
OFF STREET PARKING	2 SPACES		2 SPACES


Project

18 LINCOLN STREET

Proposed Renovations and New Rear Addition
18 Lincoln Street, Hyde Park, MA 02136

Title:	
SITE PLAN	
Scale:	1/8"=1'-0"
Revisions:	
Drawn by:	BLS
Approved by:	HP
Project No.:	
Date:	2-2-18
Drawing No.:	

L1.0

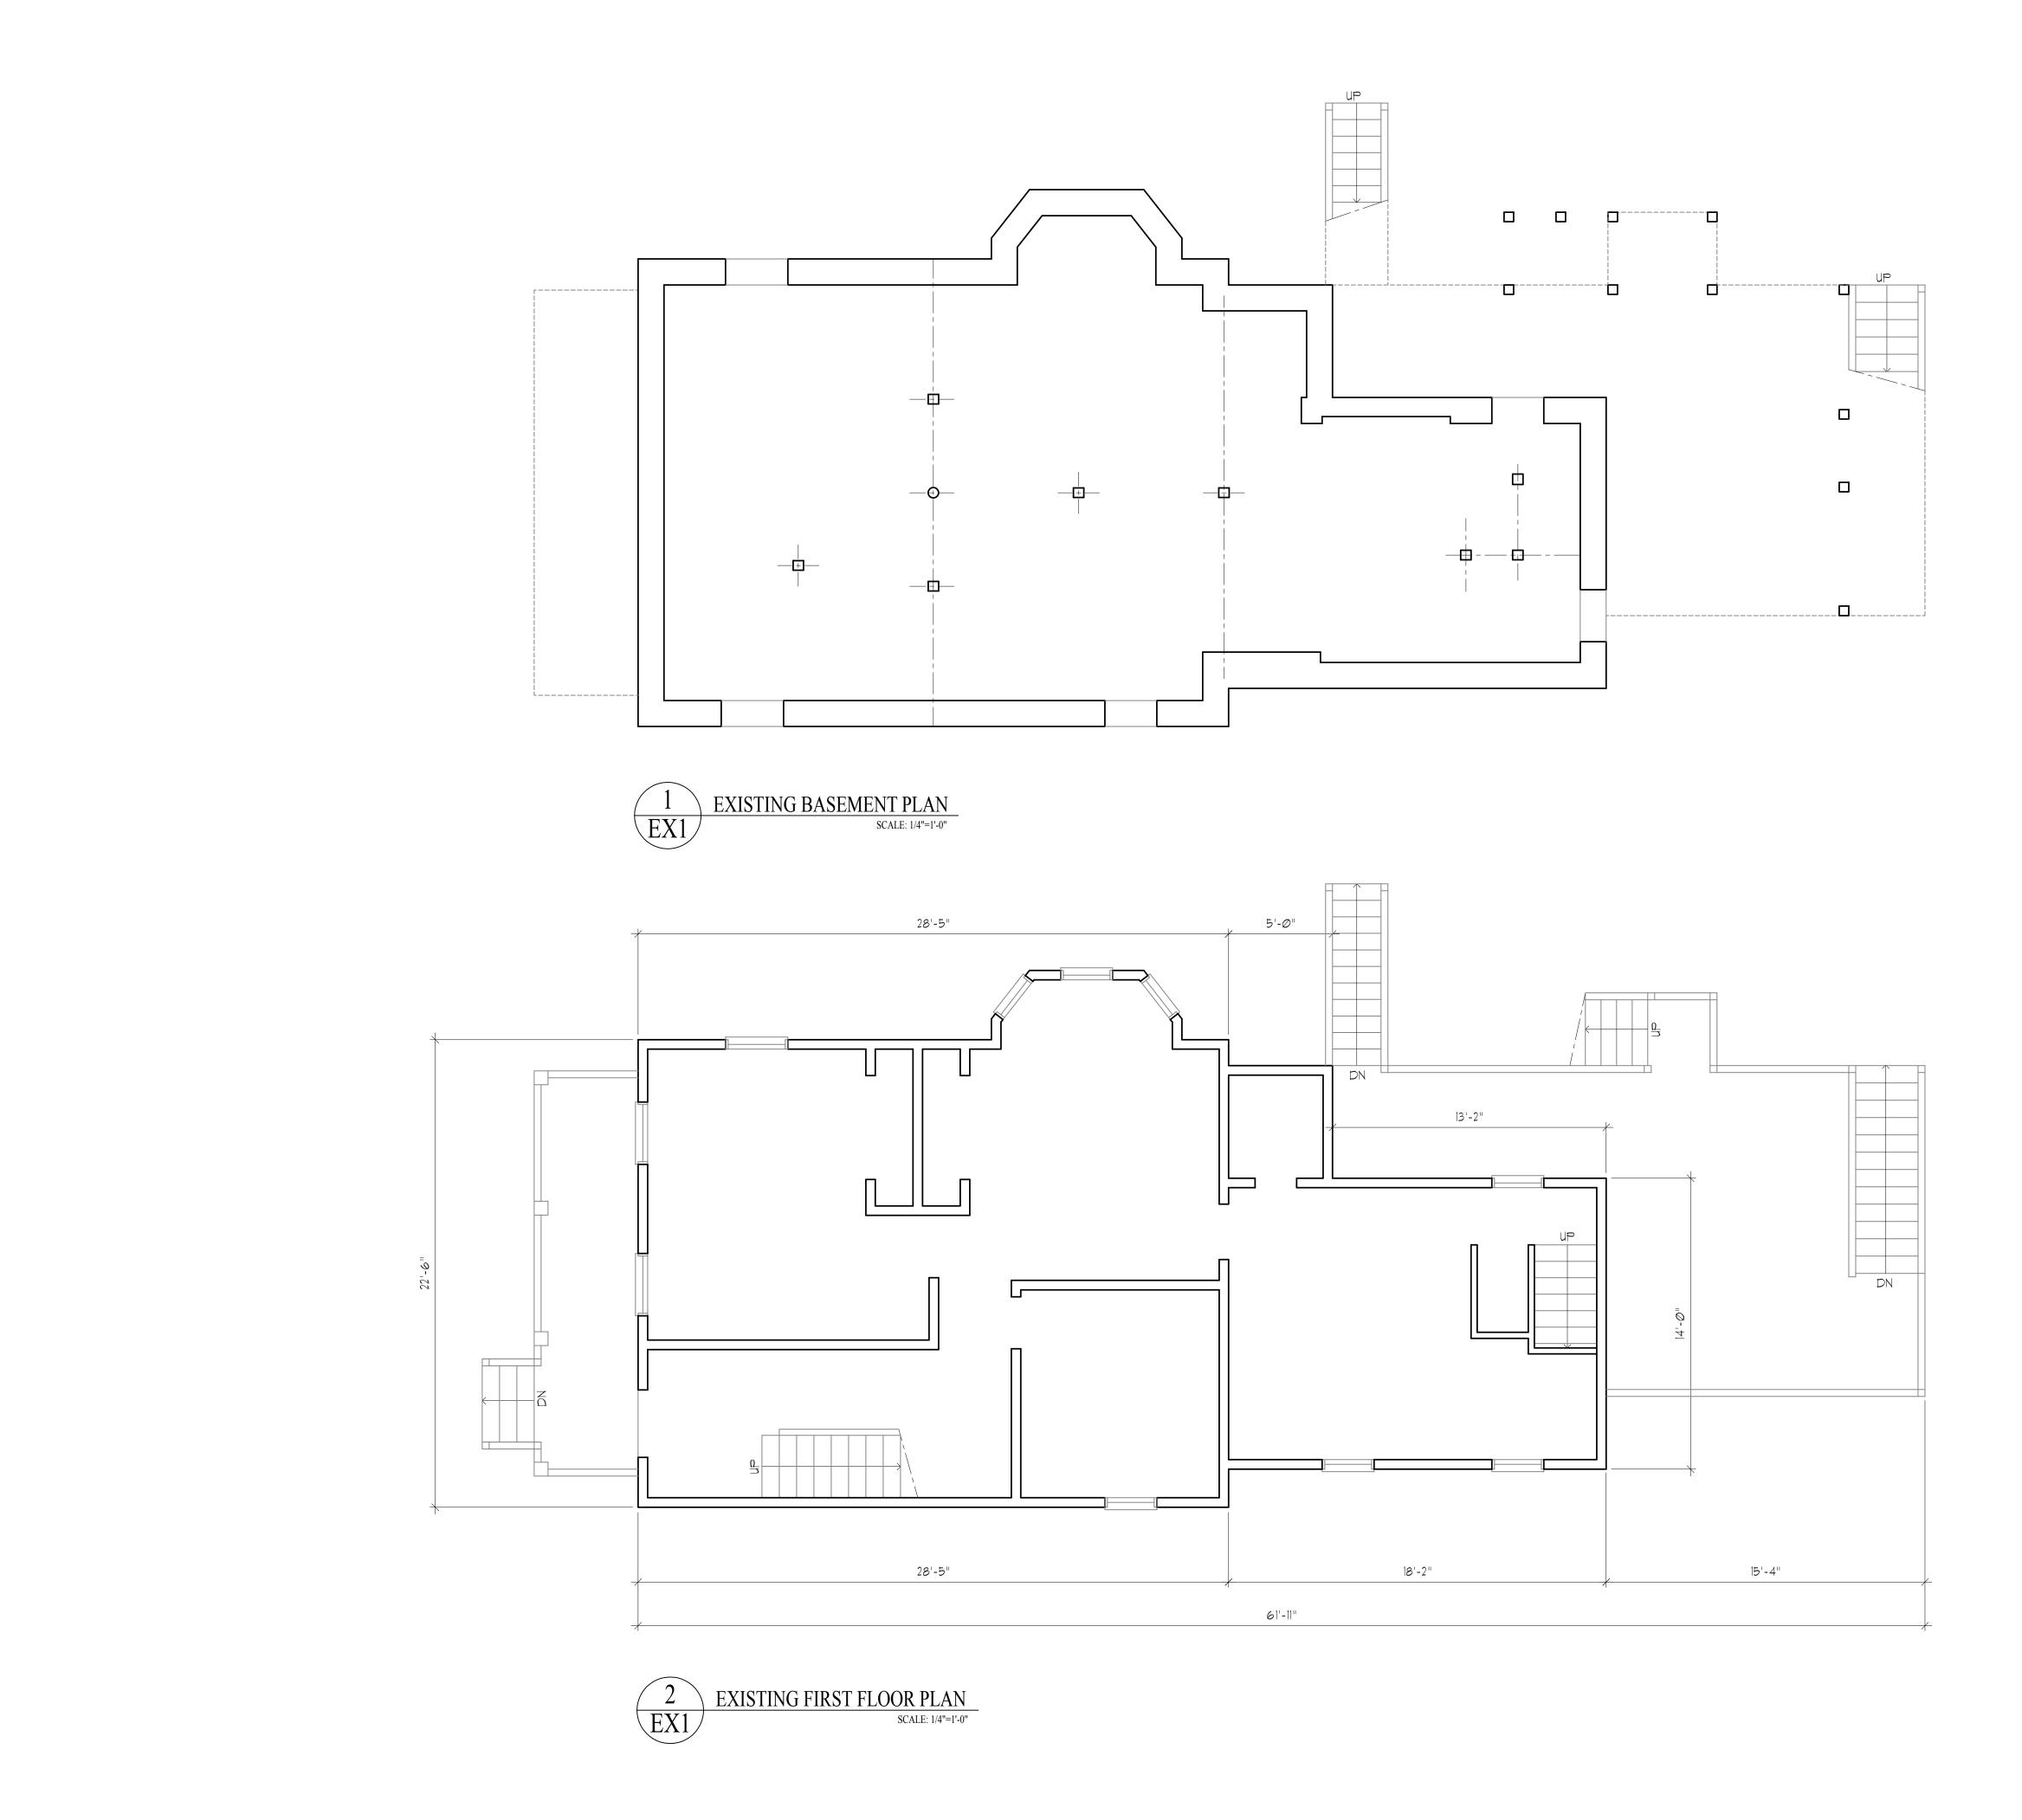

# **EXISTING CONDITIONS**

# Dimensions:

All dimensions, calculations or other data pertaining to the work of all trades shall be carefully checked before manufacture, fabrication or installation of any portion of the work before it is commenced. Any discrepancies discovered shall be reported immediately to the architect for his decision. All work shown on the drawings is intended to be correct according to the scale are made, but figured dimensions and detail drawings are in all cases to be followed. The contractor shall verify all dimensions at the site, regardless of dimensions shown on drawings. He shall be responsible for all work affected by this provision.

Architect
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Project

18 LINCOLN STREET

Proposed Renovations and New Rear Addition
18 Lincoln Street, Hyde Park, MA 02136

Title:

EXISTING BASEMENT & FIRST FLOOR PLANS

Scale: 1/4"=1'-0"

Revisions:

Drawn by: BLS


Approved by: HP


Project No.:

Date: 2-2-18

Drawing No.:

EX1

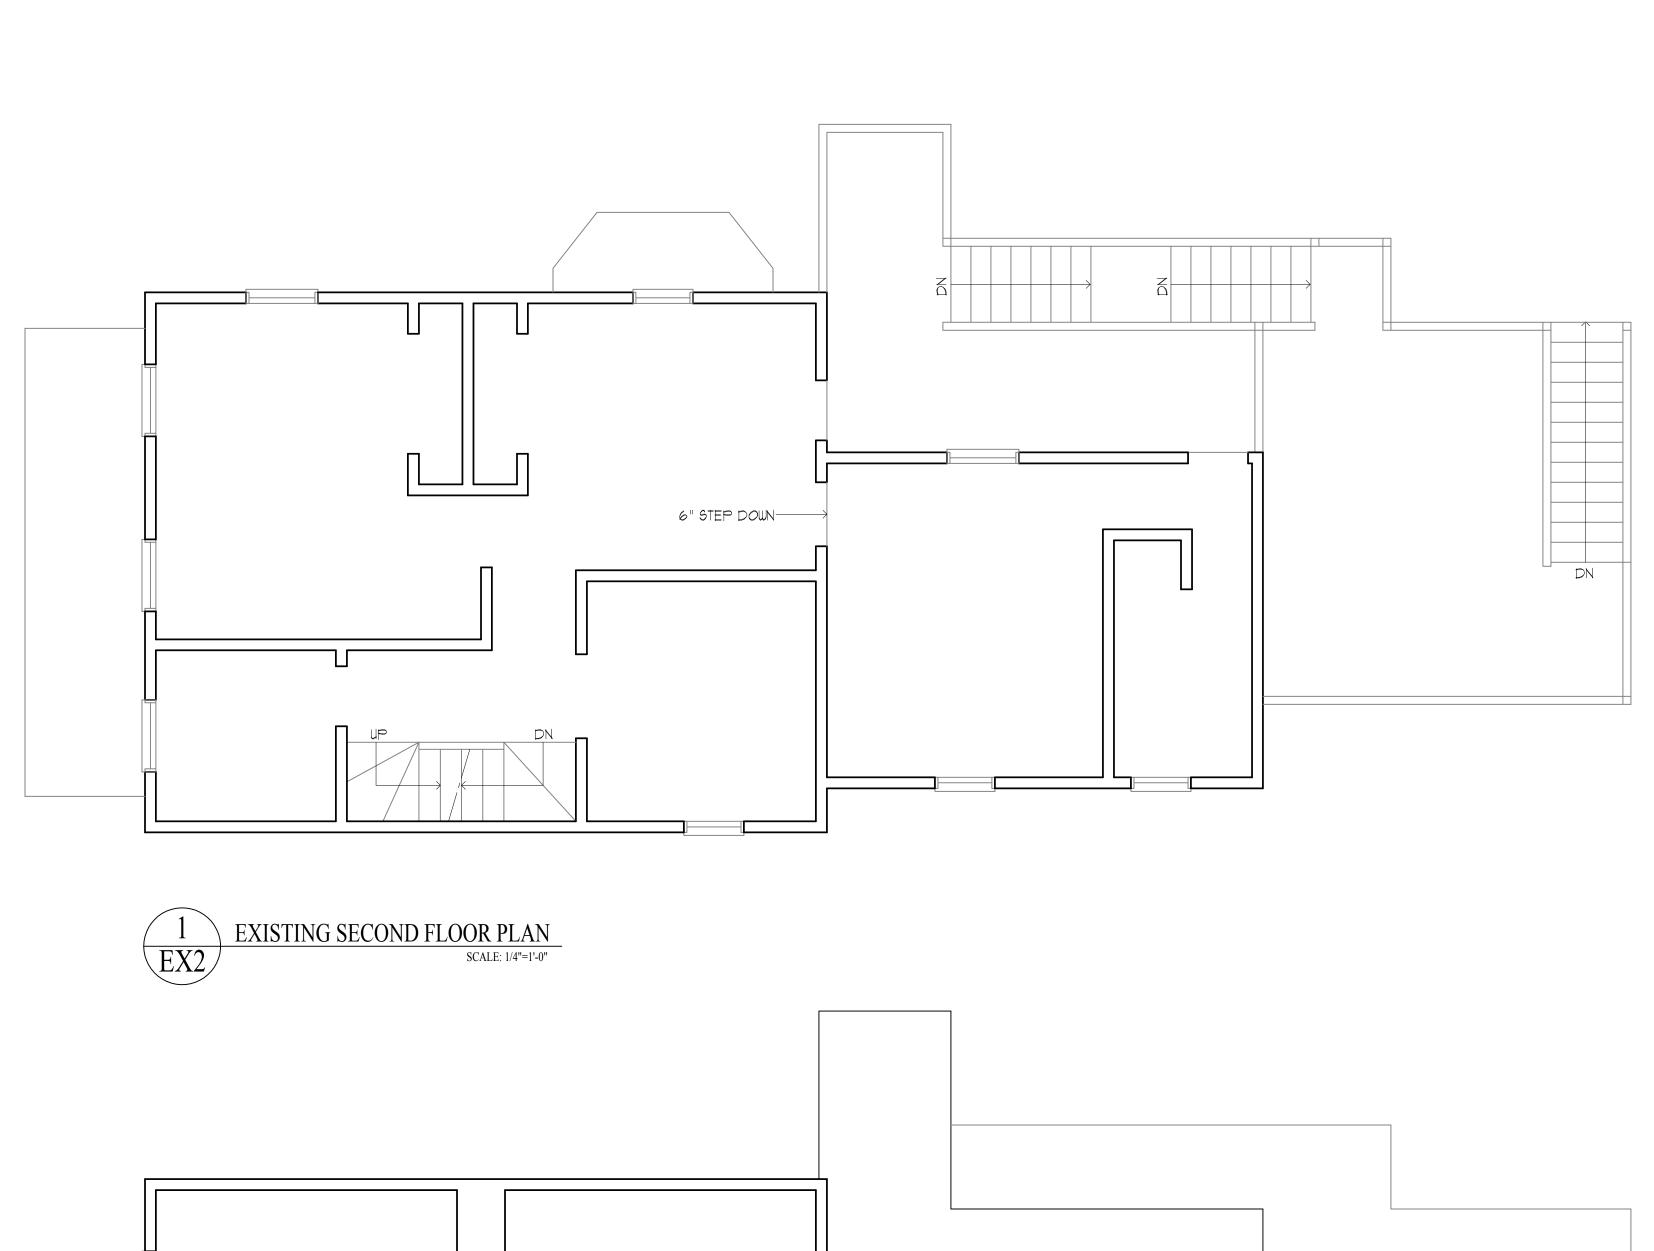

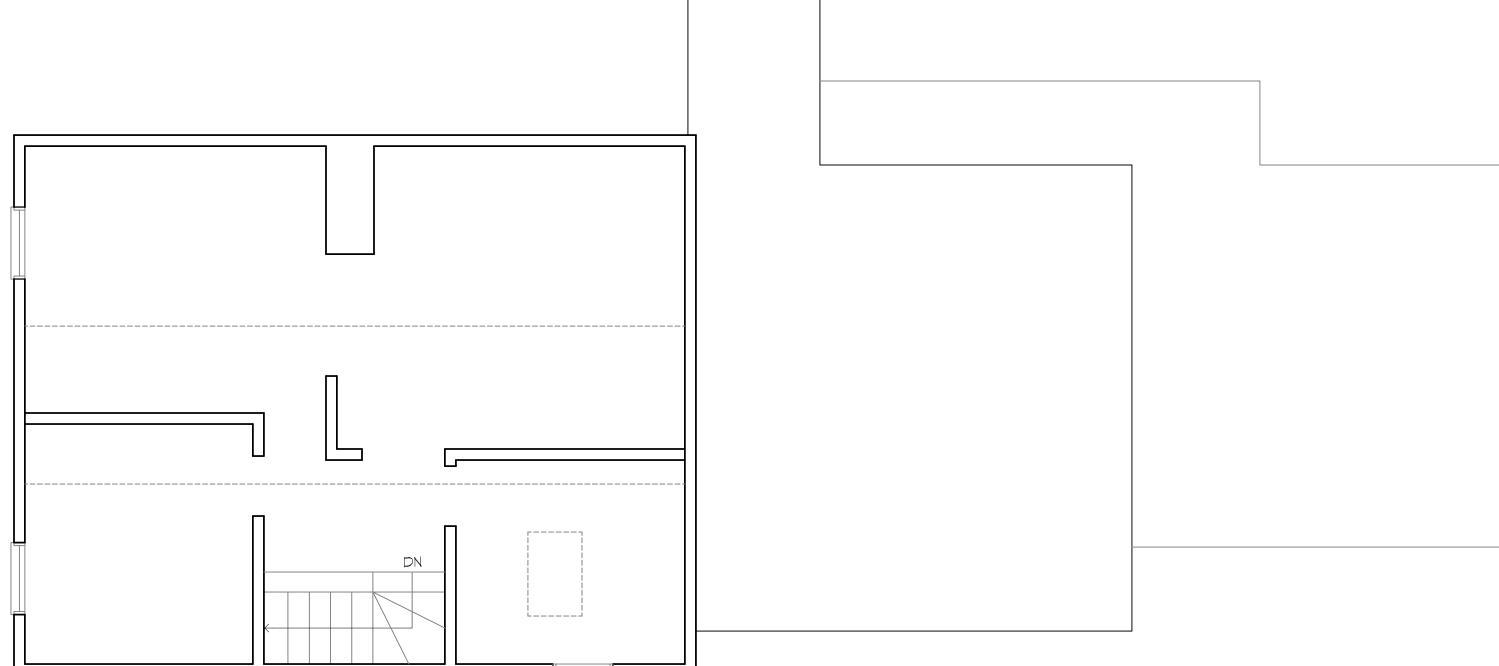




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# EMST NS DECK ABOVE SHALL REHAN NOTE: REMOVE ENTIRE EXISTING DECK AND EXISTING FLOT BALLET REMOVED. THE ENTIRE EXISTENCE EXISTING BASIMENT NOTE: REMOVE ALL EXISTING BASIMENT REMOVE ALL FIRE DAMAGED. G STS. BEDYS ALL FIRE DAMAGED. G STS. BEDYS AND SOLUTION IN THE SAREA

# 1 BASEMENT DEMOLITION PLAN D1.0 SCALE: 1/4"=1'-0"



# PROPOSED RENOVATIONS and NEW REAR ADDITION

## Dimensions:
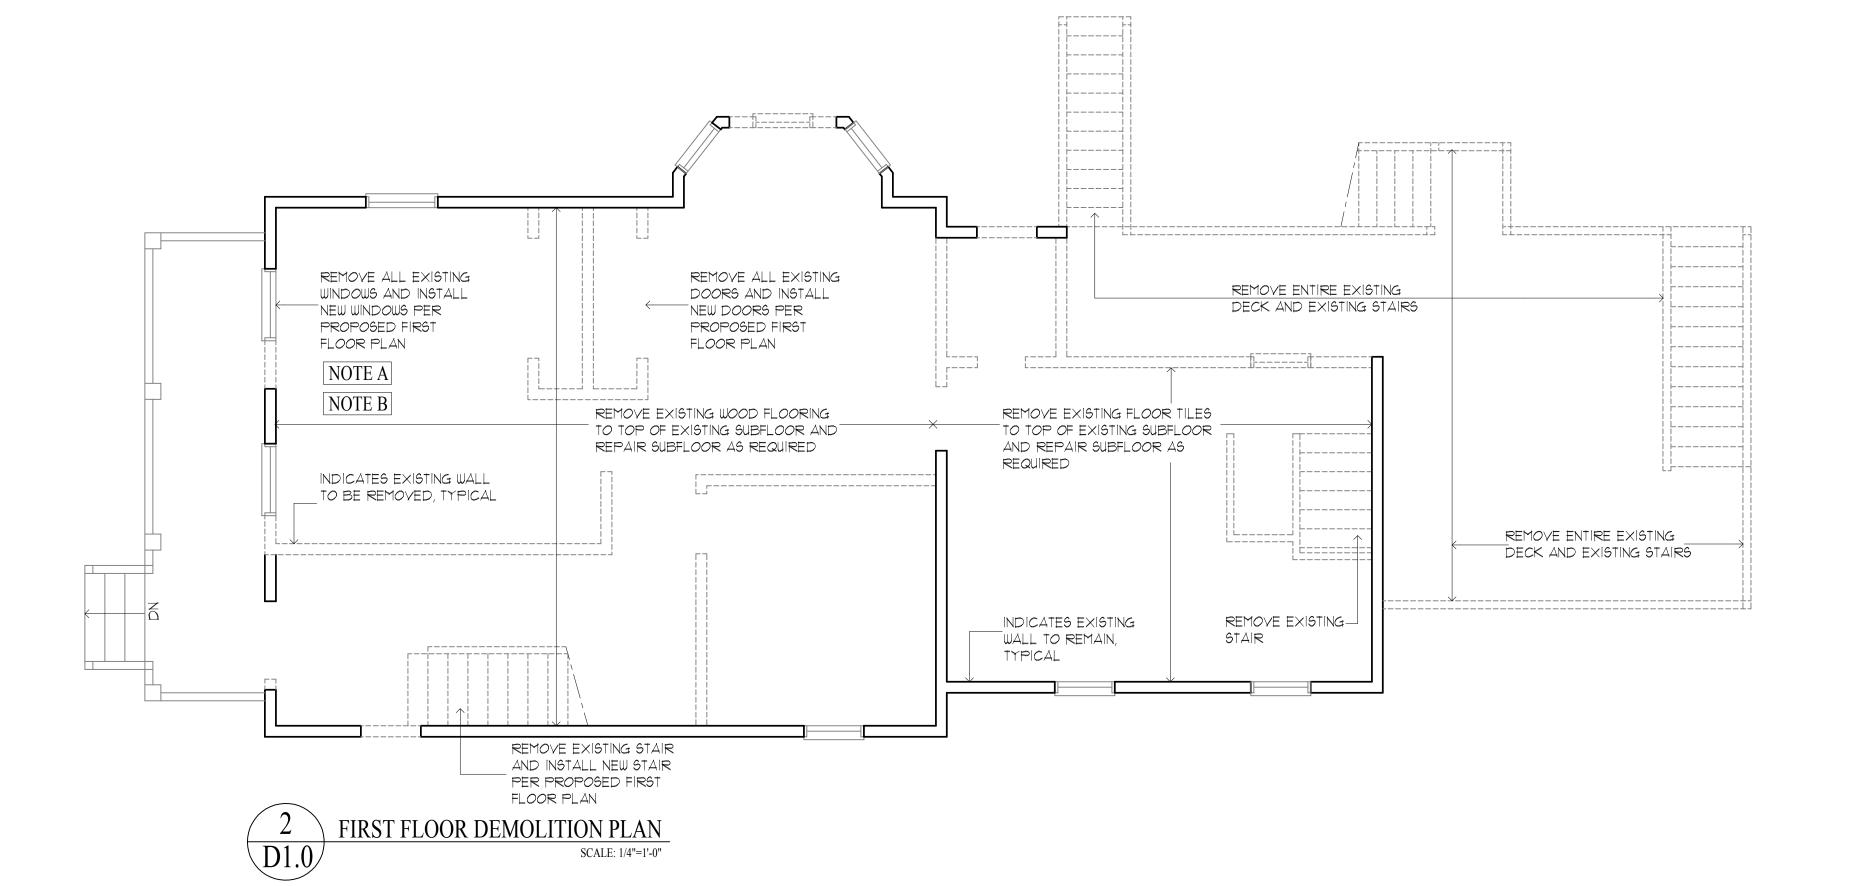
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NOTE

- A. EXCEPT WHERE OTHERWISE NOTED
  OR INDICATED ALL CONDITIONS ARE
  EXISTING AND SHALL REMAIN UNCHANGED
- B. THE BUILDER SHALL VERIFY ALL EXISTING LOAD BEARING WALLS IN THE FIELD AND PROVIDE ADEQUATE SUPPORT AS NECESSARY TO SUPPORT STRUCTURE BEFORE REMOVING ANY WALLS

WALL LEGEND:

EXISTING WALL TO BE REMOVED

EXISTING WALL TO REMAIN

FIRST FLOOR DEMOLITION NOTES:

1. REMOVE ALL EXISTING CEILING STRAPPING TO BOTTOM OF EXISTING JOISTS.

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18 LINCOLN STREET

Proposed Renovations and New Rear Addition
18 Lincoln Street, Hyde Park, MA 02136

Title:	
BASEMENT OF DEMOLITION	& FIRST FLOOR N PLANS
Scale:	1/4"=1'-0"
Revisions:	
Drawn by:	BLS
Approved by:	НР
Project No.:	
Date:	2-2-18
Drawing No.:	
I	

**D1.0** 

# REMOVE ALL EXISTING WINDOWS AND INSTALL NEW WINDOWS PER PROPOSED FIRST FLOOR PLAN REMOVE ALL EXISTING 2X6 FLOOR JOISTS AND BUILD NEW FLOOR FRAMING PER STRUCTURAL DRAWING NOTE A NOTE B EXISTING 6" STEP DOWN EXISTING 6" REMOVE EXISTING STEP DOWN OAK FLOORING REMOVE EXISTING SHEET VINYL FLOORING TO EXISTING SUBFLOOR AND REPAIR DAMAGED SUBFLOOR ! \_ INDICATES EXISTING WALL TO BE REMOVED, TYPICAL AS REQUIRED REMOVE EXISTING WALL INDICATES EXISTING — AND REBUILD AS SHOWN WALL TO REMAIN, TYPICAL ON ELEVATIONS REMOVE EXISTING SHEET VINYL FLOORING TO EXISTING SUBFLOOR AND REPAIR DAMAGED SUBFLOOR AS REQUIRED REMOVE THIS WINDOW \_ AND FRAME OPENING TO MATCH EXISTING REMOVE EXISTING 12×12 - CERAMIC TILE AND EXISTING SECOND FLOOR DEMOLITION PLAN SUBFLOOR REMOVE THIS SECTION OF EXISTING WALL REMOVE ALL EXISTING WINDOWS AND INSTALL NEW WINDOWS PER PROPOSED FIRST FLOOR PLAN REMOVE EXISTING WOOD NOTE A PARQUET FLOORING TO -EXISTING CONDITIONS EXISTING SUBFLOOR NOTE B TO BE REMOVED, TYP. INDICATES EXISTING WALL TO BE REMOVED, TYPICAL INDICATES EXISTING REMOVE ENTIRE GABLE ROOF, WALL TO REMAIN, -JOISTS, COLLAR BEAMS AND TYPICAL REBUILD AS SHOWN ON ELEVATIONS REMOVE EXISTING REMOVE EXISTING OAK ATTIC ACCESS FLOORING TO EXISTING LADDER REMOVE EXISTING SHEET VINYL SUBFL*OOR* FLOORING TO EXISTING SUBFLOOR AND REPAIR DAMAGED SUBFLOOR AS REQUIRED REMOVE EXISTING STAIR REMOVE THIS SECTION\_ - AND INSTALL NEW STAIR OF EXISTING WALL PER PROPOSED PLAN THIRD FLOOR DEMOLITION PLAN SCALE: 1/4"=1'-0"

# PROPOSED RENOVATIONS and NEW REAR ADDITION

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WALL LEGEND:

EXISTING WALL TO BE REMOVED


EXISTING WALL TO REMAIN

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Project

18 LINCOLN STREET
Proposed Renovations and New Rear A
18 Lincoln Street, Hyde Park, MA 0213

SECOND & THIRD FLOOR DEMOLITION PLANS 1/4"=1'-0" Revisions: Drawn by: Approved by: Project No.: 2-2-18 Drawing No.:

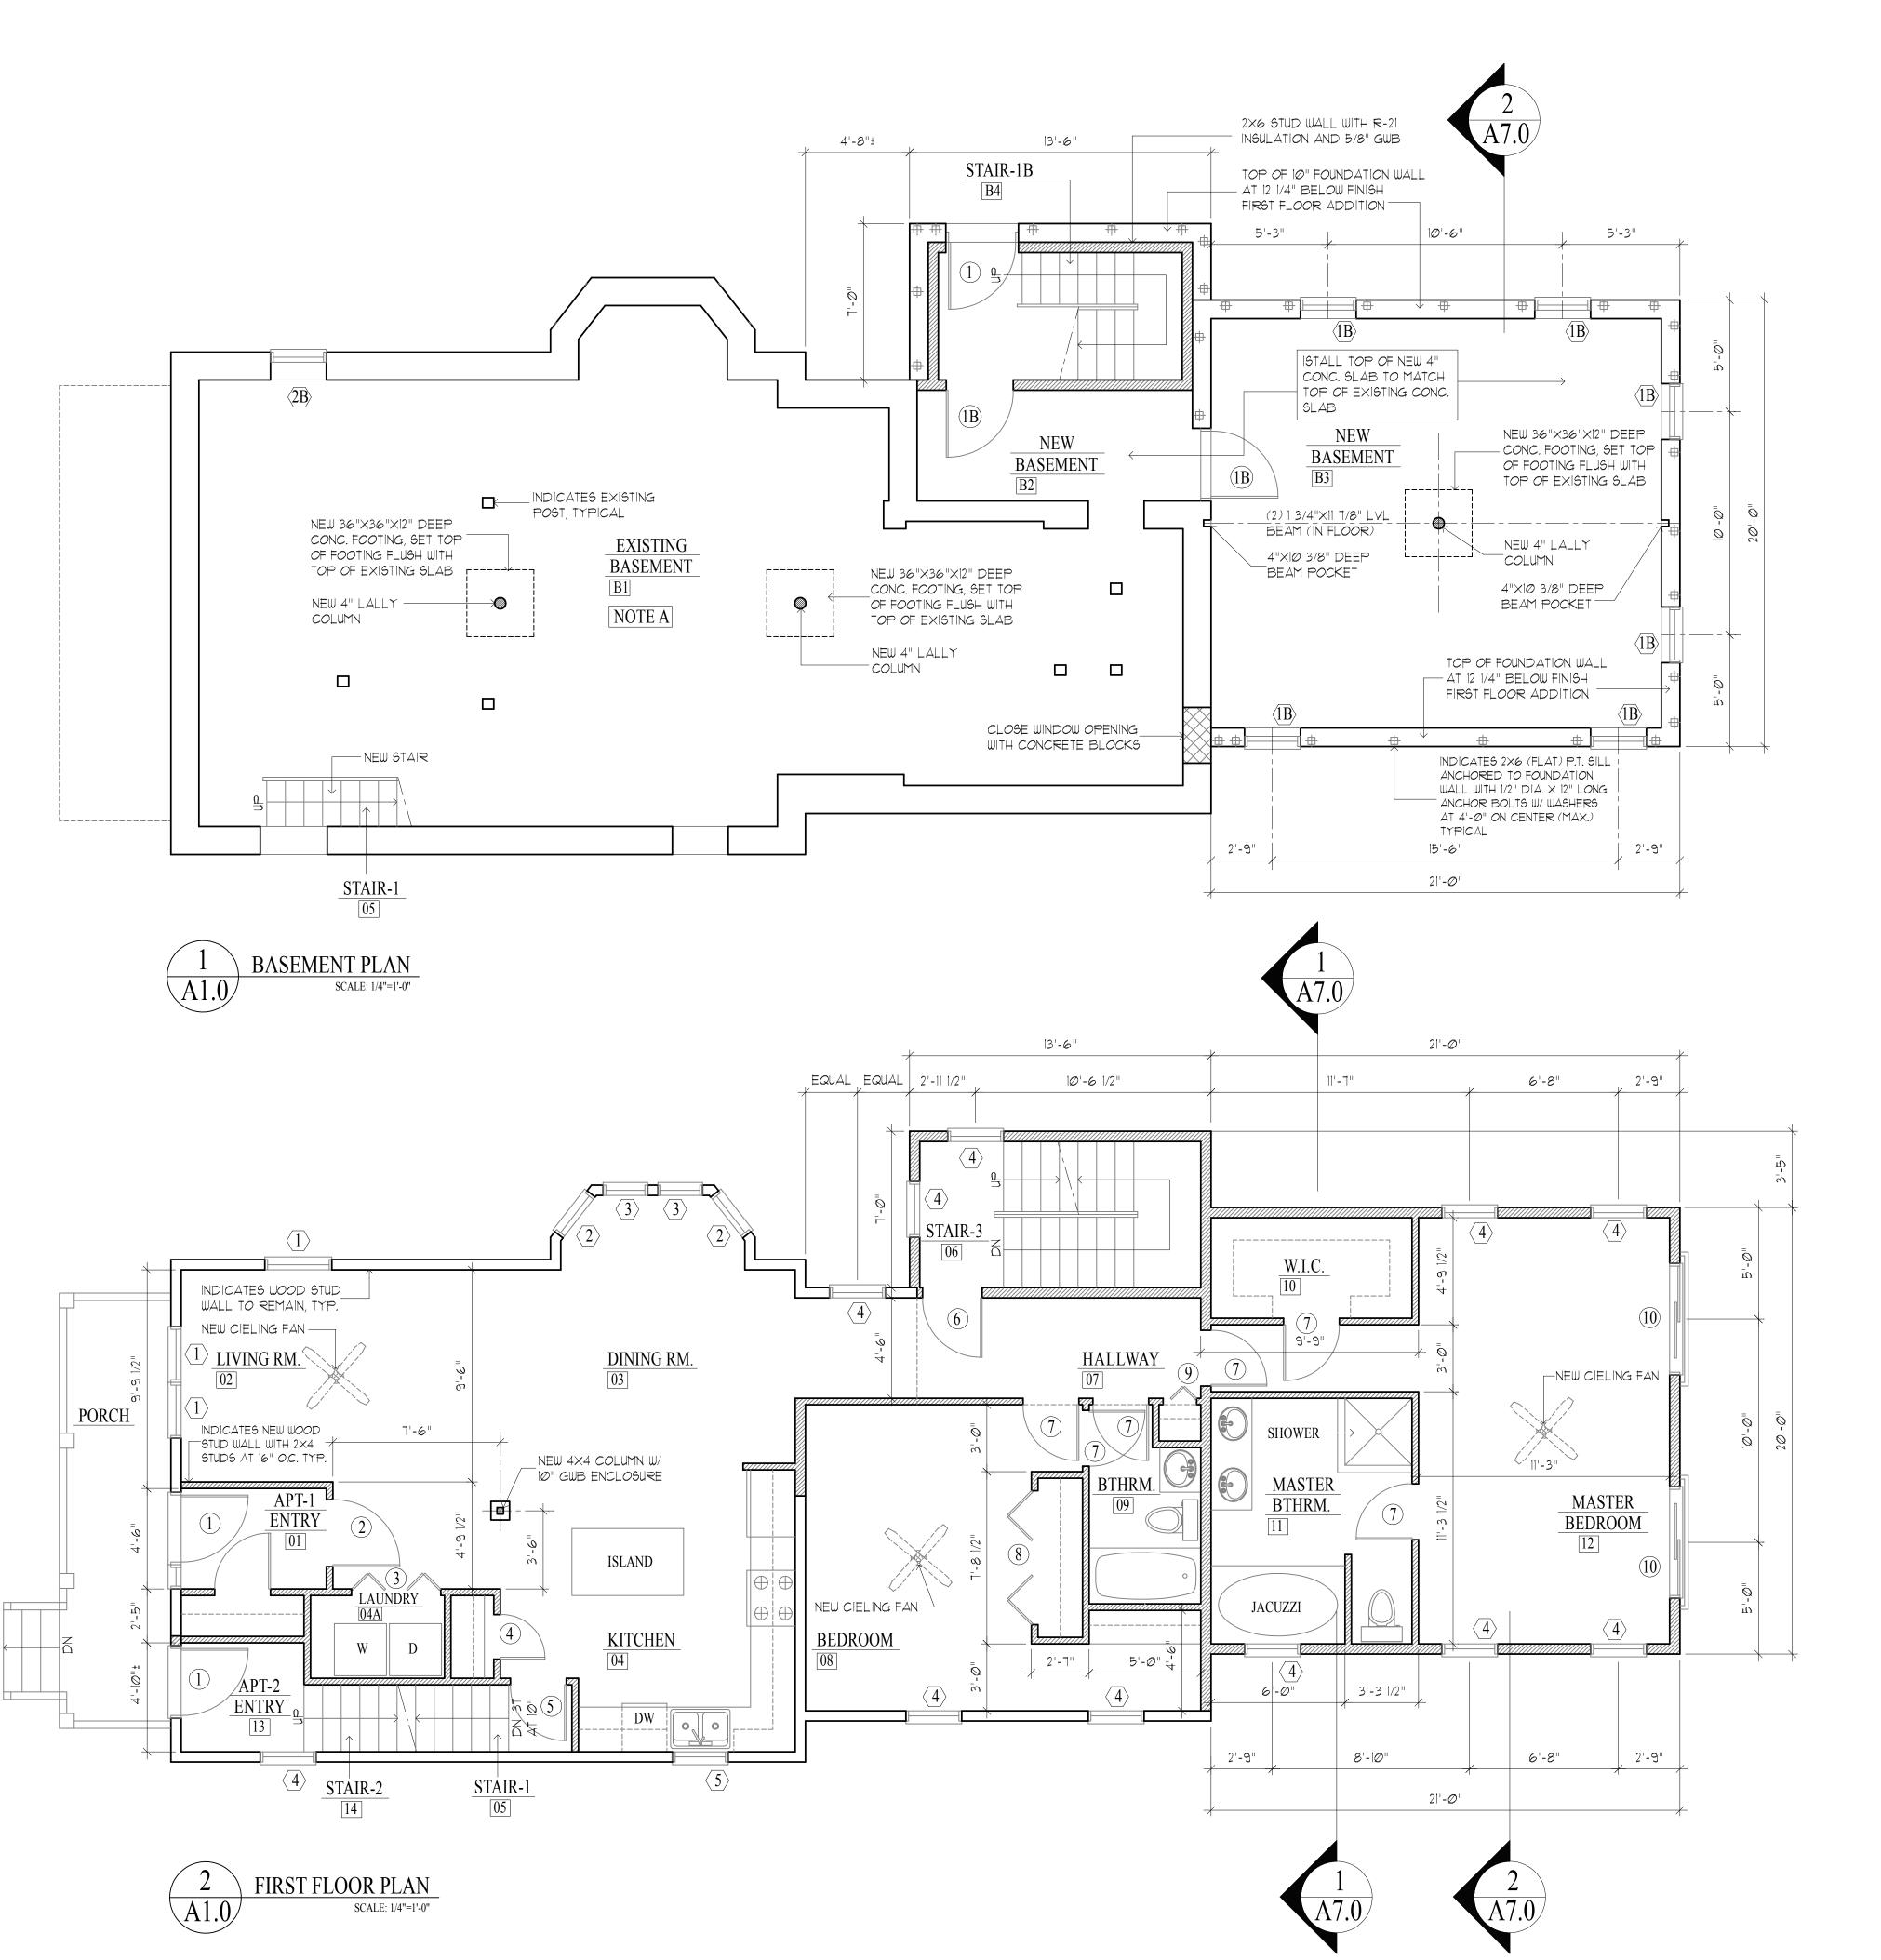

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## WALL LEGEND:

EXISTING WALL TO BE REMOVED

EXISTING WALL TO REMAIN

NEW STUD FRAMED WALL

## FOUNDATION NOTES

- 1. FOUNDATIONS SHALL BE CARRIED DOWN TO ELEVATIONS INDICATED ON DRAWINGS OR FURTHER, AS REQUIRED, TO UNDISTURB MATERIAL HAVING A MINIMUM BEARING CAPACITY OF 2 TONS PER SQUARE FOOT.
- 2. FOOTING ELEVATIONS SHOWN ON DRAWINGS REPRESENT ESTIMATED DEPTHS AND ARE NOT TO BE CONSTRUED AS LIMITING THE AMOUNT OF EXCAVATION REQUIRED TO REACH BEARING MATERIAL.
- 3. EXTERIOR CONSTRUCTION SHALL BE CARRIED DOWN BELOW FINISHED EXTERIOR GRADE TO A MINIMUM DEPTH OF 4 FEET UNLESS OTHERWISE NOTED.
- 4. BACKFILL UNDER ANY PORTION OF THE BUILDING SHALL BE COMPACTED IN 6" LIFTS.
- 5. UNLESS OTHERWISE NOTED, FOOTINGS SHALL BE CENTERED UNDER SUPPORTED MEMBERS.
- 6. BACKFILLING SHALL BE DONE SIMULTANEOUSLY ON BOTH SIDES OF THE BUILDING IN ORDER TO MINIMIZE UNBALANCED EARTH PRESSURES.

# CONCRETE

1. CONCRETE WORK SHALL CONFORM TO BUILDING CODE REQUIREMENTS FOR REINFORCED CONCRETE (ACI 318) AND SPECIFICATIONS FOR STRUCTURAL CONCRETE FOR BUILDINGS (ACI 301).

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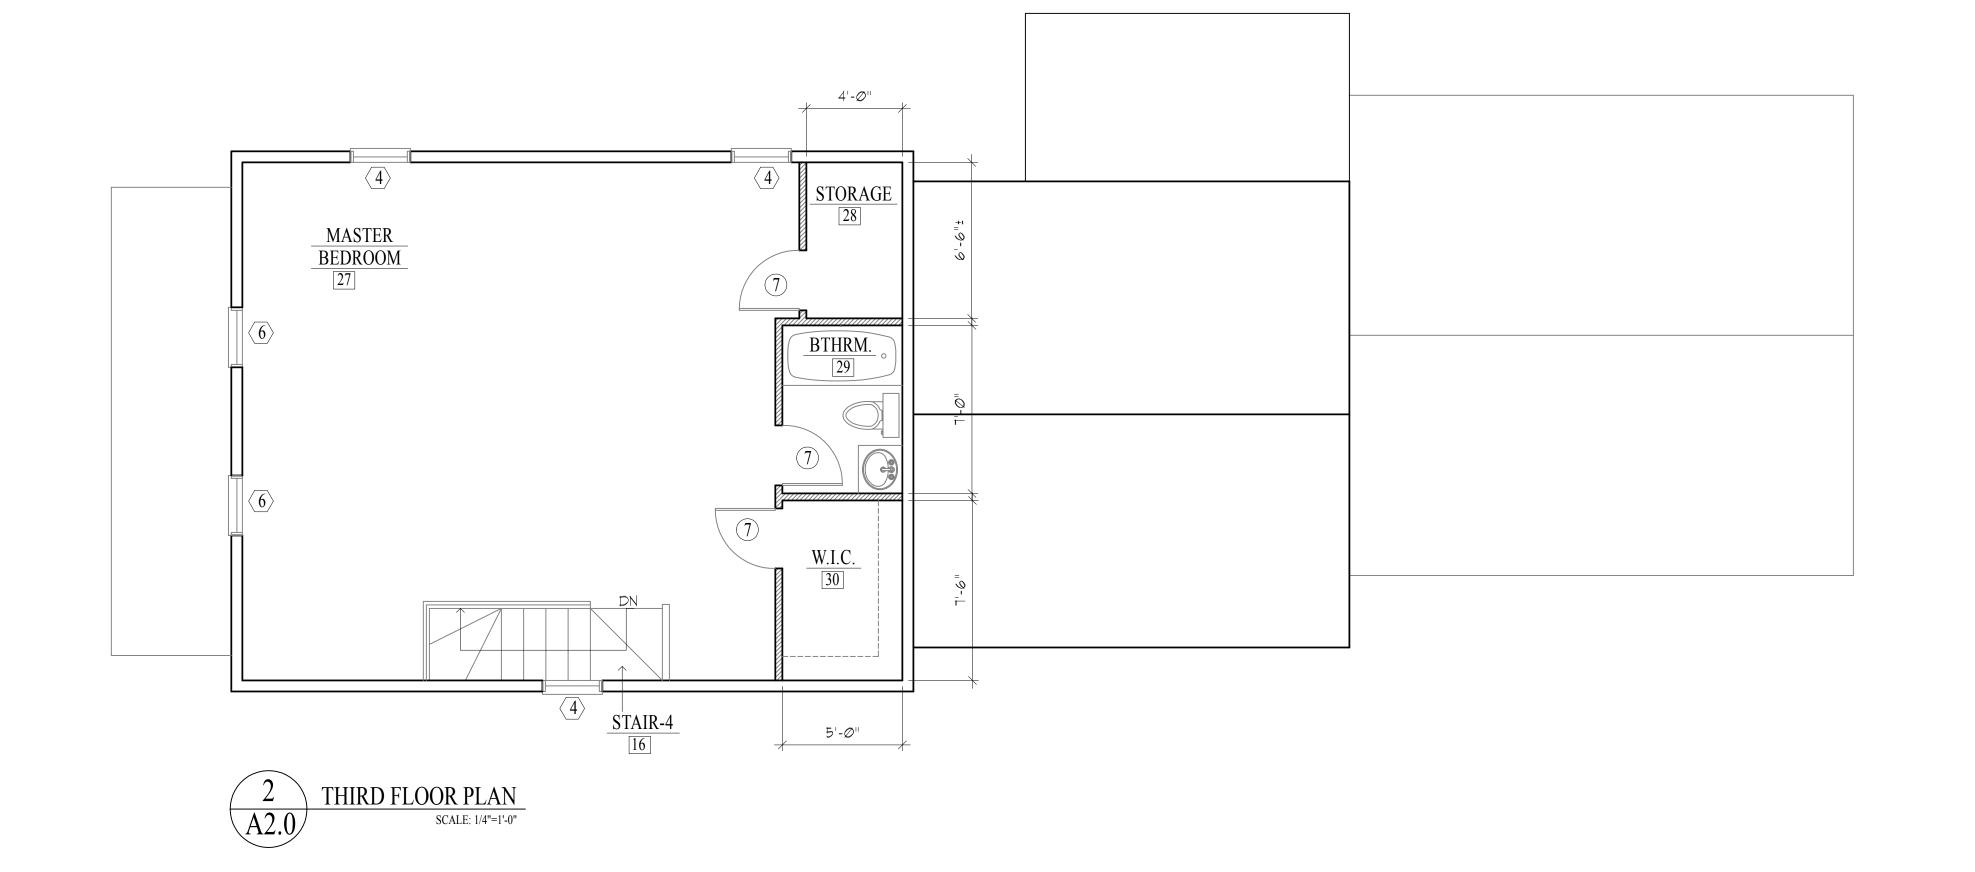
18 LINCOLN STREET

Proposed Renovations and New Rear Addition
18 Lincoln Street, Hyde Park, MA 02136

Title:	
BASEMENT FLOOR PLAN	
Scale:	1/4"=1'-0"
Revisions:	
Drawn by:	BLS
Approved by:	НР
Project No.:	
Date:	2-2-18
Drawing No.:	

A1.0

# 13'-6" EXISTING ROOF BLW. DINING RM. EXISTING ROOF BLW. 14'-6" 4'-3 1/2" NEW ROOF BELOW **ISLAND** BEDROOM-2 HALLWAY BEDROOM-1 5'-Ø" STAIR-4 STAIR-2 10'-3 1/2" SECOND FLOOR PLAN



# PROPOSED RENOVATIONS and NEW REAR ADDITION

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WALL LEGEND:

EXISTING WALL TO BE REMOVED

EXISTING WALL TO REMAIN

NEW STUD FRAMED WALL

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Project

18 LINCOLN STREET


Proposed Renovations and New Rear Addition
18 Lincoln Street, Hyde Park, MA 02136

Title:	
SECONE FLOOR I	O & THIRD PLANS
Scale:	1/4"=1'-0"
Revisions:	
Drawn by:	BLS
Approved by:	НР
Project No.:	
Date:	2-2-18

**A2.0** 

## Dimensions:

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Project

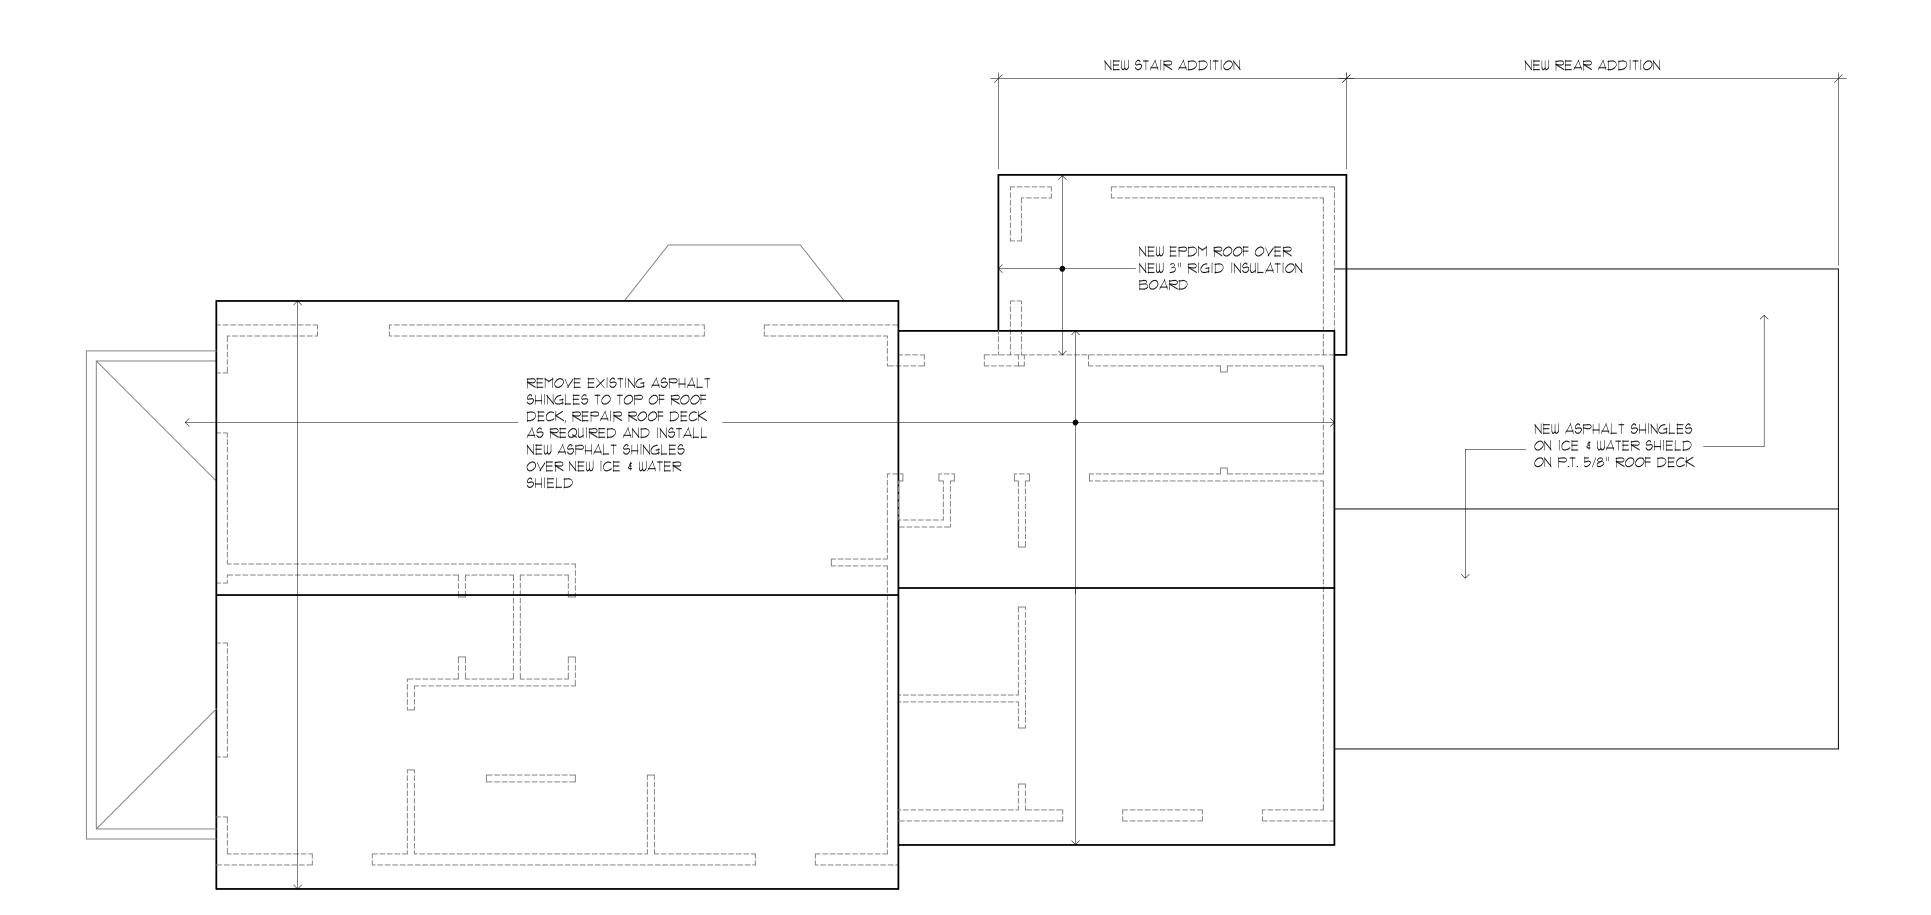18 LINCOLN STREET

Proposed Renovations and New Rear Addition
18 Lincoln Street, Hyde Park, MA 02136

Title:	
ROOF P	LAN
Scale:	1/4"=1'-0"
Revisions:	
Drawn by:	
Diawii by.	BLS
Approved by:	НР
Project No.:	
Date:	
Date.	2-2-18
Drawing No.:	

**A3.0** 

			FINISH ROO	M SCHEDULE		
ROOM No.	ROOM NAME	FLOOR	BASE	WALL	CEILING	NOTES
B1	EXISTING BASEMENT	EXIST. CONCRETE		EXISTING		
B2	NEW BASEMENT	CONCRETE		CONCRETE		
В3	NEW BASEMENT	CONCRETE		CONCRETE		
B4	STAIR - 1B	CERAMIC TILE	4" WOOD	GYPSUM WALLBOARD	GYPSUM WALLBOARD	
01	APT. 1 ENTRY	STRIP OAK	4" WOOD	GYPSUM WALLBOARD	GYPSUM WALLBOARD	
02	LIVING ROOM	STRIP OAK	4" WOOD	GYPSUM WALLBOARD	GYPSUM WALLBOARD	
03	DINING ROOM	STRIP OAK	4" WOOD	GYPSUM WALLBOARD	GYPSUM WALLBOARD	
04	KITCHEN	STRIP OAK	4" WOOD	GYPSUM WALLBOARD	GYPSUM WALLBOARD	
04A	LAUNDRY	STRIP OAK	4" WOOD	GYPSUM WALLBOARD	GYPSUM WALLBOARD	
05	STAIR - 1	STRIP OAK	4" WOOD	GYPSUM WALLBOARD	GYPSUM WALLBOARD	
06	STAIR - 3	STRIP OAK	4" WOOD	GYPSUM WALLBOARD	GYPSUM WALLBOARD	
07	HALLWAY	STRIP OAK	4" WOOD	GYPSUM WALLBOARD	GYPSUM WALLBOARD	
08	BEDROOM	STRIP OAK	4" WOOD	GYPSUM WALLBOARD	GYPSUM WALLBOARD	
09	BATHROOM	CERAMIC TILE	4" WOOD	GYPSUM WALLBOARD	GYPSUM WALLBOARD	
10	WALK-IN-CLOSET	STRIP OAK	4" WOOD	GYPSUM WALLBOARD	GYPSUM WALLBOARD	
11	MASTER BATHROOM	CERAMIC TILE	CERAMIC TILE	GYPSUM WALLBOARD	GYPSUM WALLBOARD	
12	MASTER BEDROOM	STRIP OAK	4" WOOD	GYPSUM WALLBOARD	GYPSUM WALLBOARD	
13	APT. 2 ENTRY	STRIP OAK	4" WOOD	GYPSUM WALLBOARD	GYPSUM WALLBOARD	
14	STAIR - 2	STRIP OAK	4" WOOD	GYPSUM WALLBOARD	GYPSUM WALLBOARD	
15	STAIR - 4	STRIP OAK	4" WOOD	GYPSUM WALLBOARD	GYPSUM WALLBOARD	
16	BEDROOM - 1	STRIP OAK	4" WOOD	GYPSUM WALLBOARD	GYPSUM WALLBOARD	
17	LIVING ROOM	STRIP OAK	4" WOOD	GYPSUM WALLBOARD	GYPSUM WALLBOARD	
18	DINING ROOM	STRIP OAK	4" WOOD	GYPSUM WALLBOARD	GYPSUM WALLBOARD	
19	KITCHEN	STRIP OAK	4" WOOD	GYPSUM WALLBOARD	GYPSUM WALLBOARD	
20	HALLWAY	STRIP OAK	4" WOOD	GYPSUM WALLBOARD	GYPSUM WALLBOARD	
21	STAIR - 5	STRIP OAK	4" WOOD	GYPSUM WALLBOARD	GYPSUM WALLBOARD	
22	HALLWAY	STRIP OAK	4" WOOD	GYPSUM WALLBOARD	GYPSUM WALLBOARD	
23	LAUNDRY	STRIP OAK	4" WOOD	GYPSUM WALLBOARD	GYPSUM WALLBOARD	
24	BATHROOM	CERAMIC TILE	CERAMIC TILE	GYPSUM WALLBOARD	GYPSUM WALLBOARD	
25	WALK-IN-CLOSET	STRIP OAK	4" WOOD	GYPSUM WALLBOARD	GYPSUM WALLBOARD	
26	BEDROOM - 2	STRIP OAK	4" WOOD	GYPSUM WALLBOARD	GYPSUM WALLBOARD	
27	MASTER BEDROOM	STRIP OAK	4" WOOD	GYPSUM WALLBOARD	GYPSUM WALLBOARD	
28	STORAGE	STRIP OAK	4" WOOD	GYPSUM WALLBOARD	GYPSUM WALLBOARD	
29	BATHROOM	CERAMIC TILE	CERAMIC TILE	GYPSUM WALLBOARD	GYPSUM WALLBOARD	
30	WALK-IN-CLOSET	STRIP OAK	4" WOOD	GYPSUM WALLBOARD	GYPSUM WALLBOARD	

Dimensions:


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18 LINCOLN STREET
Proposed Renovations and New Rear Addition
18 Lincoln Street, Hyde Park, MA 02136

Title:	
FINISH S	SCHEDULE
Scale: NO	ΓAPPLICABLE
Revisions:	
D 1	
Drawn by:	BLS
Approved by:	HP
Project No.:	
Date:	2-2-18
Drawing No.:	

**A4.0** 




Project

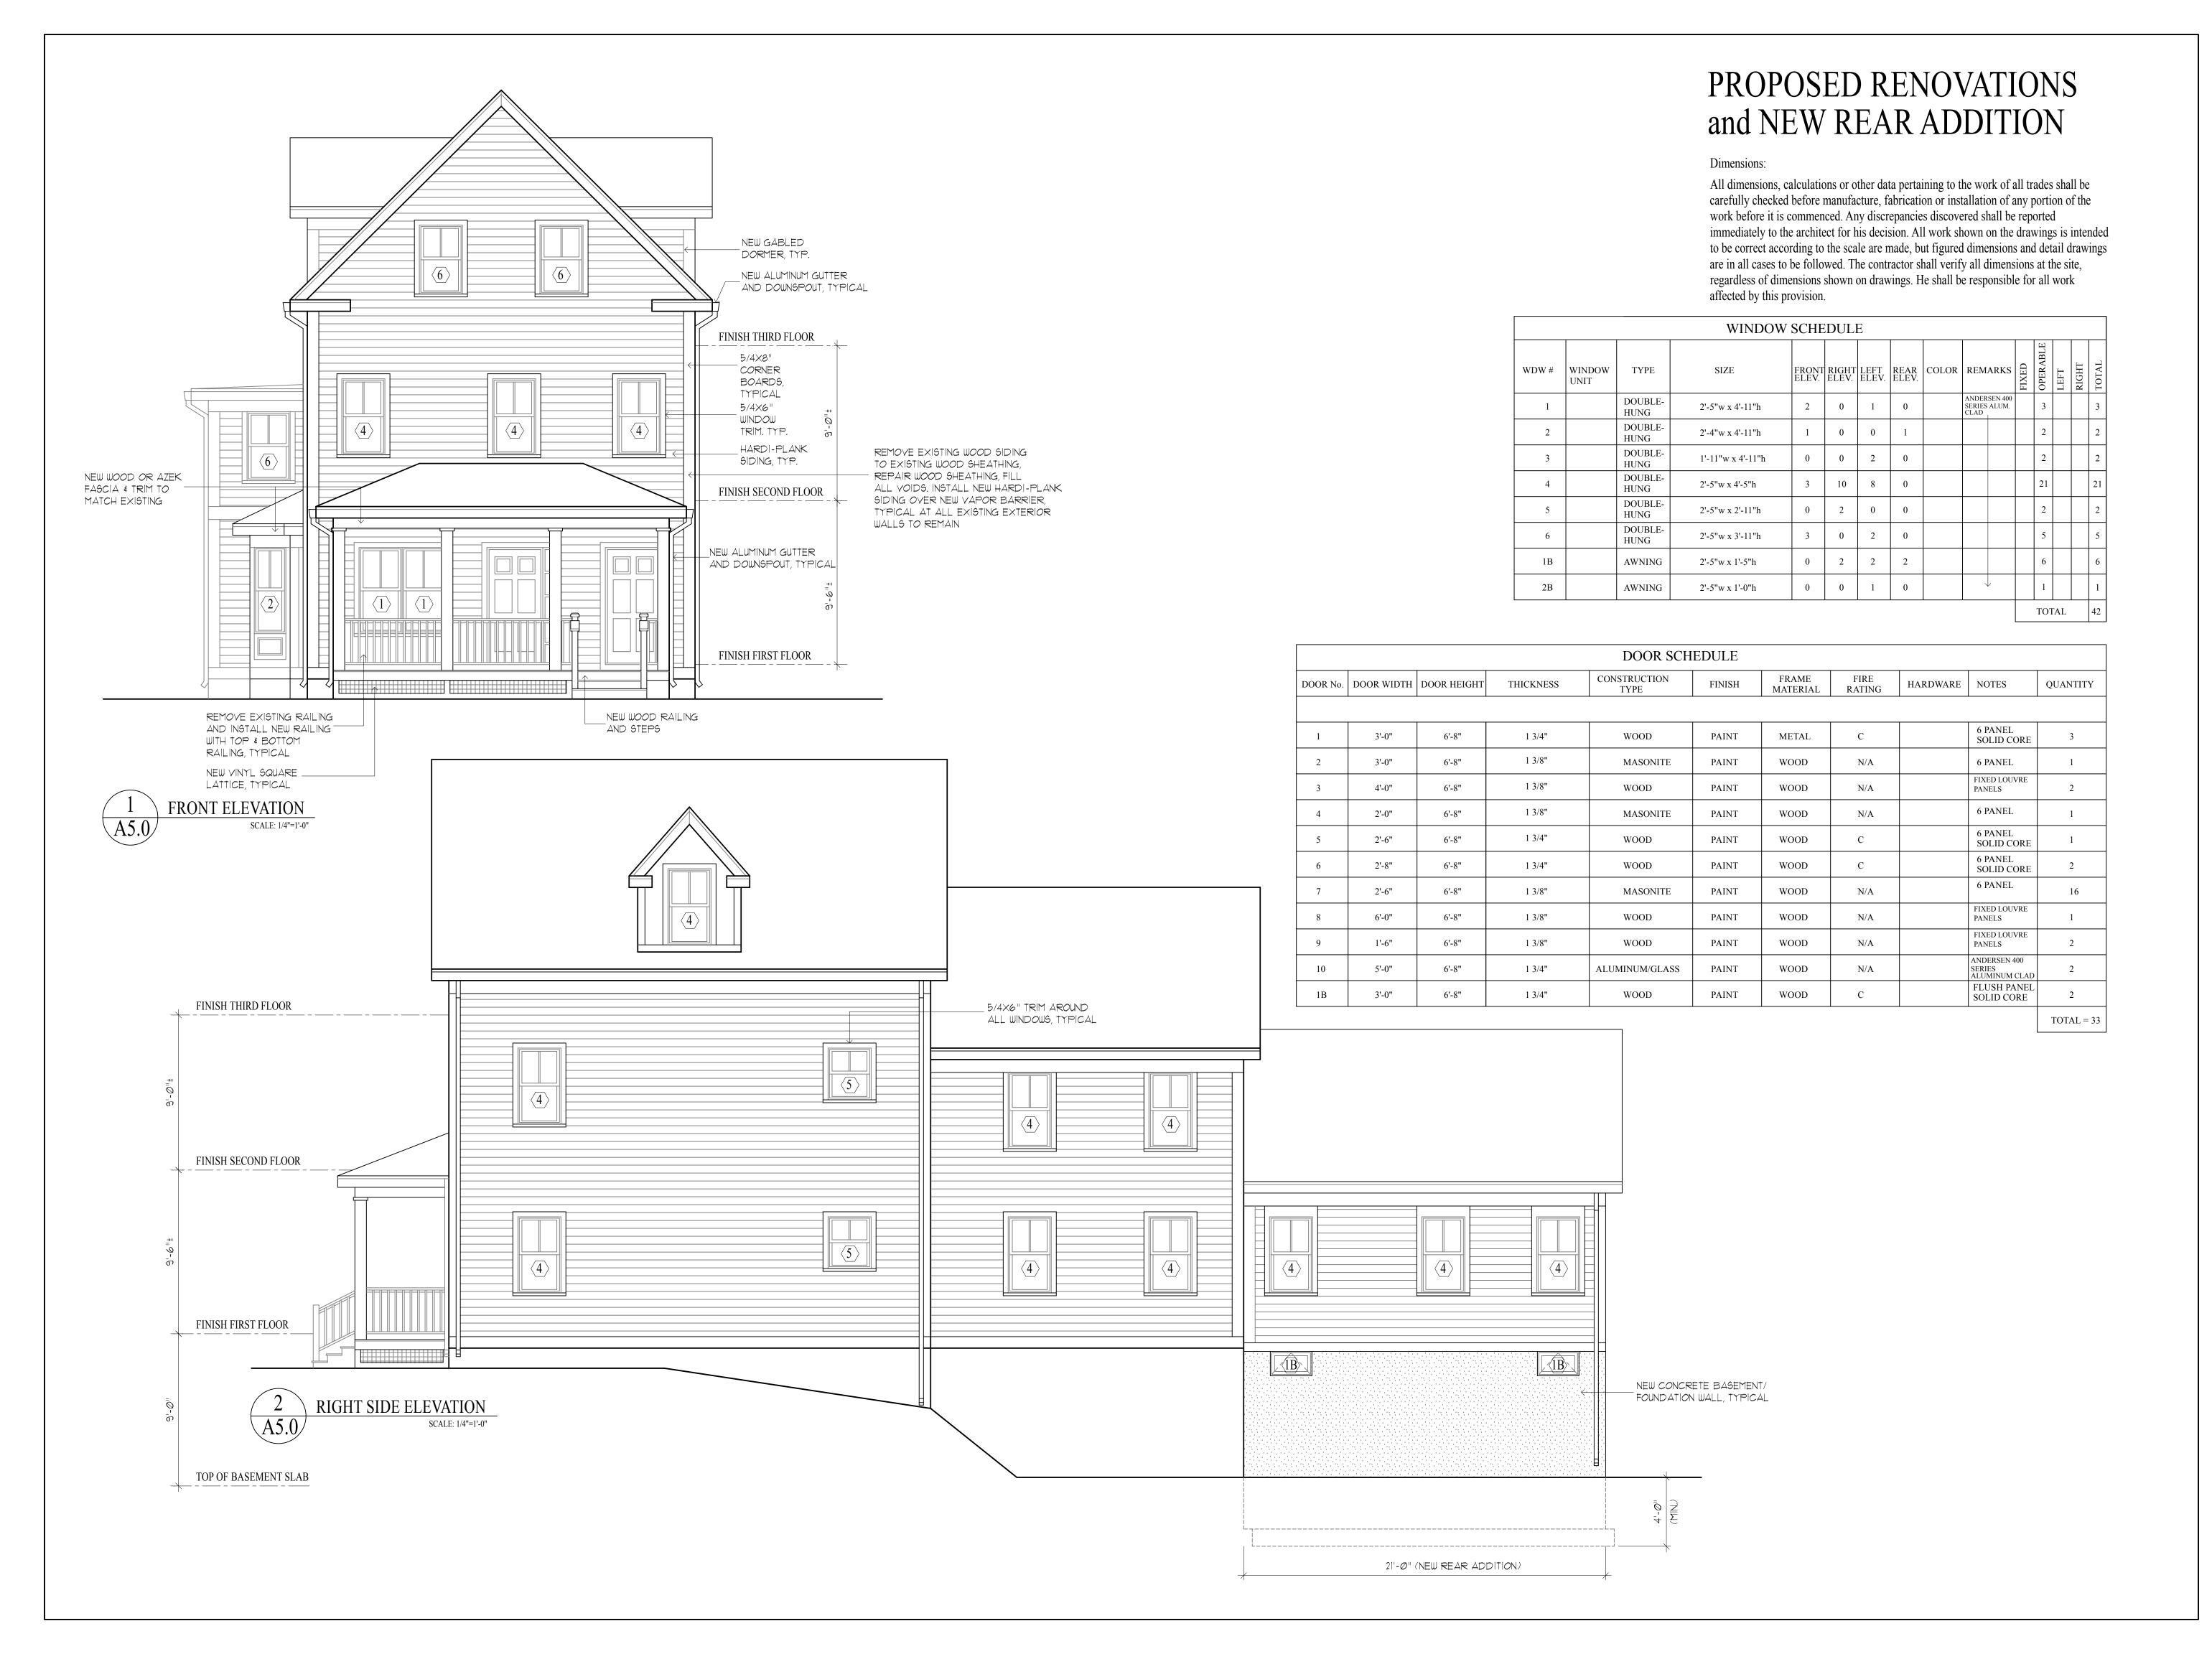18 LINCOLN STREET
Proposed Renovations and New Rear A
18 Lincoln Street, Hyde Park, MA 0213

Architect
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FRONT & RIGHT SIDE ELEVATIONS 1/4"=1'-0" Revisions: Drawn by: Approved by: Project No.: 2-2-18

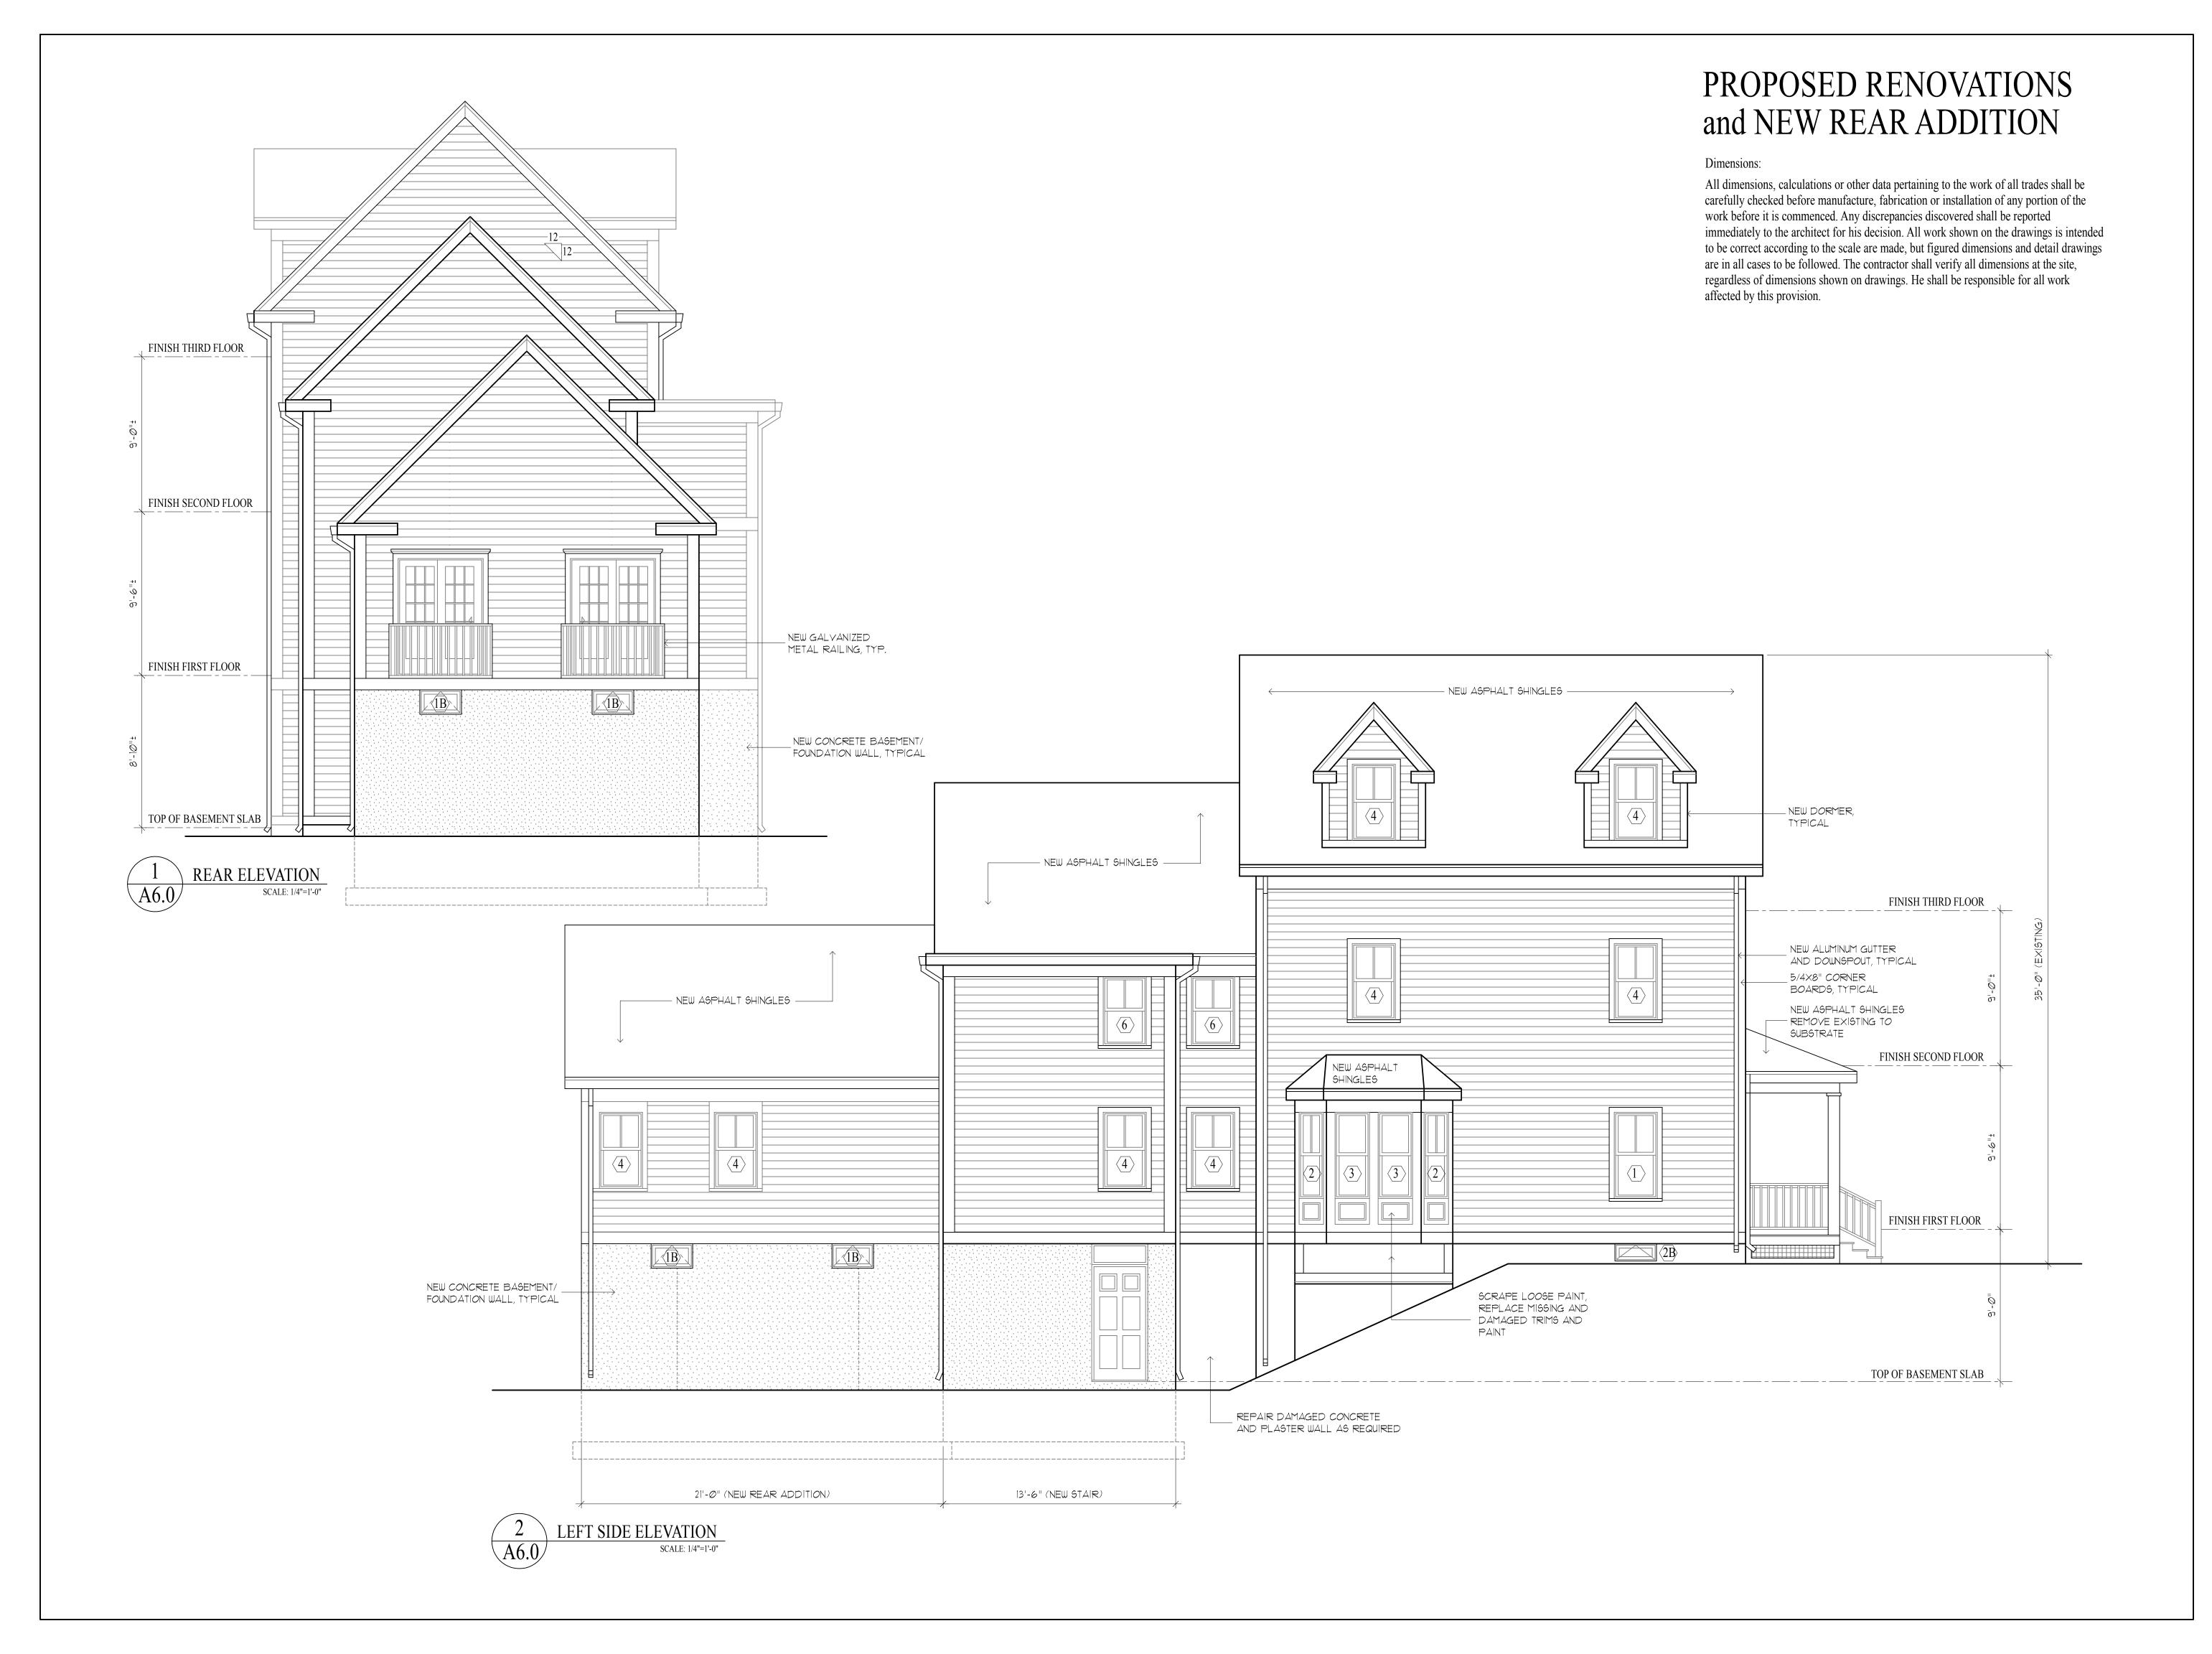

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18 LINCOLN STREET

Proposed Renovations and New Rear Addition
18 Lincoln Street, Hyde Park, MA 02136

Title:

REAR & LEFT
SIDE ELEVATIONS

Scale: 1/4"=1'-0"

Revisions:

Drawn by: BLS


Approved by: HP

Project No.:

Date: 2-2-18


Drawing No.:

**A6.0** 

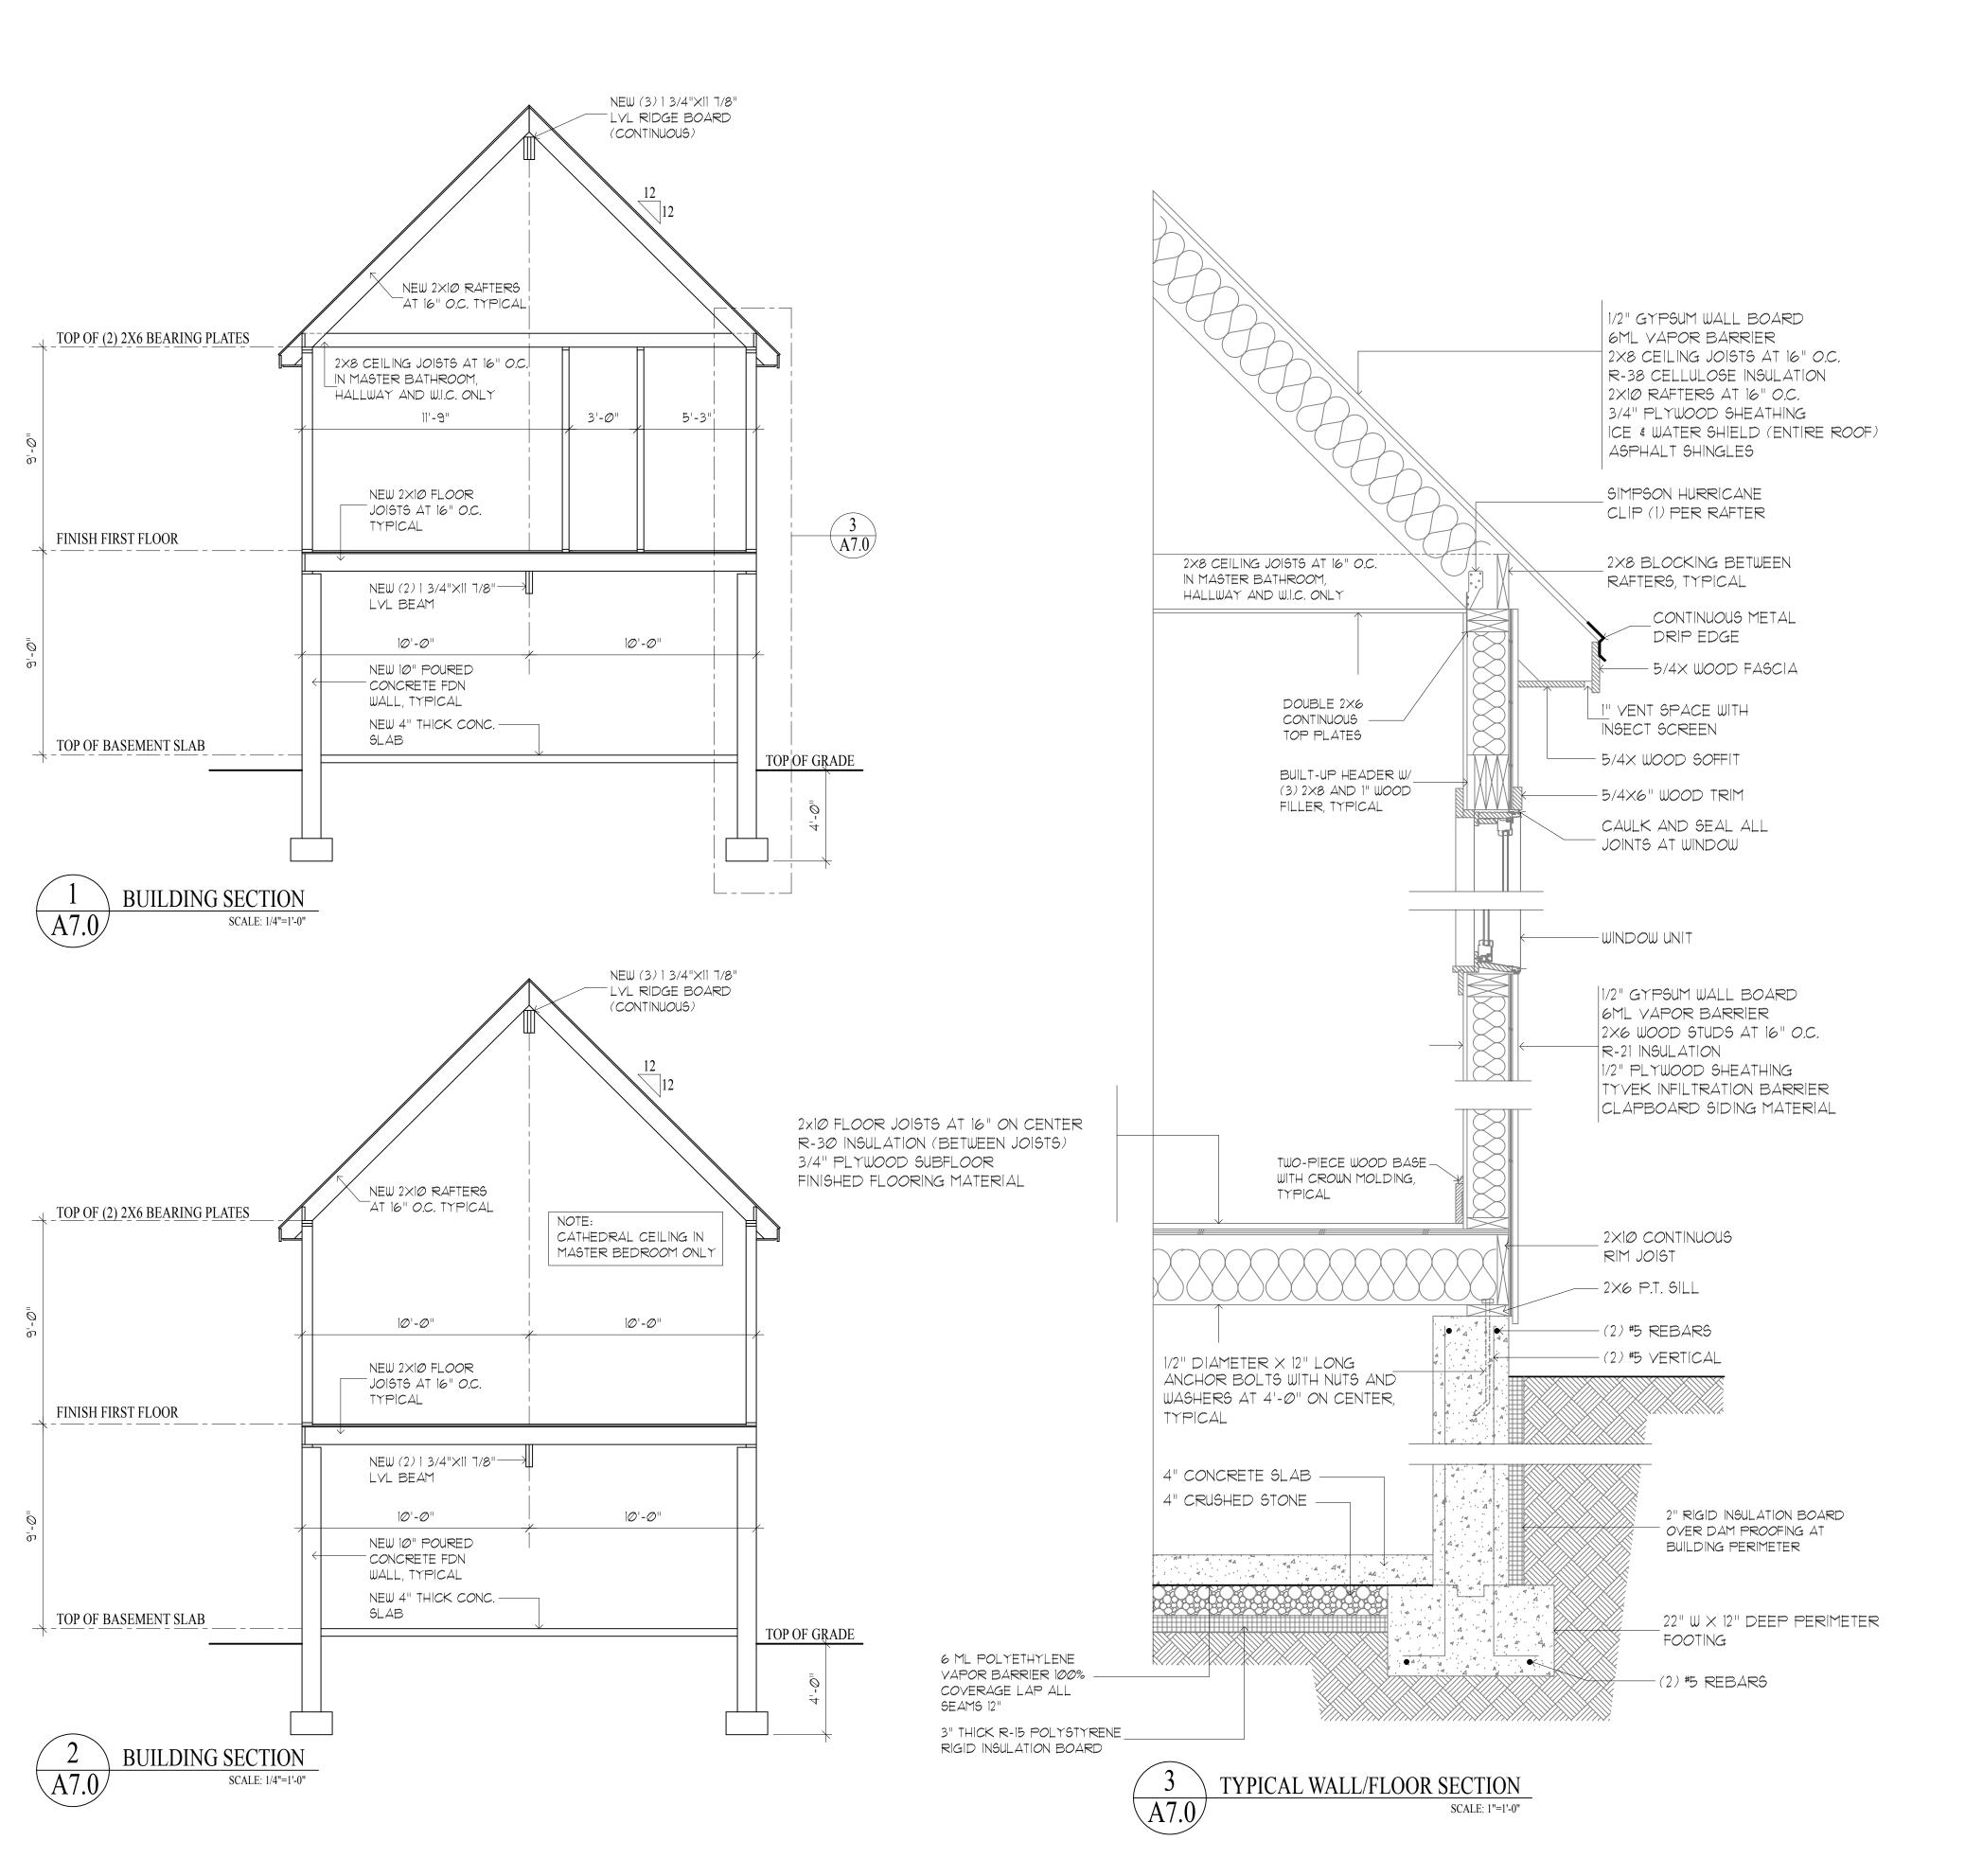


## Dimension


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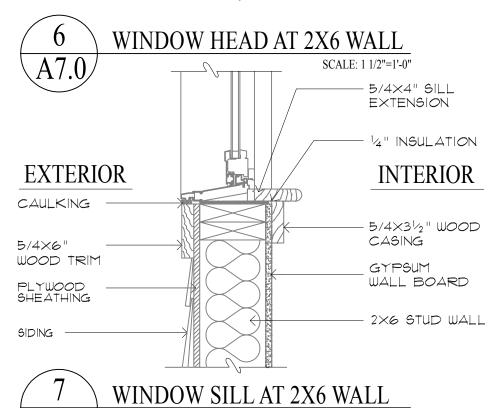

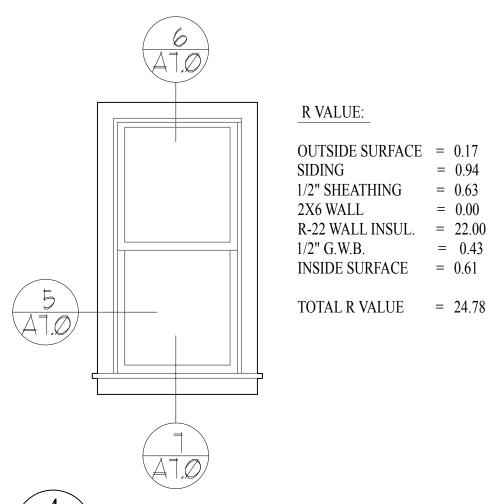
# 4 TYPICAL DOUBLE-HUNG WINDOW SCALE: 1/2"=1'-0"

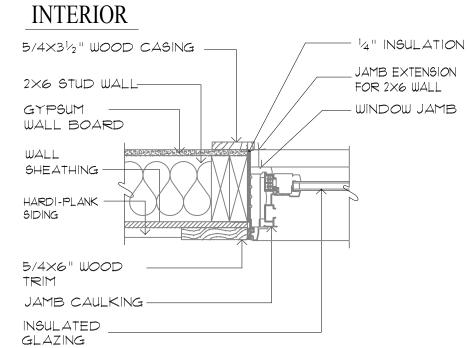

# **EXTERIOR**



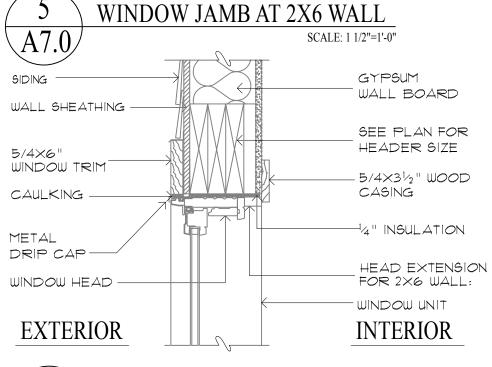


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454 Lowell Avenue Newton, MA 02460
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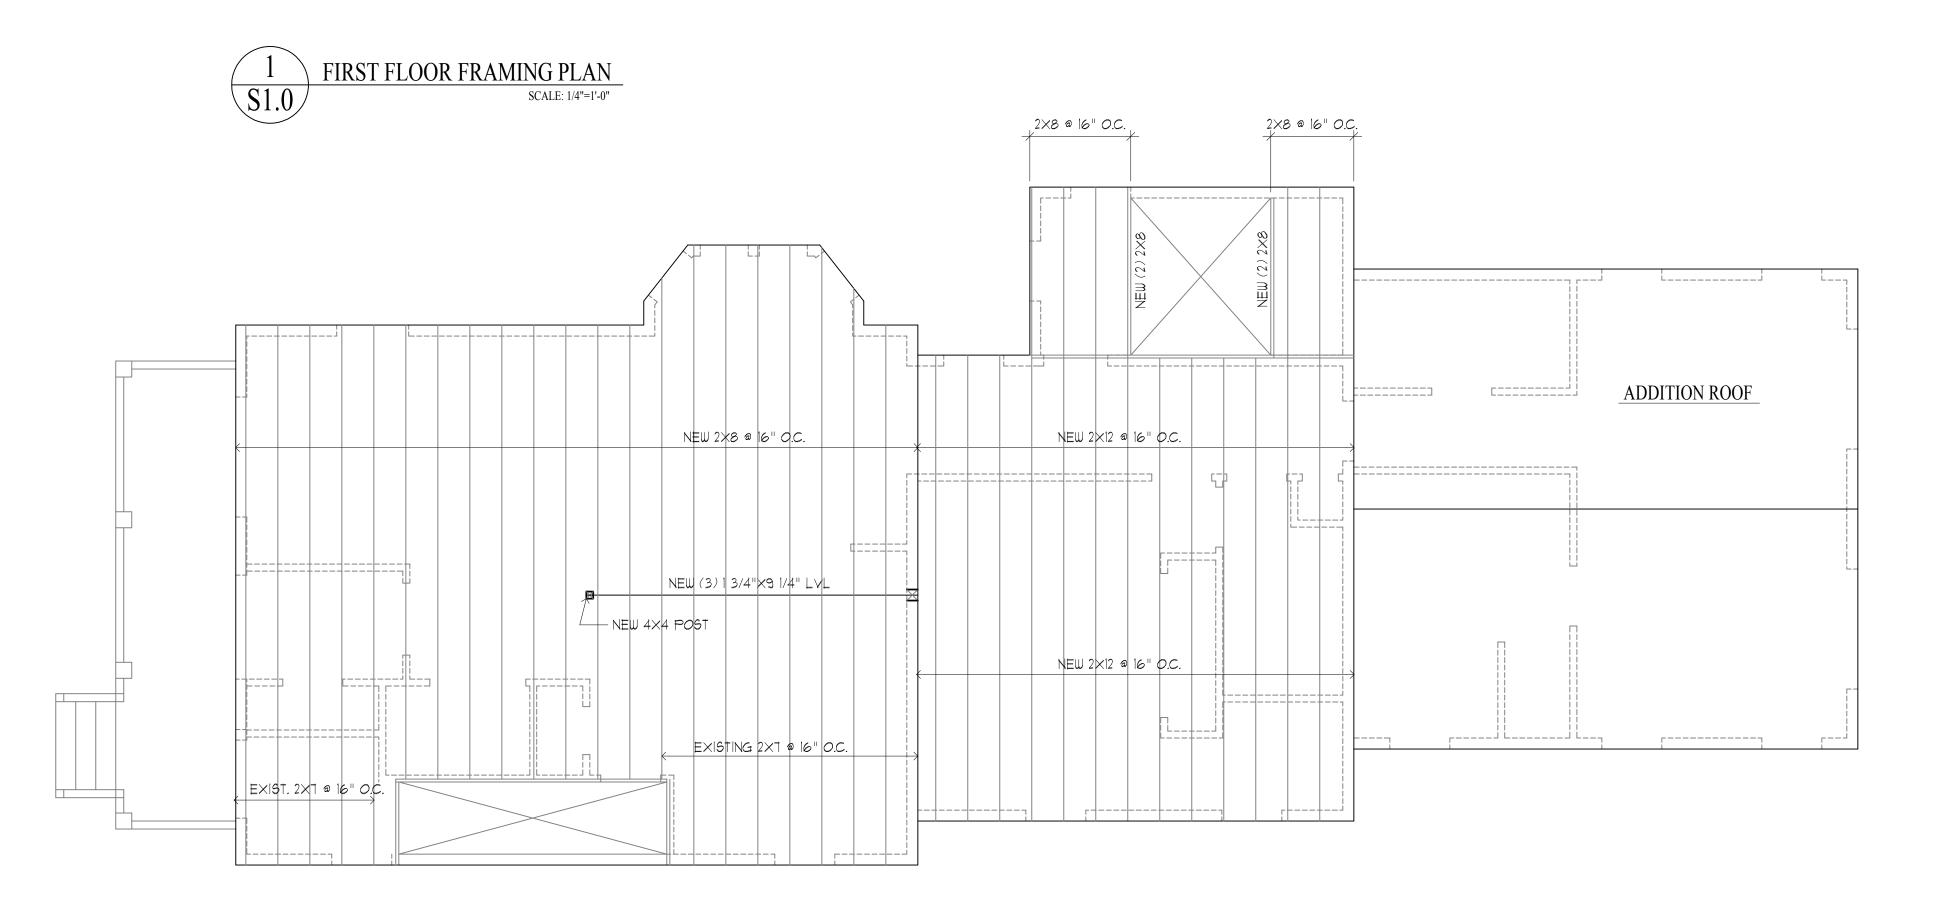
Project

18 LINCOLN STREET

Proposed Renovations and New Rear Addition
18 Lincoln Street, Hyde Park, MA 02136

Scale:	AS NOTED
Revisions:	
Drawn by:	
-	BLS
Approved by	y: HP
Project No.:	
Date:	2-2-18
Drawing No	)i



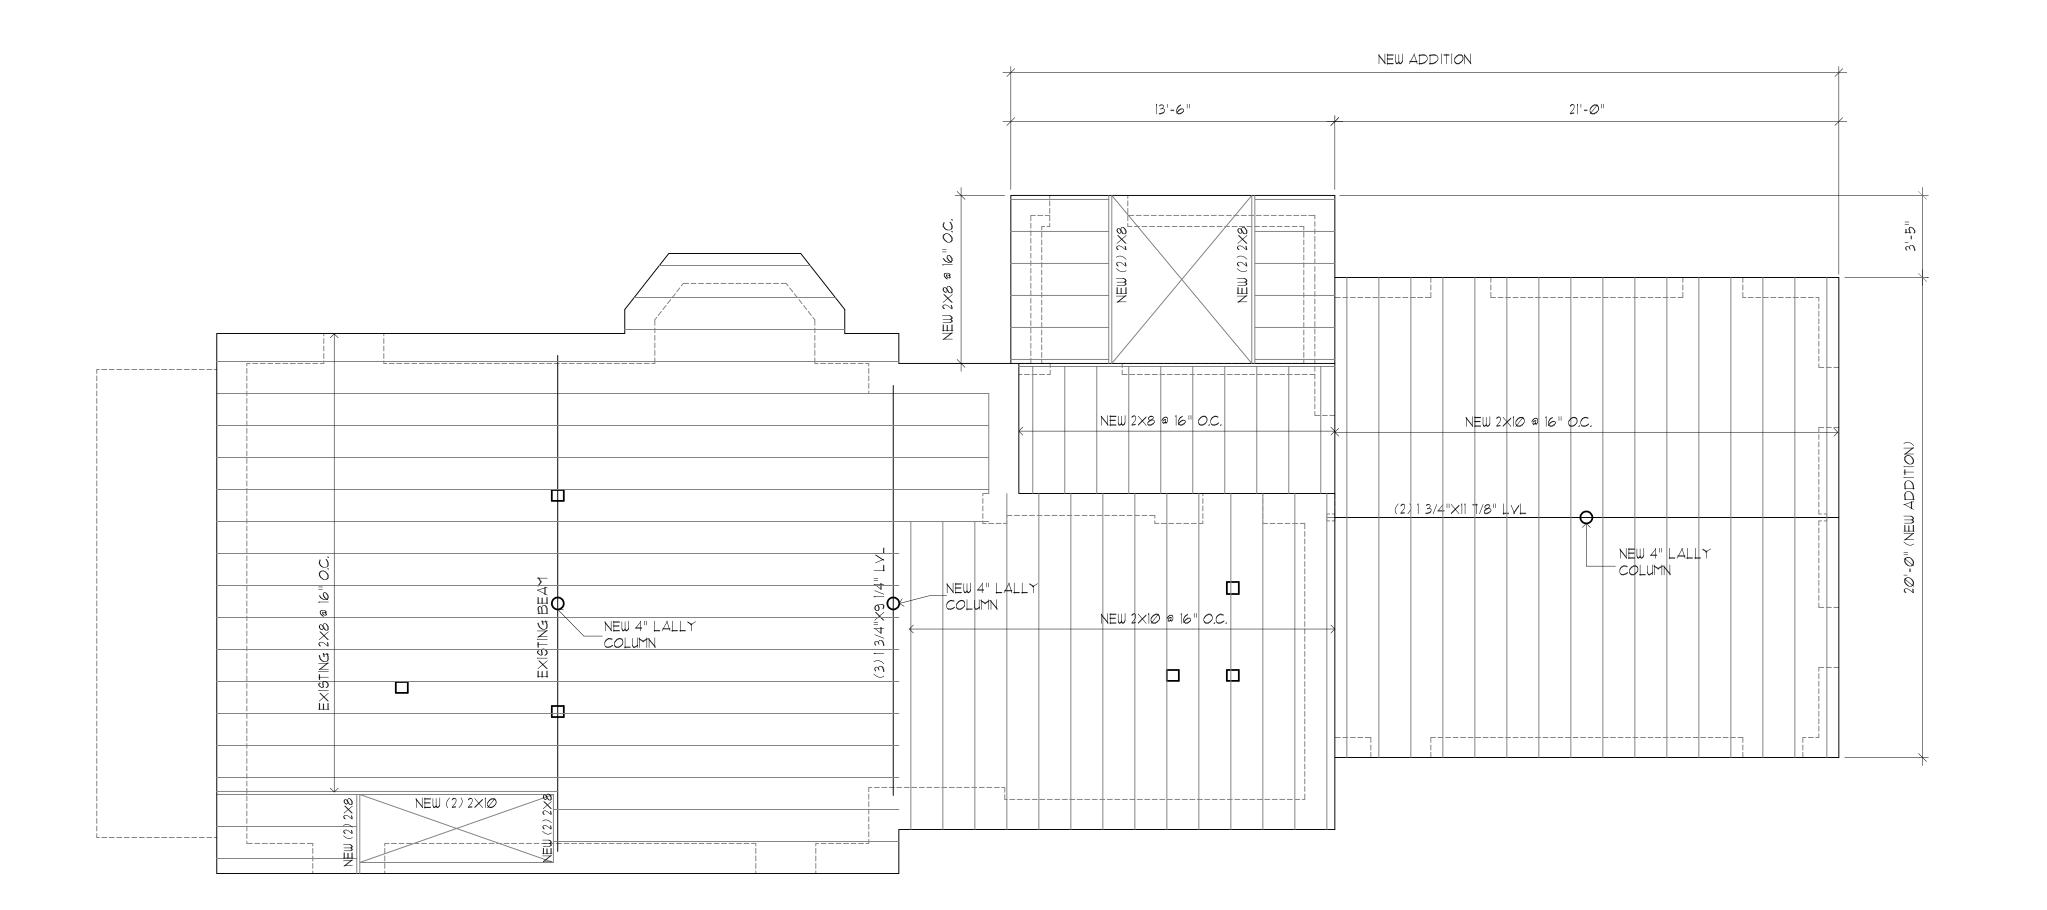



## Dimensions:

All dimensions, calculations or other data pertaining to the work of all trades shall be carefully checked before manufacture, fabrication or installation of any portion of the work before it is commenced. Any discrepancies discovered shall be reported immediately to the architect for his decision. All work shown on the drawings is intended to be correct according to the scale are made, but figured dimensions and detail drawings are in all cases to be followed. The contractor shall verify all dimensions at the site, regardless of dimensions shown on drawings. He shall be responsible for all work affected by this provision.

## STRUCTURAL WOOD CONSTRUCTION

- 1. NEW WOOD FRAMING SHALL HAVE 1100 PSI (REPETITIVE) BENDING STRESS. THE MODULUS OF ELASTICITY SHALL BE A MINIMUM OF 1,200,000 PSI.
- 2. LAMINATED VENER LUMBER BEAMS (LVL) SHALL HAVE A MINIMUM ALLOWABLE BENDING STRESS OF 2800 PSI AND A MINIMUM MODULUS OF ELASTICITY OF 2,000,000 PSI.
- 3. JOIST SPANNING OVER 8' MUST HAVE CROSS BRIDGING AT NO MORE THAN 8' O.C.
- 4. NO JOIST SHALL BE NOTCHED OR DRILLED WITH HOLES WITHOUT THE SPECIFIC APPROVAL OF THE ENGINEER.
- 5. USE DOUBLE JOISTS UNDER ALL PARTITIONS.
- 6. BEARING WALLS WILL BE 2X6 AT 16" O.C. UNLESS OTHERWISE NOTED.
- 7. STUDS SHALL BE NAILED TO SOLE PLATE WITH 3-10d OR 4-8d TOE NAILS.
- 8. ORIENT STRUCTURAL SHEATHING VERTICALLY AND FASTEN TO SOLE PLATE AND ALL PANEL EDGES AT 3" MAXIMUM O.C.
- 9. FOR OPENING UP TO 2'-0" DOUBLE JOIST AT EACH SIDE OF OPENINGS.
- 10. LARGER OPENINGS SHALL BE CALLED TO THE ATTENTION OF THE STRUCTURAL ENGINEER.
- 11. JAMB STUDS SHALL EXTEND IN ONE PIECE FROM HEADER TO SOLE PLATE.
- 12. DOUBLE STUDS SHALL BE USED AT ALL OPENINGS.
- 13. HEADERS SHALL BE SUPPORTED ON JAMB STUDS.
- 14 ALL STUDS SHALL BE CONTINUOUS FROM FLOOR TO FLOOR OR FLOOR TO ROOF.
- 15. SOLE PLATES SHALL BE NAILED TO SUBFLOOR AND JOISTS WITH 16d NAILS AT EACH JOIST.
- 16. WHEN TOP PLATES ARE CUT FOR PIPING OR DUCTWORK, REINFORCE WITH STEEL STRAPS.
- 17. WHERE BEAMS AND GIRDERS OF NOMINAL 2" MEMBERS ARE SHOWN NAIL WITH TWO ROWS OF 16d NAILS SPACED NOT MORE THAN 24" O.C.
- 18. ALL BEAMS MUST SPLICE ONLY OVER SUPPORTS UNLESS SPECIFICALLY INSTRUCTED OTHERWISE BY THE STRUCTURAL ENGINEER.
- 19. ALL WOOD STRUCTURES EXPOSED TO WEATHER SHALL BE PRESSURE TREATED.
- 20. STRUCTURAL TIMBER SHALL BE PURCHASED WITH MAXIMUM MOISTURE CONTENT OF 19% WITH THE 2X6s USED AS SOLE PLATES IN STUD BEARING WALLS. ALL OTHER STRUCTURAL TIMBER SHALL BE PURCHASED WITH A MAXIMUM MOISTURE CONTENT OF 15%.
- 21. TIMBER SHALL BE SO HANDLED AND COVERED AS TO PREVENT MARRING, AND MOISTURE ABSORPTION FROM SNOW OR RAIN

Architect
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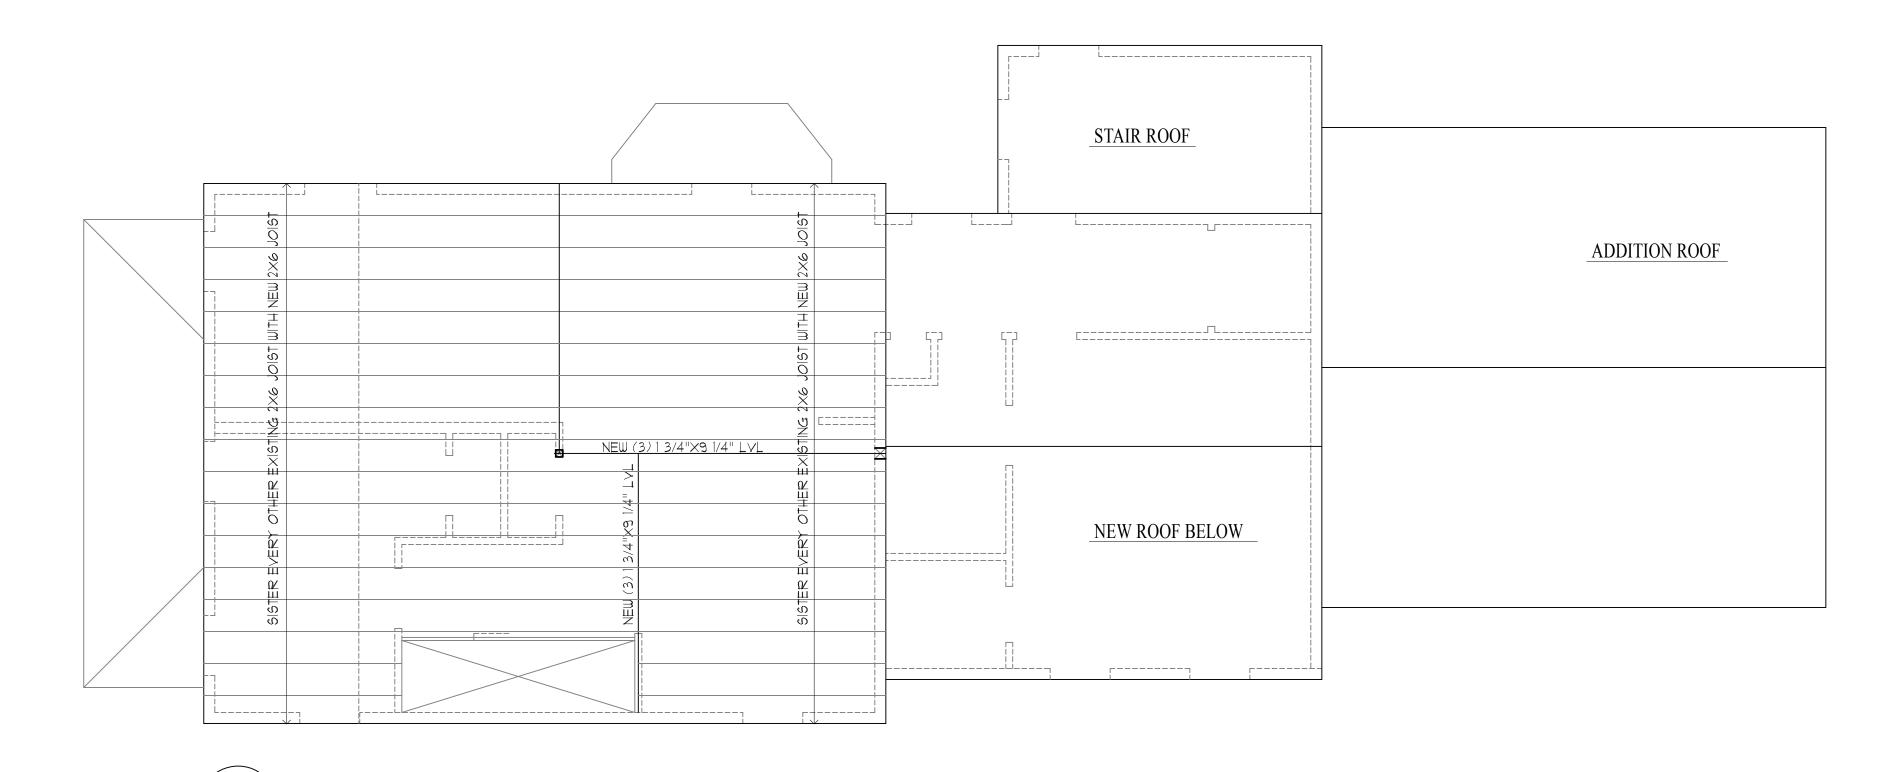
Project


18 LINCOLN STREET

Proposed Renovations and New Rear Addition
18 Lincoln Street, Hyde Park, MA 02136

Title:	
FIRST & SEC FRAMING PL	OND FLOOR LANS
Scale:	1/4"=1'-0"
Revisions:	
<b>D</b> 1	
Drawn by:	BLS
Approved by:	НР
Project No.:	
Date:	2-2-18
Drawing No.:	

**S1.0** 



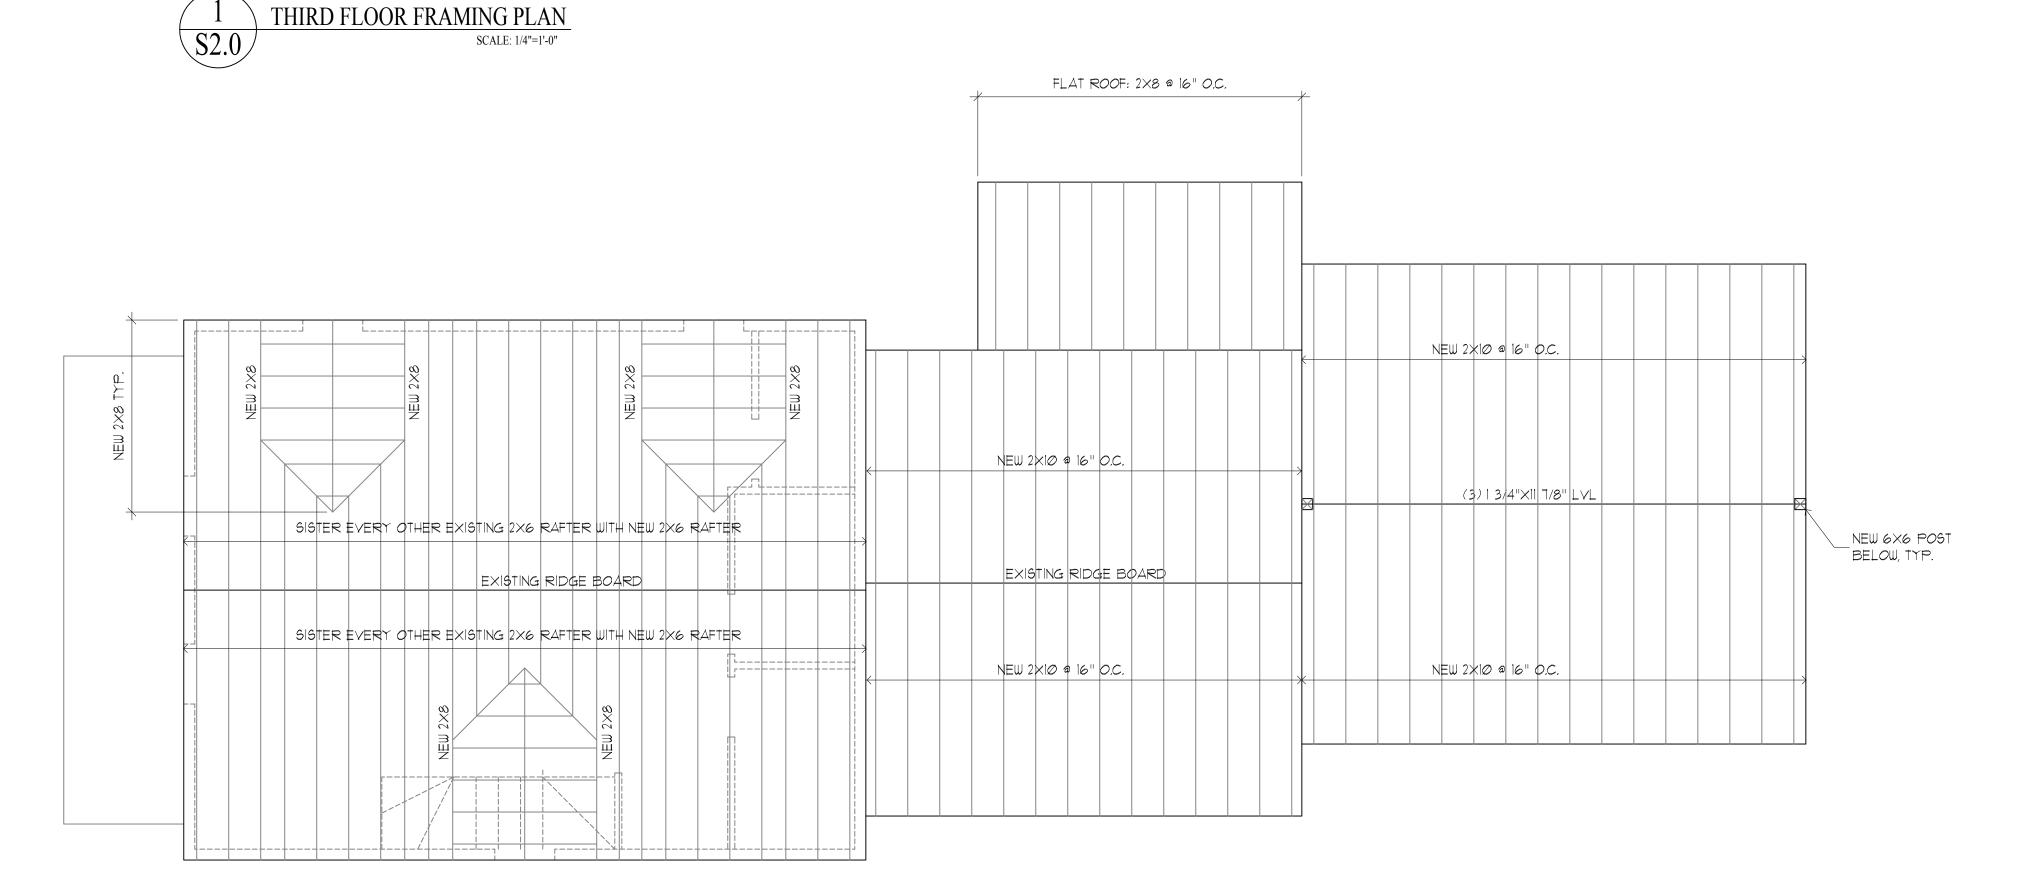

ROOF FRAMING PLAN

SCALE: 1/4"=1'-0"

# PROPOSED RENOVATIONS and NEW REAR ADDITION

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- 6. BEARING WALLS WILL BE 2X6 AT 16" O.C. UNLESS OTHERWISE NOTED.
- 7. STUDS SHALL BE NAILED TO SOLE PLATE WITH 3-10d OR 4-8d TOE NAILS.
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- 15. SOLE PLATES SHALL BE NAILED TO SUBFLOOR AND JOISTS WITH 16d NAILS AT EACH JOIST.
- 16. WHEN TOP PLATES ARE CUT FOR PIPING OR DUCTWORK, REINFORCE WITH STEEL STRAPS.
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- 21. TIMBER SHALL BE SO HANDLED AND COVERED AS TO PREVENT MARRING, AND MOISTURE ABSORPTION FROM SNOW OR RAIN

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Project


18 LINCOLN STREET

Proposed Renovations and New Rear Addition
18 Lincoln Street, Hyde Park, MA 02136

Title:	
THIRD FLOO FRAMING PL	
Scale:	1/4"=1'-0"
Revisions:	
Drawn by:	BLS
Approved by:	НР
Project No.:	
Date:	2-2-18
Drawing No.:	

**S2.0** 

# SIAIR B B WIW NIW BASEMENT IBI STAR-L GE STAR-R GE STAR-

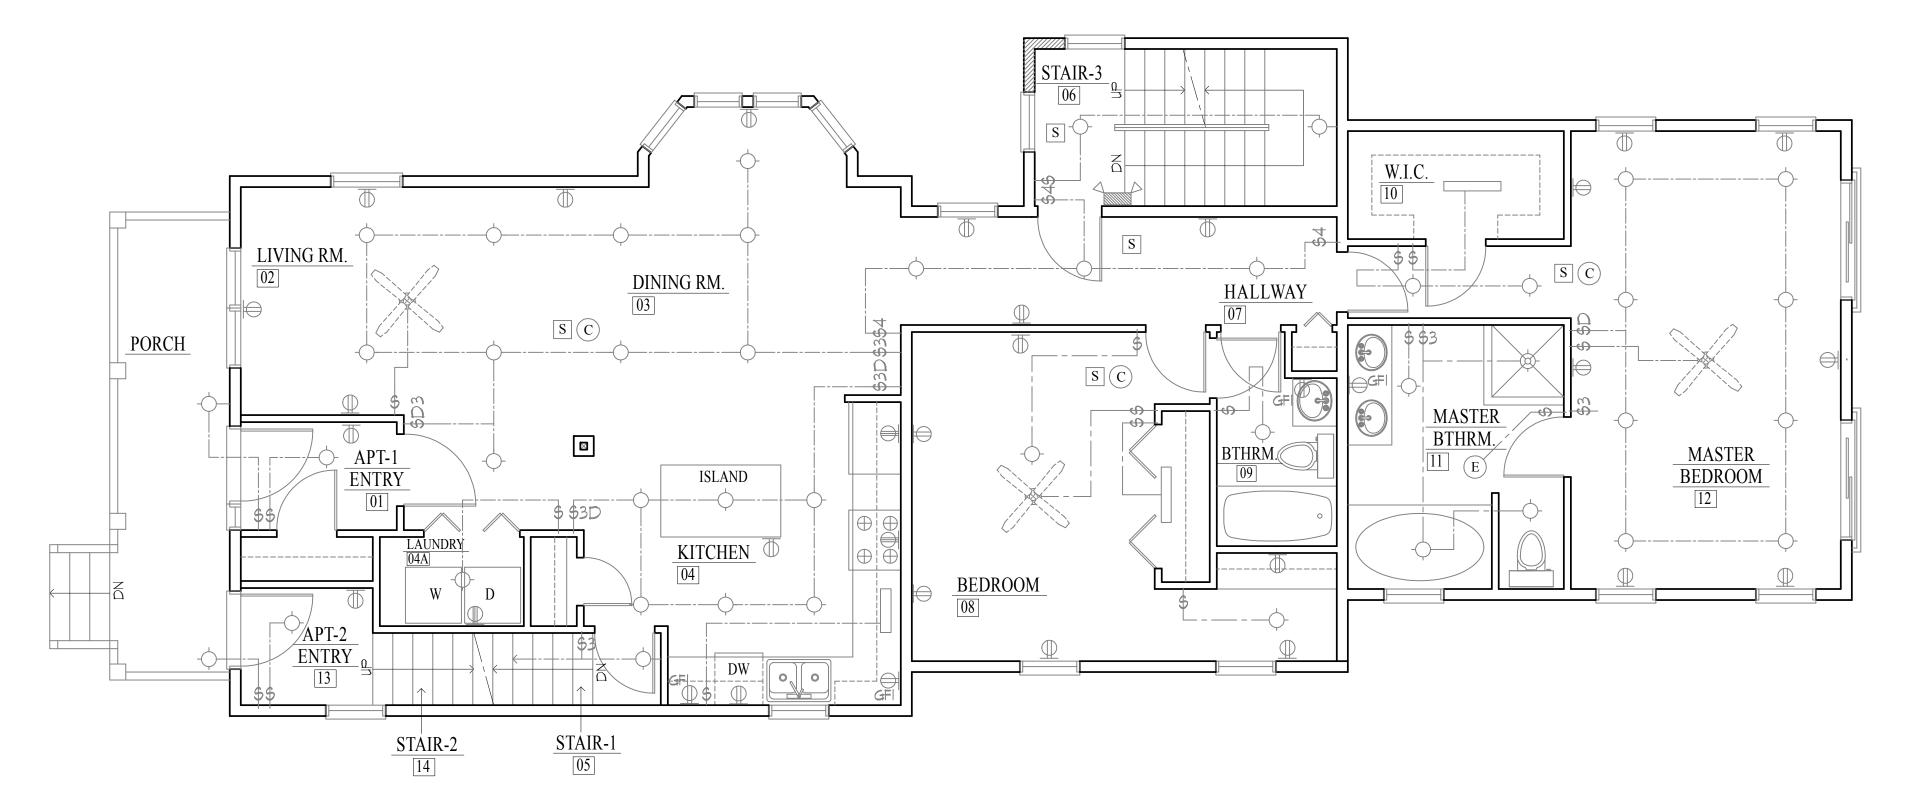

# FIRST FLOOR ELECTRICAL PLAN SCALE: 1/4"=1'-0"

BASEMENT ELECTRICAL PLAN

# PROPOSED RENOVATIONS and NEW REAR ADDITION

## Dimensions:

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FIRE ALARM FIXTURE SCHEDULE		
$\otimes$	NEW EXIT SIGN	
EL	NEW EMERGENCY LIGHT	
FE	NEW FIRE EXTINGUISHER	
ANN	NEW ANNUCIATOR	
E FACP	EXISTING FIRE ALARM CONTROL PANEL	
F	NEW PULL STATION	
	NEW STROBE/HORN	
S	NEW HARD-WIRED SMOKE DETECTOR	
C	NEW HARD-WIRED CARBON MONOXIDE DETECTOR	
V	NEW STROBE (VISUAL ONLY)	
WP	NEW EXTERIOR HORN/STROBE - EXACT LOCATION AND HEIGHT AS PER FIRE DEPARTMENT	
RA	NEW REMOTE ANNUCIATOR	

	ELECTRICAL SYMBOLS				
	RECEPTACLE OUTLET		LIGHTING OUTLETS		
$\bigcirc$	DUPLEX, 110V	ORDL	INCANDESCENT RECESSED DOWN LIGHT		
$\bigcirc$	DUPLEX, 110V, SPLIT WIRED		INCANDESCENT SUSPENDED LIGHT		
FL	DUPLEX 110V FLOOR MOUNTED	-(=)-	INCANDESCENT LIGHT AND FAN		
	DUPLEX, 110V, WEATHERPROOF	E	EXHAUST FAN		
<b>⊕</b> GFI	DUPLEX, 110V, GROUND FAULT		INCAND., WEATHERPROOF WALL SCONCE		
	SPECIAL PURPOSE, 110V		INCAND., EXT WEATHERPROOF FLOOD		
	SINGLE, 220V		INCANDESCENT SURFACE MOUNTED LIGHT		
		$\longleftrightarrow$	FLUORESCENT, DOUBLE TUBE		
MISCELLANEOUS OUTLETS			INCAND., WEATHERPROOF LIGHT WITH MOTION DETECTOR		
		<u>← Р3</u> →	FLUORESCENT, "PRISMATIC", 3 SIDED		
(F)	FAN	<u>←</u> ₽2	FLUORESCENT, "PRISMATIC", 2 SIDED		
	THERMOSTAT  DOOR SIGNAL PUSH BUTTON		SWITCHES		
	DOOR SIGNAL BUZZER OR BELL	\$	SINGLE POLE		
$\overline{Y}$	TELEPHONE	\$3	3-WAY (FROM 2 LOCATIONS)		
TV	TELEVISION	\$4	4-WAY (FROM 3 LOCATIONS)		
SPK	SPEAKER	\$ MD	SINGLE POLE MOTION DETECTOR SWITCH		
		\$D	SINGLE POLE DIMMER SWITCH		

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Project

18 LINCOLN STREET


Proposed Renovations and New Rear Addition
18 Lincoln Street, Hyde Park, MA 02136

Title:	
BASEMENT & FIRST FLOOR ELECTRICAL PLANS	
Scale:	1/4"=1'-0"
Revisions:	
Drawn by:	BLS
Approved by:	НР
Project No.:	
Date:	2-2-18
Drawing No.:	

E1.0

# EXSTING RECORD BY BEDROOM-1 STAIR-3 STAIR-3 STAIR-3 STAIR-3 STAIR-3 STAIR-4 STAIR-4 STAIR-4 STAIR-4 STAIR-2 STAIR-3 STAIR-4 STAIR-2 STAIR-4 STAIR-2 STAIR-2 STAIR-2 STAIR-2 STAIR-3 STAIR-3

SECOND FLOOR ELECTRICAL PLAN

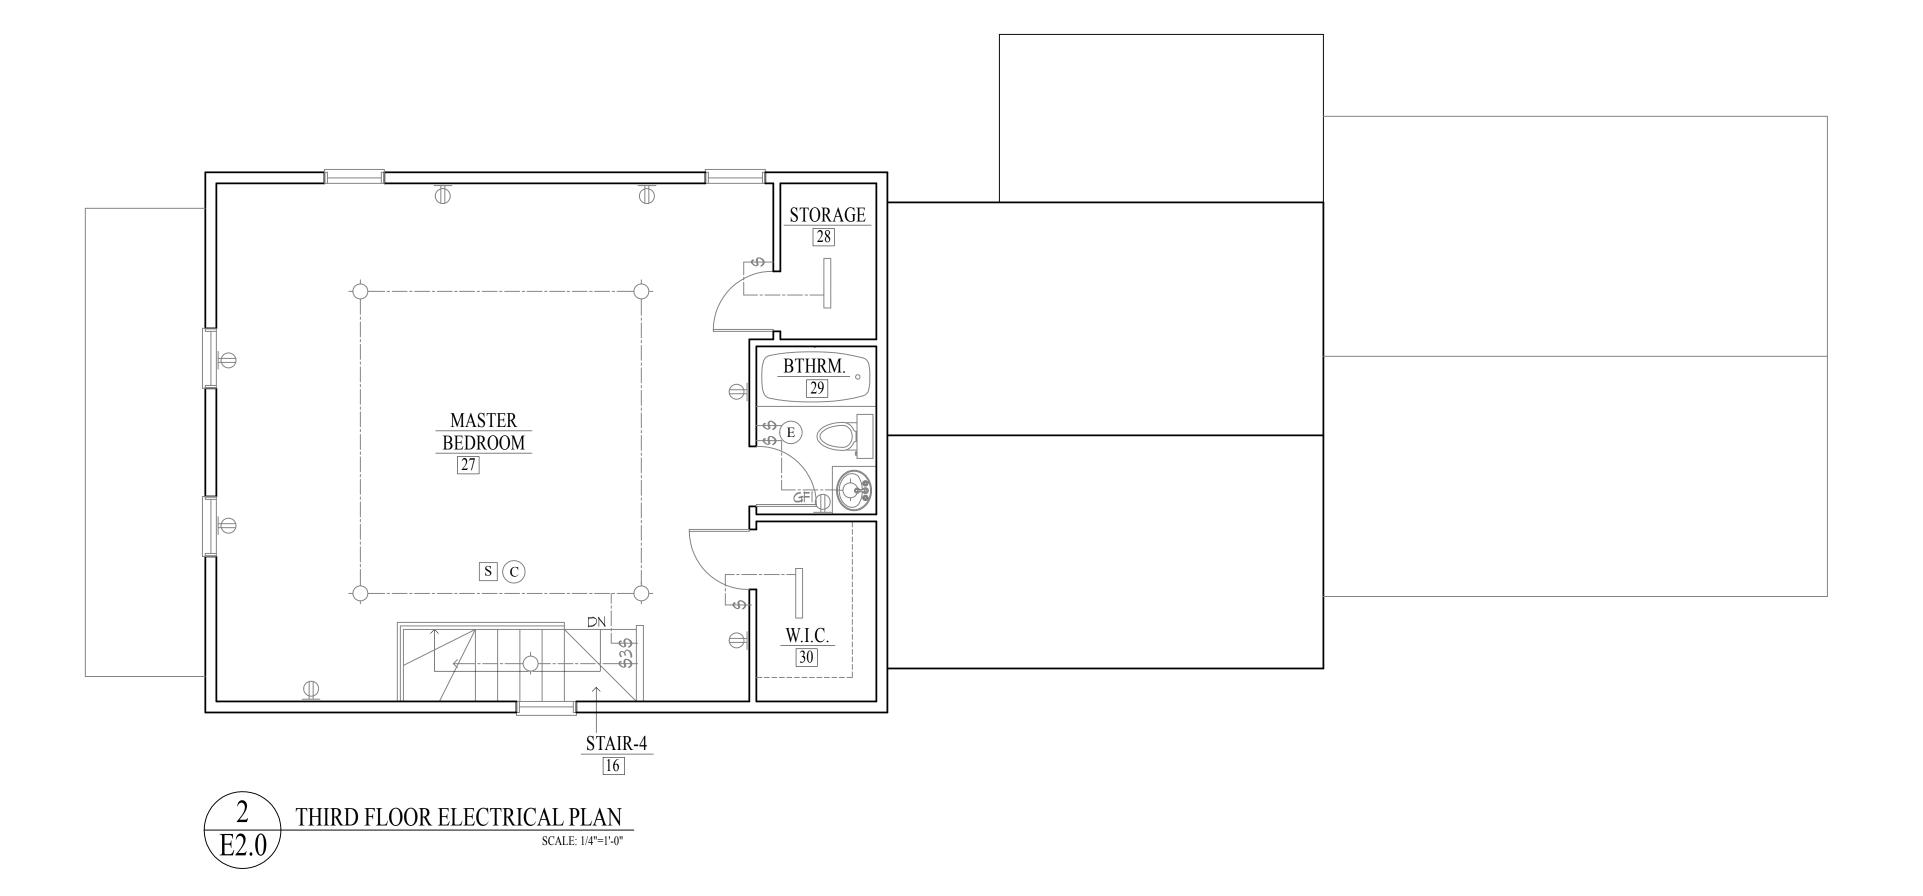

# PROPOSED RENOVATIONS and NEW REAR ADDITION

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$\otimes$	NEW EXIT SIGN			
EL	NEW EMERGENCY LIGHT			
FE	NEW FIRE EXTINGUISHER			
ANN	NEW ANNUCIATOR			
E FACP	EXISTING FIRE ALARM CONTROL PANEL			
F	NEW PULL STATION			
	NEW STROBE/HORN			
S	NEW HARD-WIRED SMOKE DETECTOR			
C	NEW HARD-WIRED CARBON MONOXIDE DETECTOR			
V	NEW STROBE (VISUAL ONLY)			
WP	NEW EXTERIOR HORN/STROBE - EXACT LOCATION AND HEIGHT AS PER FIRE DEPARTMENT			
RA	NEW REMOTE ANNUCIATOR			

	RECEPTACLE OUTLET		LIGHTING OUTLETS
$\bigcirc$	DUPLEX, 110V	ORDL	INCANDESCENT RECESSED DOWN LIGHT
$\bigcirc$	DUPLEX, 110V, SPLIT WIRED		INCANDESCENT SUSPENDED LIGHT
<u> </u>	DUPLEX 110V FLOOR MOUNTED		INCANDESCENT LIGHT AND FAN
	DUPLEX, 110V, WEATHERPROOF	E	EXHAUST FAN
<b>⊕</b> GFI	DUPLEX, 110V, GROUND FAULT		INCAND., WEATHERPROOF WALL SCONCE
	SPECIAL PURPOSE, 110V		INCAND., EXT WEATHERPROOF FLOOD
	SINGLE, 220V		INCANDESCENT SURFACE MOUNTED LIGHT
		$\longleftrightarrow$	FLUORESCENT, DOUBLE TUBE
MISCELLANEOUS OUTLETS			INCAND., WEATHERPROOF LIGHT WITH MOTION DETECTOR
_		<u>← P3</u> →	FLUORESCENT, "PRISMATIC", 3 SIDED
€	FAN	<u>← ₹2</u>	FLUORESCENT, "PRISMATIC", 2 SIDED
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18 Lincoln Street, Hyde Park, MA 02136

Title:			
	SECOND & THIRD FLOOR ELECTRICAL PLANS		
Scale:	1/4"=1'-0"		
Revisions:			
Drawn by:	BLS		
Approved by:	НР		
Project No.:			
Date:	2-2-18		
Drawing No.:			

**E2.0**