PROPOSED ADDITION & RENOVATION

19 CHESHIRE STREET, JAMAICA PLAIN, MASSACHUSETTS 02130

GENERAL NOTES

1. THE CONTRACTOR IS RESPONSIBLE FOR OBTAINING AND PAYING

2. THE CONTRACTOR IS SOLELY RESPONSIBLE FOR MEANS, METHODS,

3. ALL WORK SHALL BE PERFORMED IN CONFORMANCE TO THE MASSACHUSETTS STATE BUILDING CODE AND ALL OTHER APPLICABLE CODES AND LAWS.

4. THE CONTRACTOR SHALL VISIT THE SITE AND BE THOROUGHLY AQUATINTED WITH THE PROJECT PRIOR TO SUBMITTING A PRICE. ADDITIONAL MONEY WILL NOT BE GRANTED FOR WORK NOT

5. THE CONTRACTOR SHALL REPORT ANY DISCREPANCIES BETWEEN DRAWINGS SPECIFICATIONS OR FIELD CONDITIONS TO THE

6. THE CONTRACTOR IS RESPONSIBLE FOR REPAIRING ANY WORK DAMAGED BY HIS FORCES WHILE PERFORMING THIS CONTRACT. 7. THE CONTRACTOR SHALL WARRANTEE HIS WORK FOR A PERIOD OF ONE YEAR FROM THE DATE OF FINAL COMPLETION.

FOUNDATION NOTES:

- 1. ALL FOUNDATION FOOTINGS SHALL BE CARRIED DOWN TO A MINIMUM OF 4'-0" BELOW FINISH GRADE, OR DEEPER, IF NECESSARY, TO OBTAIN A SAFE SOIL BEARING PRESSURE OF 2 TONS PER SQUARE FOOT, FOUNDATION DESIGN IS BASED ON ASSUMED SOIL BEARING CAPACITY OF
- 2. ALL FOOTINGS SHALL BE PLACED ON UNDISTURBED SOIL; OR, ON ENGINEERED BANK RUN GRAVEL FILL MATERIAL WITH A MINIMUM DRY
- ALL FOOTING SHALL BE POURED IN THE DRY ONLY.
- 4. NO FOOTING SHALL BE POURED ON FROZEN GROUND. 5. THE MINIMUM REINFORCING FOR ALL FOUNDATION WALLS SHALL BE 2-#6 BARS AT THE TOP AND BOTTOM, CONTINUOUS;
- OR, AS SHOWN ON DRAWINGS.
- 6. LAP ALL BARS 40 DIAMETERS AND PROVIDE CORNER BARS. 7. ALL REINFORCEMENT: ASTM A615-60, WWF A185.

CONCRETE NOTES:

- 1. ALL CONCRETE SHALL ATTAIN A MINIMUM COMPRESSIVE STRENGTH OF 3,000 PSI.
- 2. MAXIMUM SLUMP SHALL NOT EXCEED 3"; AND MAXIMUM; COARSE AGGREGATE SIZE SHALL NOT EXCEED 3/4" IN DIAMETER.
- 3. ALL CONCRETE SLABS SHALL BE POURED IN 900 SQUARE FOOT PANELS, MAXIMUM; OR, PROVIDE CONTROL JOINTS BY SAW CUTTING THE SLAB WHILE THE CONCRETE IS STILL GREEN.

STEEL NOTES:

1. ALL COLUMNS: A36, STEEL PIPE, A46 STEEL TUBE.

2. BOLTS: A325. ANCHOR BOLTS: A307.

WOOD LINTEL SCHEDULE:

Lintels over openings in bearing walls shall be as follows; or as noted on drawings. Size: 2v6 stude Size: 2x4 studs

| Span or | opening. | Size. 2x0 studs | Size. 2x |
|-----------|----------|-----------------|----------|
| less that | n 4'-0" | 3 - 2x4 | 2 - 2x4 |
| up to | 6'-0" | 3 - 2x6 | 2 - 2x6 |
| up to | 8'-0" | 3 - 2x8 | 2 - 2x8 |
| up to | 10'-0" | 3 - 2x10 | 2 - 2x10 |
| | | | |

WOOD NOTES:

- ALL LUMBER SHALL HAVE A MOISTURE CONTENT OF NOT MORE THAN 19%.
- ALL FRAMING LUMBER SHALL BE #2 HEM-FIR, OR BETTER, HAVING A MINIMUM: FB=1,200 PSI, FV=140 PSI, E=1,300,000 PSI.
- 3. ALL L.V.L. LUMBER DENOTED ON PLANS SHALL HAVE A MINIMUM: FB=2,600 PSI, FV=285 PSI, E=1,900,000 PSI.
- 4. ALL JOIST SPANS SHALL HAVE ONE ROW OF 1" X 3: CROSS BRIDGING AT MID SPAN AND NOT MORE THAN 8'-O" O.C.
- 5. ALL STUD BEARING WALLS SHALL HAVE ONE ROW OF 2X HORIZONTAL BLOCKING AT 1/2 STUD HEIGHT, AND NOT MORE THAN 6'-O" O.C. MAXIMUM
- 6. PROVIDE AND INSTALL ALL NECESSARY TIMBER CONNECTORS WITH ADEQUATE STRENGTH.
- PROVIDE DOUBLE JOIST BELOW PARTITIONS PARALLEL TO JOIST FRAMING.
- PROVIDE SOLID BRIDGING BELOW PARTITIONS PERPENDICULAR TO JOIST FRAMING.
- 9. PROVIDE SOLID BRIDGING BETWEEN JOIST FRAMING MEMBERS WHEN BEARING ON STUD PARTITIONS OR BEAMS.
- 10. PROVIDE A CONTINUOUS BAND JOIST AT EXTERIOR STUD WALLS.
- 11. PROVIDE DIAGONAL METAL STRAP BRACING AT ALL CORNERS AND WALL INTERSECTIONS, AT THE INSIDE FACE OF STUDS, FROM TOP PLATE TO FLOOR PLATE AT 45°, SIMPSON TYPE "CWB", OR EQUAL
- 12. ALL BUILT-UP BEAMS SHALL BE BOLTED WITH 1/2" DIAMETER BOLTS, MEETING A307 STANDARDS, OR, AS NOTED ON DRAWINGS.

REINFORCING NOTES:


- 1. ALL REINFORCEMENT, EXCEPT FOR TIES AND STIRRUPS, SHALL CONFORM TO ASTM 615-60
- 2. ALL REINFORCEMENT FOR TIES AND STIRRUPS SHALL CONFORM TO ASTM 615-40.
- 3. ALL WELDED WIRE FABRIC SHALL CONFORM TO ASTM A185-70 SPECIFICATIONS.
- 4. ALL REINFORCEMENT SHALL BE INSPECTED AND APPROVED BY THE ARCHITECT OF HIS ENGINEER PRIOR TO THE PLACEMENT OF ANY CONCRETE
- 5. THE CONTRACTOR SHALL SUBMIT A REPRODUCIBLE SEPIA AND FOUR PRINTS OF SHOP DRAWINGS: SHOWING ALL REINFORCING DETAILS, CHAIR BARS, HIGH CHAIRS, SLAB BOLSTERS, ETC. TO THE ARCHITECT FOR HIS APPROVAL. THE CONTRACTOR SHALL RECEIVE WRITTEN APPROVED SHOP DRAWINGS FROM THE ARCHITECT OR HIS ENGINEER PRIOR TO THE FABRICATION OF REINFORCEMENT.

3 INCHES

- 6. CLEARANCES OF MAIN REINFORCING FROM ADJACENT CONCRETE SURFACES
- SHALLL BE AS FOLLOWS:
- A. FOOTINGS
- B. SIDES OF FOUNDATIONS WALLS EXPOSED FACES OF FOUNDATIONS. SIDES OF COLUMNS/PIERS, SLABS
- ON GRADE FROM TOP SURFACE 2 INCHES
- C. INTERIOR FACES OF FOUNDATIONS, TOP REINFORCING IN SLABS EXPOSED
- TO THE WEATHER 1-1/2 INCHES
- D. TOP STEEL OF INTERIOR SLABS 1 INCHES
- 7. MAXIMUM DEVIATION FROM THESE REQUIREMENTS SHALL BE 1/4" OF SECTIONS 10" OR LESS, 1/2" FOR SECTIONS GREATER THAN 10".

3F-5000 SUBDISTRICT

NDOD OVERLAY

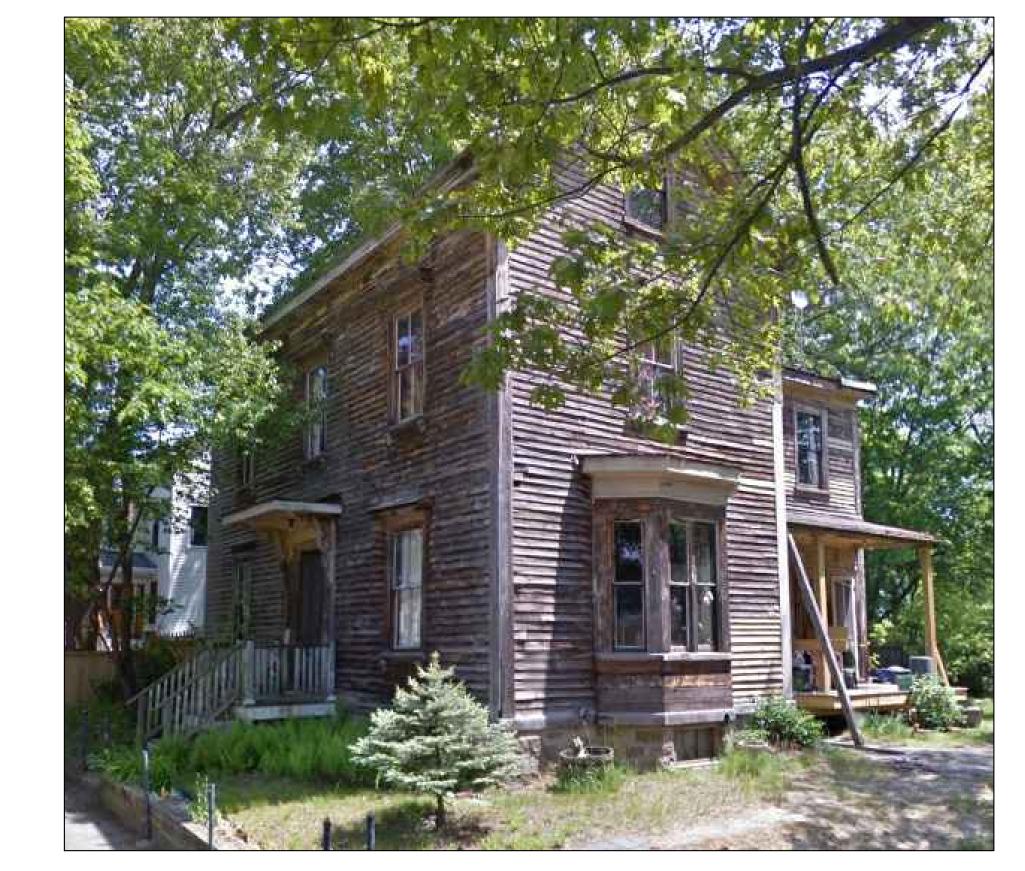

One Billings Road Quincy, MA 02171

Revision Date

6-5-17

17068 'roject No: AS NOTED 05-27-16

rawing Name

rawn By:

Sheet No.

COVER

SOIL TESTING

CODE SUMMARY

EX'G R-3 USE GROUP (ONE-FAMILY)

EX'G 2 1/2 STORIES & BASEMENT

PROPOSED R-3 (TWO-FAMILY)

EX'G TYPE 5 CONSTRUCTION

EX'G NON-SPRINKLERED

KEY

FE

SMOKE DETECTOR

CARBON MONOXIDE DETECTOR

1 HOUR CLG. ABOVE (SEE C.T.1/A-3.1)

2 HOUR CLG. WALL(SEE C.T.2/A-3.1)

HEAT DETECTOR

1 HOUR WALL

2 HOUR WALL

45 MIN. DOOR

1-1/2 HOUR DOOR

FIRE EXTINGUISHER

EX'G WALL TO REMAIN

WALL TO BE REMOVED

WINDOW TYPE

NEW WALL

FAN

CAPACITY. SOIL BORINGS SHOULD BE PERFORMED TO VERIFY THAT THE

PROPOSED 2 STORIES & BASEMENT SHEET


ZONE: 3F-5000


NOTE: THERE HAS BEEN NO SOIL TESTING PROVIDED TO THIS OFFICE FOR THIS PROJECT. THE SOIL BEARING CAPACITY OF THIS FOUNDATION SYSTEM AS DESIGNED IS BASED ON A 2 TON MINIMUM SOIL BEARING MINIMUM DESIGN BEARING CAPACITIES ARE ACHIEVABLE. IF A SUITABLE SOIL THAT CAN NOT WITHSTAND A 2 TON BEARING CAPACITY IS NOT AVAILABLE, THAN THIS OFFICE SHOULD BE CONTACTED BY THE CONTRACTOR OR OWNER FOR A FOUNDATION REDESIGN.


ZONING SUMMARY


| SEMI-ATTACHED DWELLING | MIN. LOT SIZE | MIN. LOT AREA ADD'L | TOTAL LOT SIZE | LOT WIDTH/ FRONTAGE | FAR | BLDG. HEIGHT | USABLE OPEN SPACE | FRONT | SETBACKS SIDE | REAR | MAX USE REAR YARD |
|---------------------------|------------------|------------------------|-------------------|------------------------|--------------------|-------------------------------|--|--------------------|------------------|--------|----------------------|
| REQUIRED BY ZONING | 3000 S.F. | 2000 S.F. PER UNIT | 5000 S.F. | 40' | .6 | 35'/ STORIES | 750 S.F./UNIT + 500 S.F. & 25% 750 S.F. + 287 = 1037 S.F. 500 S.F. + 287 = 787 S.F. TOTAL 1,824 S.F. | 15'/ MODAL | 7' / 10' | 20' | 25% |
| EXISTING CONDITIONS | | | 6,148 S.F. | 72.37' | 3175 / 6148 .51 | 29'-3" / ² STORIES | 4578 S.F. TOTAL | MODAL | 3'-4" / 29'-9" | 34'-8" | 1 0% |
| PROPOSED PROJECT | | | 6,148 S.F. | 72.37' | 3657 / 6148 .59 | 29'-3" 2 STORIES | 2941 S.F. TOTAL | MODAL NO CHANGE | 11'-4" / 30'-4" | 22'-7" | 0% |

ARTICLE 55

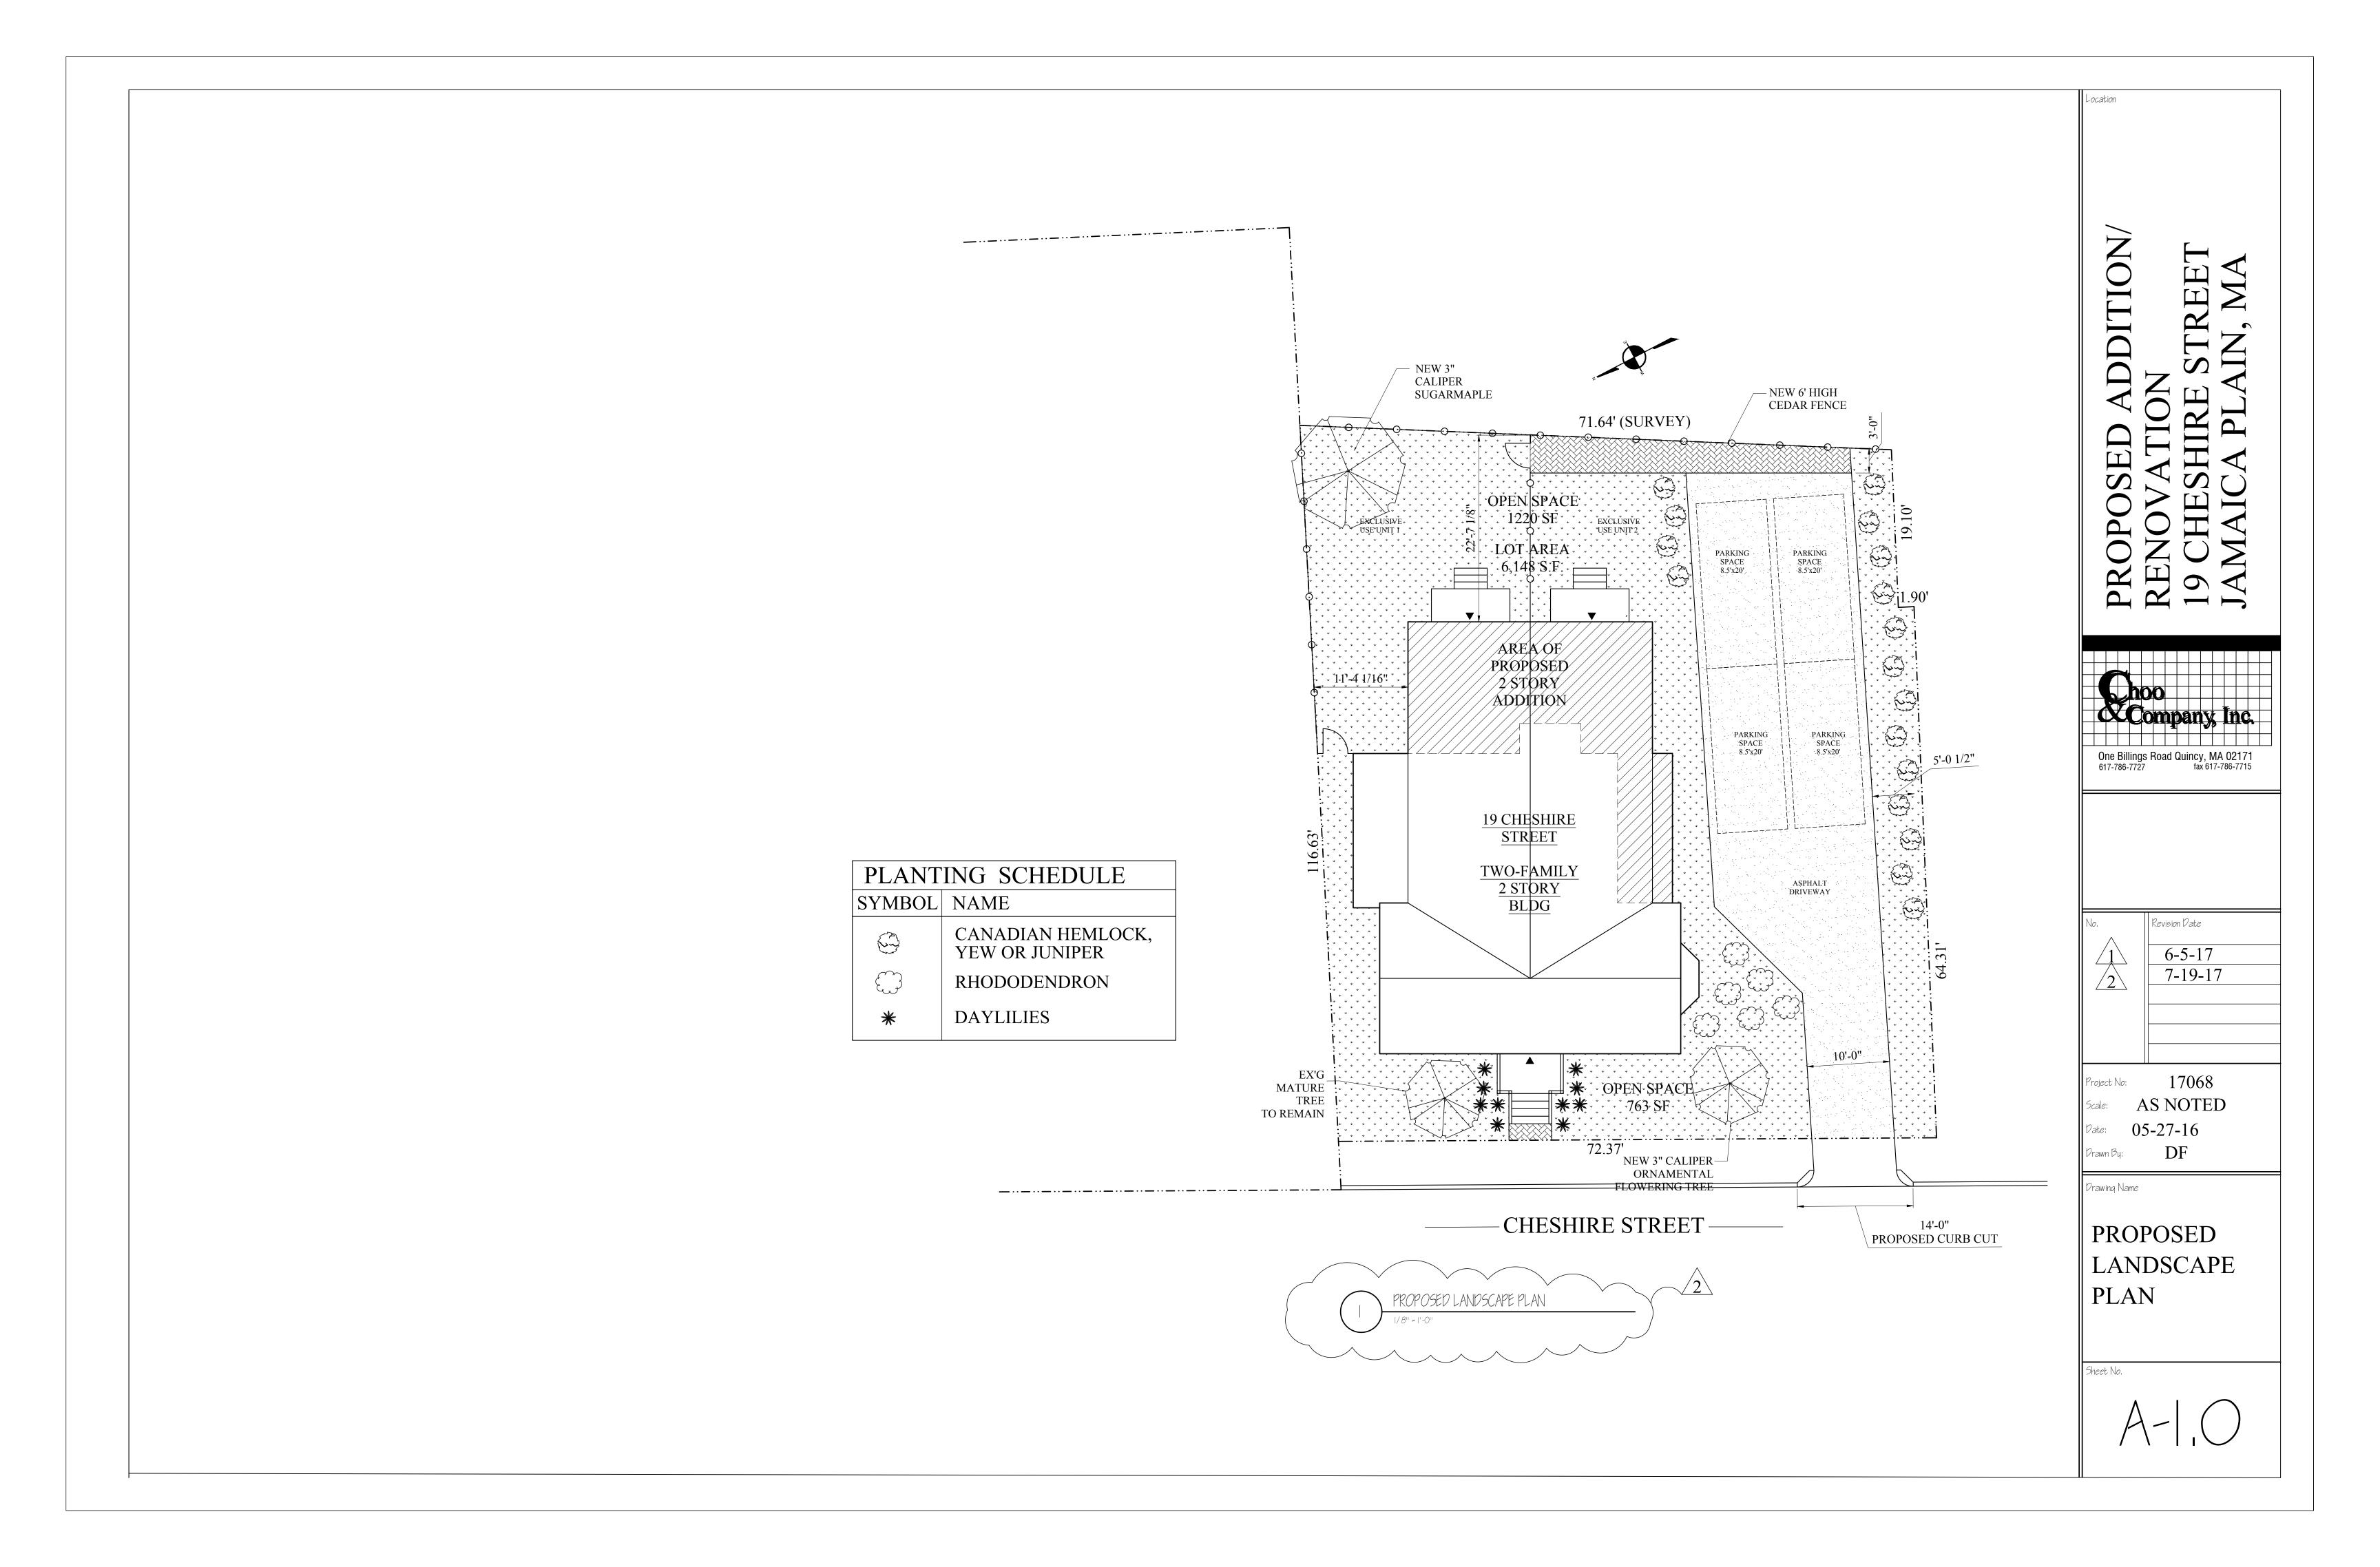


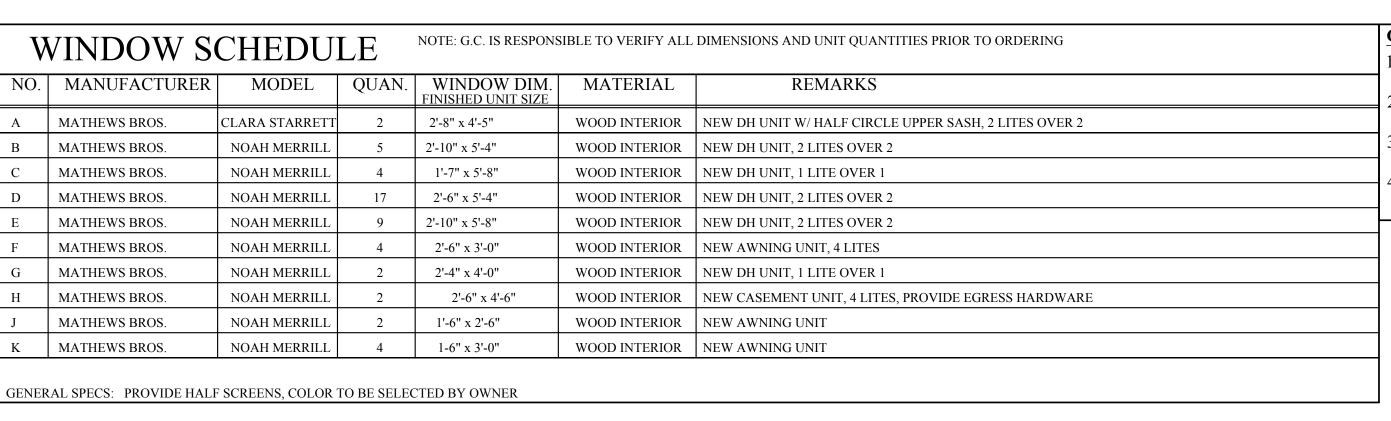

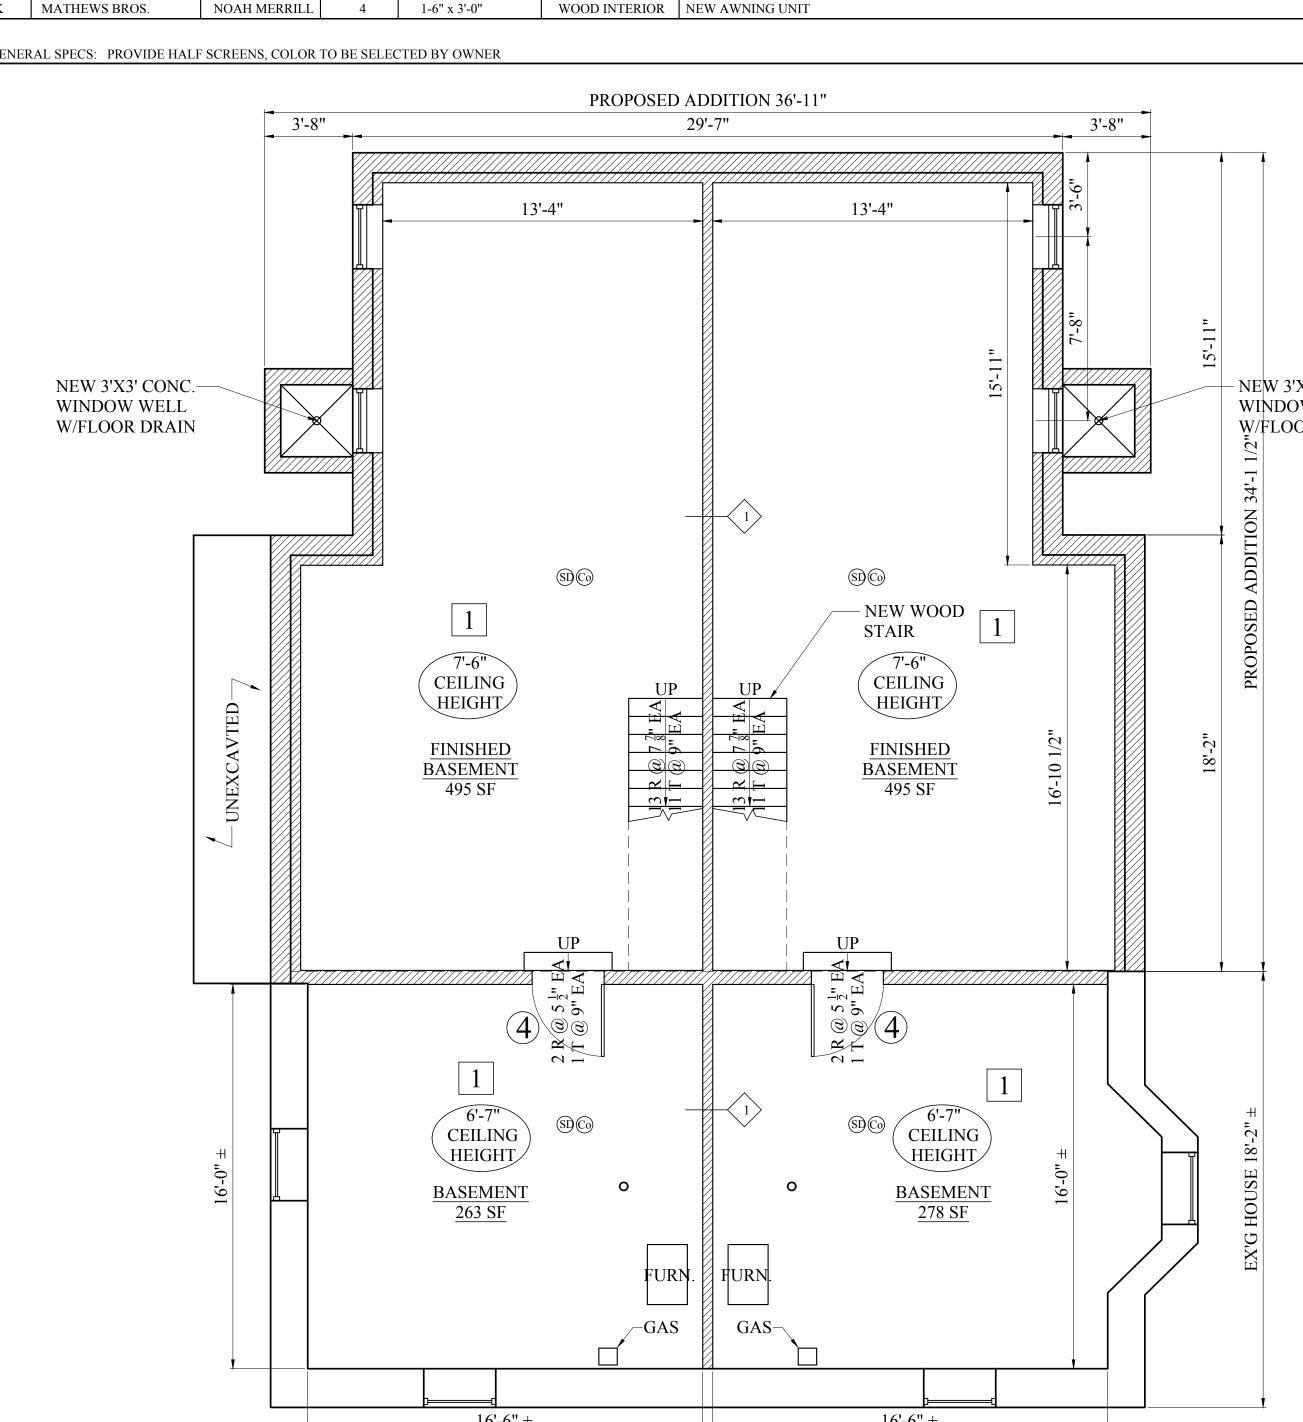


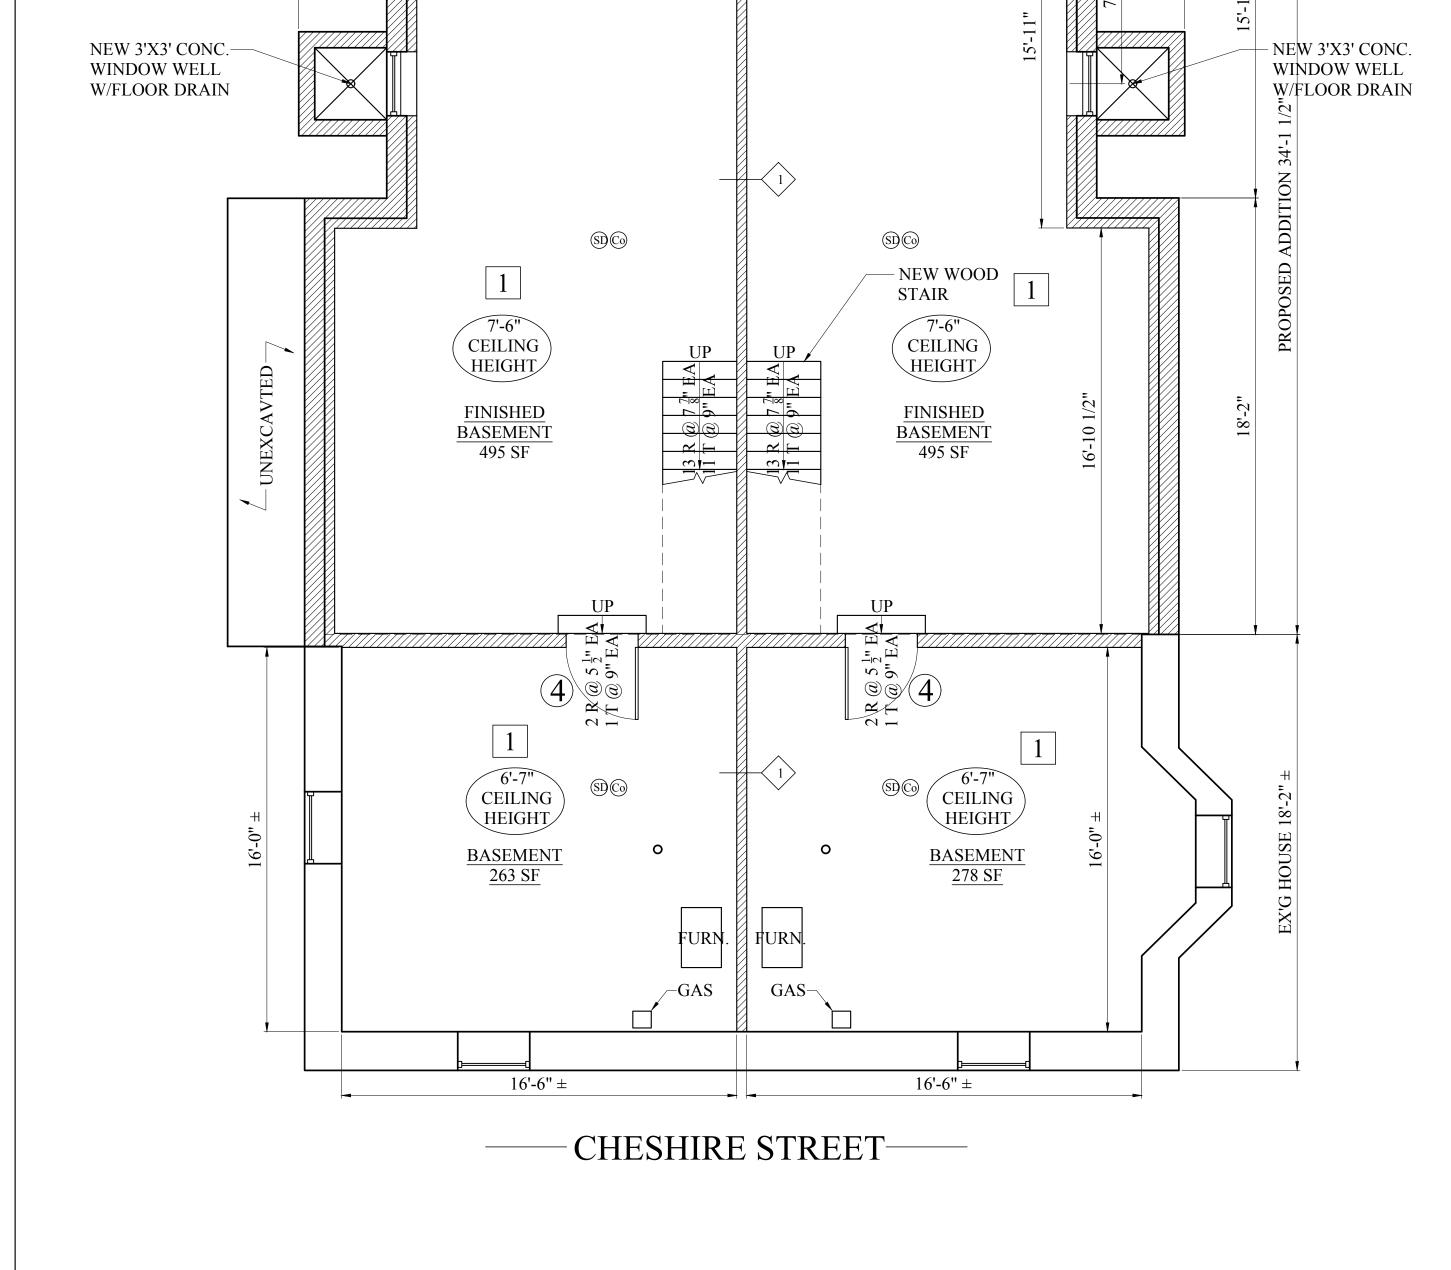

PROPOSED BASEMENT FLOOR PLAN

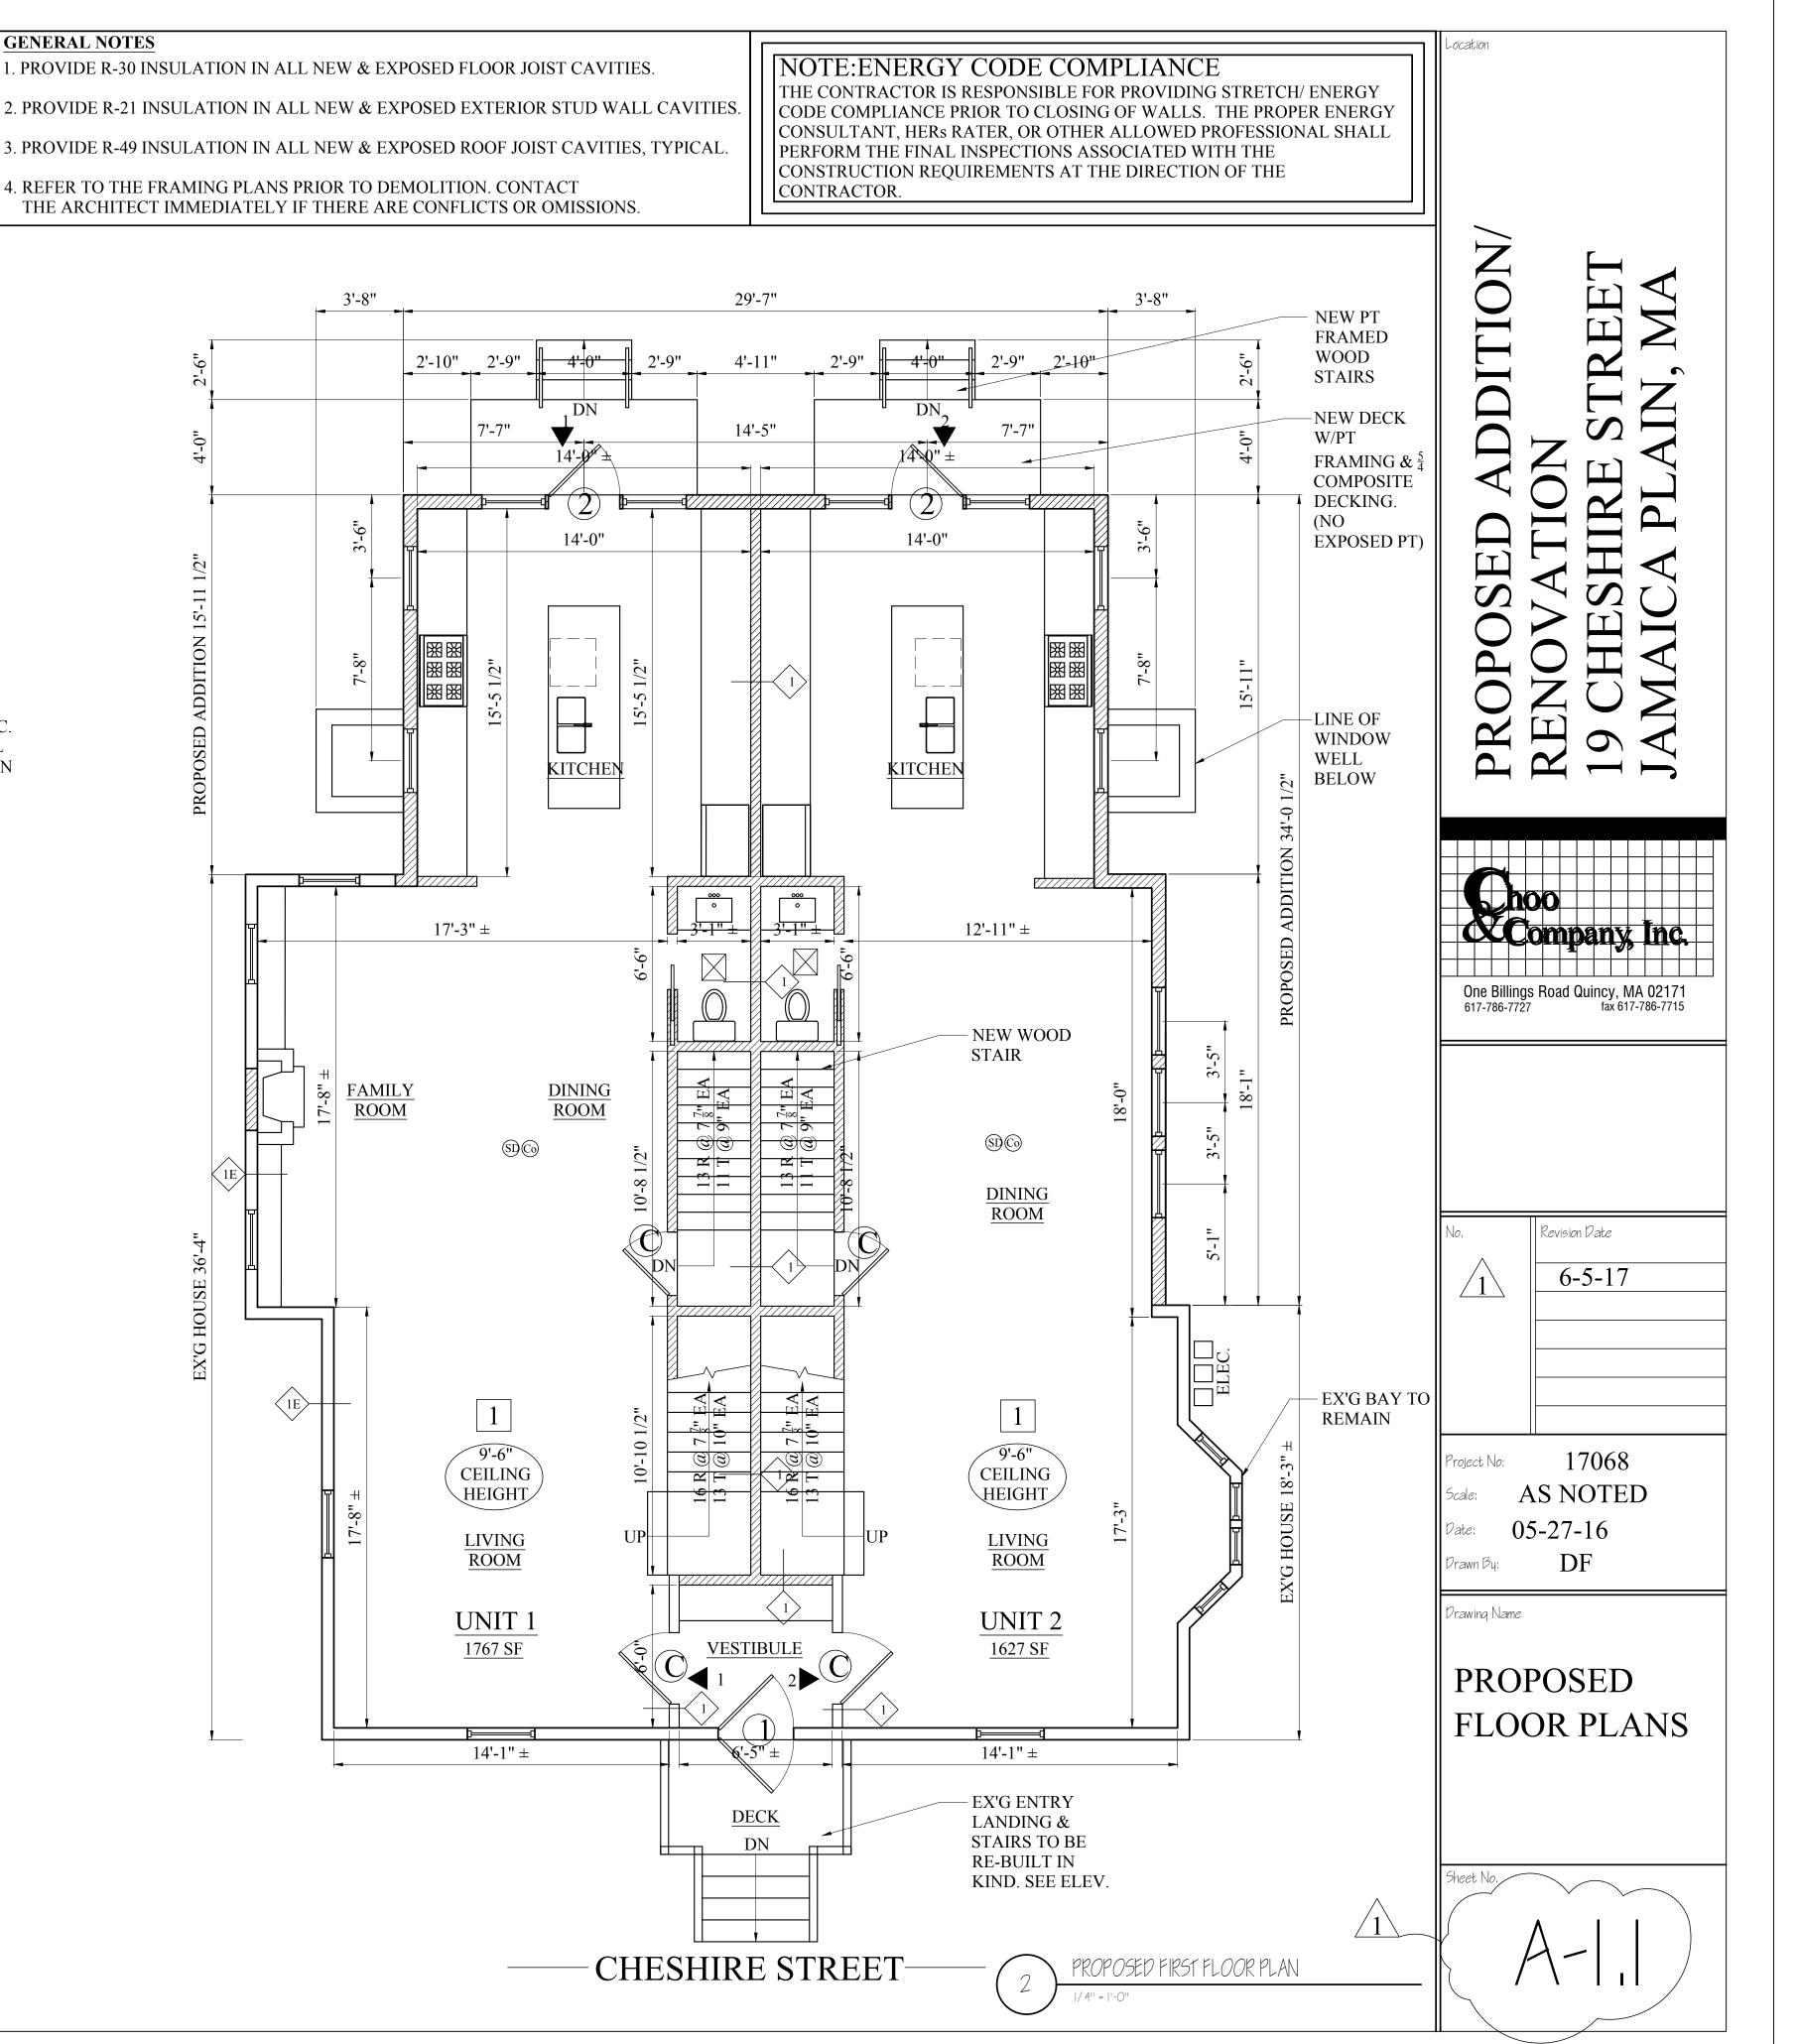

| DO | DOOR & OPENING SCHEDULE NOTE: GC TO CONFIRM SIZES & QUANTITIES PRIOR TO ORDERING | | | | | | |
|---------|---|------------------|---------|-------|---------|--------------|--|
| NO. | SIZE | MATERIAL | RATING | FRAME | TYPE | HARDWARE | REMARKS |
| C3'-0' | x 6'-8" x 1 3/4" | COMP. OR WOOD | 45 MIN. | WOOD | 45 MIN. | ENTRANCE | PANEL DOOR, SMOOTH FINISH, PAINTED, STYLE SELECTED BY OWNER, PROVIDE DEADBOLT |
| 1 3'-2' | x 6'-8" x 1 3/4" | FBGLS & GLASS | - | WOOD | - | ENTRANCE | FULL LIGHT DOOR & EXTERIOR SCREEN DOOR, PAINTED, STYLE SELECTED BY OWNER, PROVIDE DEADBOLT |
| 2 8'-7' | x 8'-3" x 1 3/4" | WOOD CLD & GLASS | - | WOOD | - | ENTRANCE | ENTRANCE DOOR UNIT (3'-0"x 6"-8") PAIR OF 32" SIDE LITE AND 12" FULL LITE TRANSOM |
| 3 3'-0' | x 6'-8" x 1 3/4" | FBGLS & GLASS | - | WOOD | _ | ENTRANCE | PANEL DOOR, SMOOTH FINISH, STYLE SELECTED BY OWNER, PROVIDE DEADBOLT |
| 4 3'-0' | x 6'-8" x 1 3/8" | COMP. OR WOOD | | WOOD | | STORAGE | PANEL DOOR, SMOOTH FINISH, PAINTED, STYLE SELECTED BY OWNER |
| 5 2'-8' | x 6'-8" x 1 3/8" | COMP. OR WOOD | - | WOOD | - | BED / BATH | PANEL DOOR, SMOOTH FINISH, PAINTED, STYLE SELECTED BY OWNER |
| 6 2'-6' | x 6'-8" x 1 3/8" | COMP. OR WOOD | - | WOOD | - | BED / BATH | PANEL DOOR, SMOOTH FINISH, PAINTED, STYLE SELECTED BY OWNER |
| 7(2)2'- | 0" x 6'-8" x 1 3/8" | COMP. OR WOOD | - | WOOD | | SINGLE DUMMY | PANEL DOOR, SMOOTH FINISH, PAINTED, STYLE SELECTED BY OWNER |
| 8(2)2'- | 6" x 6'-8" x 1 3/8" | COMP. OR WOOD | | WOOD | | SINGLE DUMMY | PANEL DOOR, SMOOTH FINISH, PAINTED, STYLE SELECTED BY OWNER |
| 9 2'-4' | x 6'-8" x 1 3/8" | COMP. OR WOOD | _ | WOOD | | STORAGE | PANEL DOOR, SMOOTH FINISH, PAINTED, STYLE SELECTED BY OWNER |
| 102'-6' | x 6'-8" x 1 3/8" | COMP. OR WOOD | - | WOOD | - | PASSAGE | PANEL DOOR, SMOOTH FINISH, PAINTED, STYLE SELECTED BY OWNER |
| 11 | 3'-6" x 6'-8" | - | - | WOOD | - | - | CASED OPENING |
| 12 | 16'-0" x 7'-0" | COMP. | - | WOOD | - | GARAGE | CUSTOM PANEL DOOR W/ GLASS LITES SELECTED BY OWNER |

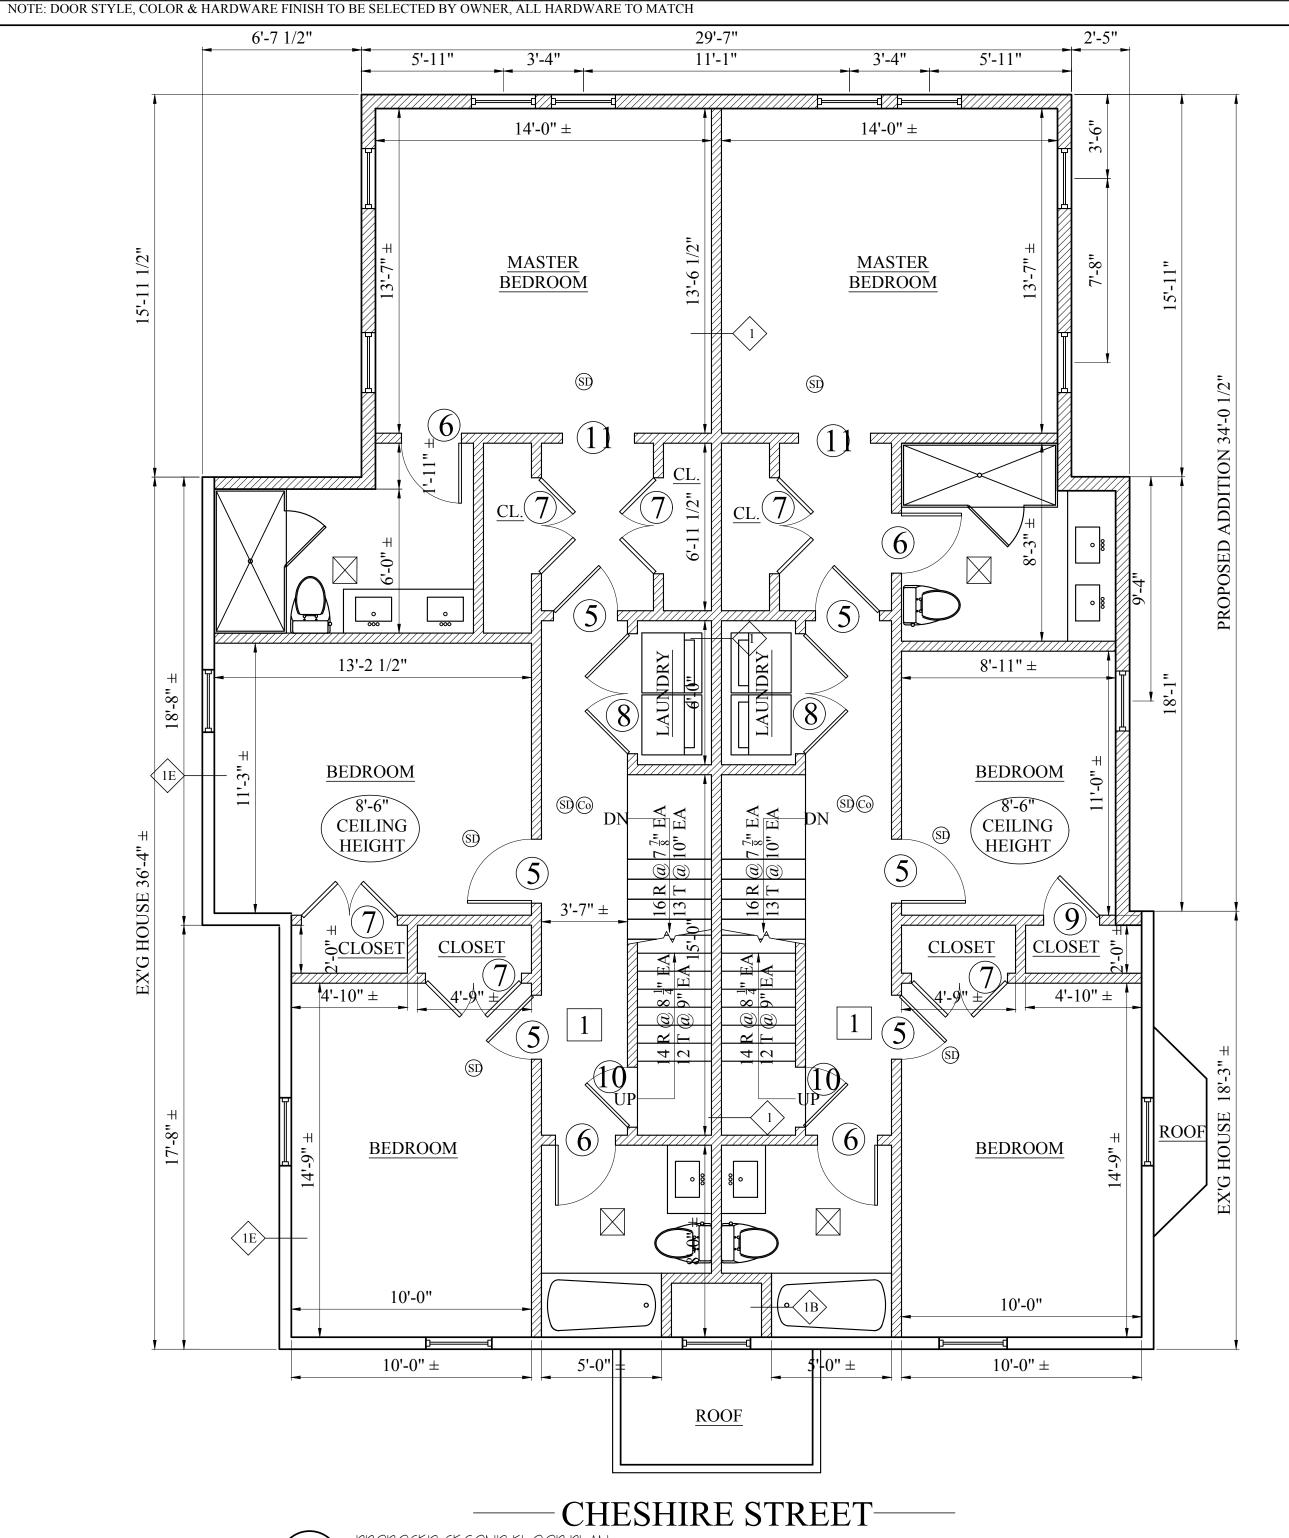

GENERAL NOTES

- 1. PROVIDE R-30 INSULATION IN ALL NEW & EXPOSED FLOOR JOIST CAVITIES.
- 2. PROVIDE R-21 INSULATION IN ALL NEW & EXPOSED EXTERIOR STUD WALL CAVITIES
- 3. PROVIDE R-49 INSULATION IN ALL NEW & EXPOSED ROOF JOIST CAVITIES, TYPICAL.
- 4. REFER TO THE FRAMING PLANS PRIOR TO DEMOLITION. CONTACT THE ARCHITECT IMMEDIATELY IF THERE ARE CONFLICTS OR OMISSIONS.

NOTE: ENERGY CODE COMPLIANCE

THE CONTRACTOR IS RESPONSIBLE FOR PROVIDING STRETCH/ ENERGY CODE COMPLIANCE PRIOR TO CLOSING OF WALLS. THE PROPER ENERGY CONSULTANT, HERS RATER, OR OTHER ALLOWED PROFESSIONAL SHALL PERFORM THE FINAL INSPECTIONS ASSOCIATED WITH THE CONSTRUCTION REQUIREMENTS AT THE DIRECTION OF THE

CONTRACTOR.

PROPOSED ADDITTION

PROPOSED ADDITTION

RENOVATION

19 CHESHIRE STREET

JAMAICA PLAIN, MA

Revision Date

6-5-17

Project No: 17068


Scale: AS NOTED

Date: 05-27-16

Drawing Name


PROPOSED FLOOR PLANS


Sheet No.

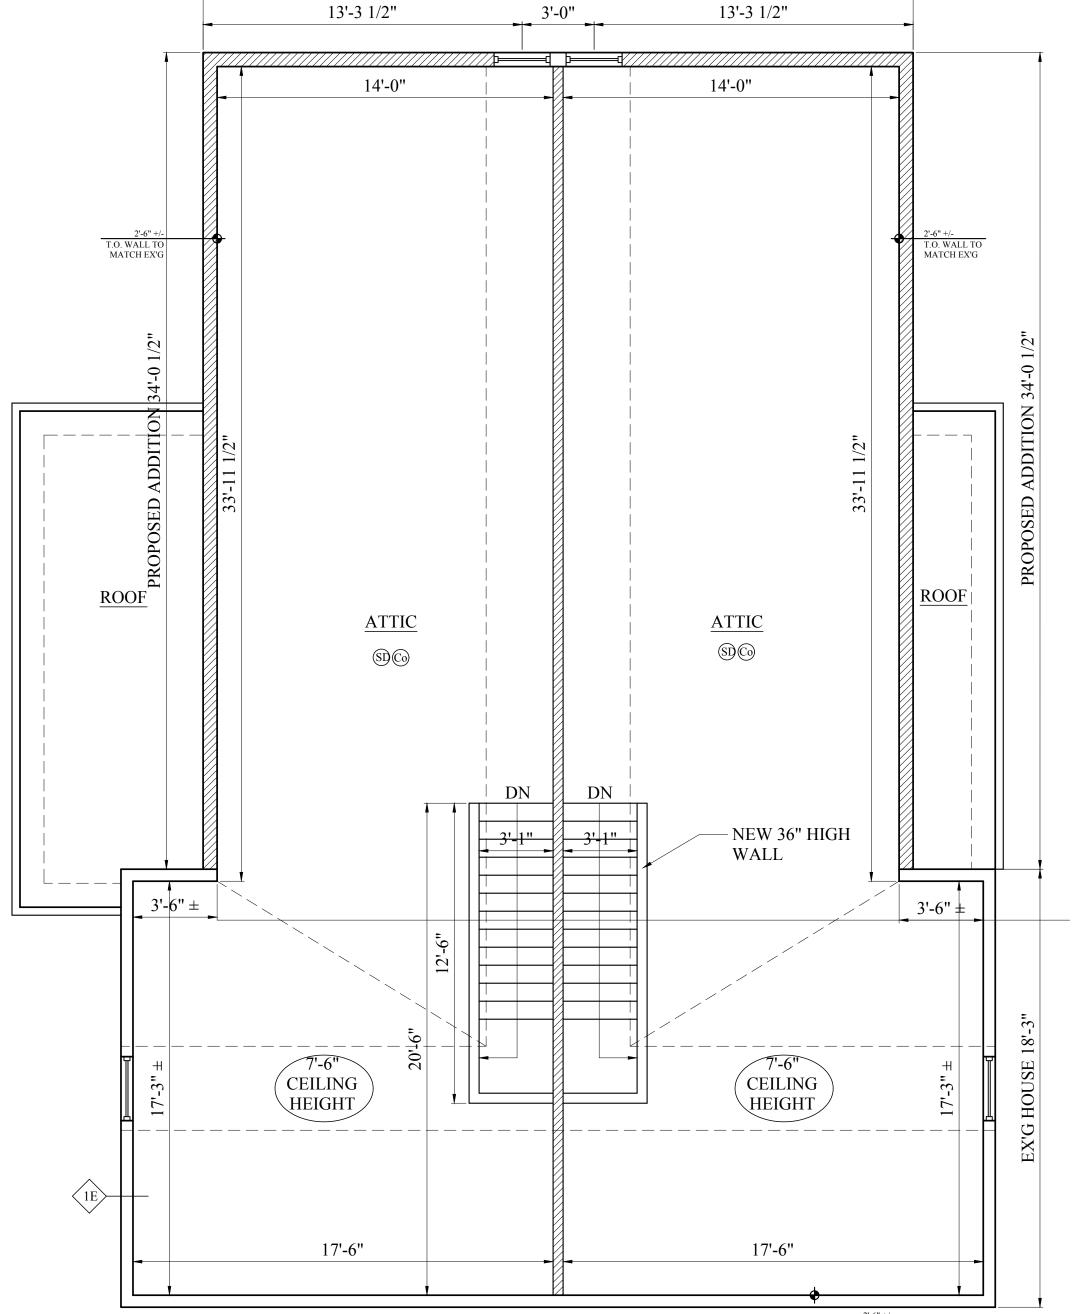


29'-7"

PROPOSED ATTIC FLOOR PLAN

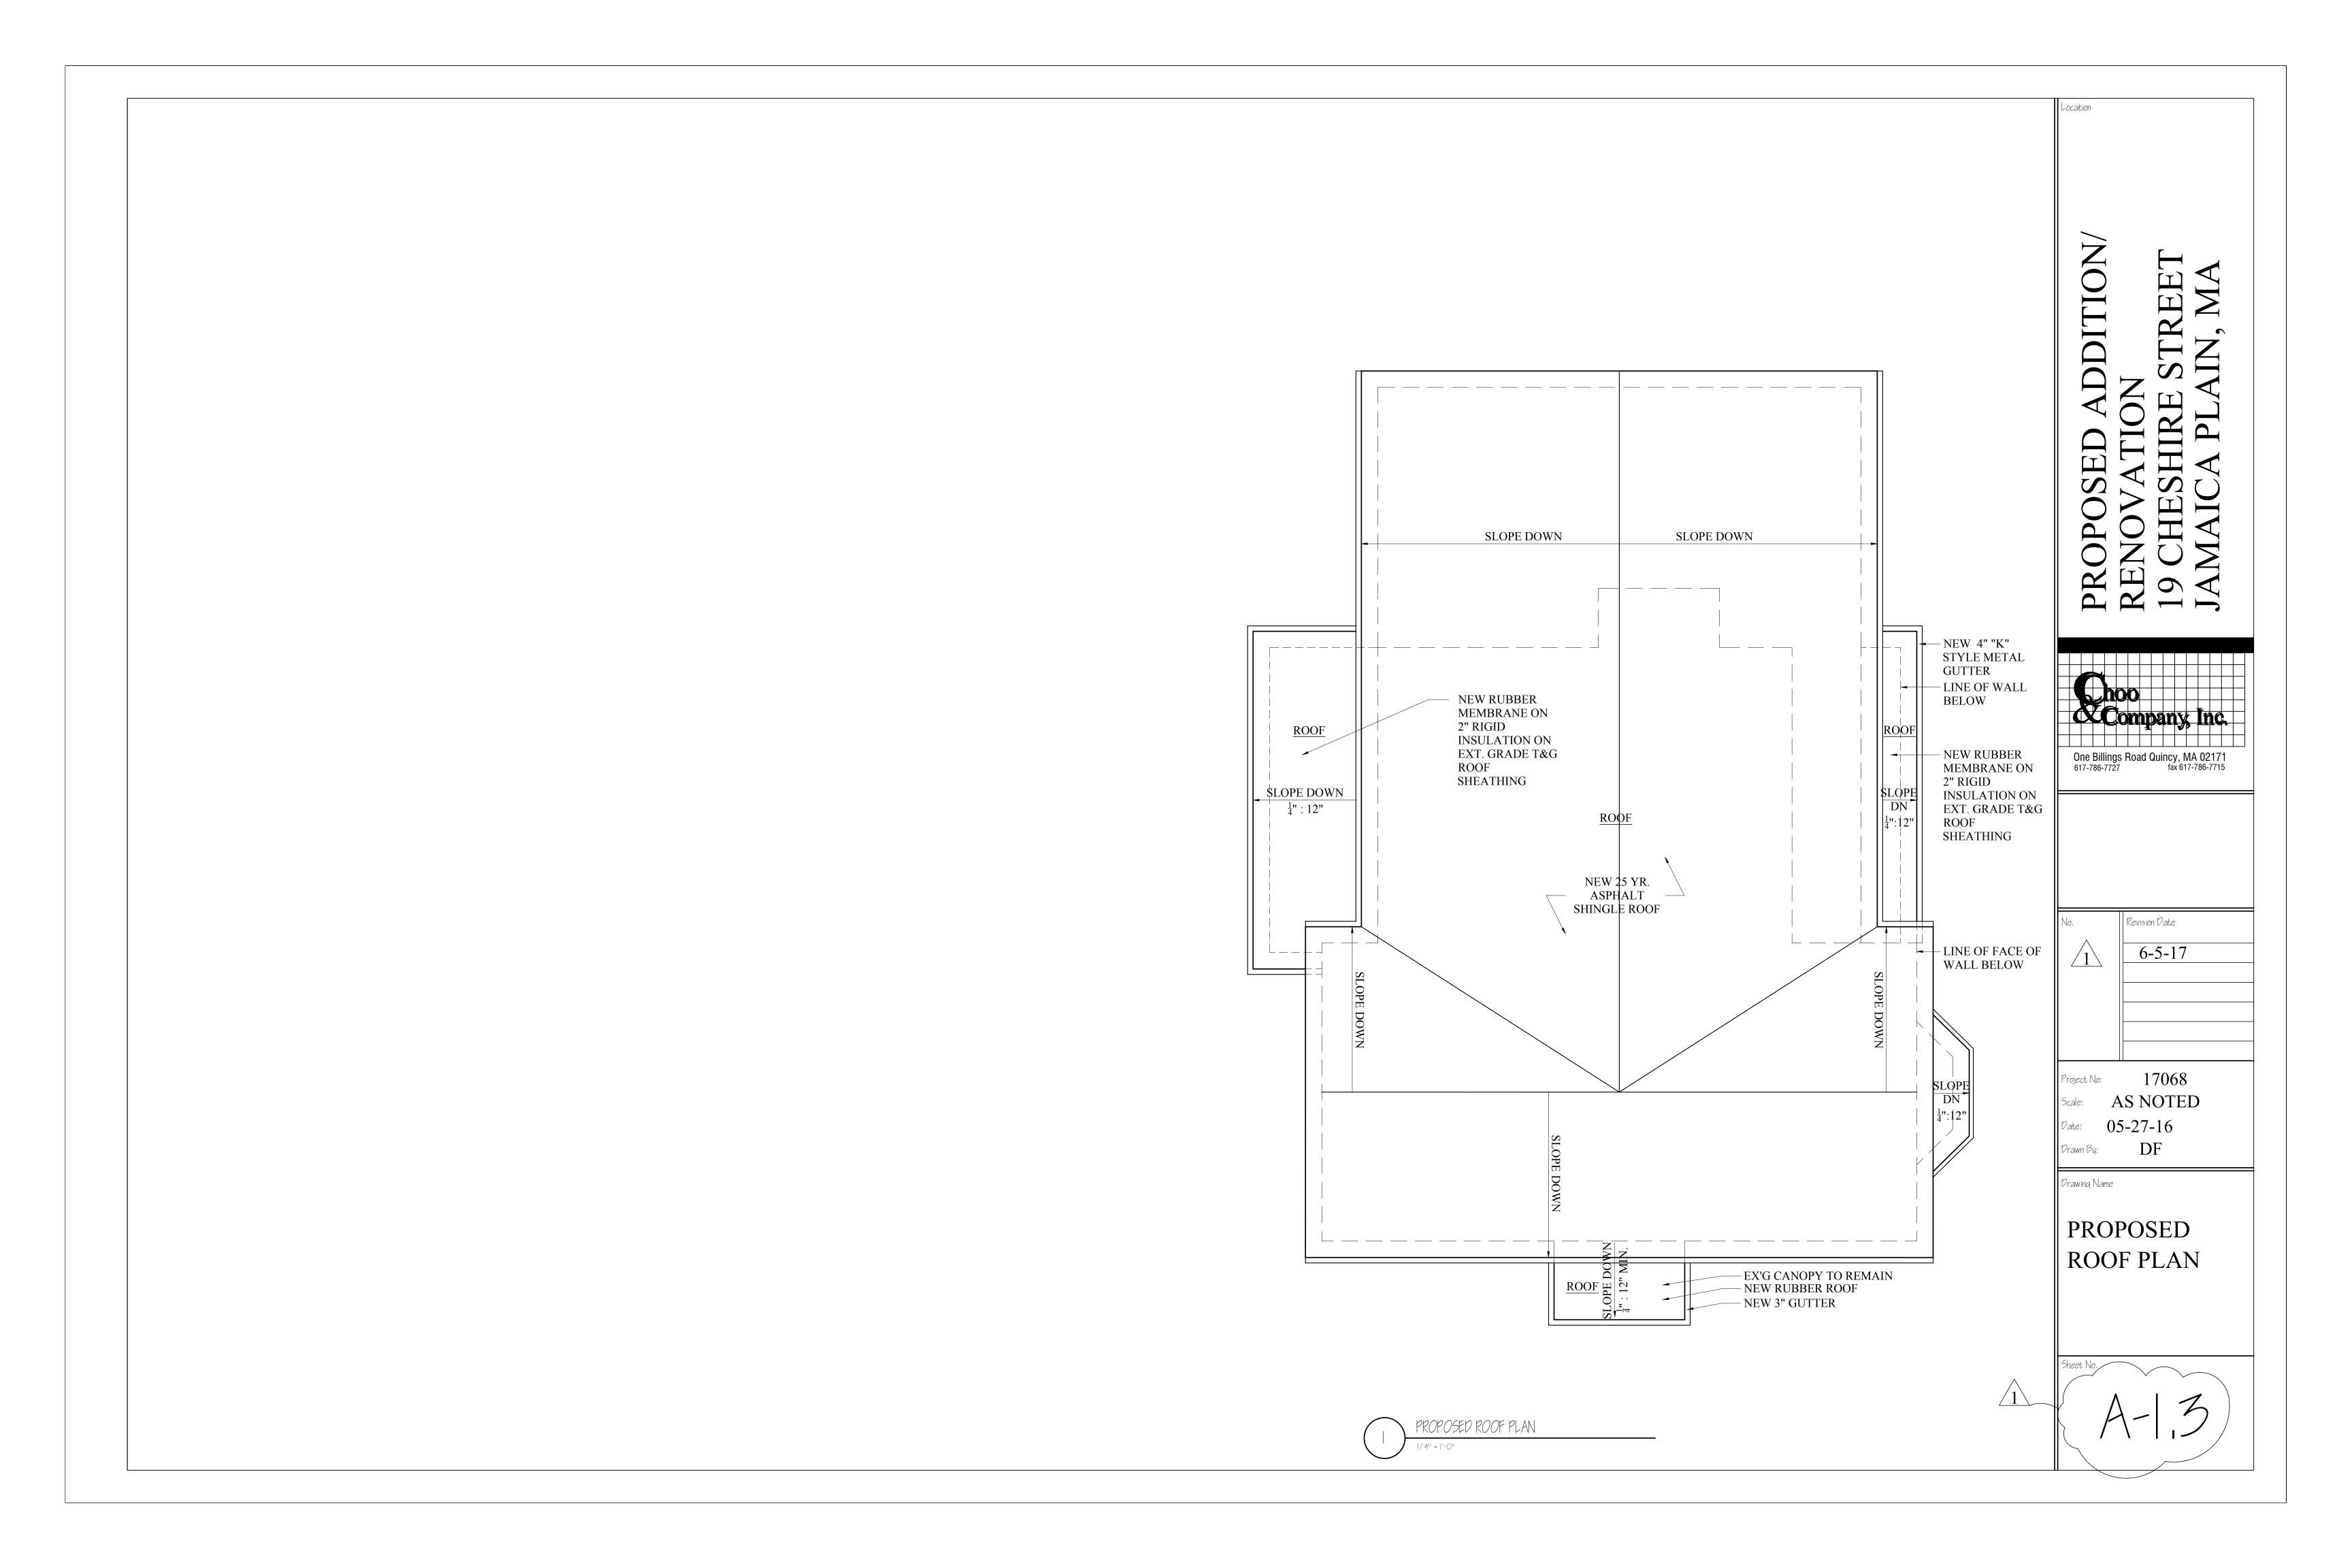

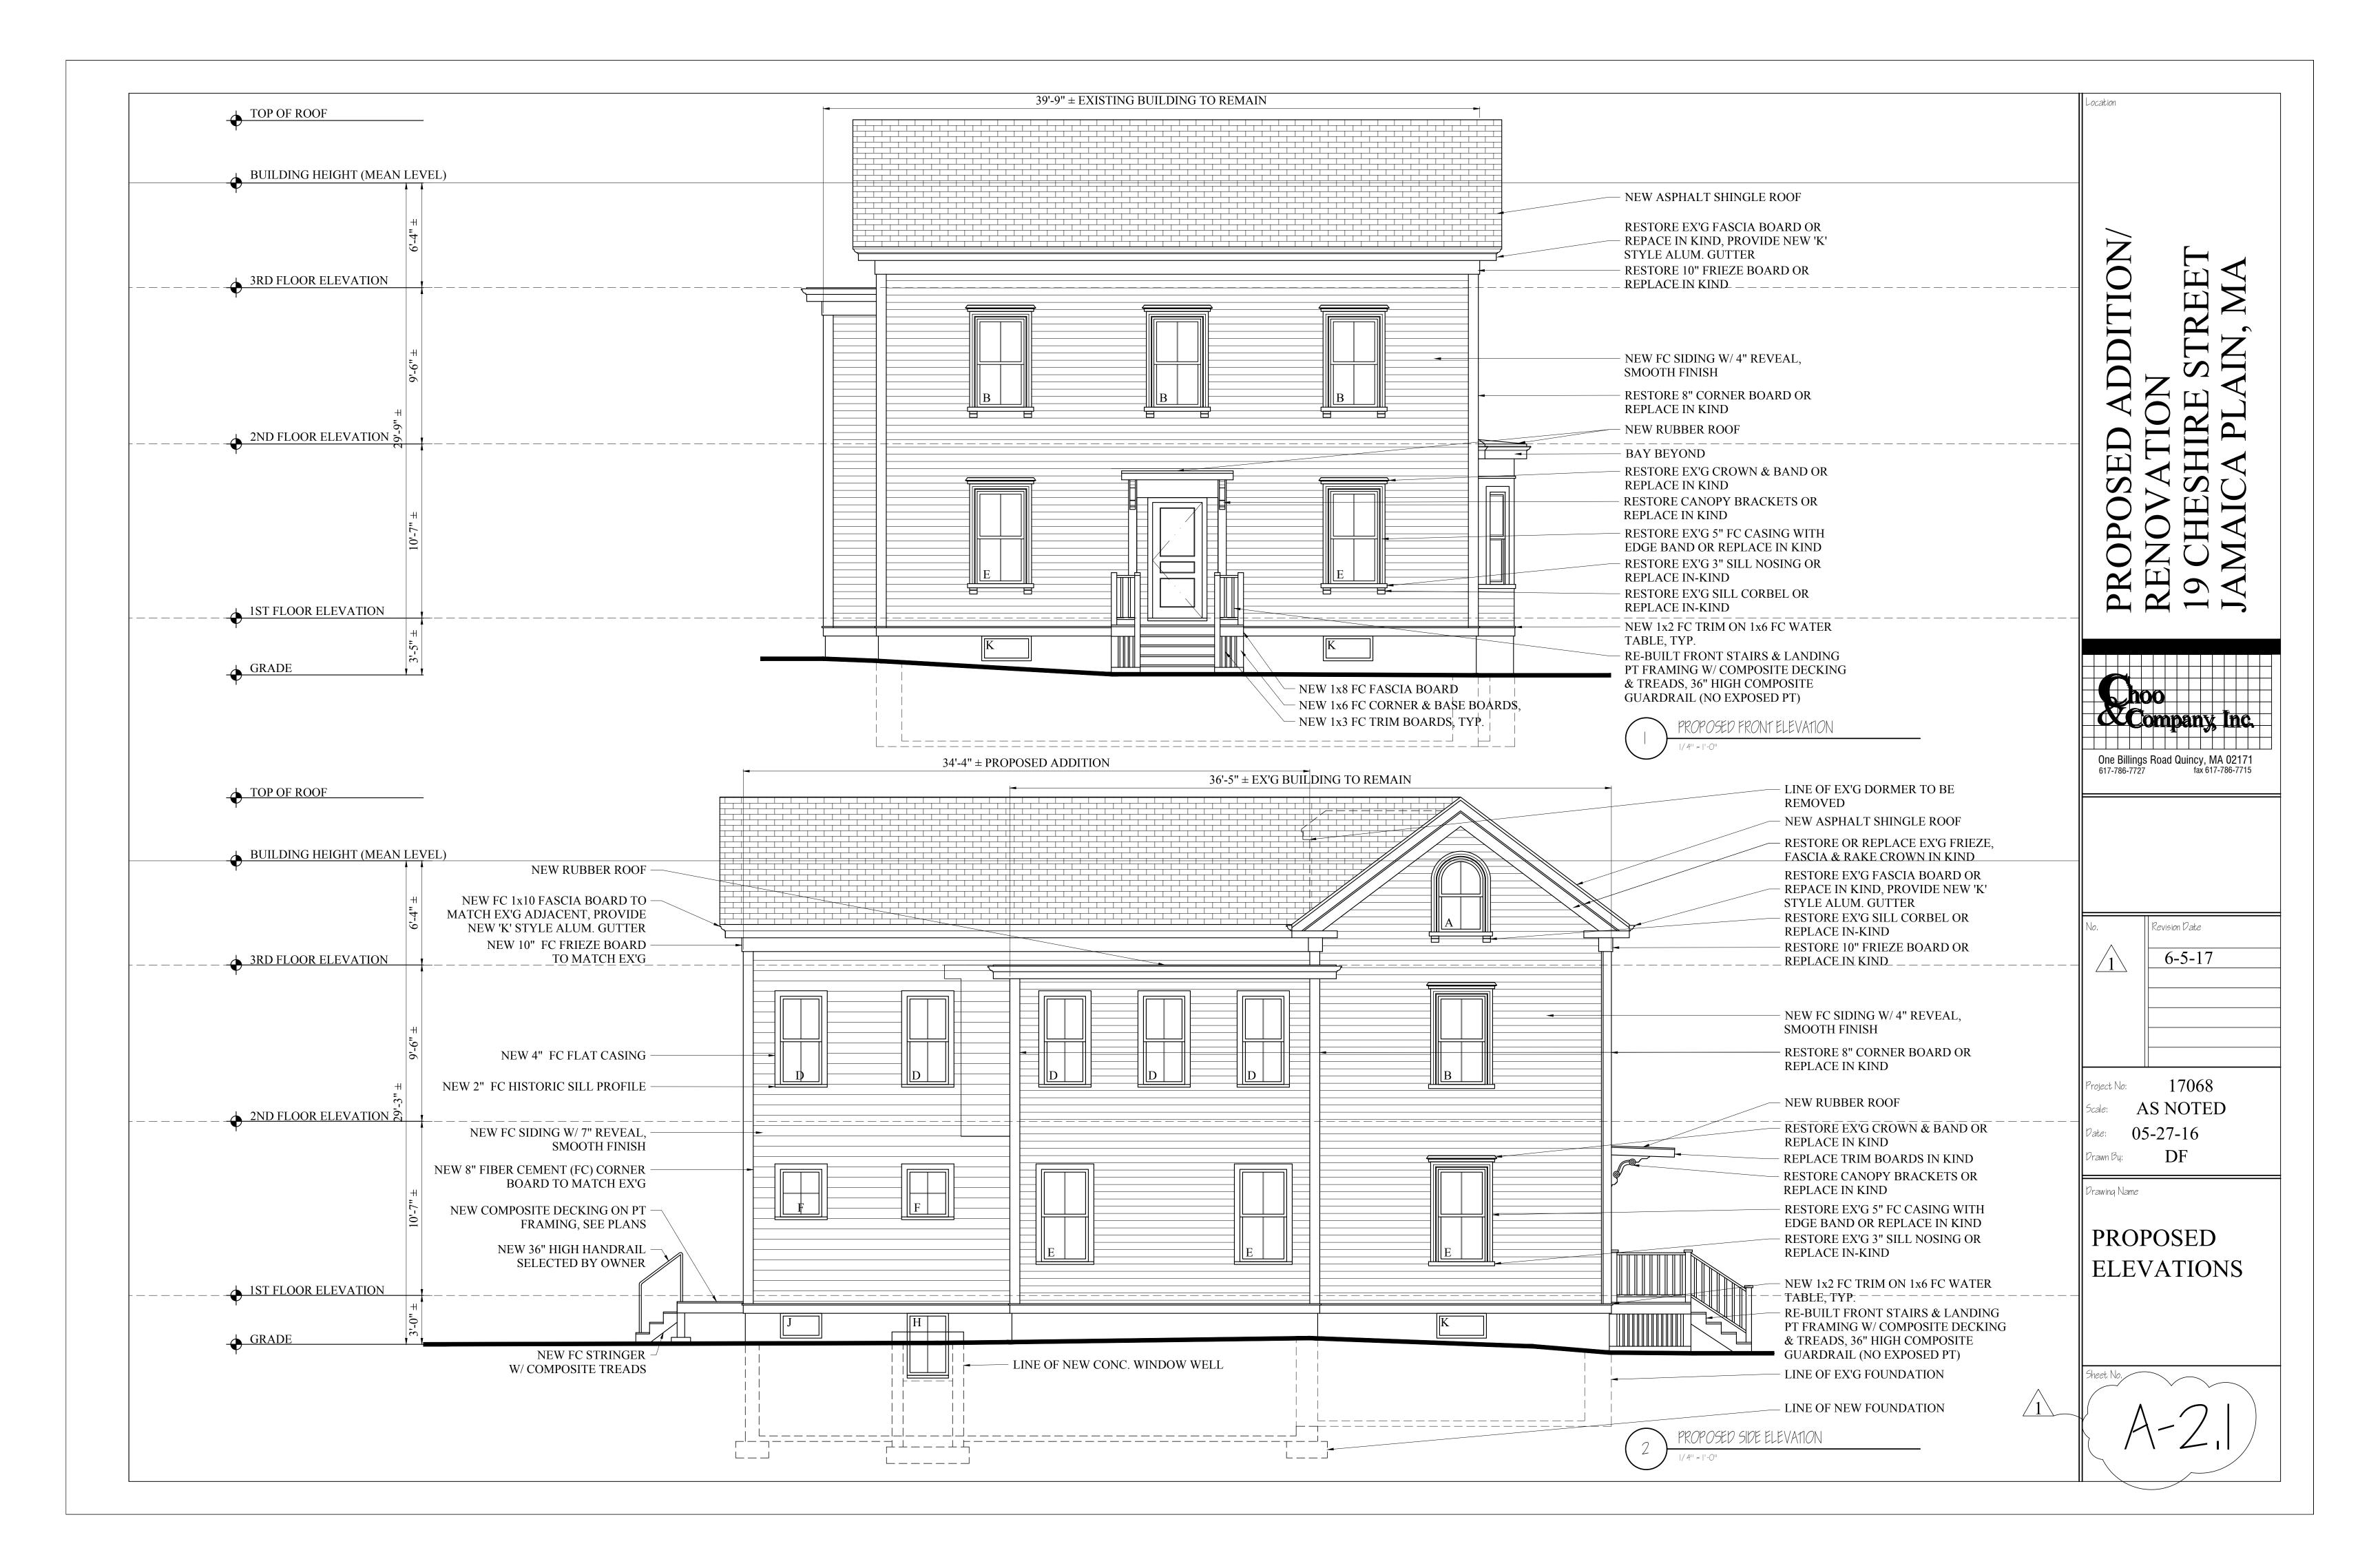





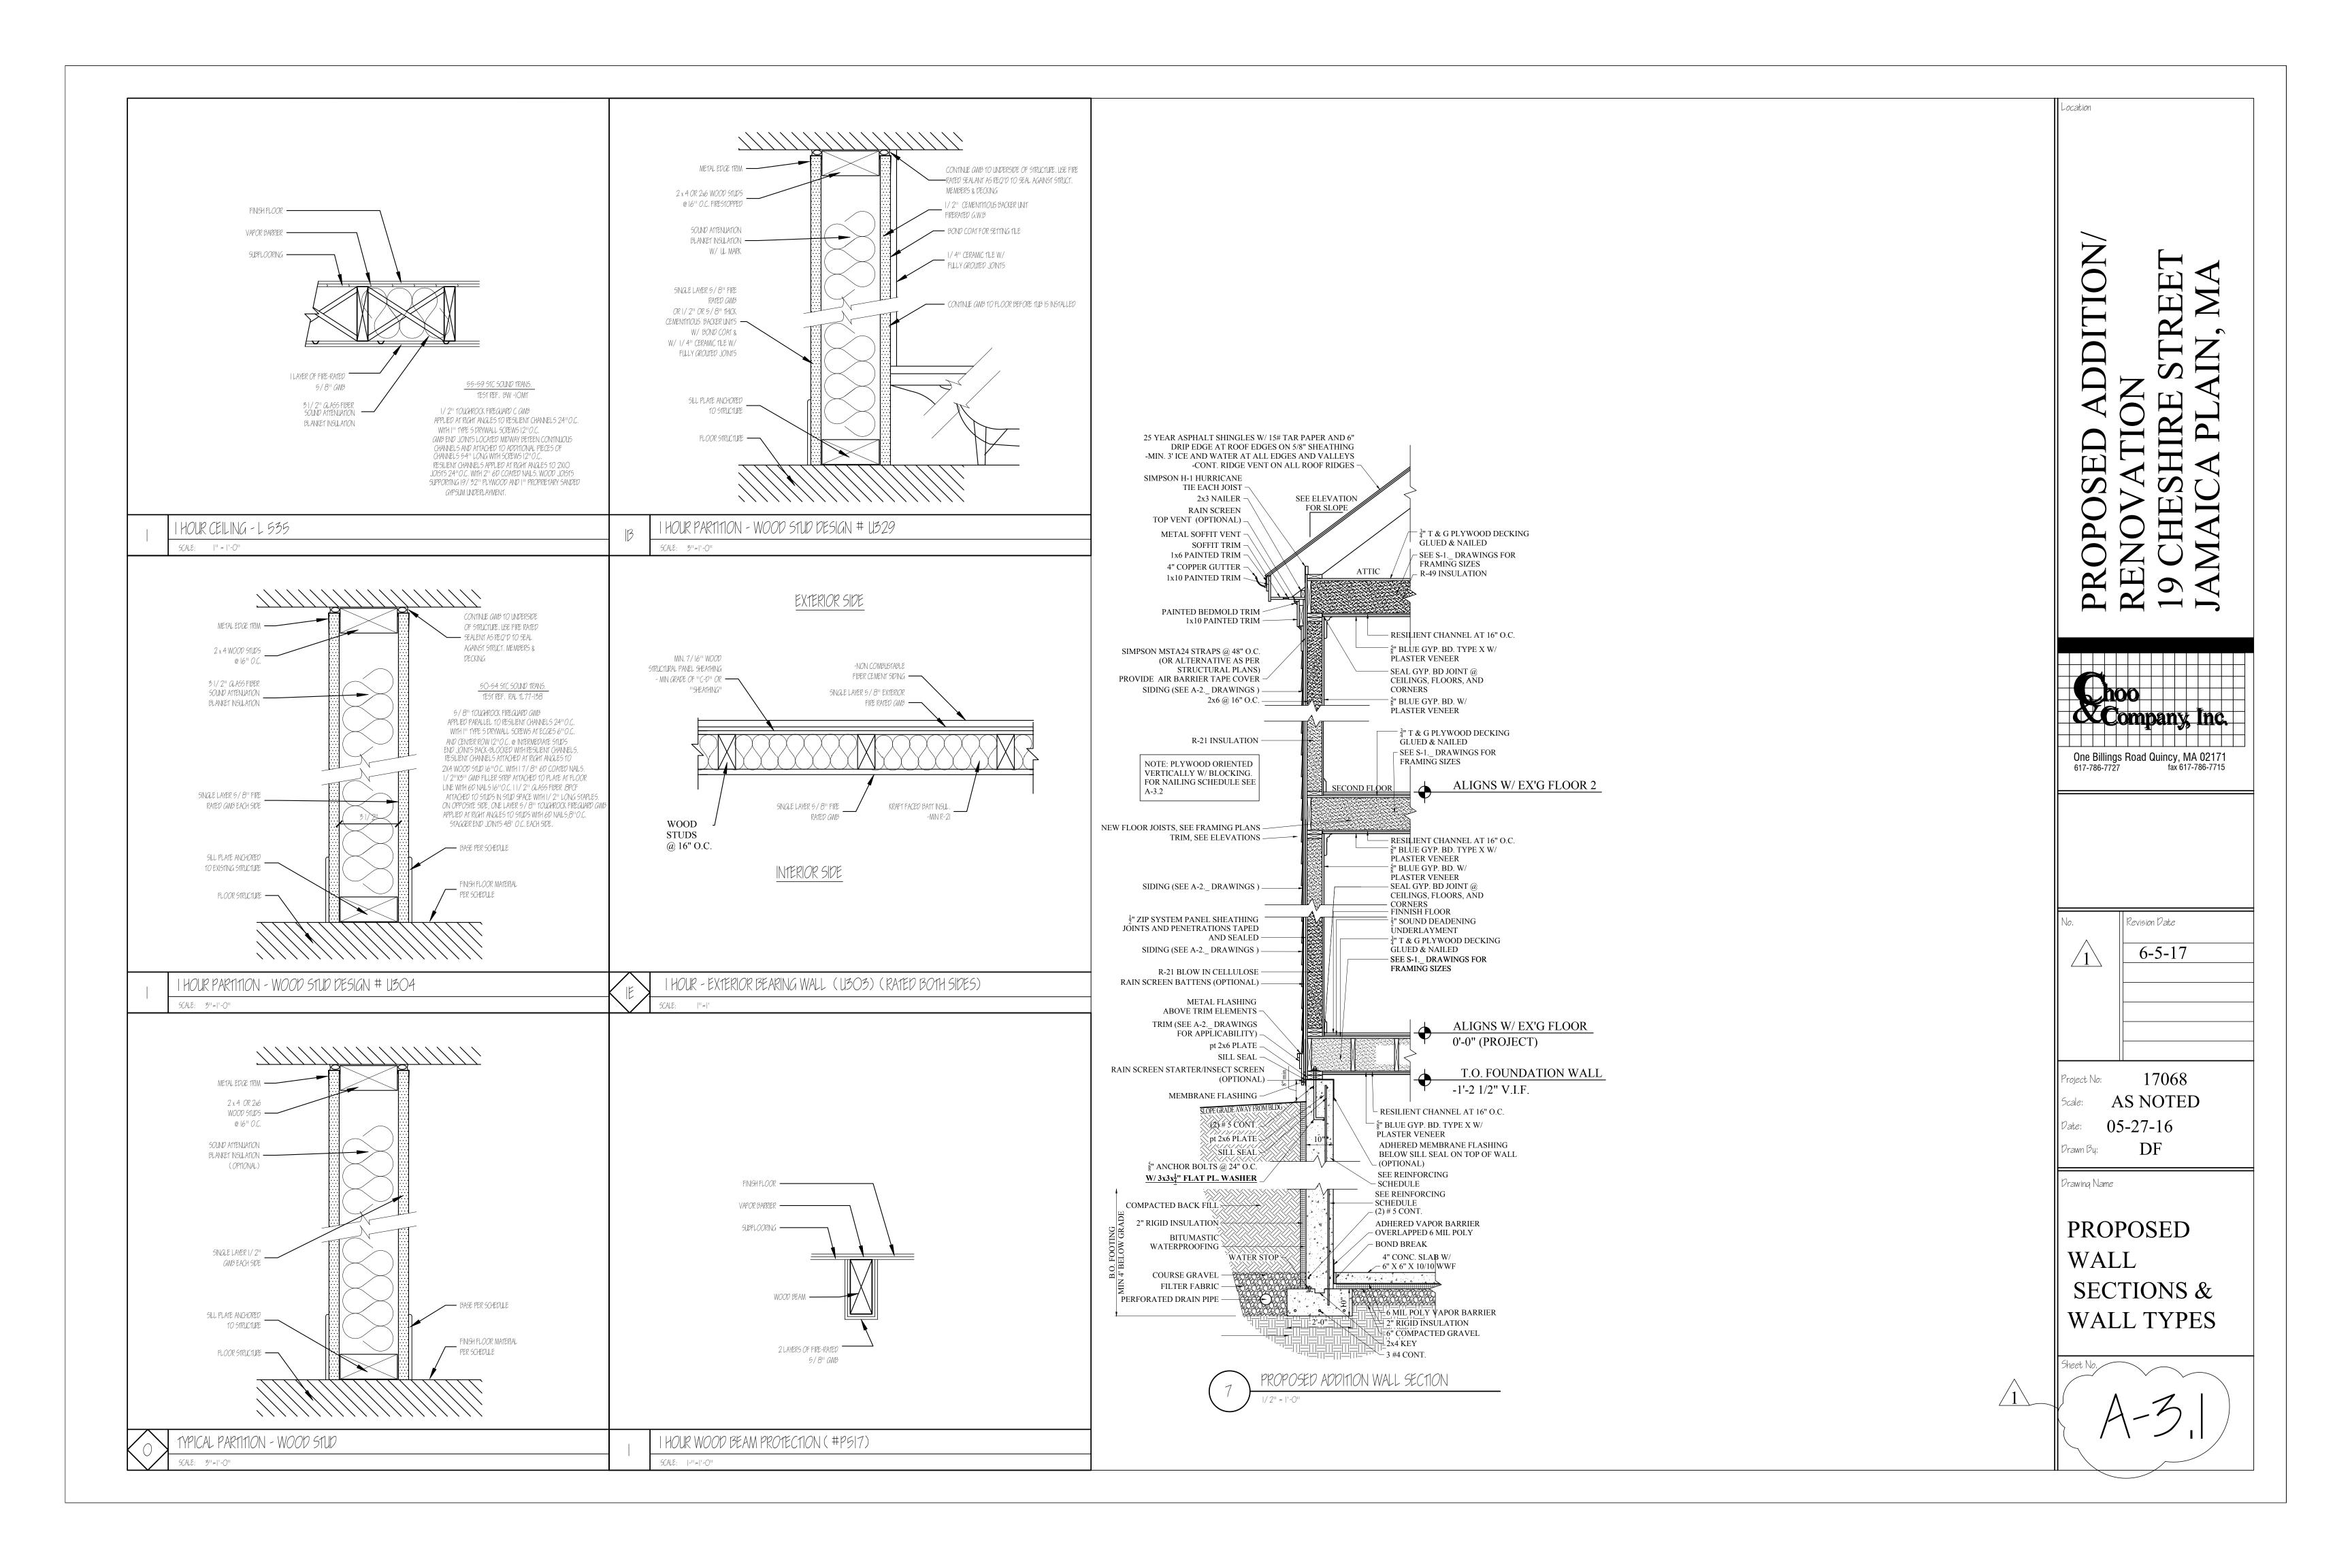



| NAIL SIZE AND TYPE | NUMBER AND LOCATION |
|---|--|
| | 4 TOE-NAIL OR 2 DIRECT-NAIL |
| 16D COMMON | |
| | 2 TOE-NAIL OR 2 DIRECT-NAIL |
| | 12" O.C. DIRECT |
| | 24" O.C. DIRECT |
| | 16" O.C. |
| | 16" O.C. DIRECT |
| | 2 DIRECT-NAIL |
| | 2 EACH DIRECT BEARING 3 EACH DIRECT BEARING |
| | 3 TOE-NAIL |
| | 2 TOE-NAIL OR DIRECT-NAIL |
| 10D COMMON 10D COMMON 16D COMMON | 3 TOE-NAIL OR 2 DIRECT-NAIL |
| 10D COMMON 10D COMMON | 5 DIRECT OR 3 DIRECT |
| 10D COMMON | 2 DIRECT |
| 3D COMMON | 3 TOE-NAIL |
| 16D COMMON | 3 EACH DIRECT |
| 16D COMMON | 3 TOE-NAIL |
| 10D COMMON | 3 DIRECT-NAIL |
| 10D COMMON | 3 DIRECT |
| 10D COMMON | 3 DIRECT |
| 8D COMMON | 2 EACH DIRECT END |
| 8D COMMON | 2 EACH DIRECT BEARING |
| 20D COMMON | 1 EACH END 4 SQ. FT. FLOOR AREA |
| 20D COMMON | 1 EACH END 8 SQ. FT. FLOOR AREA |
| 8D COMMON 8D COMMON | 2 EACH DIRECT RAFTER 3 EACH DIRECT RAFTER |
| 8D COMMON | 2 EACH DIRECT JOIST |
| 8D COMMON | 3 EACH DIRECT JOIST |
| 16D COMMON | 2 EACH DIRECT JOIST |
| 8D COMMON | 2 EACH DIRECT STUD |
| 8D COMMON | 3 EACH DIRECT STUD |
| 6D COMMON 8D COMMON 16 GAUGE GALVANIZED WIRE STAPLES, 3/8" MINIMUM CROWN; LENGTH OF 1" PLUS | 6" O.C. DIRECT EDGES & 12" O.C. INTERMEDIATI 6" O.C. DIRECT EDGES & 12" O.C. INTERMEDIATI |
| PLYWOOD THICKNESS SAME AS IMMEDIATELY ABOVE | 4" O.C. EDGES & 8" O.C. INTERMEDIATE 2 1/2" O.C. EDGES & 5" O.C. INTERMEDIATE |
| 6D COMMON OR 6D ANNULAR OR SPIRAL THREAD 8D COMMON OR 8D ANNULAR OR SPIRAL THREAD 10D COMMON OR 8D RING SHANK OR 8D ANNULAR OR SPIRAL THREAD | 6" O.C. DIRECT EDGES & 10" O.C. INTERMEDIATI 6" O.C. DIRECT EDGES & 10" O.C. INTERMEDIATI 6" O.C. DIRECT EDGES & 6" O.C. INTERMEDIATE |
| 16D GALVANIZED WIRE STAPLES 3/8" MINIMUM CROWN; 1 3/8' LENGTH | 4" O.C. EDGES & 7" O.C. INTERMEDIATE 2 1/2" O.C. EDGES & 4" O.C. INTERMEDIATE |
| 20D COMMON | 32" O.C. DIRECT |
| 8D COMMON | 4 TOE-NAIL |
| 16D COMMON | 16" O.C. DIRECT |
| 1 1/2" GALVANIZED ROOFING NAIL OR 16 GAUGE | 3" O.C. EXTERIOR EDGE 6" O.C. INTERMEDIATE |
| 1 3/4" GALVANIZED ROOFING NAIL OR 8D COMMON NAIL OR 16 GAUGE STAPLE, 1 1/2" LONG WITH | 3" O.C. EXTERIOR EDGE 6" O.C. INTERMEDIATE |
| 12 GAUGE 1 3/4" LARGE HEAD CORROSION- | 4" O.C. EDGE 8" O.C. INTERMEDIATE |
| 6D ANNULAR THREADED | 6" O.C. DIRECT EDGES 10" O.C. INTERMEDIATE |
| 6D COMMON | 6" O.C. DIRECT EDGES 12" O.C. INTERMEDIATE |
| 8D COMMON | 6" O.C. DIRECT EDGES 12" O.C. INTERMEDIATE |
| 8D COMMON | 6" O.C. DIRECT EDGES 12" O.C. INTERMEDIATE |
| NO. 14 B&S GAGE CORROSION RESISTIVE | 2 EACH BEARING |
| | |
| | 16D COMMON SPIRAL THREAD 16D GALVANIZED WIRE STAPLES 3/8" MINIMUM CROWN; LENGTH OF 1" PLUS PLYWOOD THICKNESS SAME AS IMMEDIATELY ABOVE 16D COMMON OR 8D ANNULAR OR SPIRAL THREAD 16D COMMON OR 8D ANNULAR OR SPIRAL THREAD 16D COMMON OR 8D ANNULAR OR SPIRAL THREAD 16D COMMON OR 8D SING SHANK OR 8D 172" GALVANIZED WIRE STAPLES 3/8" MINIMUM CROWN; 1 3/8" LENGTH 20D COMMON 16D C |

NOTE *: SHINGLE NAILS SHALL PENETRATE NOT LESS THAN 3/4" INTO NAILING STRIPS, SHEATHING OR SUPPORTING CONSTRUCTION EXCEPT AS OTHERWISE PROVIDED IN 780 CMR 1225.4.4.

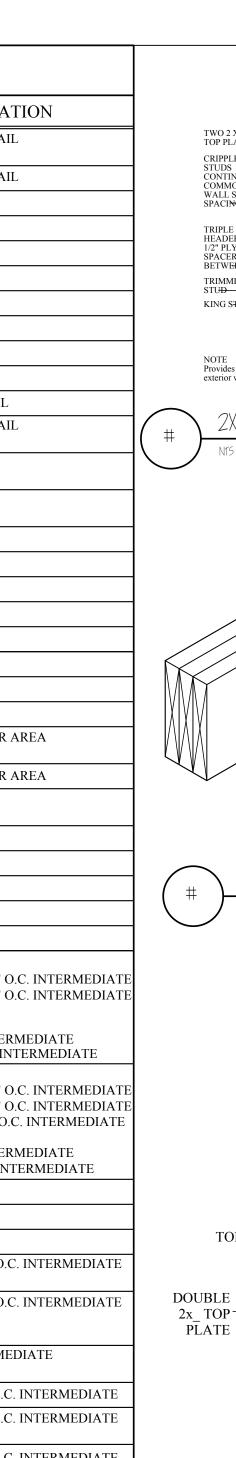

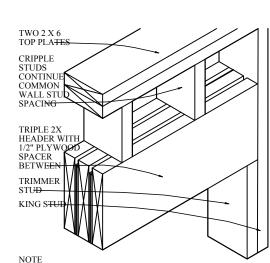

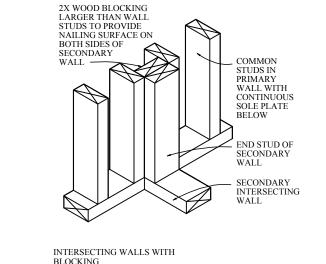

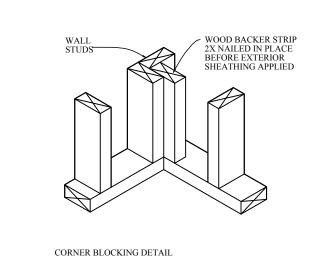

DOOR OPENING DETAIL

TREAD **RETURN**


- BLOCKING


FACE STRINGER


- WALL OR

SOLID RAIL


WALL FINISH

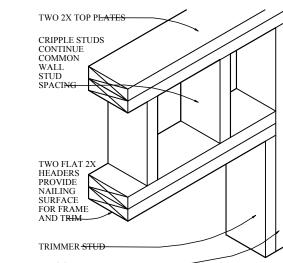


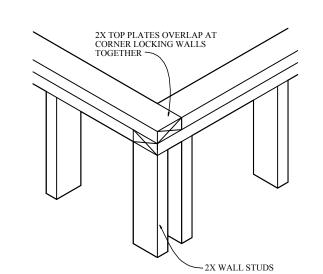

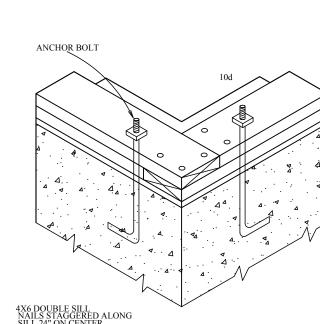

SILL FOR PLATFORM FRAMING DETAIL

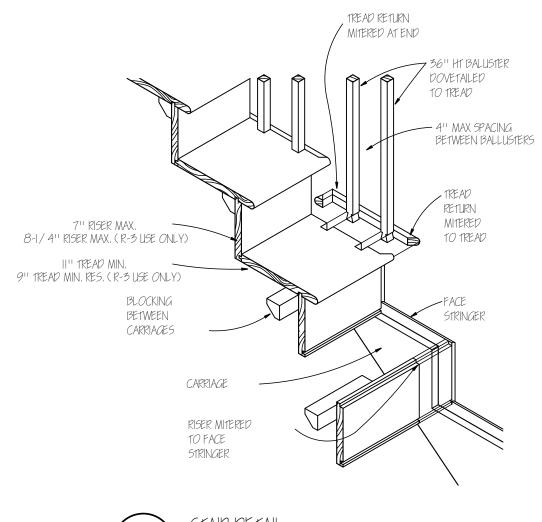

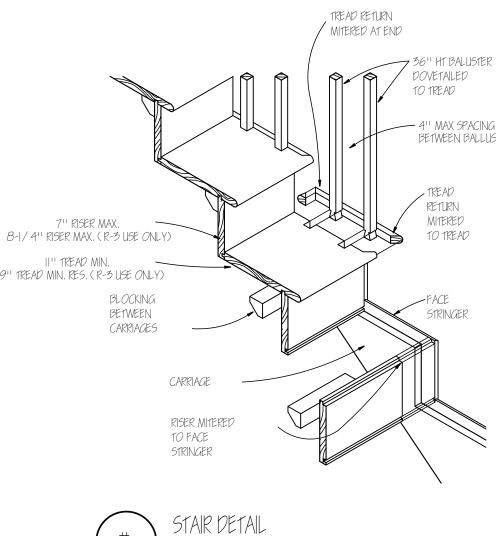

One Billings Road Quincy, MA 02171 617-786-7727 fax 617-786-7715

Revision Date


17068 Project No: AS NOTED

Date: 05-27-16

Drawing Name

FASTENING SCHEDULE & FRAMING **DETAILS**

Sheet No.

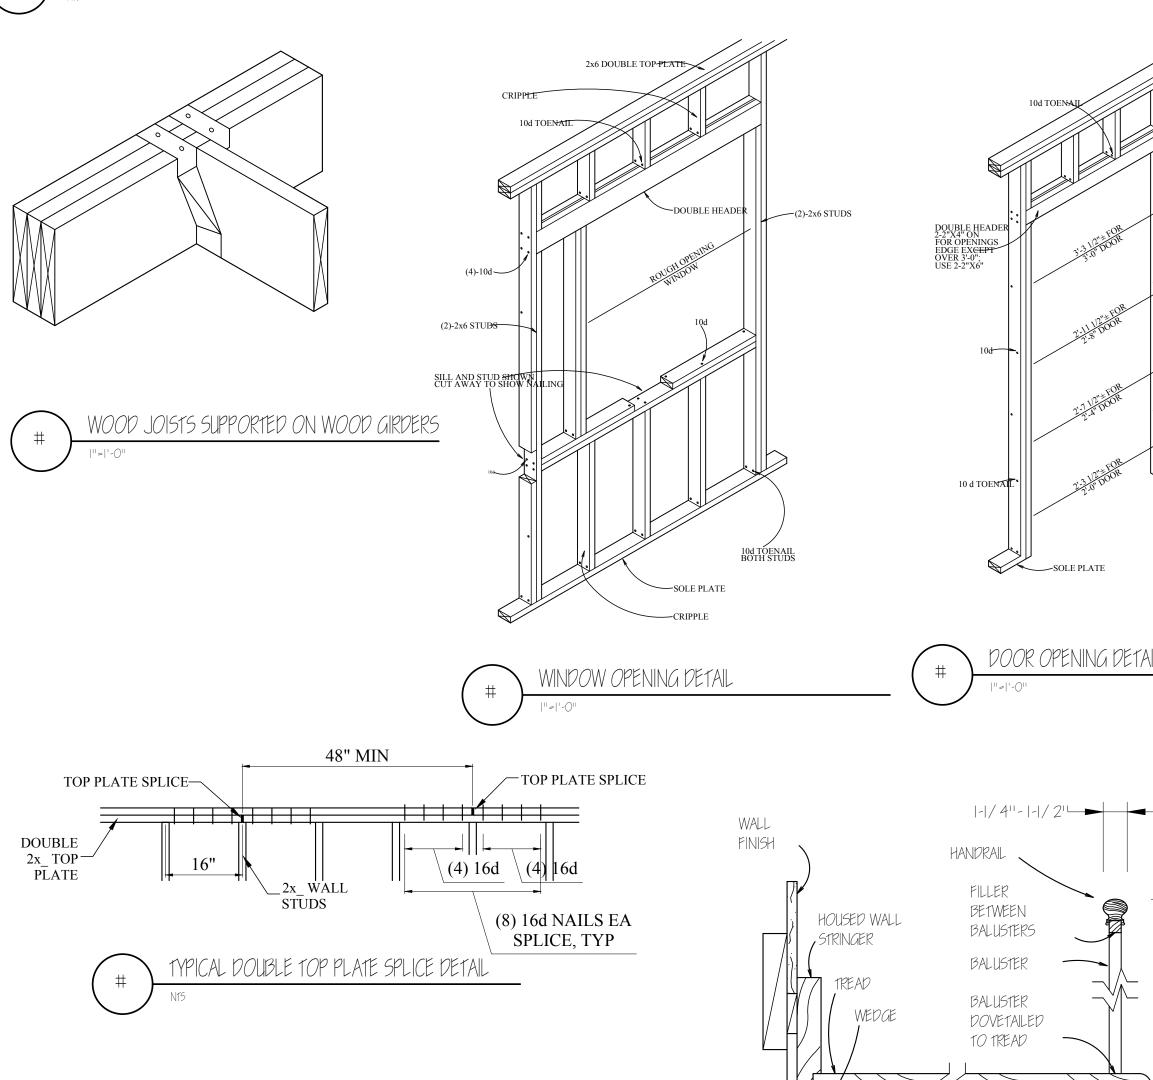

- FIRE RATED SHAFT WALL


RUN PAST LEDGERS & STRINGERS


STAIR PLATFORM STRUCTURE


- GYP BD AS REQUIRED


 $(3)\frac{3}{16}$ " LAGS EACH STUD

AS REQUIRED

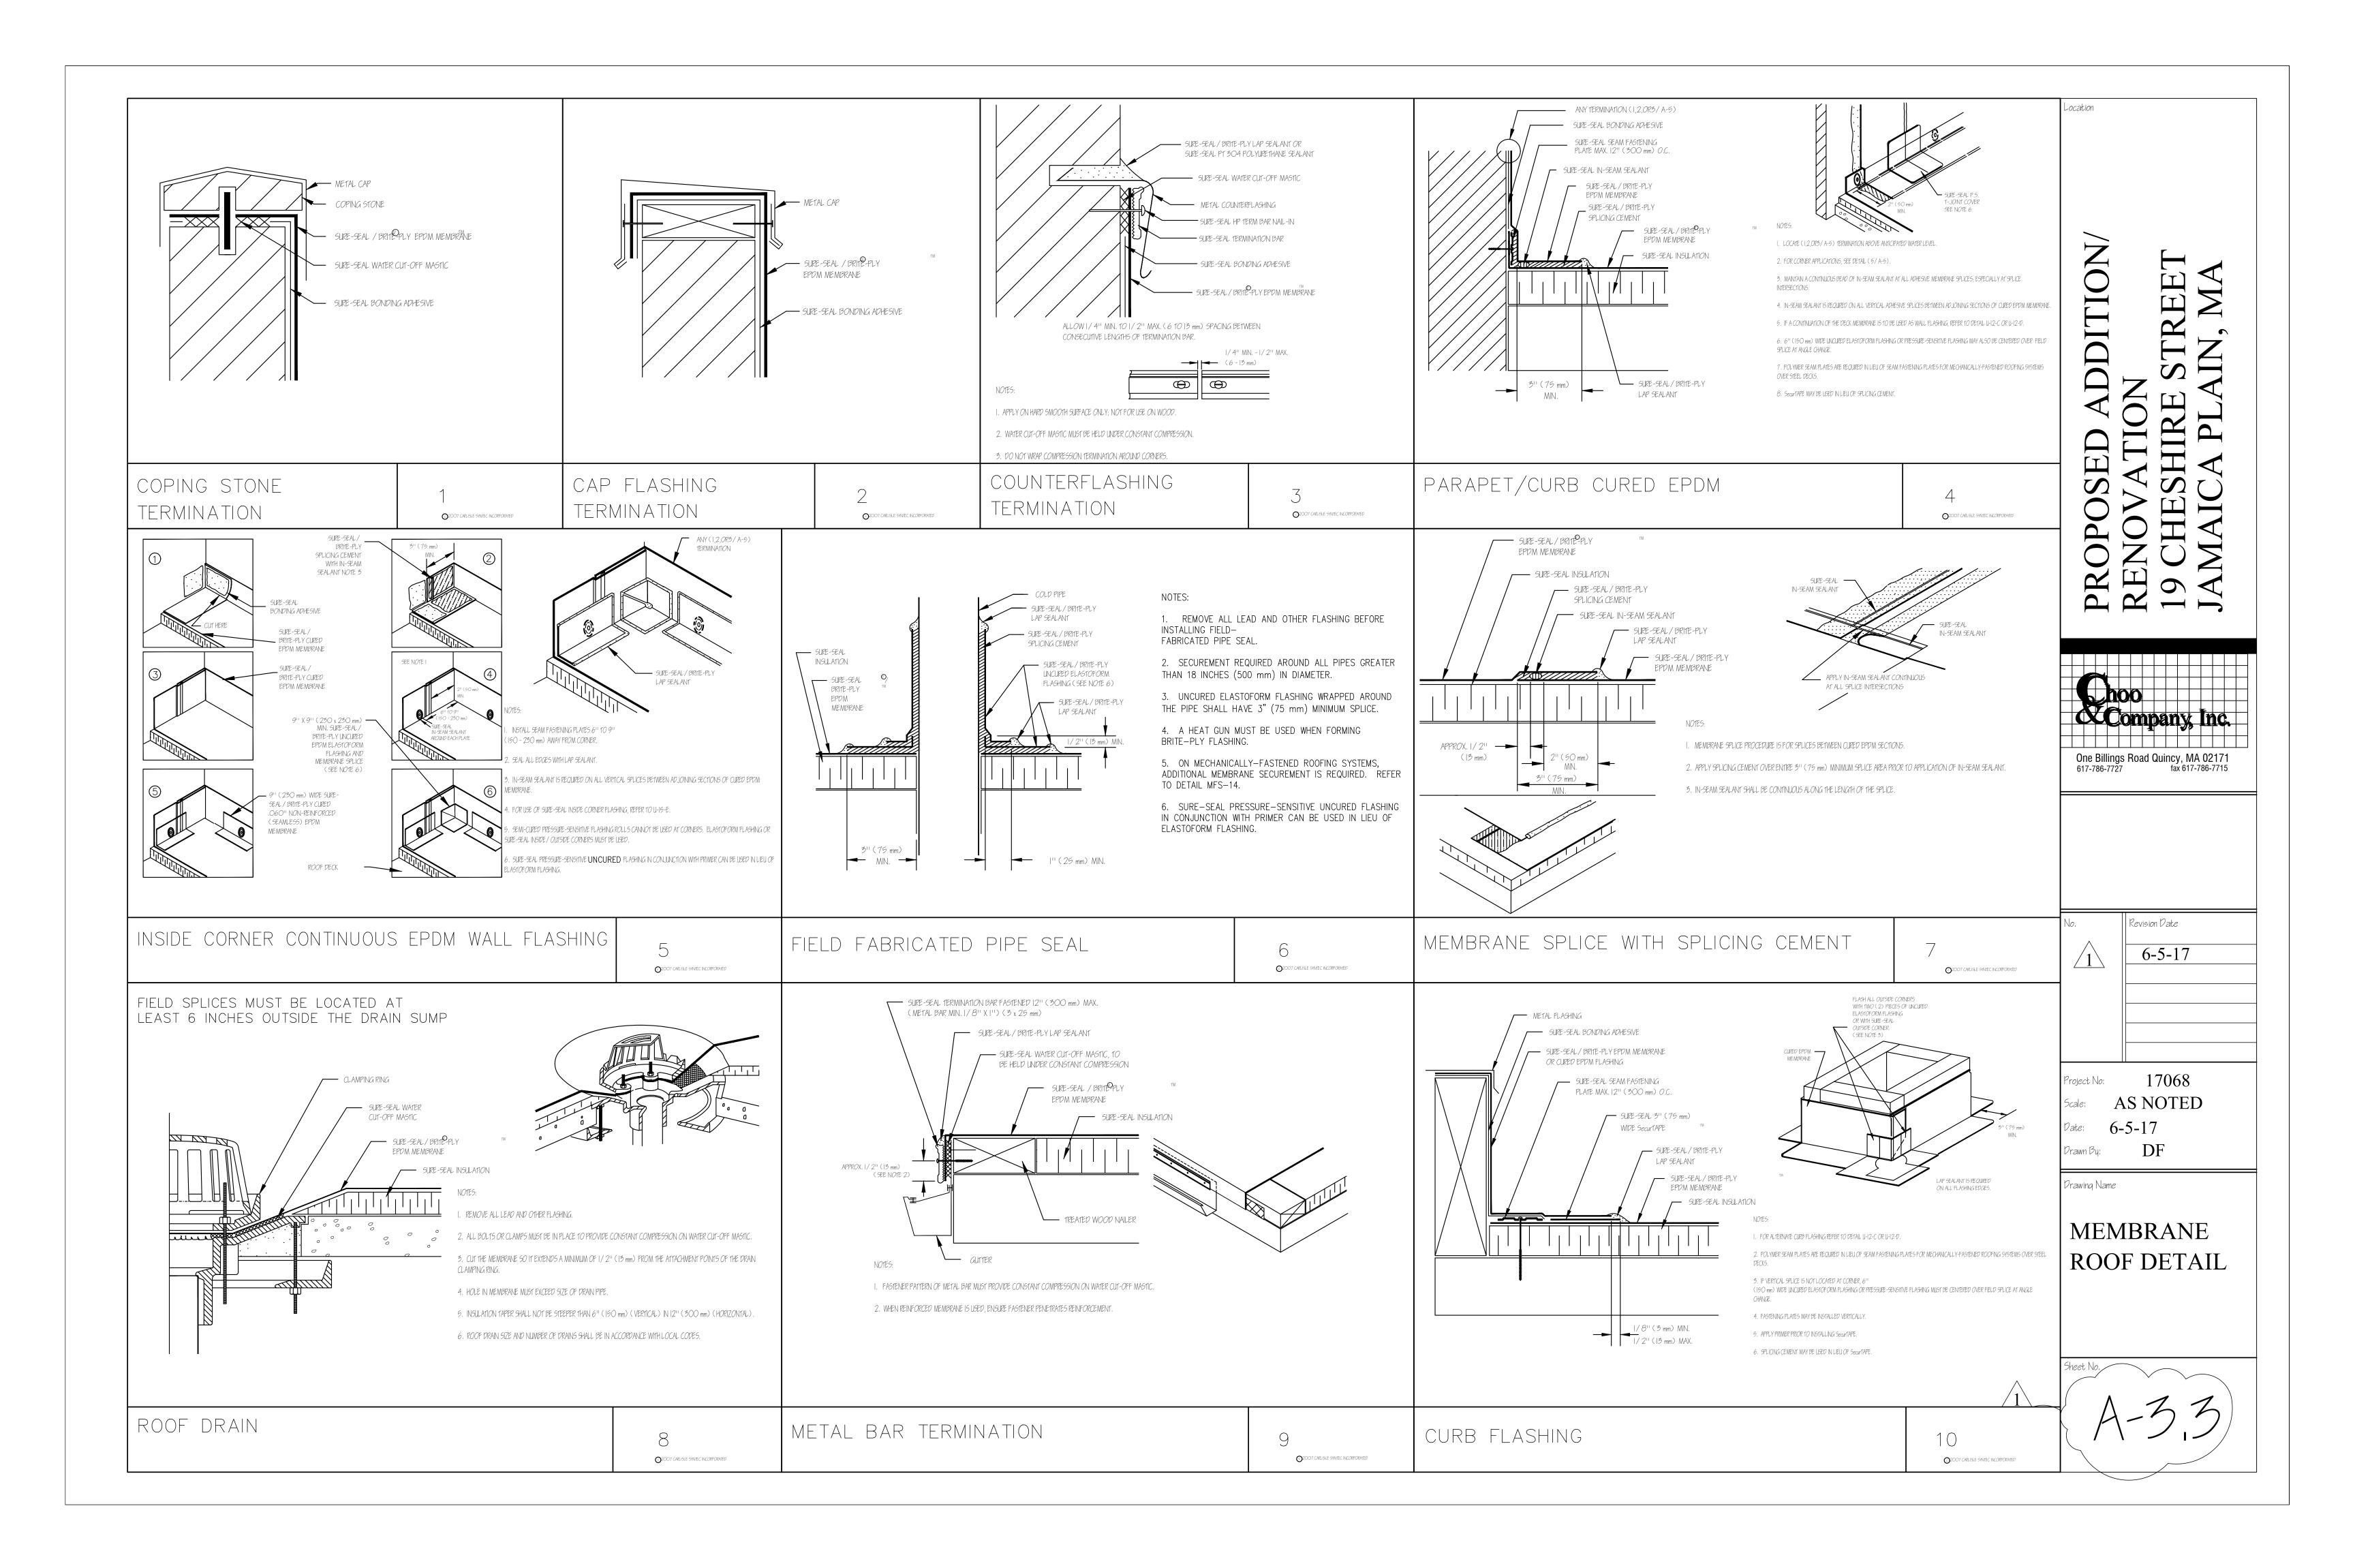

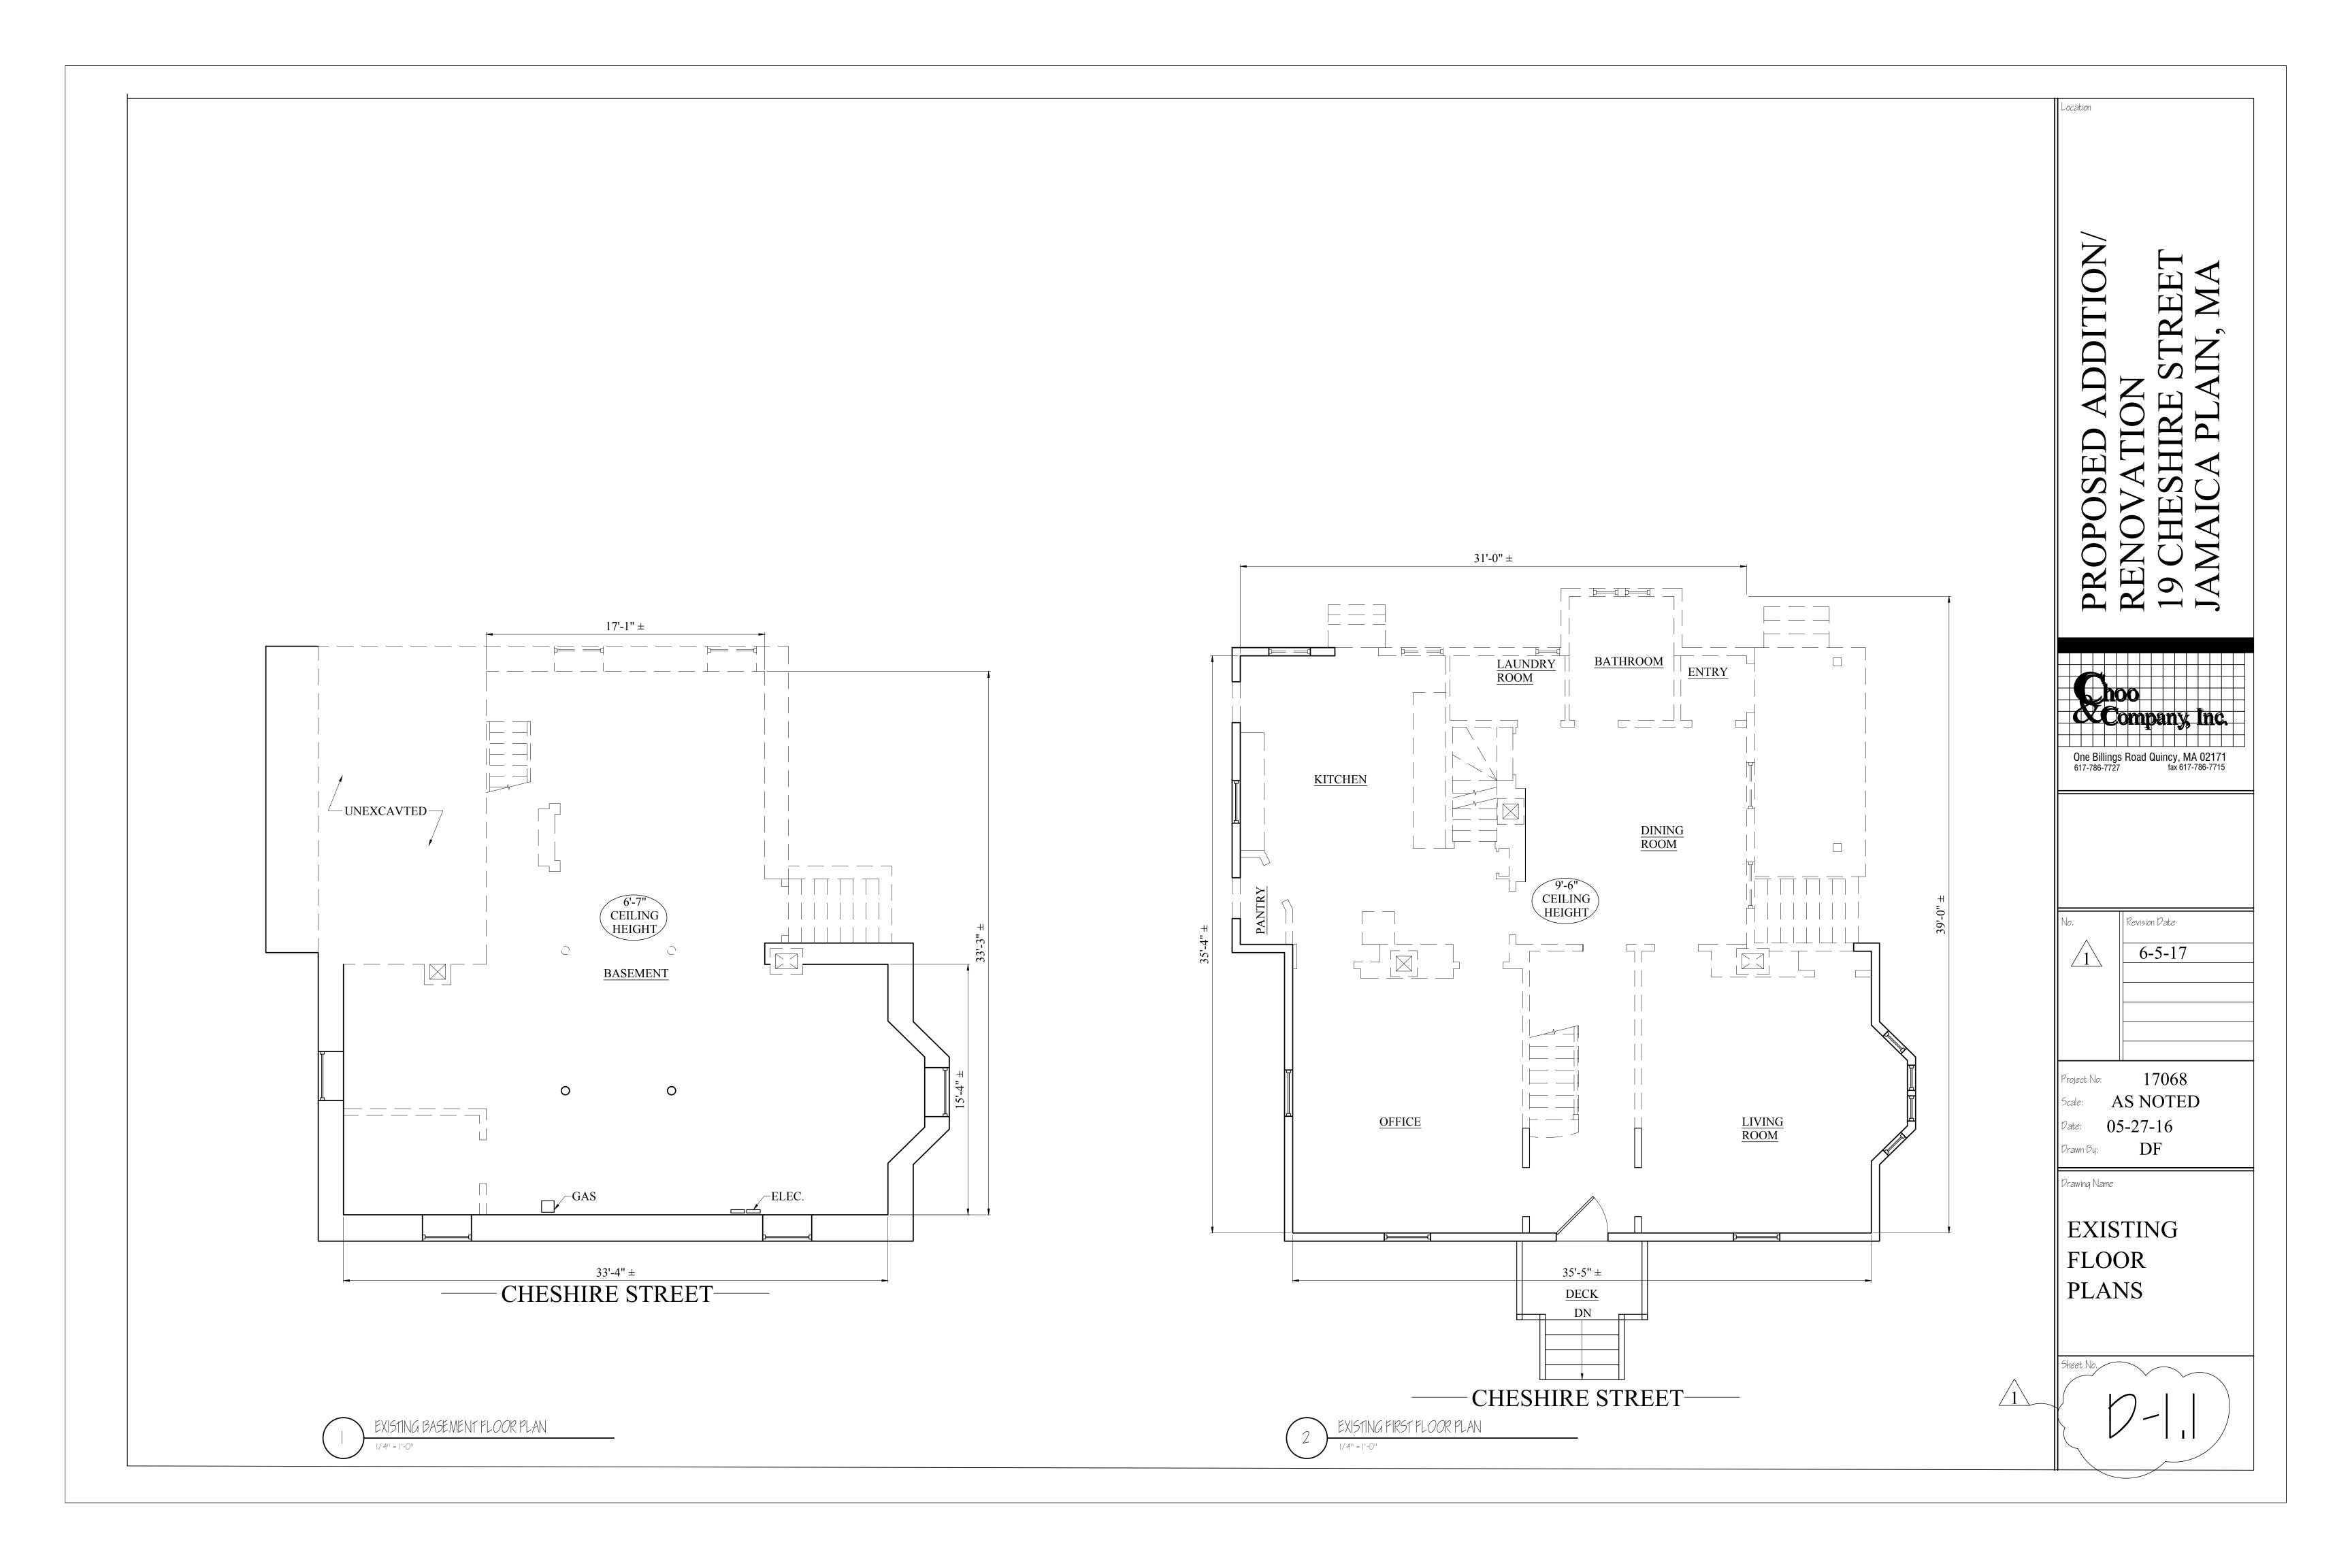


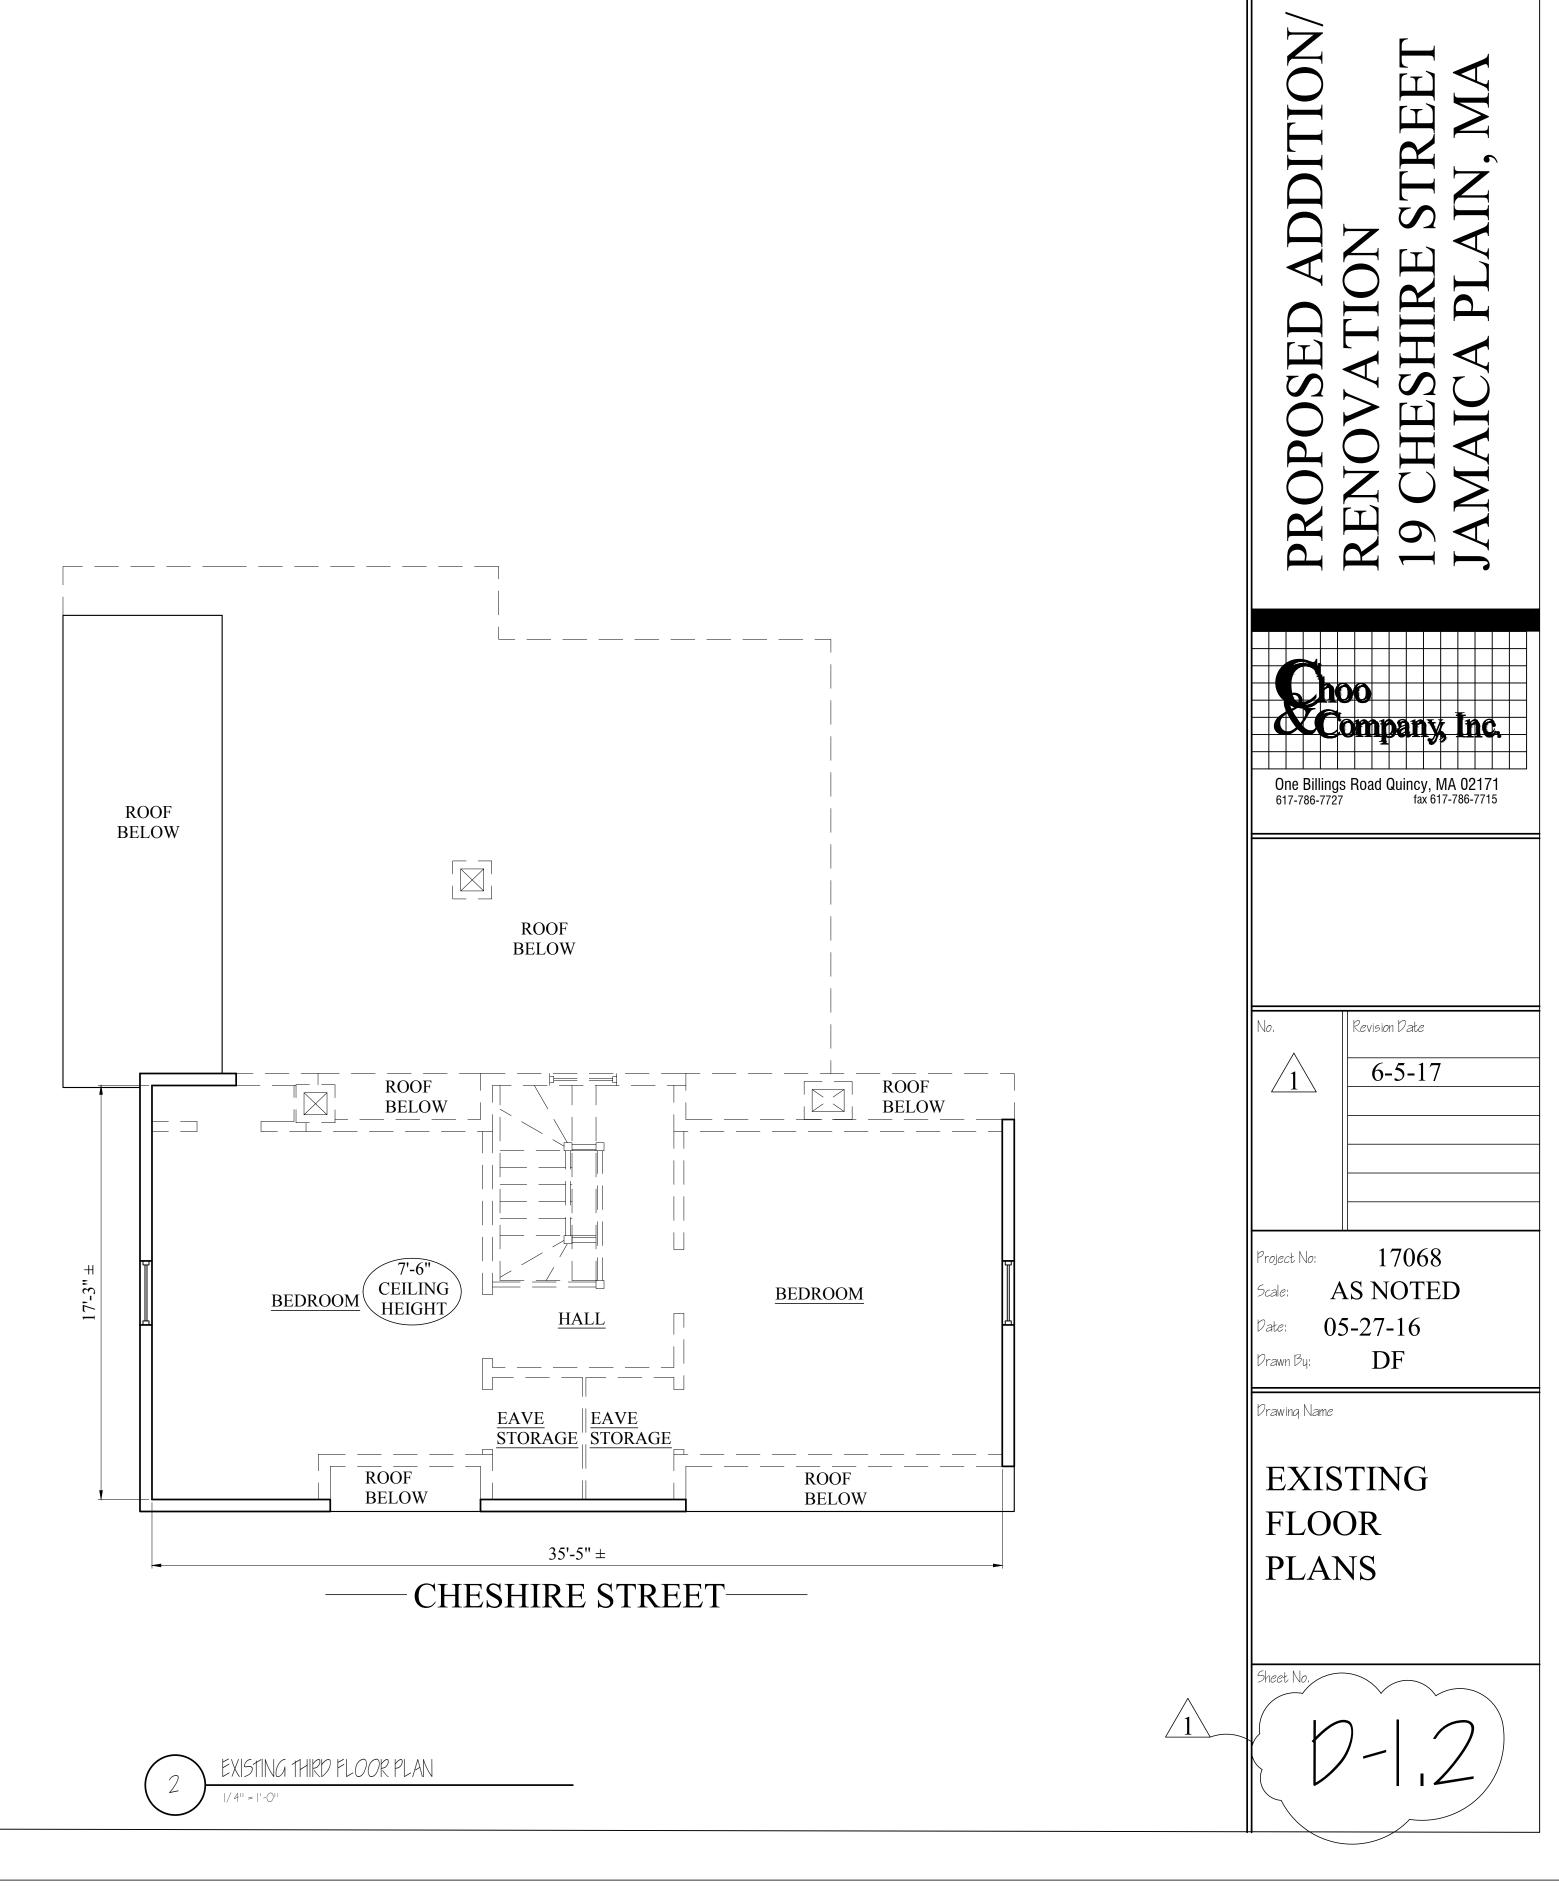


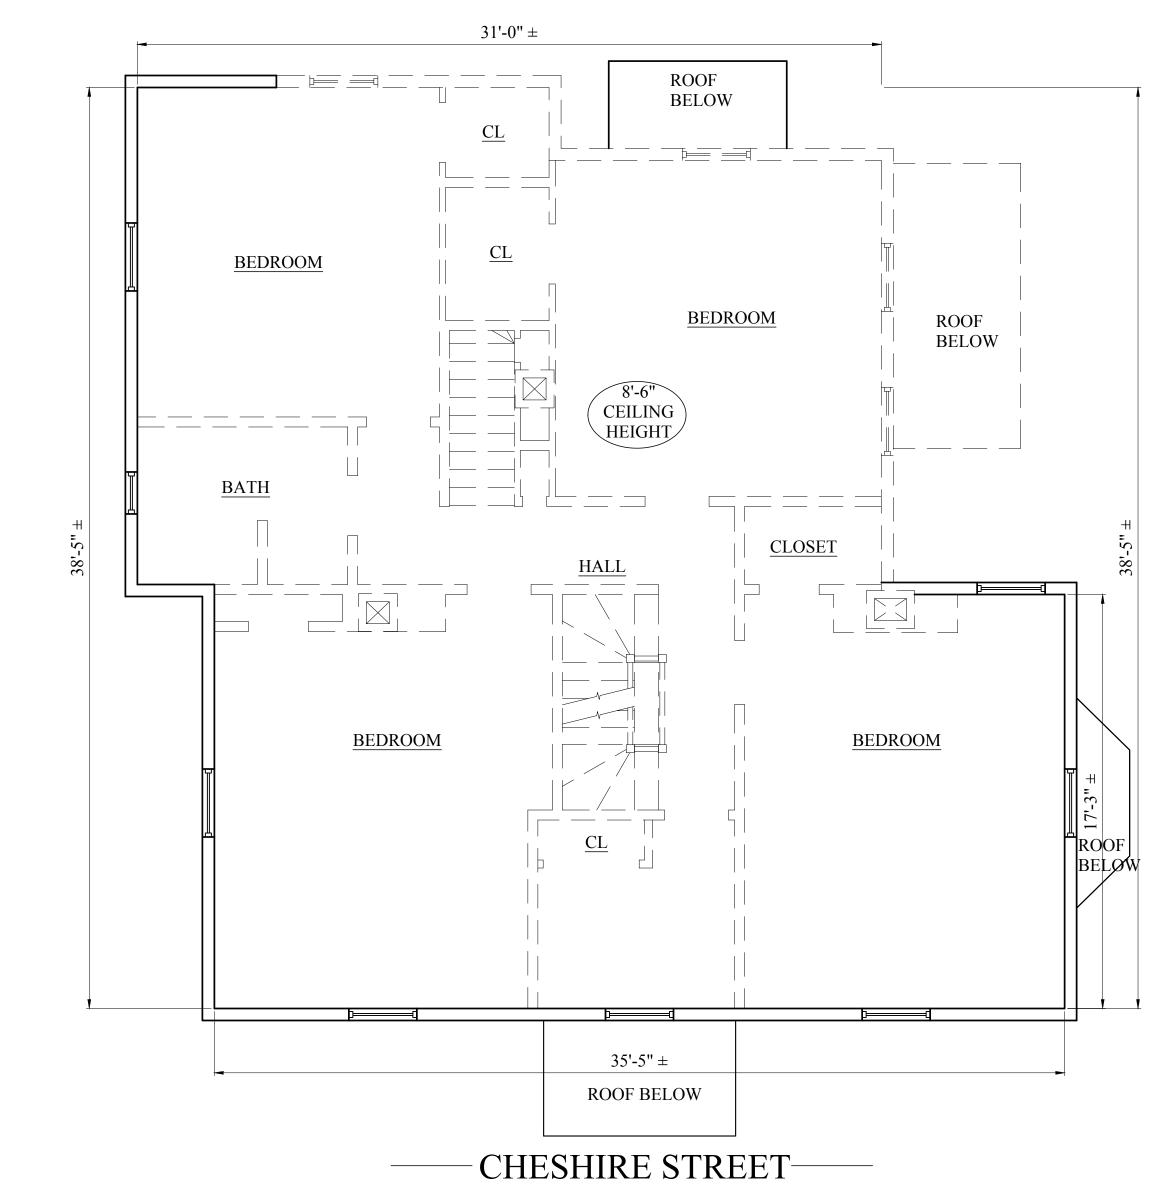


EXISTING SECOND FLOOR PLAN

1/4" = 1'-0"

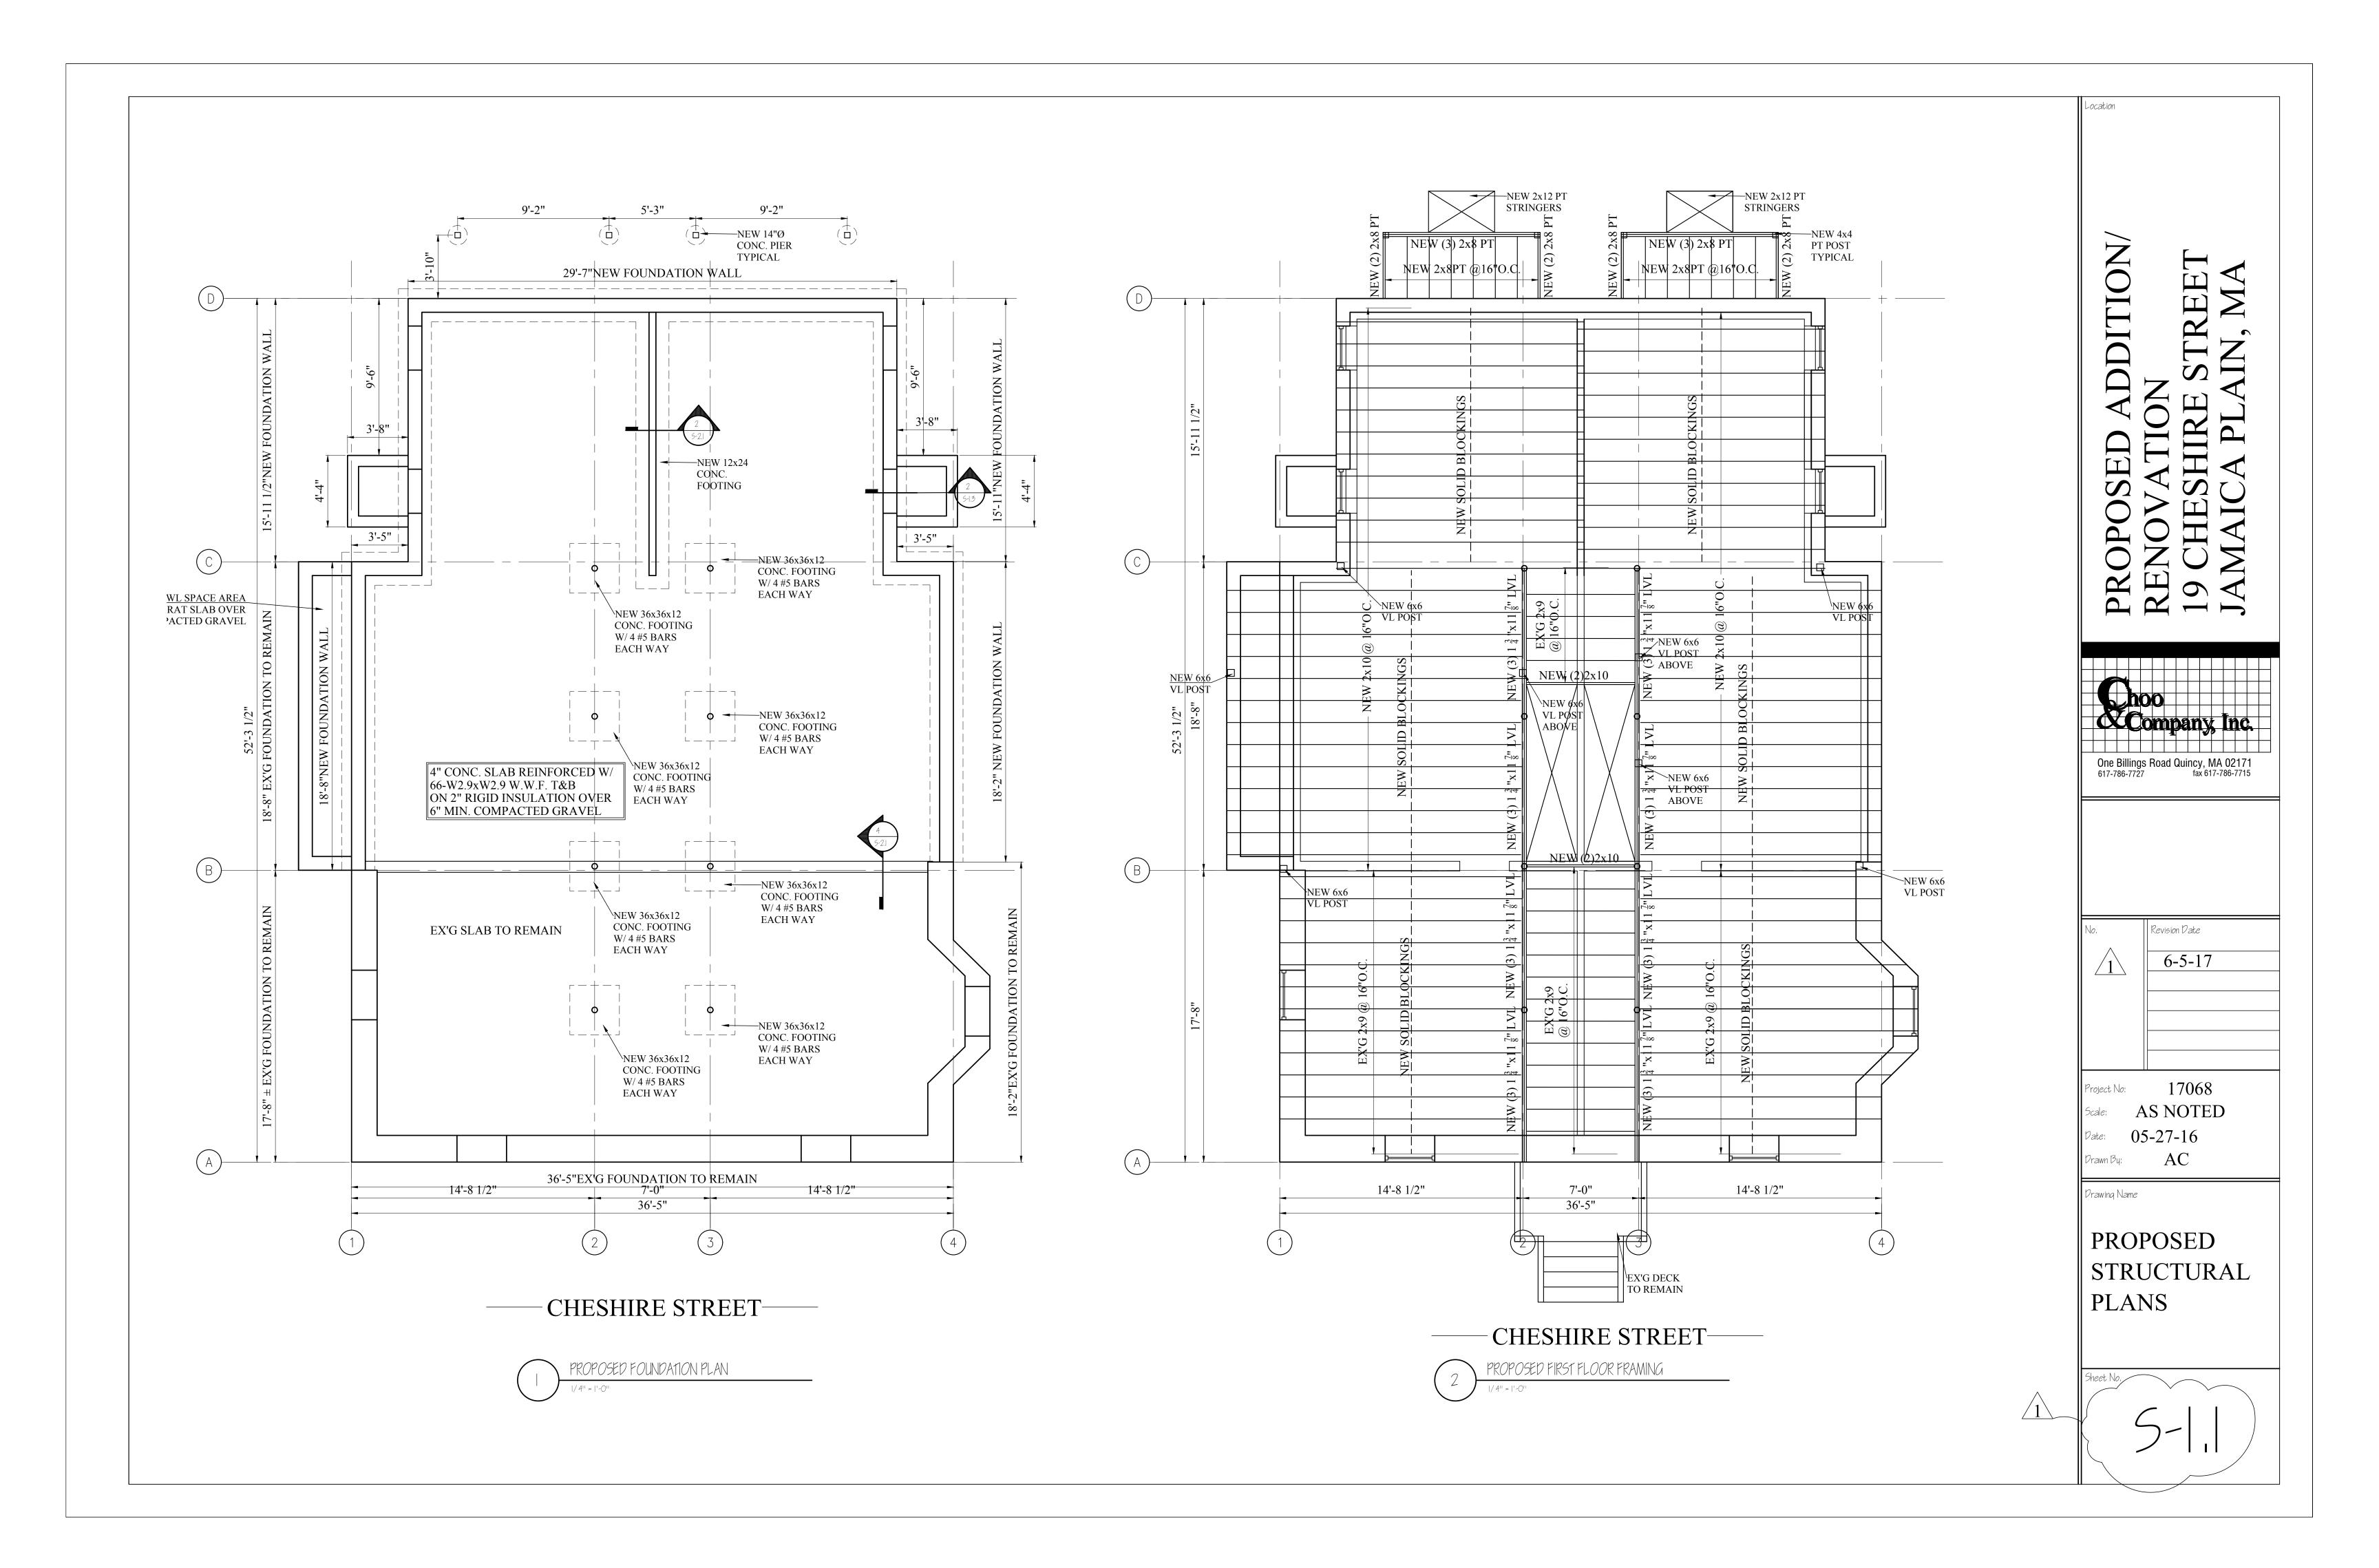

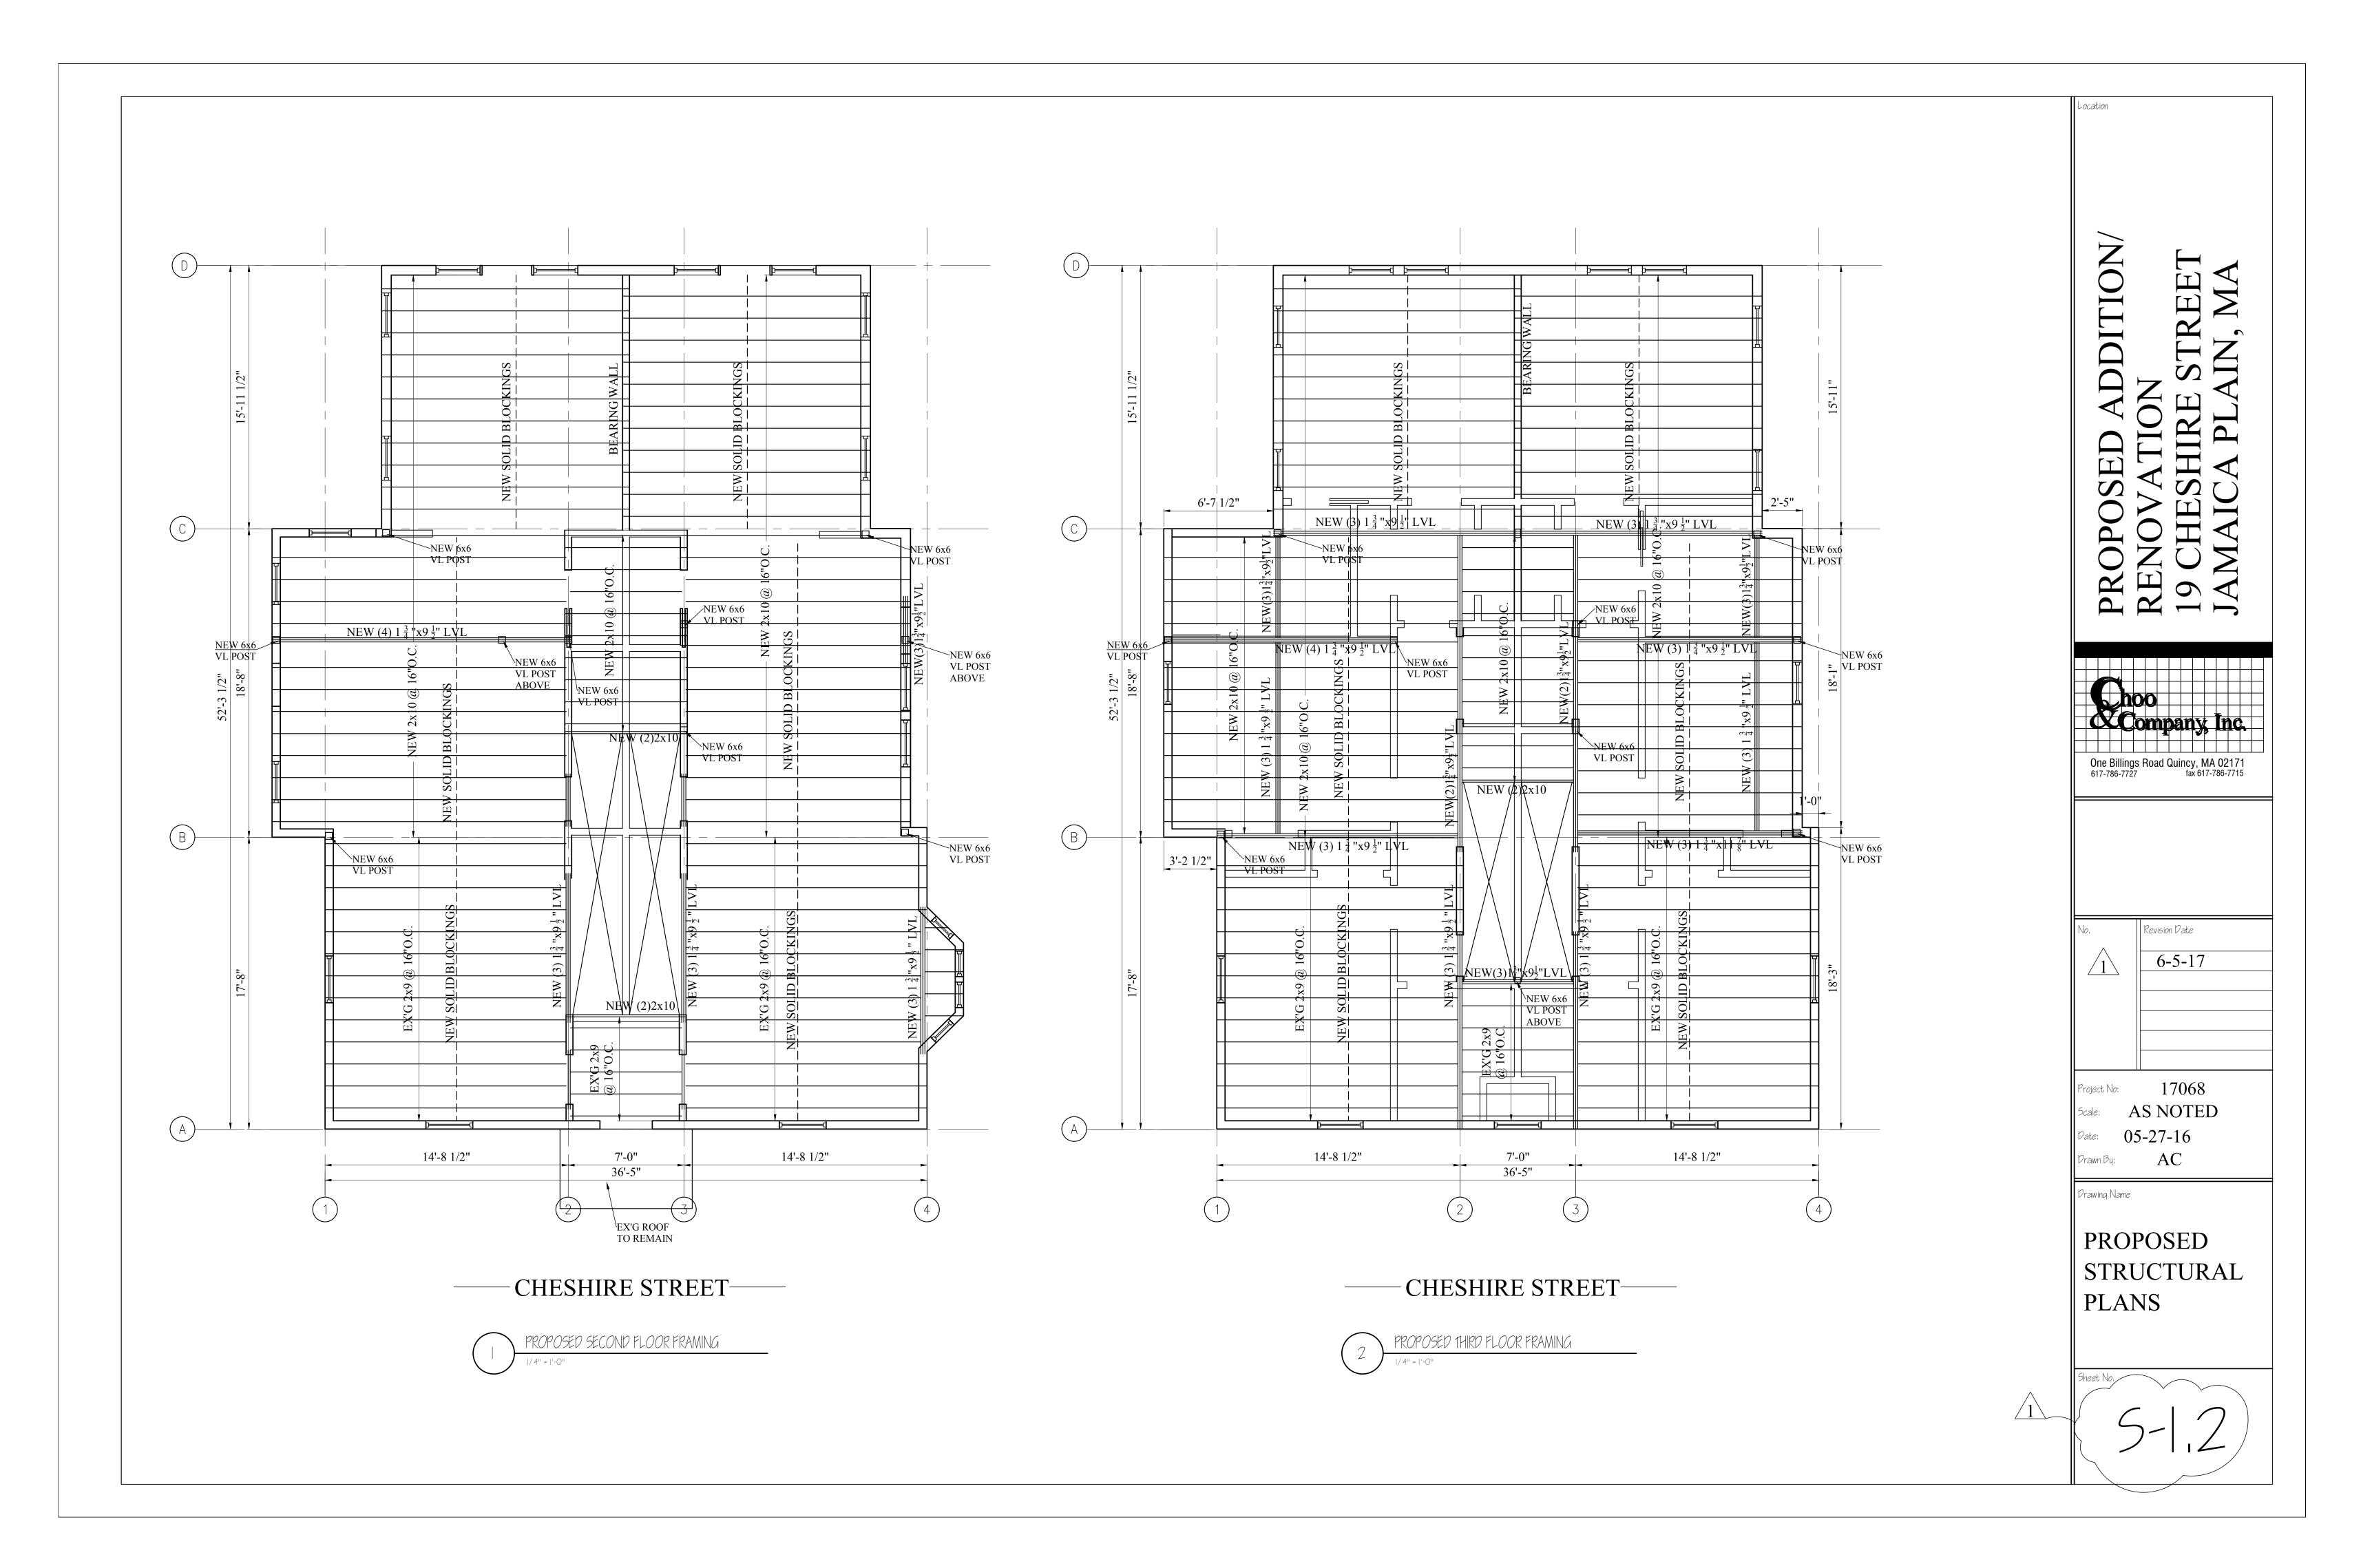

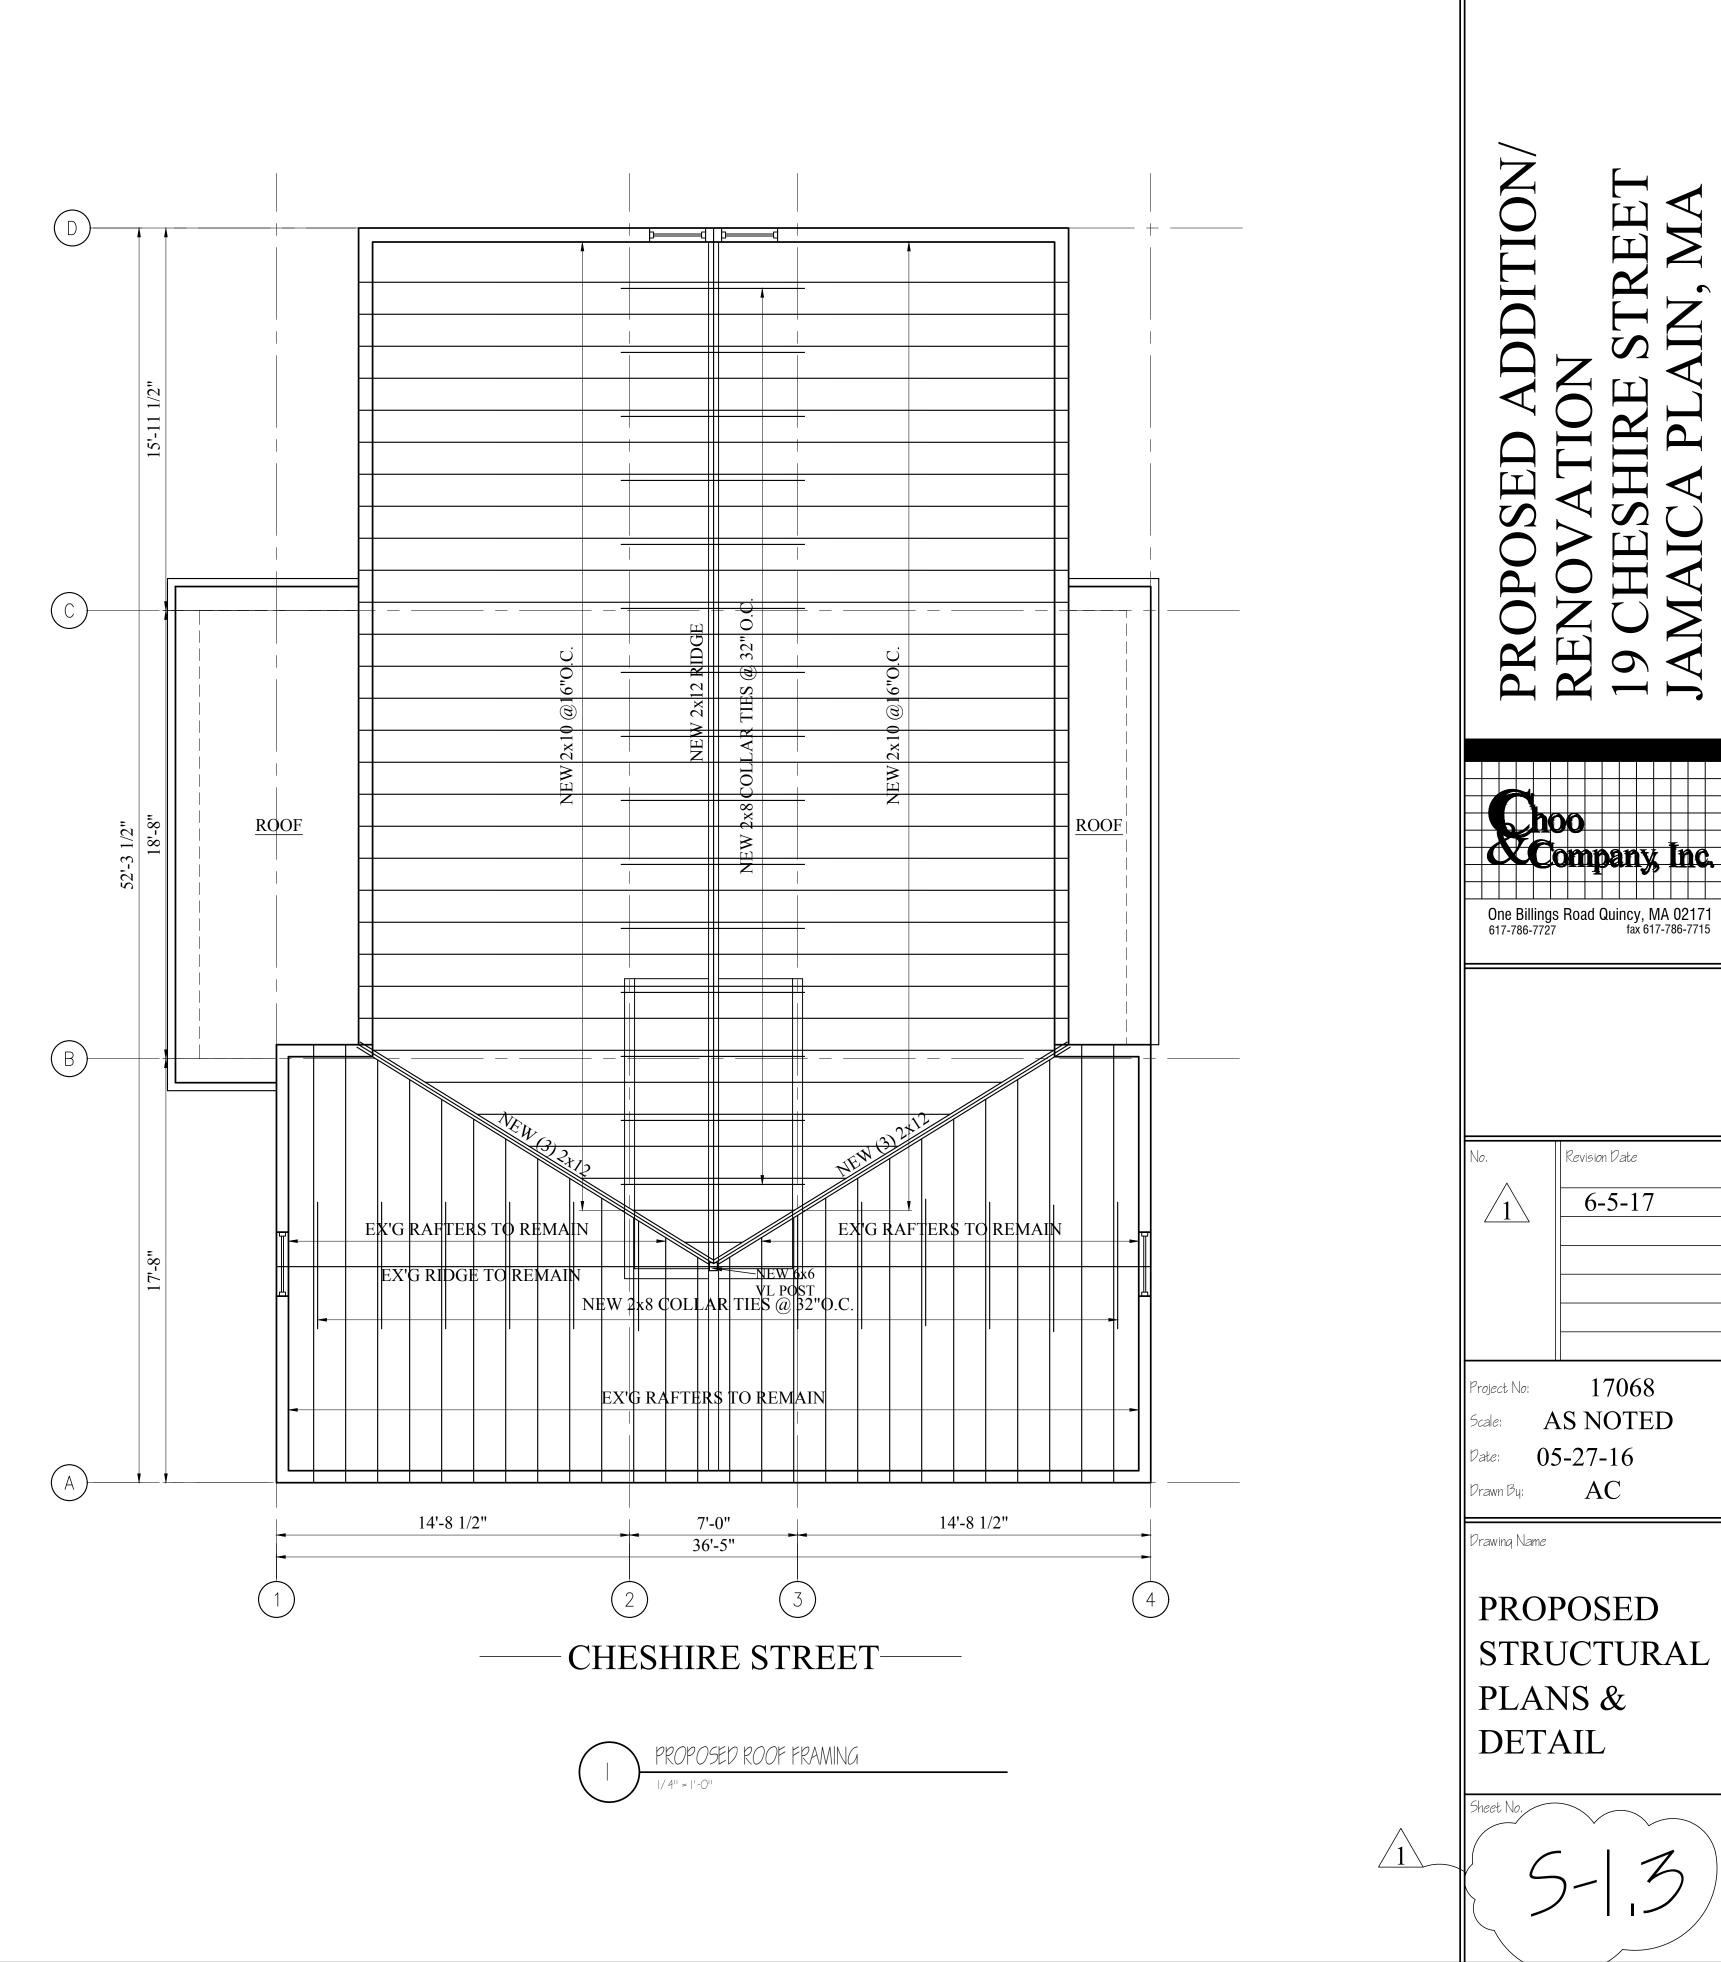

One Billings Road Quincy, MA 02171 617-786-7727 fax 617-786-7715

